

Date: 2016-01-13



**Edgecombe Builders**  
101, 1290 St. Paul Street Kelowna, BC, V1Y 2C9  
Phone: 778-484-7077

Attn: Kevin Edgecombe

**Re: 15965 Sole2 – 1350 St. Paul Street Kelowna – Design Rationale**

Dear Kevin,

For submittal to City of Kelowna regarding Design rationale for the above noted project. The name 'Sole' is a direct reference to the footprint of the building; in this case, the footprint is compact, efficient, and distinctly urban. Increased density is a common goal of many planners and Official Community Plans, including Kelowna's, to promote dynamic central centers. The C7 zoning allows for sufficient height, and benefits from an amendment to the BC Building Code, permits additional height for wood framed buildings. More units and more density will benefit the city in a number of ways as there will be an increased residential component in the city centre, critical mass, and improved aesthetics. The strategy of a compact, mixed use, attractive, and environmentally designed building also supports the business plan and would make the project financially viable.

The 'Sole 2' development will occupy the entire site, except for a public access strip on the south side of the property, creating a strong urban edge at the pedestrian level along St. Paul Street and fit into the flourishing urban fabric. Expansive parking lots create unsightly gaps in the urban rhythm. 'Sole' will house its vehicle and bicycle parking within a two storey concrete podium, with Commercial Retail Units on the street side, and offices on the third floor. The Residential floors above will be clad in a combination of cement board and metal panels (see Elevations). There will be inclusion of wood as an accent material in columns, canopies, and trellises. All units will have balconies. The roof patio will provide a landscaped oasis with a view toward the lake. Affordability is important to the success of the project, but so is quality. More compact unit sizes allow for materials that create an attractive potential first home for a young urban professional, a recent graduate, or a retired couple. Diversity is also what makes downtown living interesting and dynamic.

Sustainable strategies will be explored for durability of materials, efficiency of systems, and water use reduction. The target market values this approach. Again, increased density means increased efficiency. The design, materials, colors, and systems of the proposed 'Sole' building will be a positive addition to the City Centre and will encourage similar development strategies, consistent with your planning direction that will benefit the City of Kelowna.

Sincerely,

A handwritten signature in black ink, appearing to read 'Adam Bouzane'.

Adam Bouzane for  
**Brian Quiring**  
Project Architect, CEO  
MQN Architects

**Brian F. Quiring**  
Architect AIBC, MAA, M.Arch

**Vicki A. Topping**  
Architect AIBC, M.Arch, LEED AP+

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100, 3313 - 32nd Avenue  
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Canada V1T 2M7  
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E. info@mqn.ca  
[www.mqn.ca](http://www.mqn.ca)

Date: 2016-01-13

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Phone: 778-484-7077



Attn: Kevin Edgecombe

**Re: 15965 Sole2 – 1350 St. Paul Street Kelowna – Development  
Permit Variance Rationale**

Dear Kevin,

Please refer to the below listed variance narrative for the above noted proposed project.

1. Internal Laneway size: Parking bylaw prescribes 7m width. Request variance allowing reduction to 6.0m. The approved and constructed Sole on St. Paul precedent is evoked and suggested for use on Sole 2. The main drive aisles would be wider than Sole on St. Paul, with aisle widths of 6.5m and 6.6m, as well as a greater portion of the stalls as large stalls than the predecessor.
2. Loading space: The proposed building has 100% site coverage precluding loading space. Request variance to reduce loading space requirement to 0. Precedent is Vernon bylaw which allows waiving of the loading space for the City Centre. Loading would be provided via temporary parking on St. Paul street, as with Sole on St. Paul.
- 3a. C7 Setback Above 15m Street side: The prescribed setback for this item is limited to no encroachment less than 3.0m, however our design proposed an encroachment of 0.1m to coincide with the original Sole 1 project design, form and character of the building. We also noted from the elevations, plans and rendering that only a portion of the total lot width varies this encroachment at the levels above 15m (approximately 68.2ft/105.6ft = 64.6% of the St. Paul face).
- 3b. C7 Setback Above 15m Abutting property side: The prescribed setback for this item is limited to no encroachment less than 4.0m, however our design proposed an encroachment of 3.7m on the north project face, to coincide with the original Sole 1 project design, form and character of the building. We propose the variance for the above given; that the south side does not exhibits this restriction and rather demonstrates 5.3m clear offering 24.5% over compliance (4.0m/5.3m). The north side encroachment also falls below a 10% variance at 7.5% encroachment ratio (3.7m/4.0m = 92.5% compliance).

[Continued on next page]

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**Brian F. Quiring**  
Architect AIBC, MAA, M.Arch

**Vicki A. Topping**  
Architect AIBC, M.Arch. LEED AP+

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3c. C7 angle of incidence above 15m: The prescribed setback for this item is limited to and angle of incidence of 80°. Proposed development suggests an angle of incidence at 88.5° to coincide with the original Sole 1 project design, form and character of the building. We propose the variance for the above given; the previous mentioned variance noted in item 5a creates the increased angle due to the street side encroachment. This variance falls below a 10% variance at 9.6% ( $80\%88.5\% = 90.4\%$  compliance). Deviation from the required compliance would significantly alter the form and function of the suggested project.



3d. C7 maximum floor plate area above 15m. The prescribed maximum allowable area, for this lot is limited to 676m<sup>2</sup>. The proposed design, which matches the original Sole project, only a few blocks to the north, exhibits a floor plate area of 956.7m<sup>2</sup>. Though there is a significant deviation from the prescribed requirement, the suggested reduction would render the proposed project uneconomical and unfeasible. Utilizing the precedence of the success, form and character of the original Sole project to this proposed project, we believe that a variance for this item is reasonable.

3e. C7 maximum diagonal floor plate dimension above 15m. The prescribed maximum allowable diagonal distance, for this lot is limited to 39m. The proposed design, which matches the original Sole project, only a few blocks to the north, exhibits a diagonal floor plate distance of 48.1m. Following similar login to 5b, there is a significant deviation from the prescribed requirement. The suggested reduction would render the proposed project uneconomical and unfeasible. Utilizing the precedence of the success, form and character of the original Sole project to this proposed project, we believe that a variance for this item is reasonable.

We believe that the aforementioned variances are reasonable, and are necessary to allow this project to proceed. Feel free to contact us at any time with questions.

Sincerely,

A handwritten signature in black ink, appearing to read 'Adam Bouzane for Brian Quiring'.

Adam Bouzane for  
**Brian Quiring**  
Project Architect, CEO  
MQN Architects

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**Brian F. Quiring**  
Architect AIBC, MAA, M.Arch

**Vicki A. Topping**  
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# SOLE 2 - 1350 ST. PAUL STREET, KELOWNA, BC

## EDGECOMBE BUILDERS



SOLE 2 - 1350 ST. PAUL STREET, KELOWNA, BC  
ISSUED FOR DEVELOPMENT PERMIT

SOLE 2 - 1350 ST. PAUL STREET, KELOWNA, BC  
ISSUED FOR DEVELOPMENT PERMIT  
2016/01/13

## ARCHITECTURAL MQN ARCHITECTS

SUITE 100 - 3313 32ND AVENUE  
VERNON, BRITISH COLUMBIA V1T 2M7  
P: 250-542-1199 F: 250-542-5236

## LANDSCAPE BENCH SITE DESIGN

105-1289 ELLIS STREET  
KELOWNA, BRITISH COLUMBIA V1Y 9X6  
P: 250-860-6778

WILSON / 103

11200-000-0014


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### LANDSCAPE DRAWING LIST


A000	TITLE PAGE
A101	SITE PLAN
A201	MAIN FLOOR PLAN
A202	SECOND FLOOR PLAN
A203	THIRD FLOOR PLAN
A204	FOURTH FLOOR PLAN
A205	FIFTH FLOOR PLAN
A206	SIXTH FLOOR PLAN
A401	EXTERIOR ELEVATIONS

**L-1.1 LANDSCAPE PLAN LEVEL 1  
L-1.2 LANDSCAPE PLAN LEVEL 3**

WWW.SHELDONSHAWMUN.MY



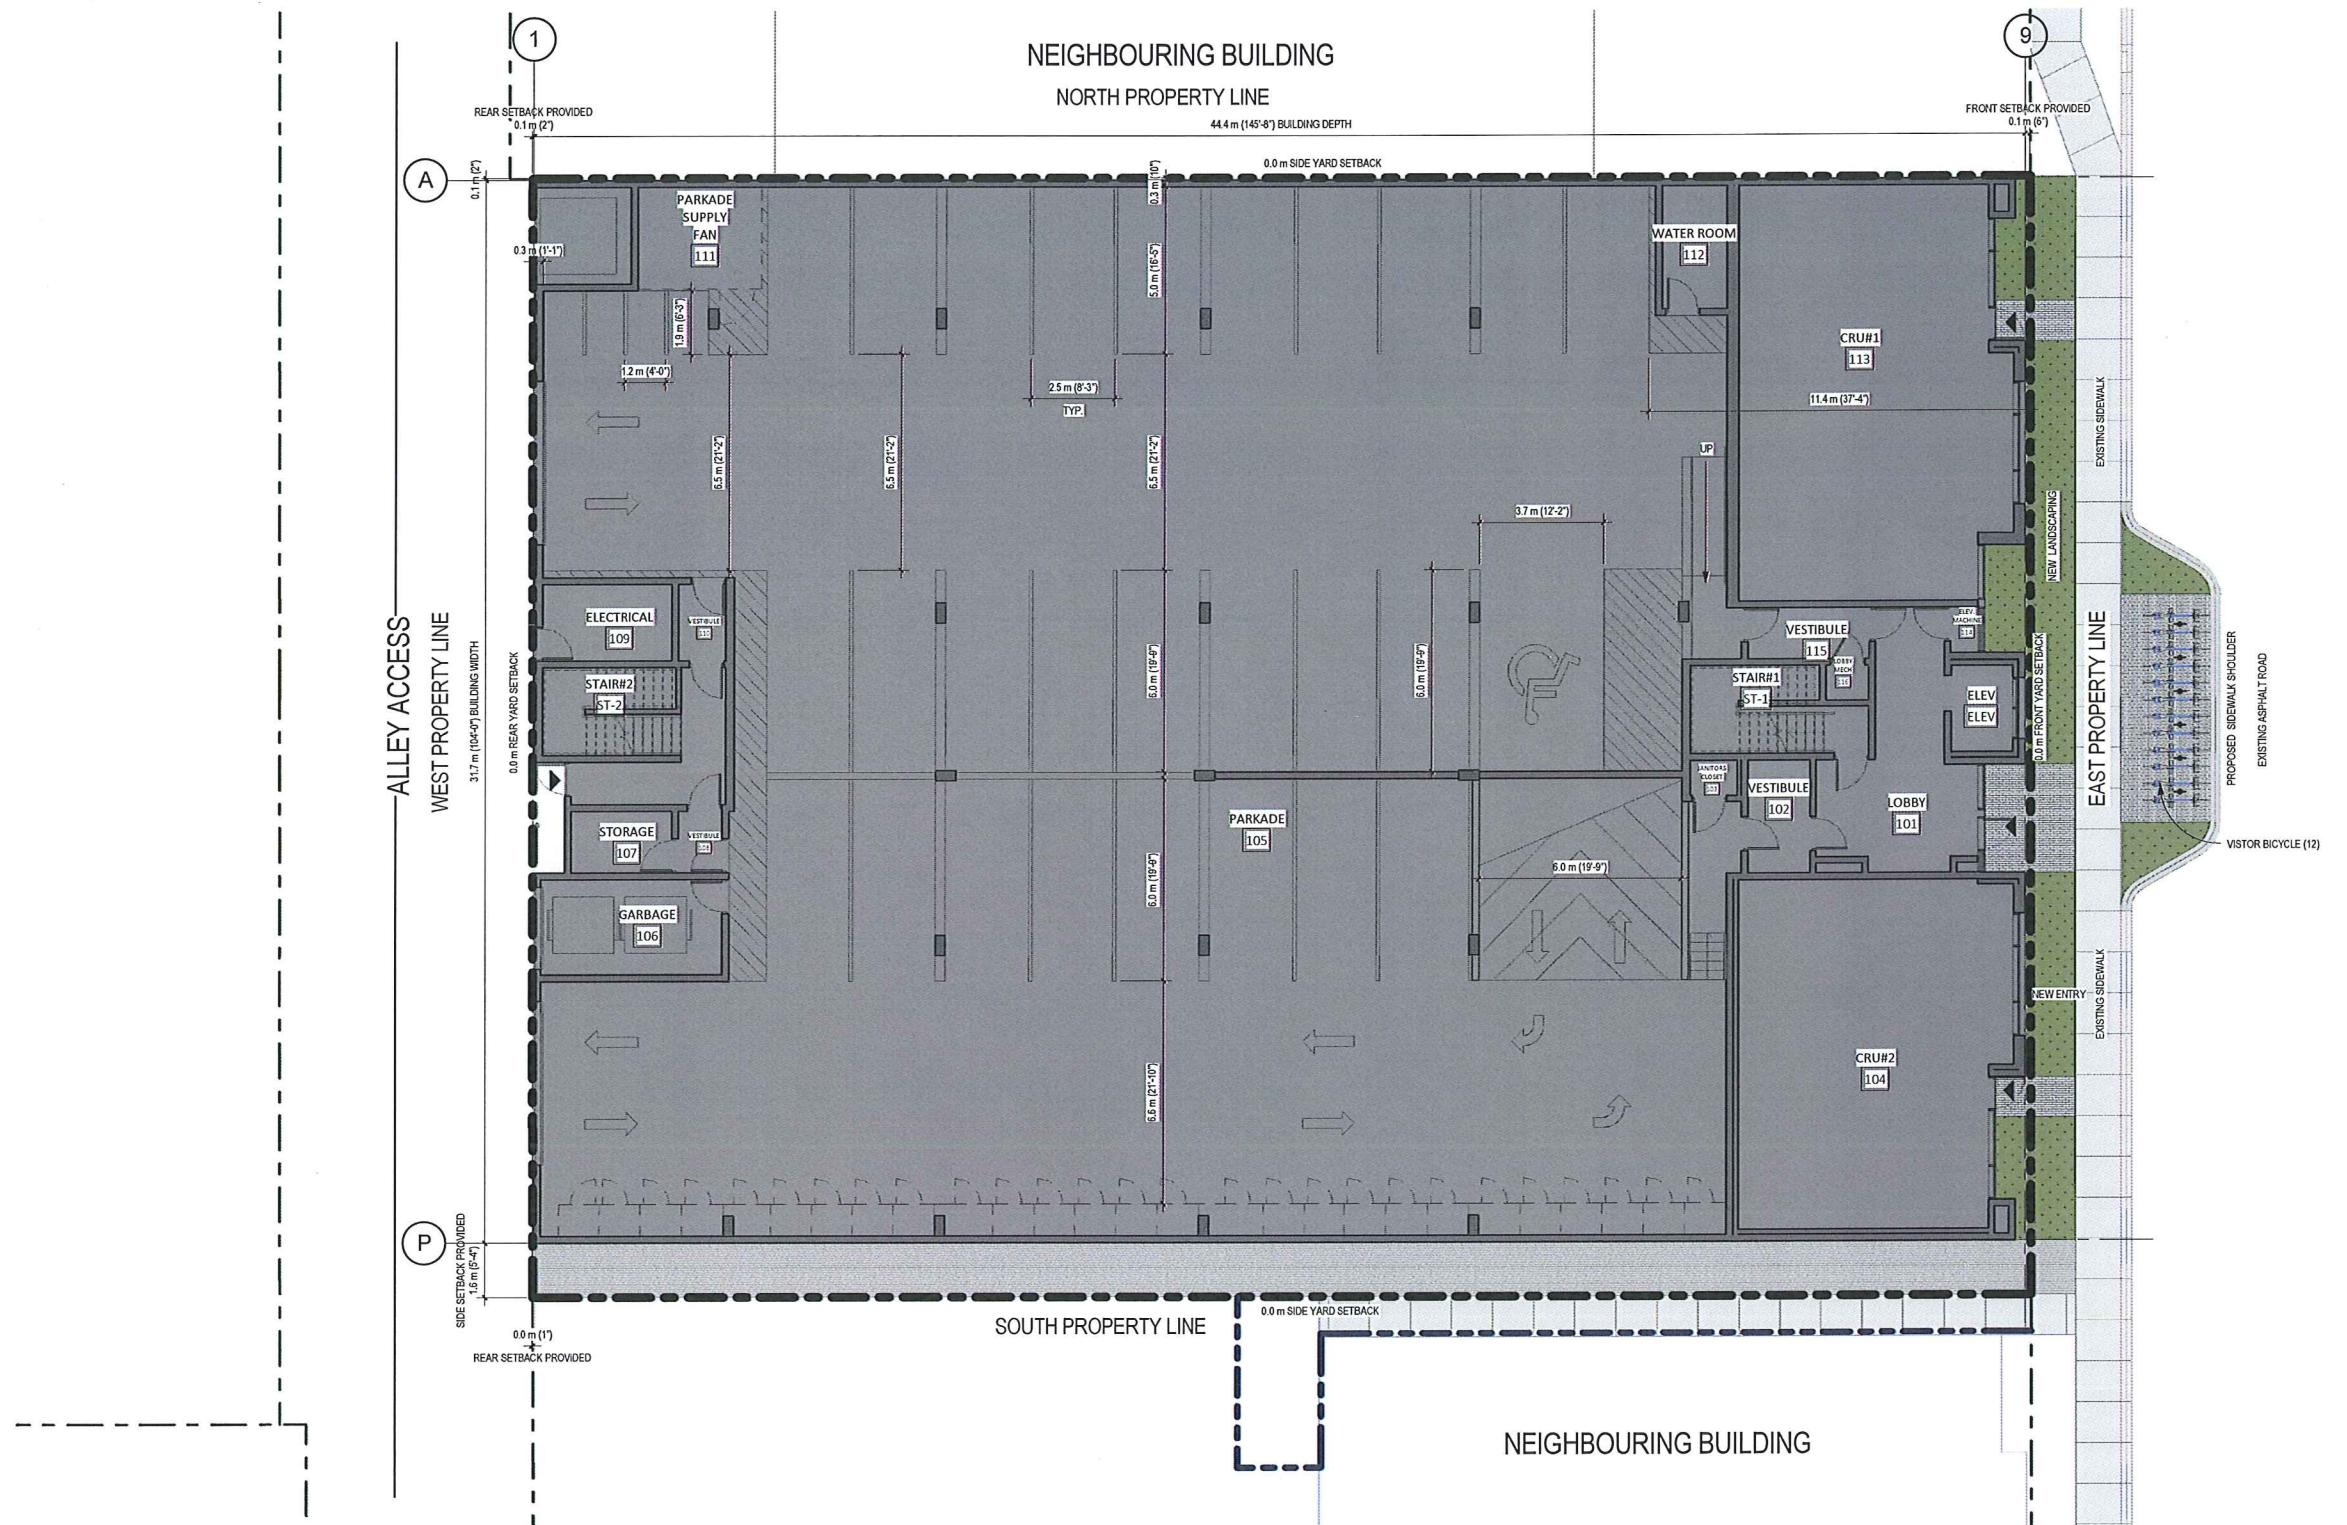


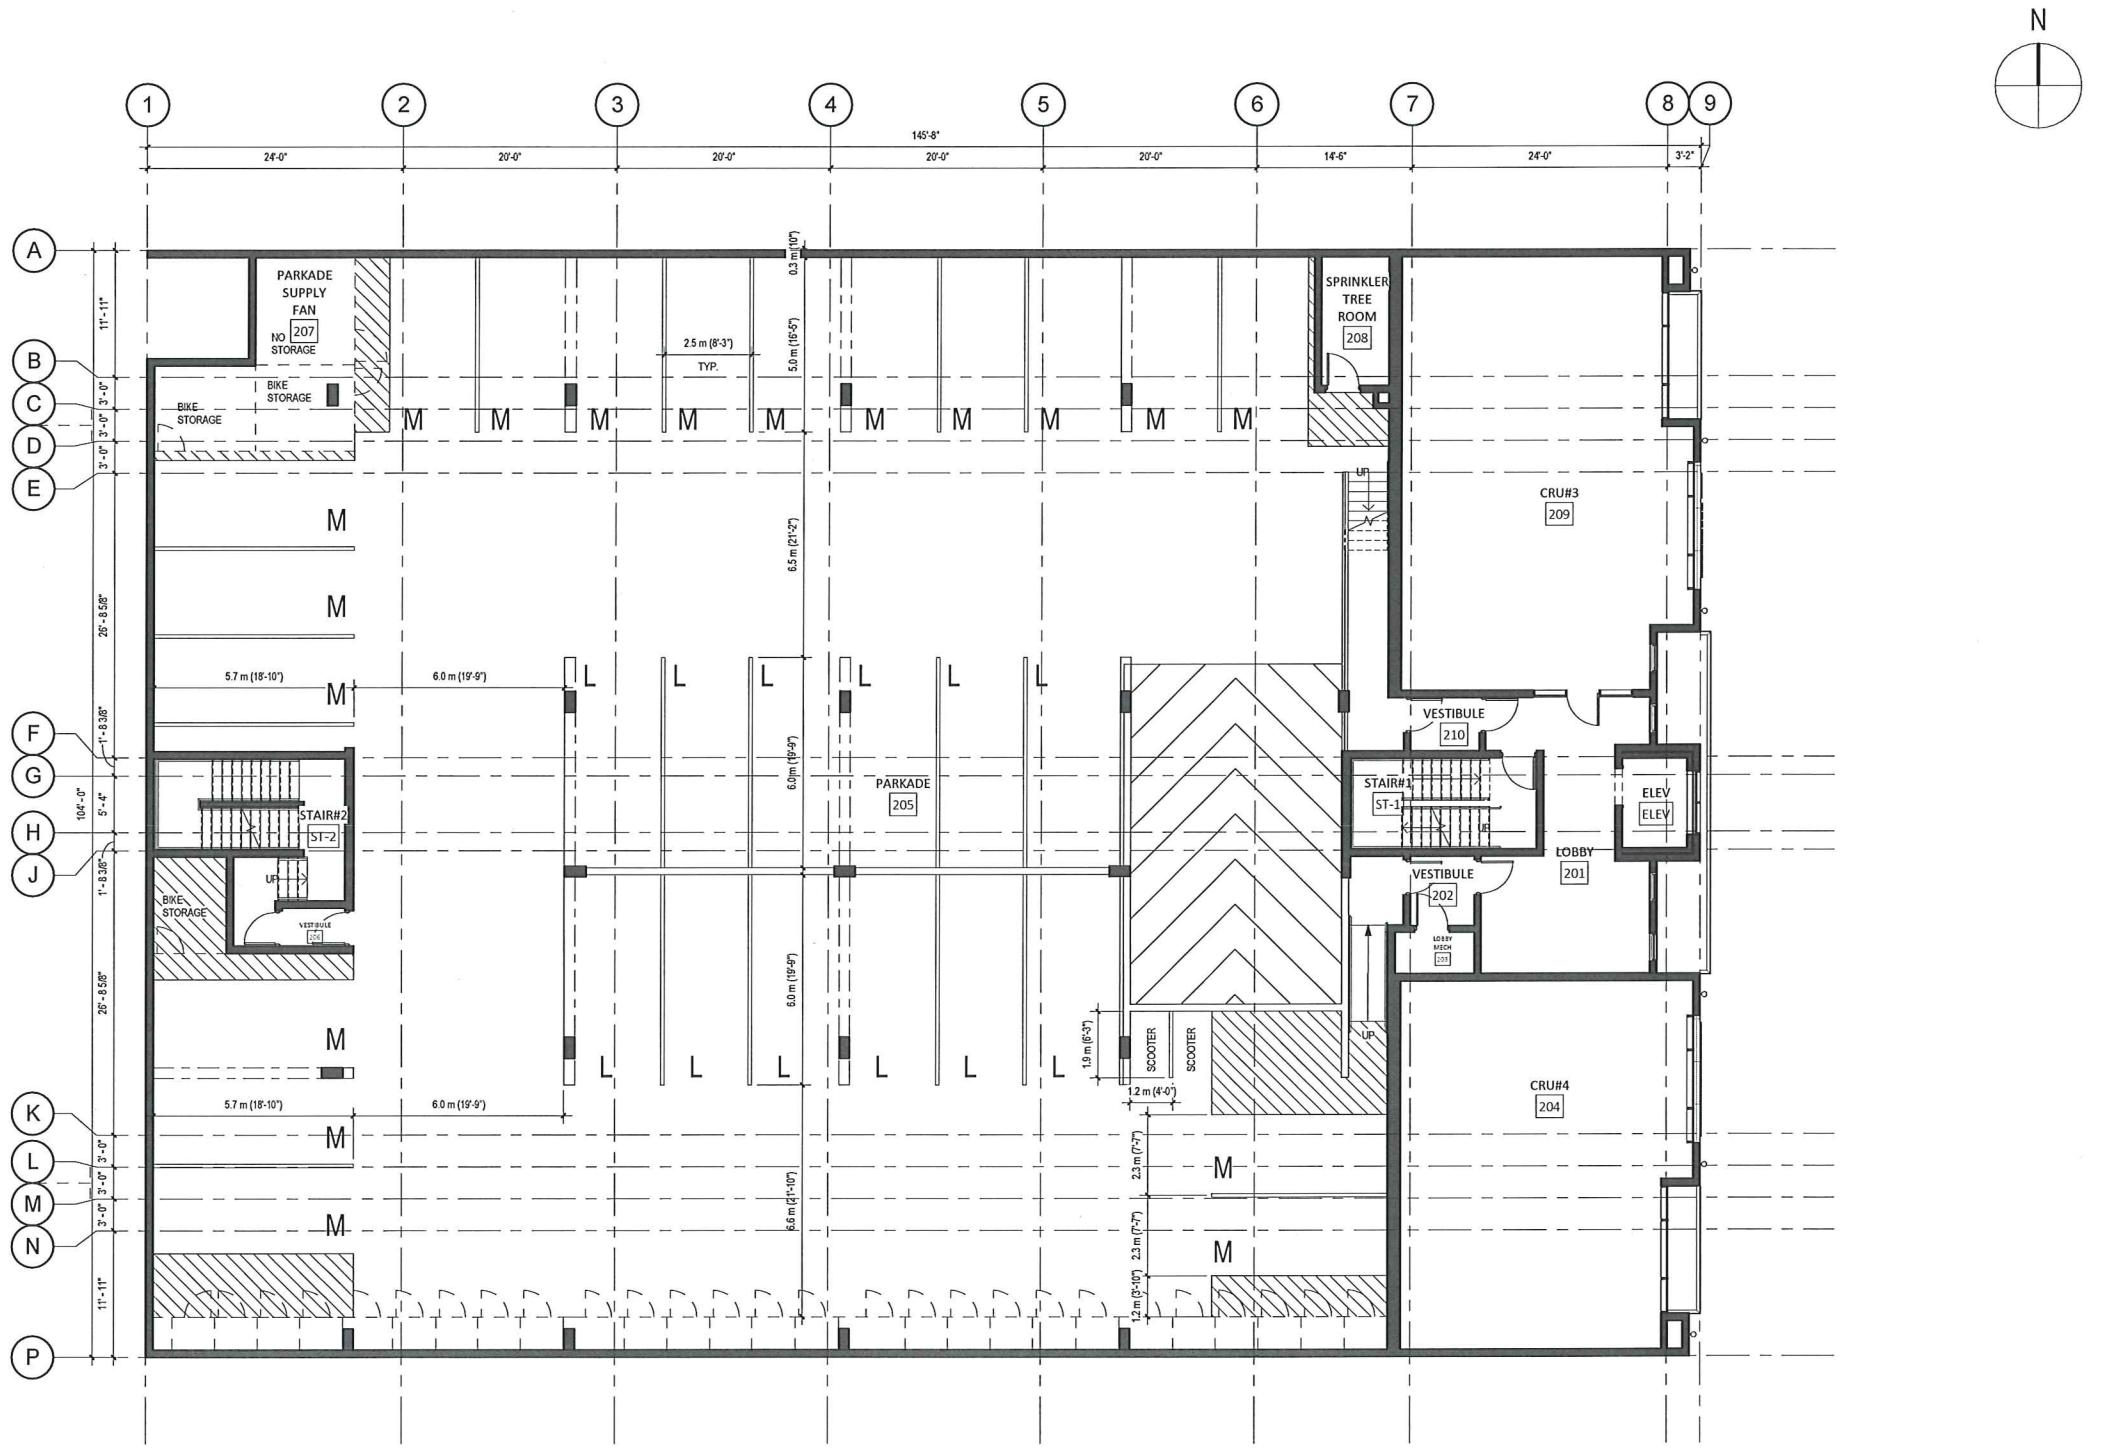

1 SECOND FLOOR PLAN  
A401 SCALE: 1/8" = 1'-0"

SUITE 2 - 1330 51ST FLOOR, VICTORIA, BC

SECOND FLOOR PLAN

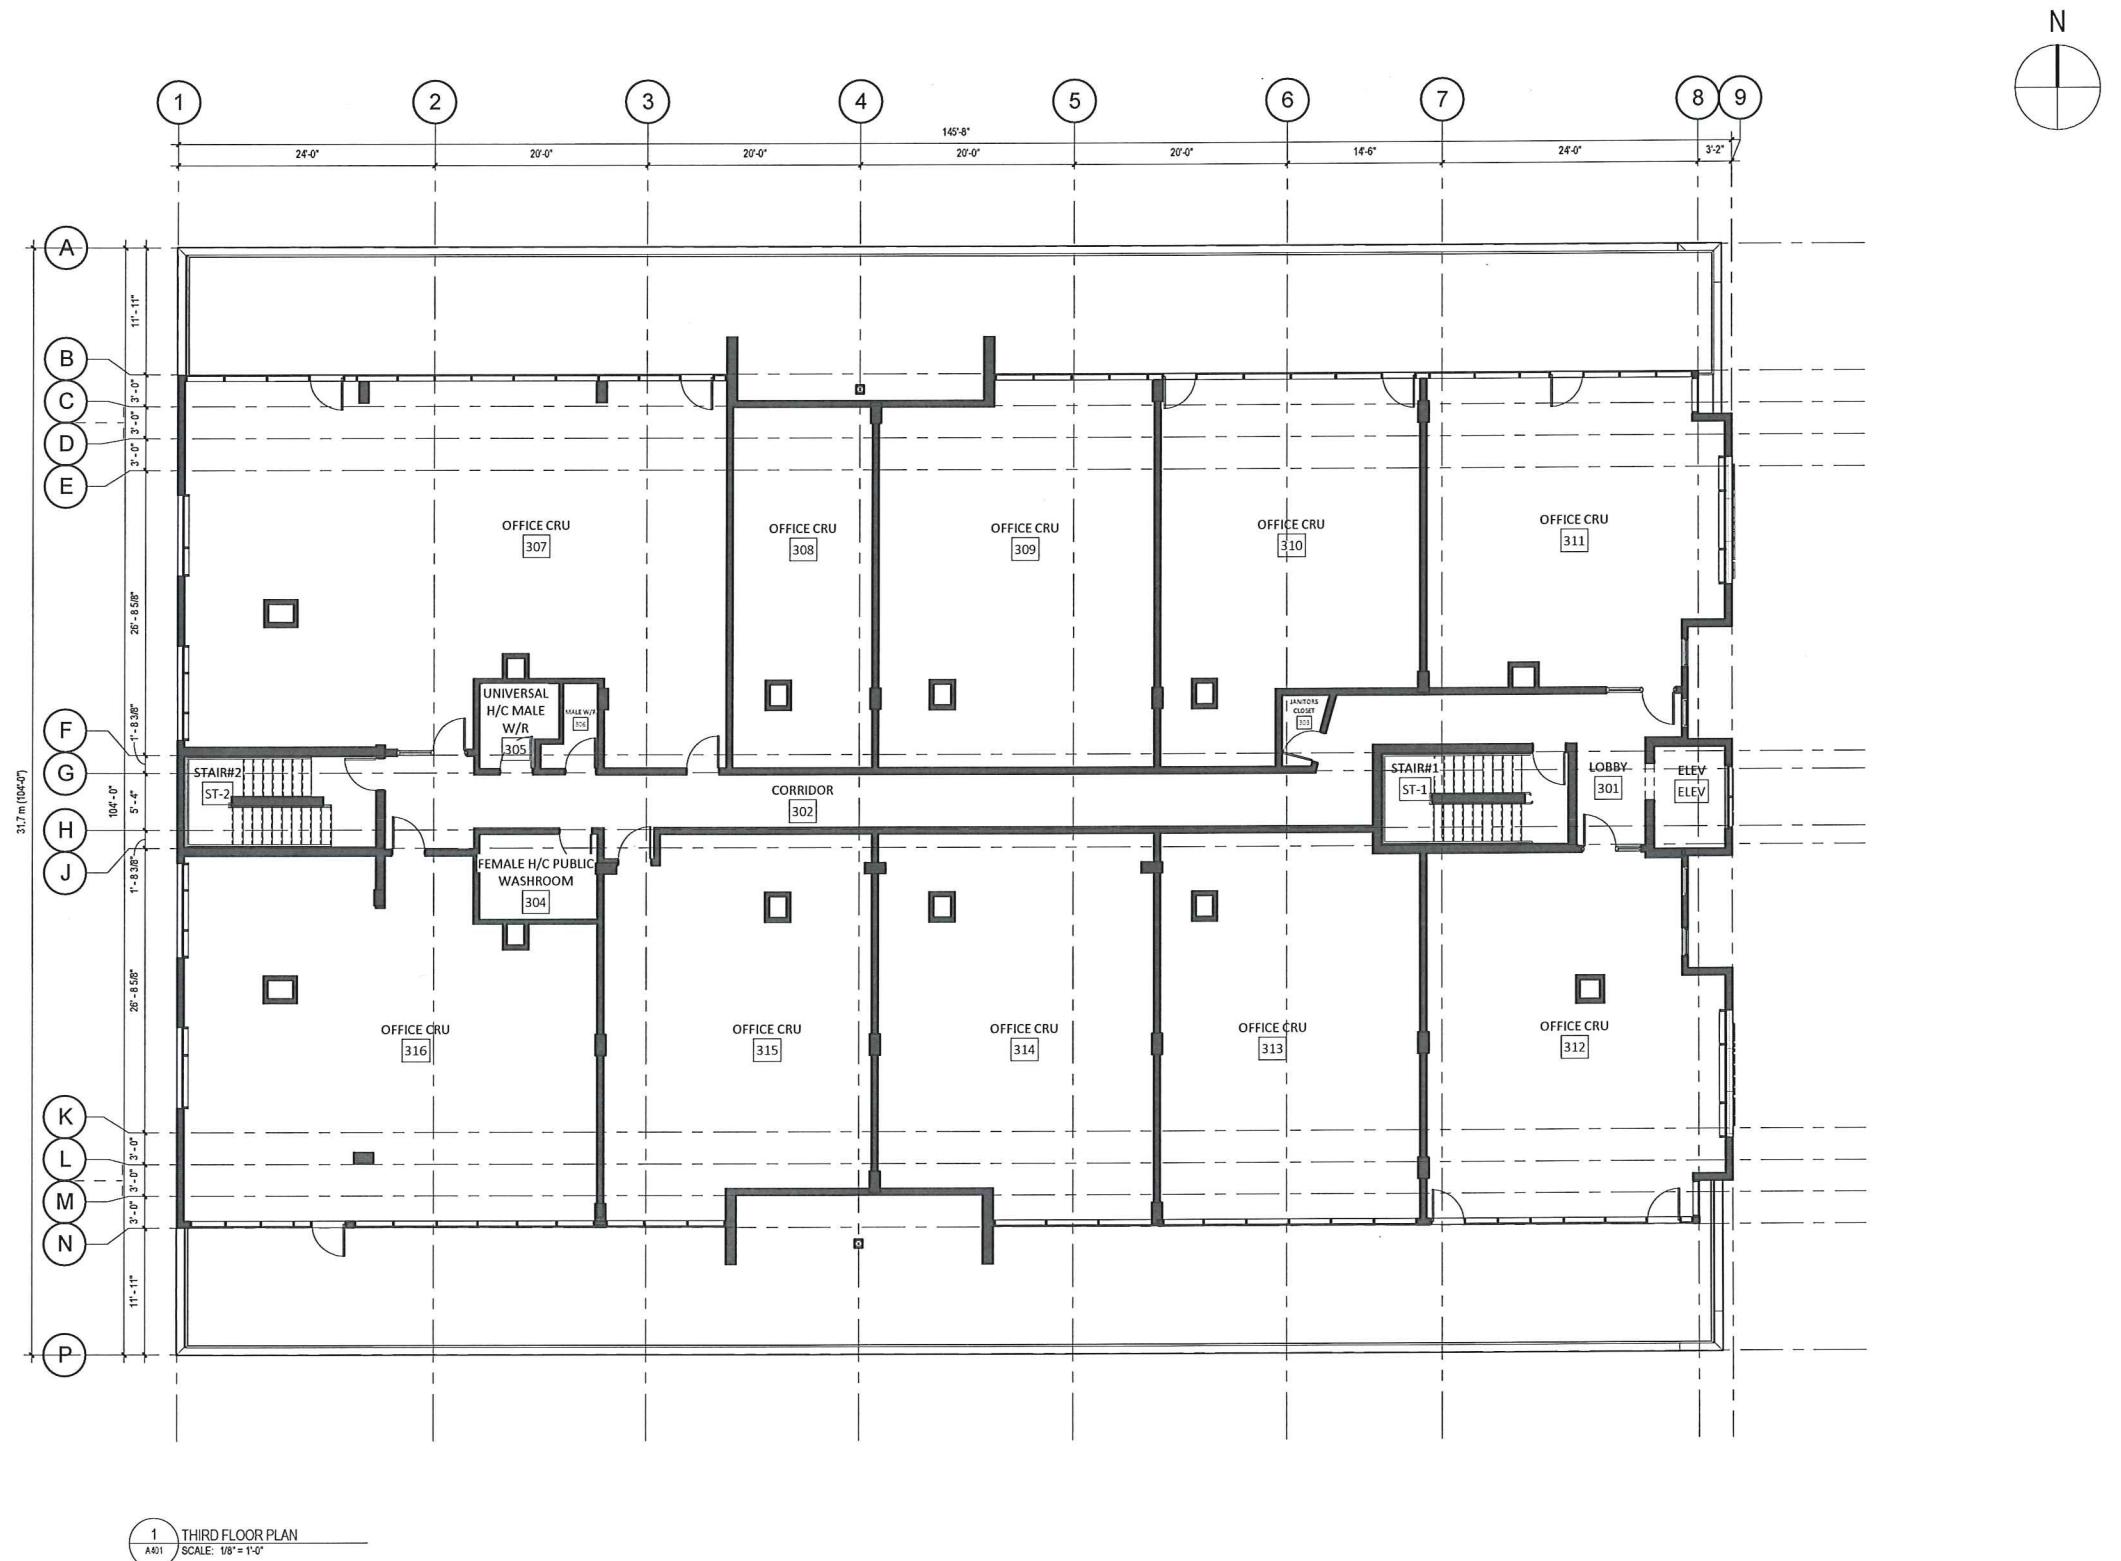

1  
A203  
THIRD FLOOR PLAN  
SCALE: 1/8 = 1'-0"

PROJECT: SOLE 2 - 1350 ST. PAUL STREET, KELowna, BC  
DRAWING: THIRD FLOOR PLAN  
DRAWING: A203  
DATE: 26/07/13  
REV: 1  
ISSUE: 1  
DRAFTSMAN: YYWAN  
DRAFTER: YYWAN  
CHECKER: YYWAN  
PROJECT: 15965  
ARCHITECTS: SOLE MIGON  
EDGECOMBE BUILDERS GROUP  
www.migondesign.com  
#100-2912b Ave, Vernon, BC V1T 2A7  
T: 250-245-1199



1 FOURTH FLOOR PLAN  
A011 SCALE: 1/8" = 1'-0"

DRAWING TITLE: FOURTH FLOOR PLAN

PROJECT TITLE: SOLE 2 - 1350 ST. PAUL STREET, KELOWNA, BC

PROJECT: 15965

DRAWING: A204

SCALE: 1/8" = 1'-0"

DATE: 26/03/13

DRAWN BY: AKEW

REVISION: 1-A

ISSUE: 1-A

DESIGNED BY: DEVELOPER/PERMITTER: NYVYAMO




1 FIFTH FLOOR PLAN  
A401 SCALE: 1/8" = 1'-0"

**DRAWING:** A205 **SCALE:** DRAWN BY: **1/4"** **DATE:** 10/10/13

לעומת פא

סמלב זי - 1990 גזע: אַבְּרָהָם אַבְּרָהָם, בָּבָן

**MQN**  
ARCHITECTS  
101-3035 32nd Ave., Vernon, BC V1T 2A7  
T: 250-542-1150  
PROJECT: 15965  
[www.mqnarchitects.com](http://www.mqnarchitects.com)

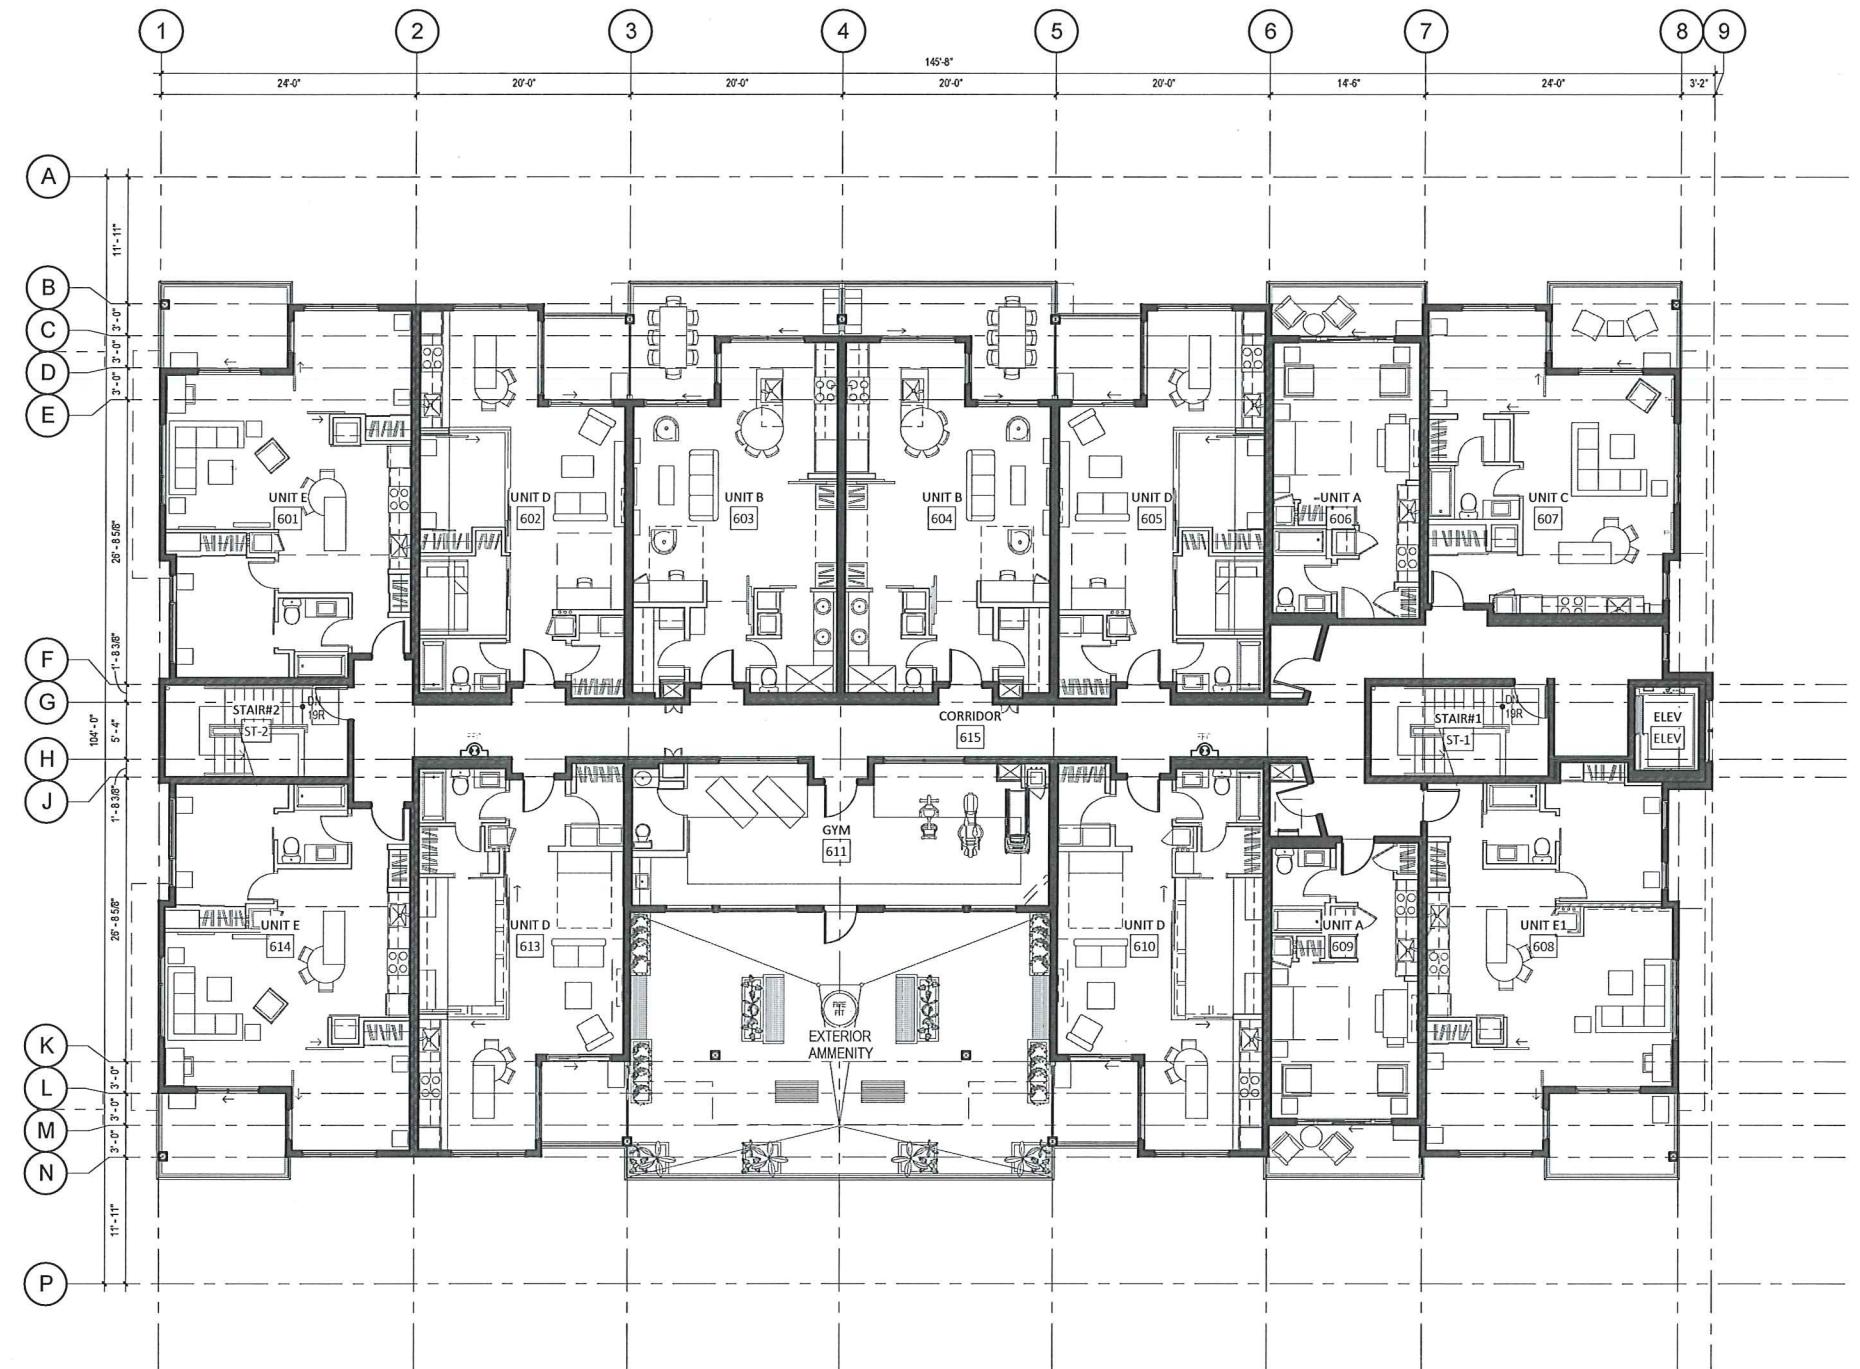

1 SIXTH FLOOR PLAN  
A201

NO. REV. ISSUE  
1-A ISSUED BY DEVELOPER/PERMIT  
20100103  
DRAWING NO. DRAWING  
A206  
SCALE: 1/8" = 1'-0"  
DRAFTSMAN: AArch

PRODUCT: 1350 St. Paul Street, Kelowna, BC  
PROJECT: 15965

EDGEcombe  
BUILDERS GROUP  
**SOLE**  
ARCHITECTS  
Big Life. Small Footprint  
IMQIN  
PRODUCT: 15965  
PROJECT: 1350 St. Paul Street, Kelowna, BC  
DRAFTSMAN: AArch



## EXTERIOR ELEVATIONS





SOLE 2 - 1330 ST. PAUL STREET, KELowna, BC

### EXTERIOR FINISH LEGEND


	<b>1</b>	ARCHITECTURAL CONCRETE, CONE SNAP TIE FORMING PROFILE: SMOOTH HORIZONTAL FORMS CW 2" REVEALS COLOUR: NATURAL CONCRETE (NO TINT OR SEALER)		<b>5</b>	STAINED & SEALED HEAVY TIMBER FRAMING FINISH: SATIN SHEEN ON PLANED & Sanded SURFACE COLOUR: DARK WALNUT TRANSLUCENT STAIN ON FIR		<b>9</b>	EXTERIOR GLASS RAILING FRAMING: ALUMINUM COLOUR: CHARCOAL - TO MATCH <6>
	<b>2</b>	TAUPE PTD. FIBER CEMENT VERTICAL SIDING PROFILE: SMOOTH FINISH CW H-CHANNEL JOINT COLOUR: BENJAMIN MOORE "METROPOLIS" CG-546		<b>6</b>	CHARCOAL HARDIE TRIM FASCIA & BELLY BANDS FINISH: SMOOTH COLOUR: CHARCOAL		<b>10</b>	DARK GREY PREFINISHED METAL FLASHING & COLUMN FINISH: SEMI-GLOSS COLOUR: CHARCOAL - TO MATCH <6>
	<b>3</b>	ORANGE PTD. FIBER CEMENT VERTICAL SIDING PROFILE: SMOOTH FINISH CW H-CHANNEL JOINT COLOUR: BENJAMIN MOORE "NAVAJO RED" 2171-10		<b>7</b>	EXTERIOR CLEAR CURTAIN WALL GLAZING FRAMING: ALUMINUM COLOUR: GALVALUME		<b>11</b>	LIGHT GREY PREFINISHED METAL FLASHING FINISH: SEMI-GLOSS COLOUR: GALVALUME - TO MATCH <4>
	<b>4</b>	GALVANIZED CORRUGATED METAL PANEL SIDING PROFILE: 7/8" SINE WAVE CORRUGATED COLOUR: GALVANIZED STEEL		<b>8</b>	EXTERIOR CLEAR GLAZING FRAMING: VINYL COLOUR: WHITE		<b>12</b>	OVERHEAD DOORS PROFILE: SMOOTH COLOUR: GALVANIZED STEEL

EMBER FRAMING FINISHED & SANDED SURFACE INSULCENT STAIN ON FIR	 	EXTERIOR GLASS RAILING FRAMING: ALUMINUM COLOUR: CHARCOAL - TO MATCH <6>	 	PRESSED STEEL DOORS PROFILE: SMOOTH COLOUR: GALVAMUME - TO MATCH <4>, <12>
ACIAS & BELLY BANDS	 	DARK GREY PREFINISHED METAL FLASHING & COLUMNS FINISH: SEMI-GLOSS COLOUR: CHARCOAL - TO MATCH <6>	 	PREFINISHED SPANDEL PANEL IN ALUMINUM ASSEMBLY FINISH: SMOOTH COLOUR: CHARCOAL - TO MATCH <6>
WALL GLAZING	 	LIGHT GREY PREFINISHED METAL FLASHING FINISH: SEMI-GLOSS COLOUR: GALVAMUME - TO MATCH <4>	 	2 PLY SBS ROOF MEMBRANE FINISH: SMOOTH COLOUR: BLACK
	 	OVERHEAD DOORS PROFILE: SMOOTH COLOUR: GALVANIZED STEEL		

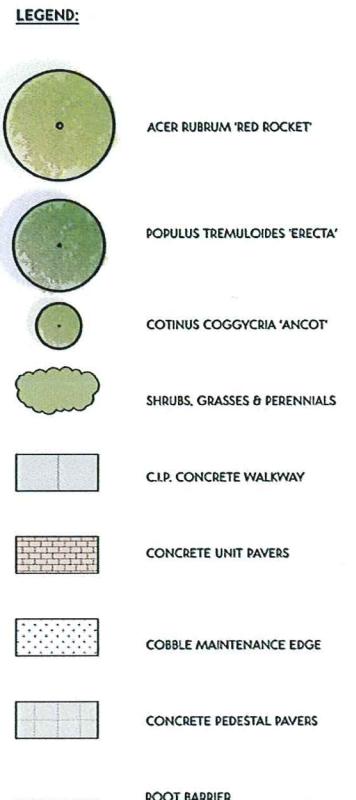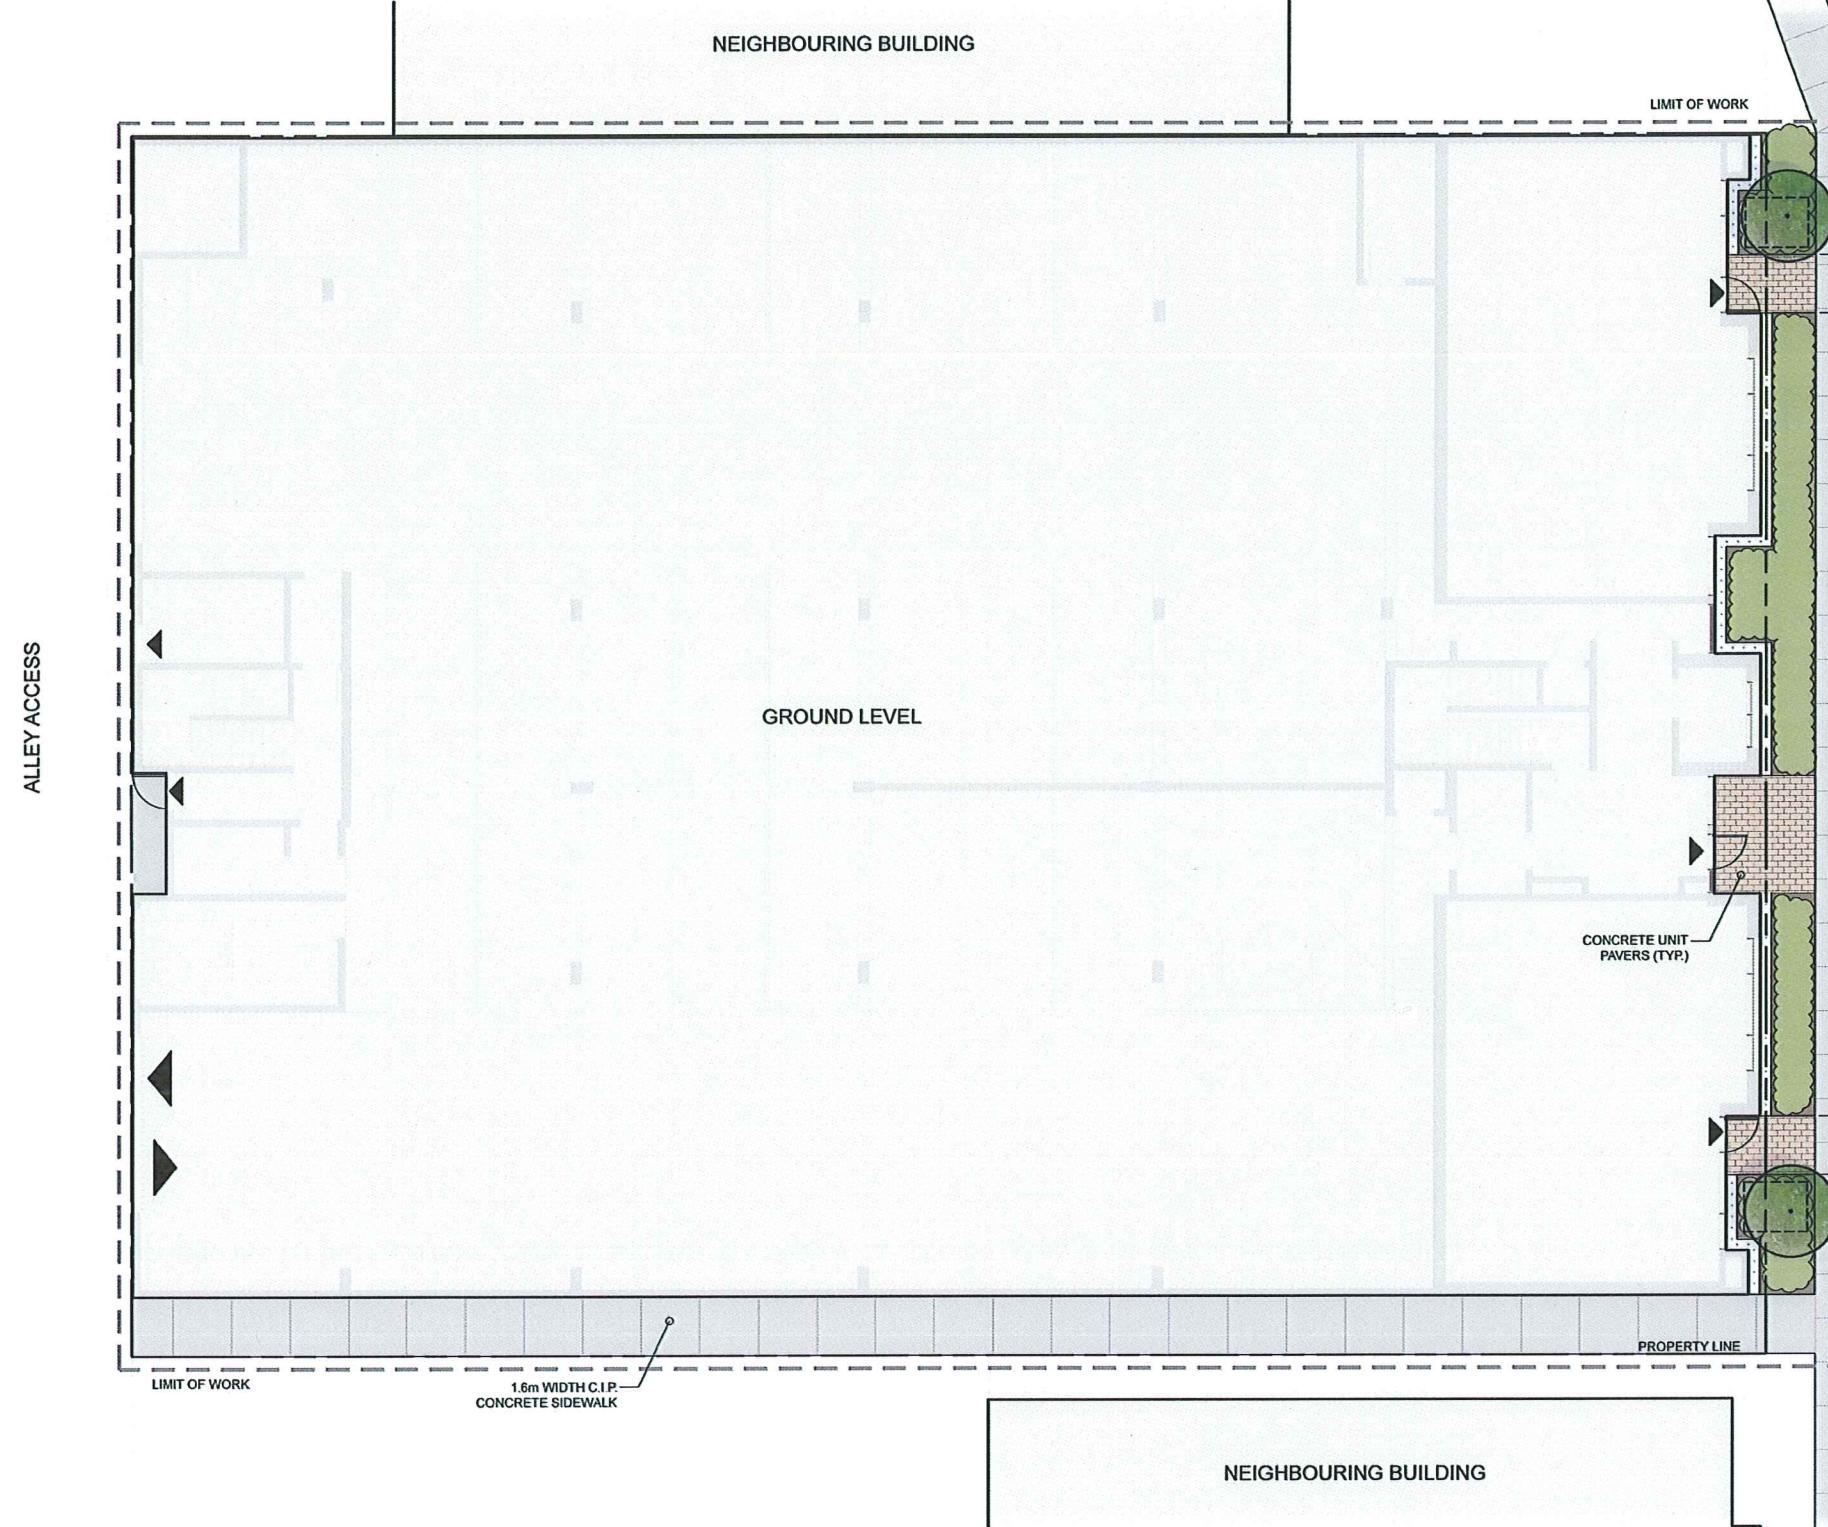

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REVISIONS / ISSUED:	
2 JAN 11/16	ISSUED FOR DP
1 JAN 08/16	ISSUED FOR REVIEW
NO. DATE	DESCRIPTION

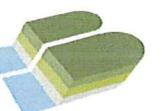

BENCH

SITE DESIGN

105-1209 Ellis Street, Kelowna BC V1V 9X5

1-250-660-6778

CLIENT:  
SOLE DOWNTOWN DEVELOPMENTS LTD.  
KELOWNA, B.C.

PROJECT:  
SOLE 2  
1350 ST. PAUL STREET  
KELOWNA, B.C.

Sheet Title  
LANDSCAPE PLAN  
LEVEL 1

DESIGN BY  
DRAWN BY  
CHECKED BY  
PROJECT NO.  
SCALE

Sheet No.

L-1.1

PLANT LIST:

TREES

Botanical Name	Common Name	Size	Root
<i>Acer rubrum 'Red Rocket'</i>	Red rocket maple	6 cm. Cal.	B&B
<i>Populus tremuloides 'Erecta'</i>	Columnar Swedish aspen	6 cm. Cal.	B&B

SHRUBS

Botanical Name	Common Name	Size/Spacing	Root
<i>Arctostaphylos uva-ursi</i>	Kinnickinnick	#01 Cont./0.6m O.C.	Potted
<i>Cotinus coggygria 'Ancot'</i>	Golden spirit smoketree	#05 Cont./ N/A	Potted


PERENNIALS & GRASSES

Botanical Name	Common Name	Size/Spacing	Root
<i>Alchemilla mollis</i>	Lady's mantle	#01 Cont./0.6m O.C.	Potted
<i>Calamagrostis brachytricha</i>	Korean feather reed grass	#01 Cont./0.60m O.C.	Potted
<i>Echinacea 'White Swan'</i>	White swan coneflower	#01 Cont./0.60m O.C.	Potted
<i>Festuca idahoensis 'Joseph'</i>	Joseph Idaho fescue	#01 Cont./0.3m O.C.	Potted
<i>Helleborus orientalis</i>	Lenten rose	#01 Cont./0.45m O.C.	Potted
<i>Sesleria autumnalis</i>	Autumn moor grass	#01 Cont./0.3m O.C.	Potted

DEVELOPMENT PERMIT NOTES:

- A PLANT MATERIALS AND CONSTRUCTION METHODS SHALL CONFORM TO MINIMUM STANDARDS ESTABLISHED IN THE LATEST EDITION OF THE B.C. LANDSCAPE STANDARDS, PUBLISHED BY B.C.N.T.A. AND B.C.S.L.A. AS WELL AS THE CITY OF KELOWNA LANDSCAPE STANDARDS IN BYLAW 7900.
- B THE LANDSCAPE DESIGN DESIGNATED HEREIN IS CONCEPTUAL BUT REFLECTS THE MINIMUM CITY OF KELOWNA FORM AND CHARACTER REQUIREMENTS.
- C PLANT MATERIAL SELECTIONS ARE CONCEPTUAL ONLY. FINAL PLANTING SELECTIONS MAY VARY DEPENDING UPON AVAILABILITY AT THE TIME OF CONSTRUCTION.
- D TREES SHALL BE INSTALLED IN DEFINED SOIL PITS OR PLANTING BED AREAS. ADEQUATE SOIL VOLUME SHALL BE PROVIDED BASED ON THE SPECIFIED TREE SPECIES AND LOCATION.
- E ORNAMENTAL SHRUB, GRASS AND PERENNIAL CLUSTERS ARE TO BE PLACED WITHIN DEFINED PLANTING BEDS. ALL PLANTING BEDS SHALL HAVE A MIN. OF 450mm (18") IMPORTED GROWING MEDIUM AND 75mm (3") OF COMPOSTED MULCH OR APPROVED EQUAL.
- F A HIGH EFFICIENCY IRRIGATION SYSTEM SHALL BE INSTALLED FOR ALL ORNAMENTAL LANDSCAPE AREAS AND SHALL CONFORM TO THE CITY OF KELOWNA'S IRRIGATION STANDARDS IN BYLAW 7900.

ALLEY ACCESS

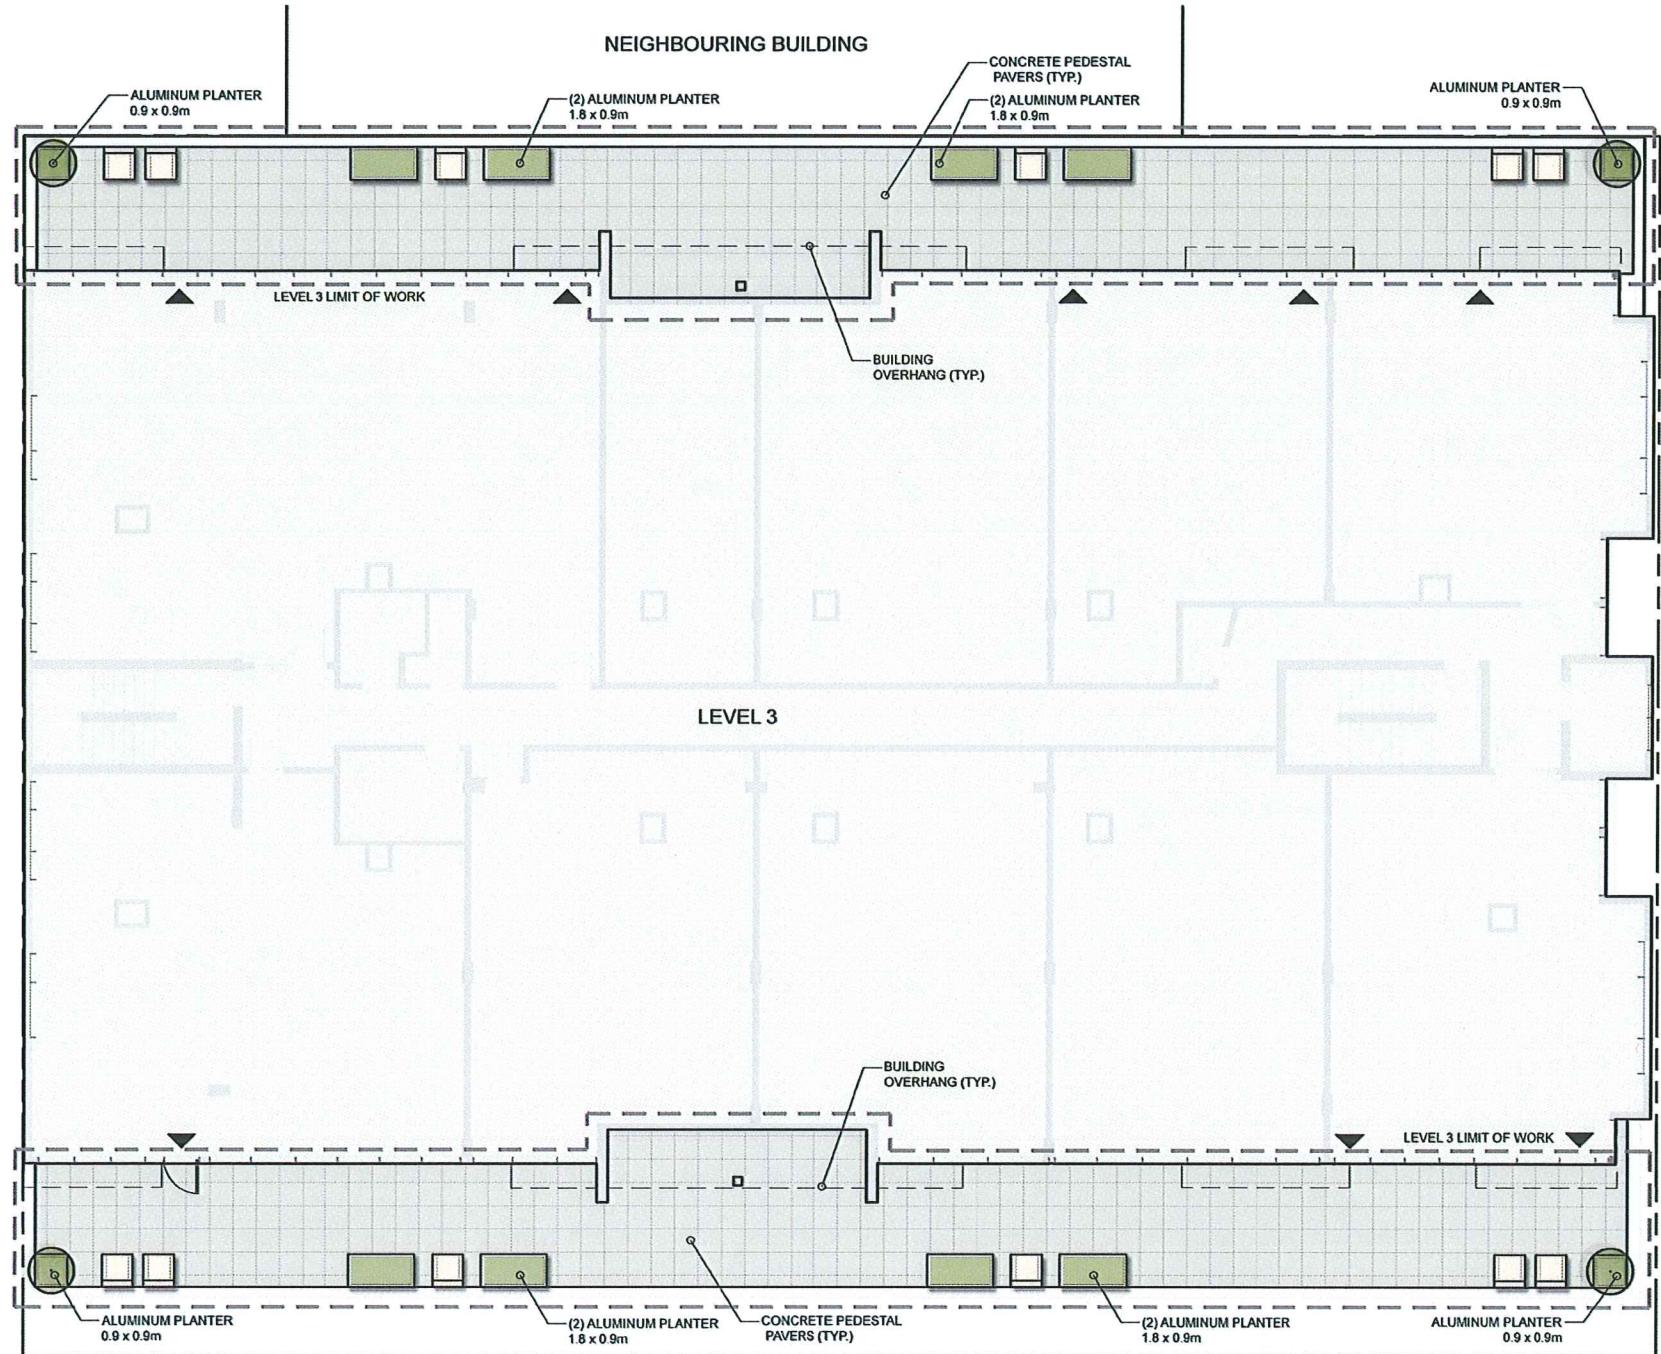

NEIGHBOURING BUILDING

PLANT LIST:

TREES

Botanical Name	Common Name	Size	Root
<i>Acer rubrum 'Red Rocket'</i>	Red rocket maple	6 cm. Cal.	B&B
<i>Populus tremuloides 'Erecta'</i>	Columnar Swedish aspen	6 cm. Cal.	B&B

SHRUBS

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<i>Cotinus coggygria 'Ancot'</i>	Golden spirit smoketree	#05 Cont./N/A	Potted


PERENNIALS & GRASSES

Botanical Name	Common Name	Size/Spacing	Root
<i>Alchemilla mollis</i>	Lady's mantle	#01 Cont./0.6m O.C.	Potted
<i>Calamagrostis brachytricha</i>	Korean feather reed grass	#01 Cont./0.60m O.C.	Potted
<i>Echinacea 'White Swan'</i>	White swan coneflower	#01 Cont./0.60m O.C.	Potted
<i>Festuca idahoensis 'Joseph'</i>	Joseph Idaho fescue	#01 Cont./0.3m O.C.	Potted
<i>Helleborus orientalis</i>	Lenten rose	#01 Cont./0.45m O.C.	Potted
<i>Sesleria autumnalis</i>	Autumn moor grass	#01 Cont./0.3m O.C.	Potted

DEVELOPMENT PERMIT NOTES:

- A PLANT MATERIALS AND CONSTRUCTION METHODS SHALL CONFORM TO MINIMUM STANDARDS ESTABLISHED IN THE LATEST EDITION OF THE B.C. LANDSCAPE STANDARDS, PUBLISHED BY B.C.N.T.A. AND B.C.S.L.A. AS WELL AS THE CITY OF KELOWNA LANDSCAPE STANDARDS IN BYLAW 7900.
- B THE LANDSCAPE DESIGN DESIGNATED HEREIN IS CONCEPTUAL BUT REFLECTS THE MINIMUM CITY OF KELOWNA FORM AND CHARACTER REQUIREMENTS.
- C PLANT MATERIAL SELECTIONS ARE CONCEPTUAL ONLY. FINAL PLANTING SELECTIONS MAY VARY DEPENDING UPON AVAILABILITY AT THE TIME OF CONSTRUCTION.
- D TREES SHALL BE INSTALLED IN DEFINED SOIL PITS OR PLANTING BED AREAS. ADEQUATE SOIL VOLUME SHALL BE PROVIDED BASED ON THE SPECIFIED TREE SPECIES AND LOCATION.
- E ORNAMENTAL SHRUB, GRASS AND PERENNIAL CLUSTERS ARE TO BE PLACED WITHIN DEFINED PLANTING BEDS. ALL PLANTING BEDS SHALL HAVE A MIN. OF 450mm (18") IMPORTED GROWING MEDIUM AND 75mm (3") OF COMPOSTED MULCH OR APPROVED EQUAL.
- F A HIGH EFFICIENCY IRRIGATION SYSTEM SHALL BE INSTALLED FOR ALL ORNAMENTAL LANDSCAPE AREAS AND SHALL CONFORM TO THE CITY OF KELOWNA'S IRRIGATION STANDARDS IN BYLAW 7900.

LEGEND:

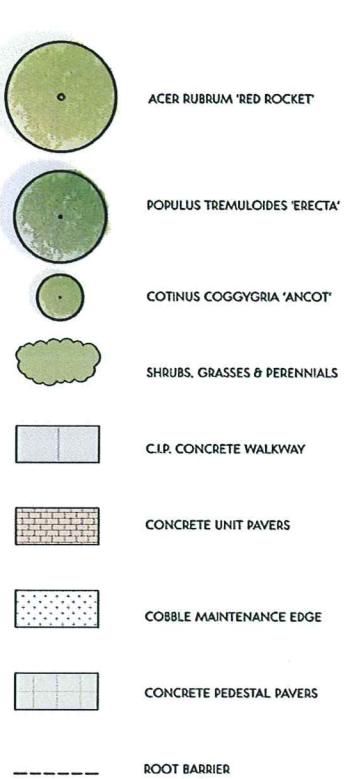

REVISIONS / ISSUED:

2 JAN 11/16 ISSUED FOR DP  
1 JAN 08/16 ISSUED FOR REVIEW  
NO. DATE DESCRIPTION



CLIENT:  
SOLE DOWNTOWN DEVELOPMENTS LTD.  
KELOWNA, B.C.



PROJECT:  
SOLE 2  
1350 ST. PAUL STREET  
KELOWNA, B.C.

SHEET TITLE  
LANDSCAPE PLAN  
LEVEL 3

DESIGN BY: XS  
DRAWN BY: SD  
CHECKED BY: XS  
PROJECT NO.: 16-001  
SCALE: 1:100

SHEET NO.

L-1.2

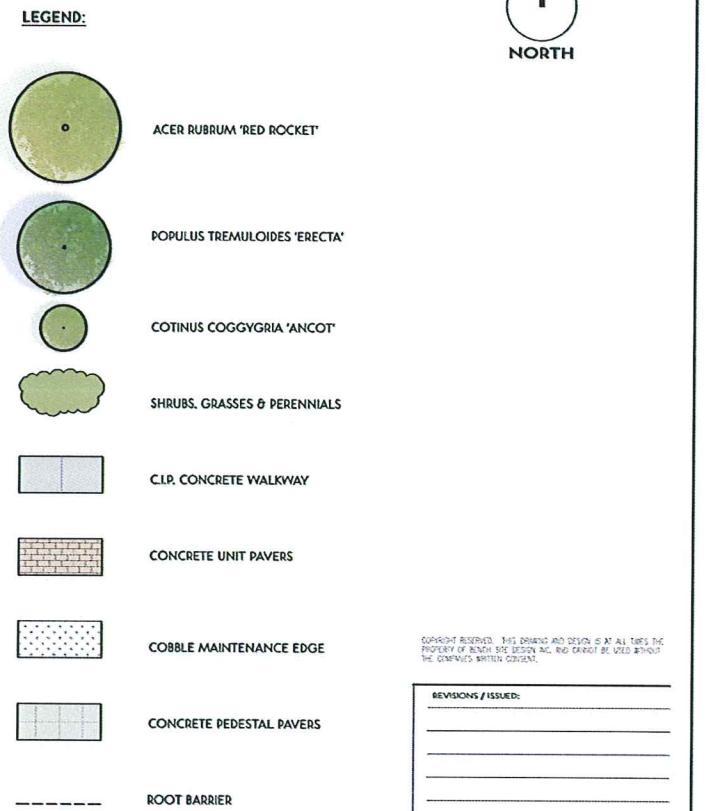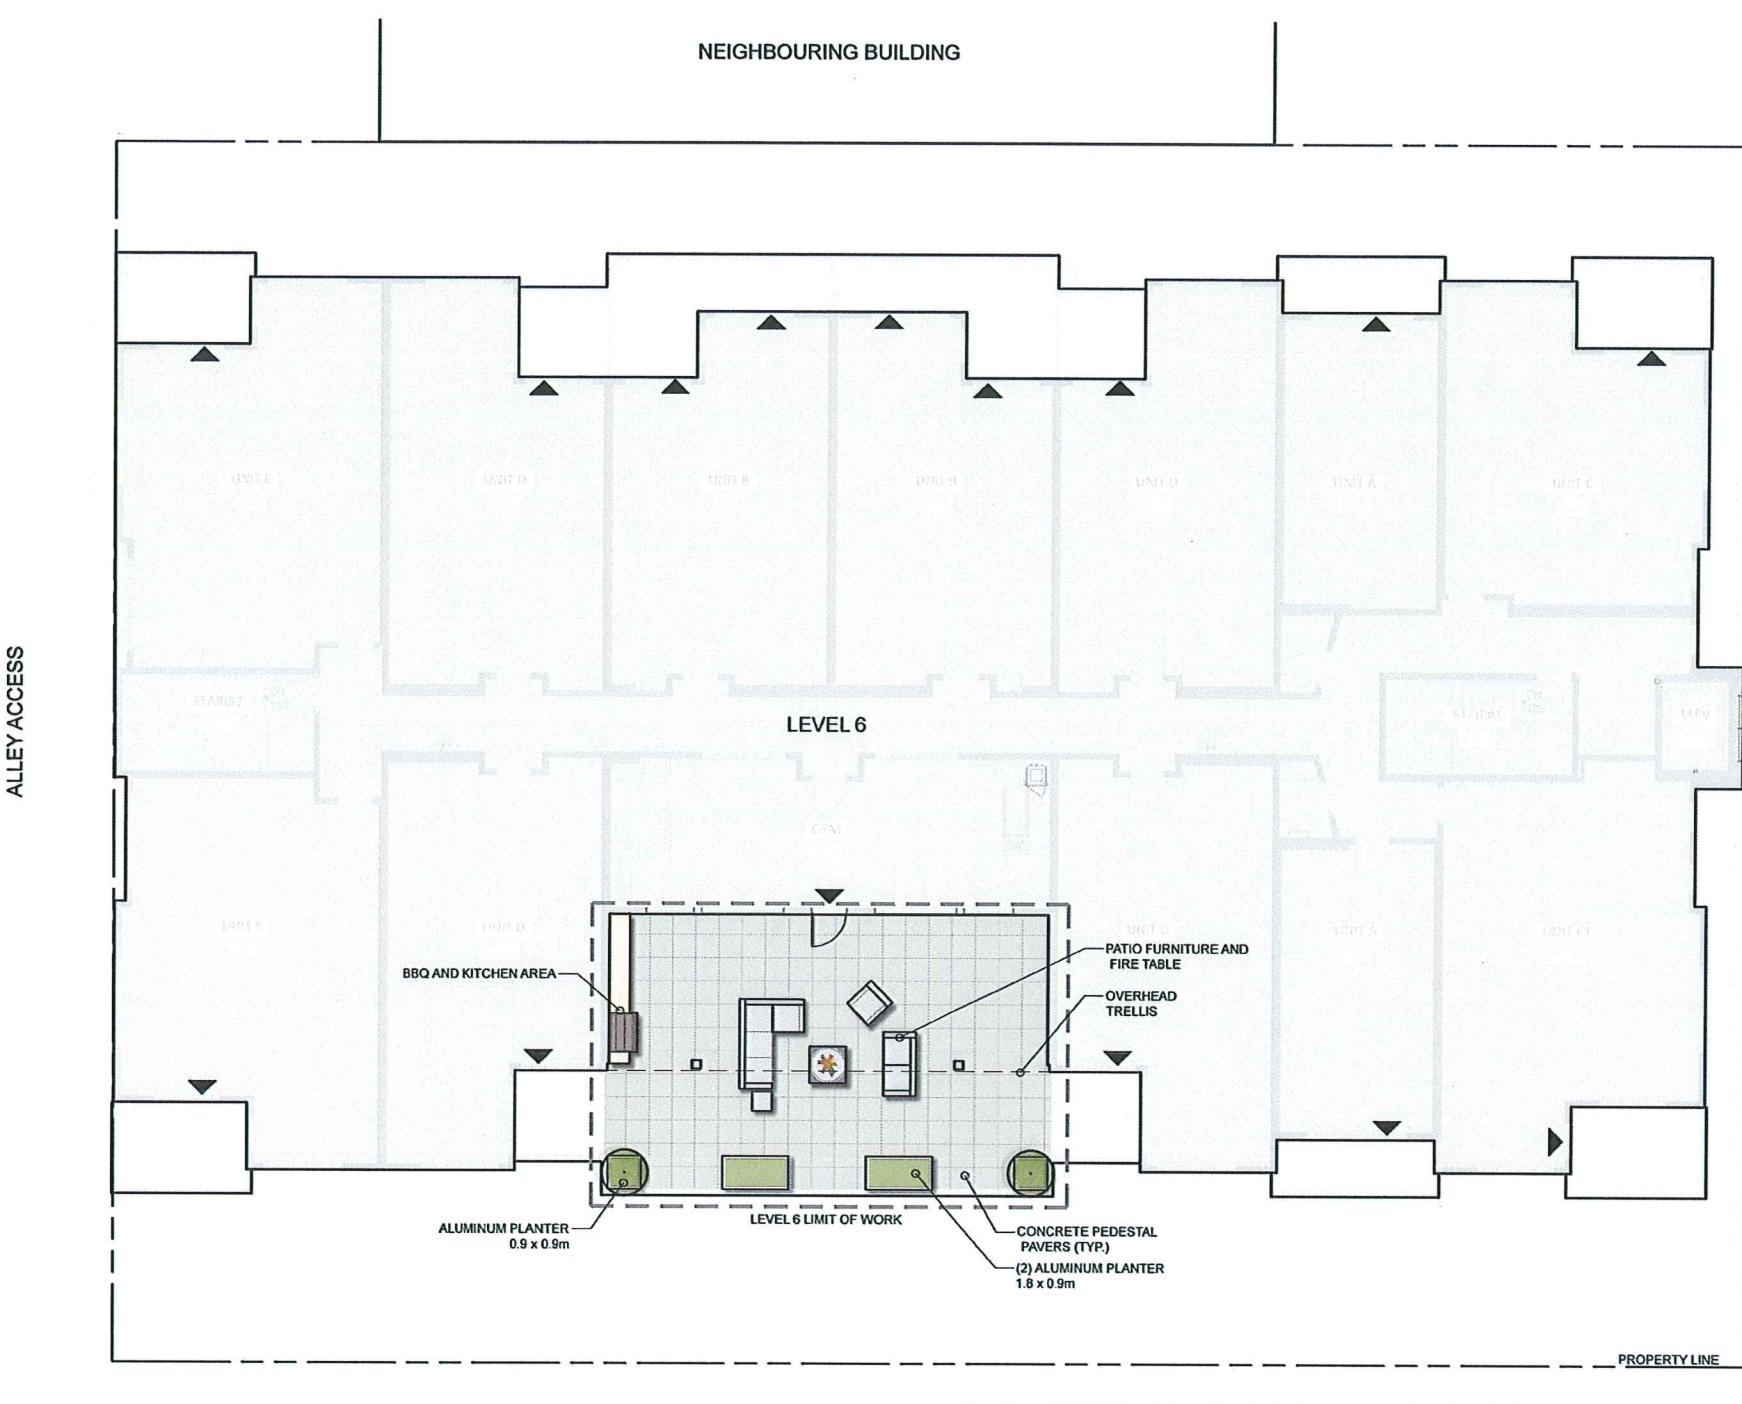

REVISIONS / ISSUED:

2	JAN	11/16	ISSUED FOR DP
1	JAN	05/16	ISSUED FOR REVIEW
NO. DATE		DESCRIPTION	



CLIENT:  
SOLE DOWNTOWN  
DEVELOPMENTS LTD.  
KELOWNA, B.C.

PROJECT:  
SOLE 2  
1350 ST. PAUL STREET  
KELOWNA, B.C.

SHEET TITLE  
LANDSCAPE PLAN  
LEVEL 6

DESIGN BY	XS
DRAWN BY	SD
CHECKED BY	XS
PROJECT NO.	16-001
SCALE	1:100

NOTE NO.

L-1.3

**PLANT LIST:**

**TREES**

Botanical Name	Common Name	Size	Root
<i>Acer rubrum 'Red Rocket'</i>	Red rocket maple	6 cm. Cal.	B&B
<i>Populus tremuloides 'Erecta'</i>	Columnar Swedish aspen	6 cm. Cal.	B&B

**SHRUBS**

Botanical Name	Common Name	Size/Spacing	Root
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<i>Cotinus coggygria 'Ancot'</i>	Golden spirit smoke tree	#05 Cont./N/A	Potted

**PERENNIALS & GRASSES**

Botanical Name	Common Name	Size/Spacing	Root
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<i>Calamagrostis brachytricha</i>	Korean feather reed grass	#01 Cont./0.60m O.C.	Potted
<i>Echinacea 'White Swan'</i>	White swan coneflower	#01 Cont./0.60m O.C.	Potted
<i>Festuca idahoensis 'Joseph'</i>	Joseph Idaho fescue	#01 Cont./0.3m O.C.	Potted
<i>Helleborus orientalis</i>	Lenten rose	#01 Cont./0.45m O.C.	Potted
<i>Sesleria autumnalis</i>	Autumn moor grass	#01 Cont./0.3m O.C.	Potted

**DEVELOPMENT PERMIT NOTES:**

- A PLANT MATERIALS AND CONSTRUCTION METHODS SHALL CONFORM TO MINIMUM STANDARDS ESTABLISHED IN THE LATEST EDITION OF THE B.C. LANDSCAPE STANDARDS, PUBLISHED BY B.C.N.T.A. AND B.C.S.L.A. AS WELL AS THE CITY OF KELOWNA LANDSCAPE STANDARDS IN BYLAW 7900.
- B THE LANDSCAPE DESIGN DESIGNATED HEREIN IS CONCEPTUAL BUT REFLECTS THE MINIMUM CITY OF KELOWNA FORM AND CHARACTER REQUIREMENTS
- C PLANT MATERIAL SELECTIONS ARE CONCEPTUAL ONLY. FINAL PLANTING SELECTIONS MAY VARY DEPENDING UPON AVAILABILITY AT THE TIME OF CONSTRUCTION.
- D TREES SHALL BE INSTALLED IN DEFINED SOIL PITS OR PLANTING BED AREAS. ADEQUATE SOIL VOLUME SHALL BE PROVIDED BASED ON THE SPECIFIED TREE SPECIES AND LOCATION.
- E ORNAMENTAL SHRUB, GRASS AND PERENNIAL CLUSTERS ARE TO BE PLACED WITHIN DEFINED PLANTING BEDS. ALL PLANTING BEDS SHALL HAVE A MIN. OF 450mm (18") IMPORTED GROWING MEDIUM AND 75mm (3") OF COMPOSTED MULCH OR APPROVED EQUAL.
- F A HIGH EFFICIENCY IRRIGATION SYSTEM SHALL BE INSTALLED FOR ALL ORNAMENTAL LANDSCAPE AREAS AND SHALL CONFORM TO THE CITY OF KELOWNA'S IRRIGATION STANDARDS IN BYLAW 7900.

NEIGHBOURING BUILDING



L-1.3