



Design Rational

Green Square RM5 Development at Mission Springs Drive

The fundamental approach to the building forms and massing has been to maximize the open space, increase the amount of green space, open up view corridors between built forms through the site, and provide an overall increase in daylight to the interior and exterior spaces.

The central green square not only provides a functional community green space but acts as a hub in pedestrian connections internally and to the adjacent community. The sheltered and secure environment of the square will ensure its success as an informal gathering space. These qualities have been achieved through the employment of the four taller buildings rather than the single larger more typical solution.

Two roof top terrace amenities have been provided, one on building A and one on building C.

The parkade structures are flanked on the exterior sides by townhomes. These three bedroom units encourage a mixed demographic. Their patios utilize the landscaped parkade podium roof. They also provide a vibrant connectivity between the project and Mission Springs Drive and adjacent public spaces.

The smaller floor plates allowed for a high percentage of corner units, the decks for these units became a central architectural theme by the choice of material and the open and extending form.

The general architecture of material and colour has been chosen to blend in with the adjacent townhomes.

The project requires a number of variances.

- As described above the buildings are 5 and six stories in height to achieve maximum green space, openness and daylight. Parapet heights' excluding roof access elements from lowest average grades is 20.5m.
- The side yard set back of 4.5m has a limit of a 2.5 storeys building height. Due to the limitation of excavation depth as a result of a high water table (344.5m) the parkade structures define our main floor elevations. In keeping with the design objective to flank the parkade with townhouses the site grades have resulted in a full three storey townhouse elevation. Any artificially built up site grade to this area would not add any extra benefit.

- An exit stair adjacent to the side yard in C. projects into the 7m set back to the 4.5m set back line. This projection is 2.6m wide, or about 11% of the overall building width (above the 3rd floor).
- There are a number of .6m deep bays on the town houses that project into the 4.5m and 7m setbacks. There are a number that exceed the defined allowed limits as outlined in the exclusion definitions.
- Building C has townhome decks that cantilever 1m into the 4.5m side yard.

Changes from original DP submission include the following:

1. Revised top floor of buildings B & C. 6 units were revised to 2 large "family style" units. This got our bed count down and parking requirements reduced. Plans, stats, elevations and renderings were all updated to suit.
2. 1 additional parking space was added to the surface parking and storage room 2 below building A at L0 was revised to allow for additional parking. 100% of the parking requirements is met with the reduced bed count and additional parking provided.

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GREEN SQUARE RESIDENTIAL DEVELOPMENT

3626 MISSION SPRINGS DR, KELOWNA, BC
LOT 6 & 7, PLAN 515, BLOCK 2

ISSUED FOR REVISED DEVELOPMENT PERMIT - 2017-10-16

ARCHITECTURAL DRAWING LIST

NO.	COVER SHEET & DRAWING LIST	DATE	REVISION NUMBER
A0.0	ZONING & CODE INFORMATION		
A1.1	SITE PLAN LEVEL 0		
A2.0	SITE PLAN LEVEL 1		
A2.1	SITE PLAN LEVEL 2		
A2.2	SITE PLAN LEVEL 3		
A2.3	SITE PLAN LEVEL 4		
A2.4	SITE PLAN LEVEL 5		
A2.5	SITE PLAN LEVEL 6		
A2.6	SITE PLAN LEVEL 7		
A2.7	SITE PLAN LEVEL 8		
A2.8	BUILDING A LEVEL 0 FLOOR PLAN		
A3.0	BUILDING A LEVEL 1 FLOOR PLAN		
A3.1	BUILDING A LEVEL 2 FLOOR PLAN		
A3.2	BUILDING A LEVEL 3 FLOOR PLAN		
A3.3	BUILDING A LEVEL 4-5 & PH FLOOR PLAN		
A3.4	BUILDING A AMENITY & ROOF PLAN		
A3.5	BUILDING D LEVEL 0 FLOOR PLAN		
A3.6	BUILDING D LEVEL 1 & 2 FLOOR PLAN		
A3.7	BUILDING D LEVEL 3-5 FLOOR PLAN		
A3.8	BUILDING D ROOF PLAN		
A3.9	BUILDING B & C LEVEL 1 & 2 FLOOR PLAN		
A3.1.BC	BUILDING B & C LEVEL 3-5 FLOOR PLAN		
A3.2.BC	BUILDING B & C LEVEL 6 & 7 FLOOR PLAN		
A3.3.BC	BUILDING B & C ROOF PLAN		
A3.4.BC	SITE SECTIONS		
A4.1	BUILDING A ELEVATIONS		
A5.1	BUILDING B ELEVATIONS		
A5.2	BUILDING C ELEVATIONS		
A5.3	BUILDING D ELEVATIONS		
A5.4	PERSPECTIVE IMAGES		
A6.1	PERSPECTIVE IMAGES		
A6.2	PERSPECTIVE IMAGES		
A6.3	PERSPECTIVE IMAGES		

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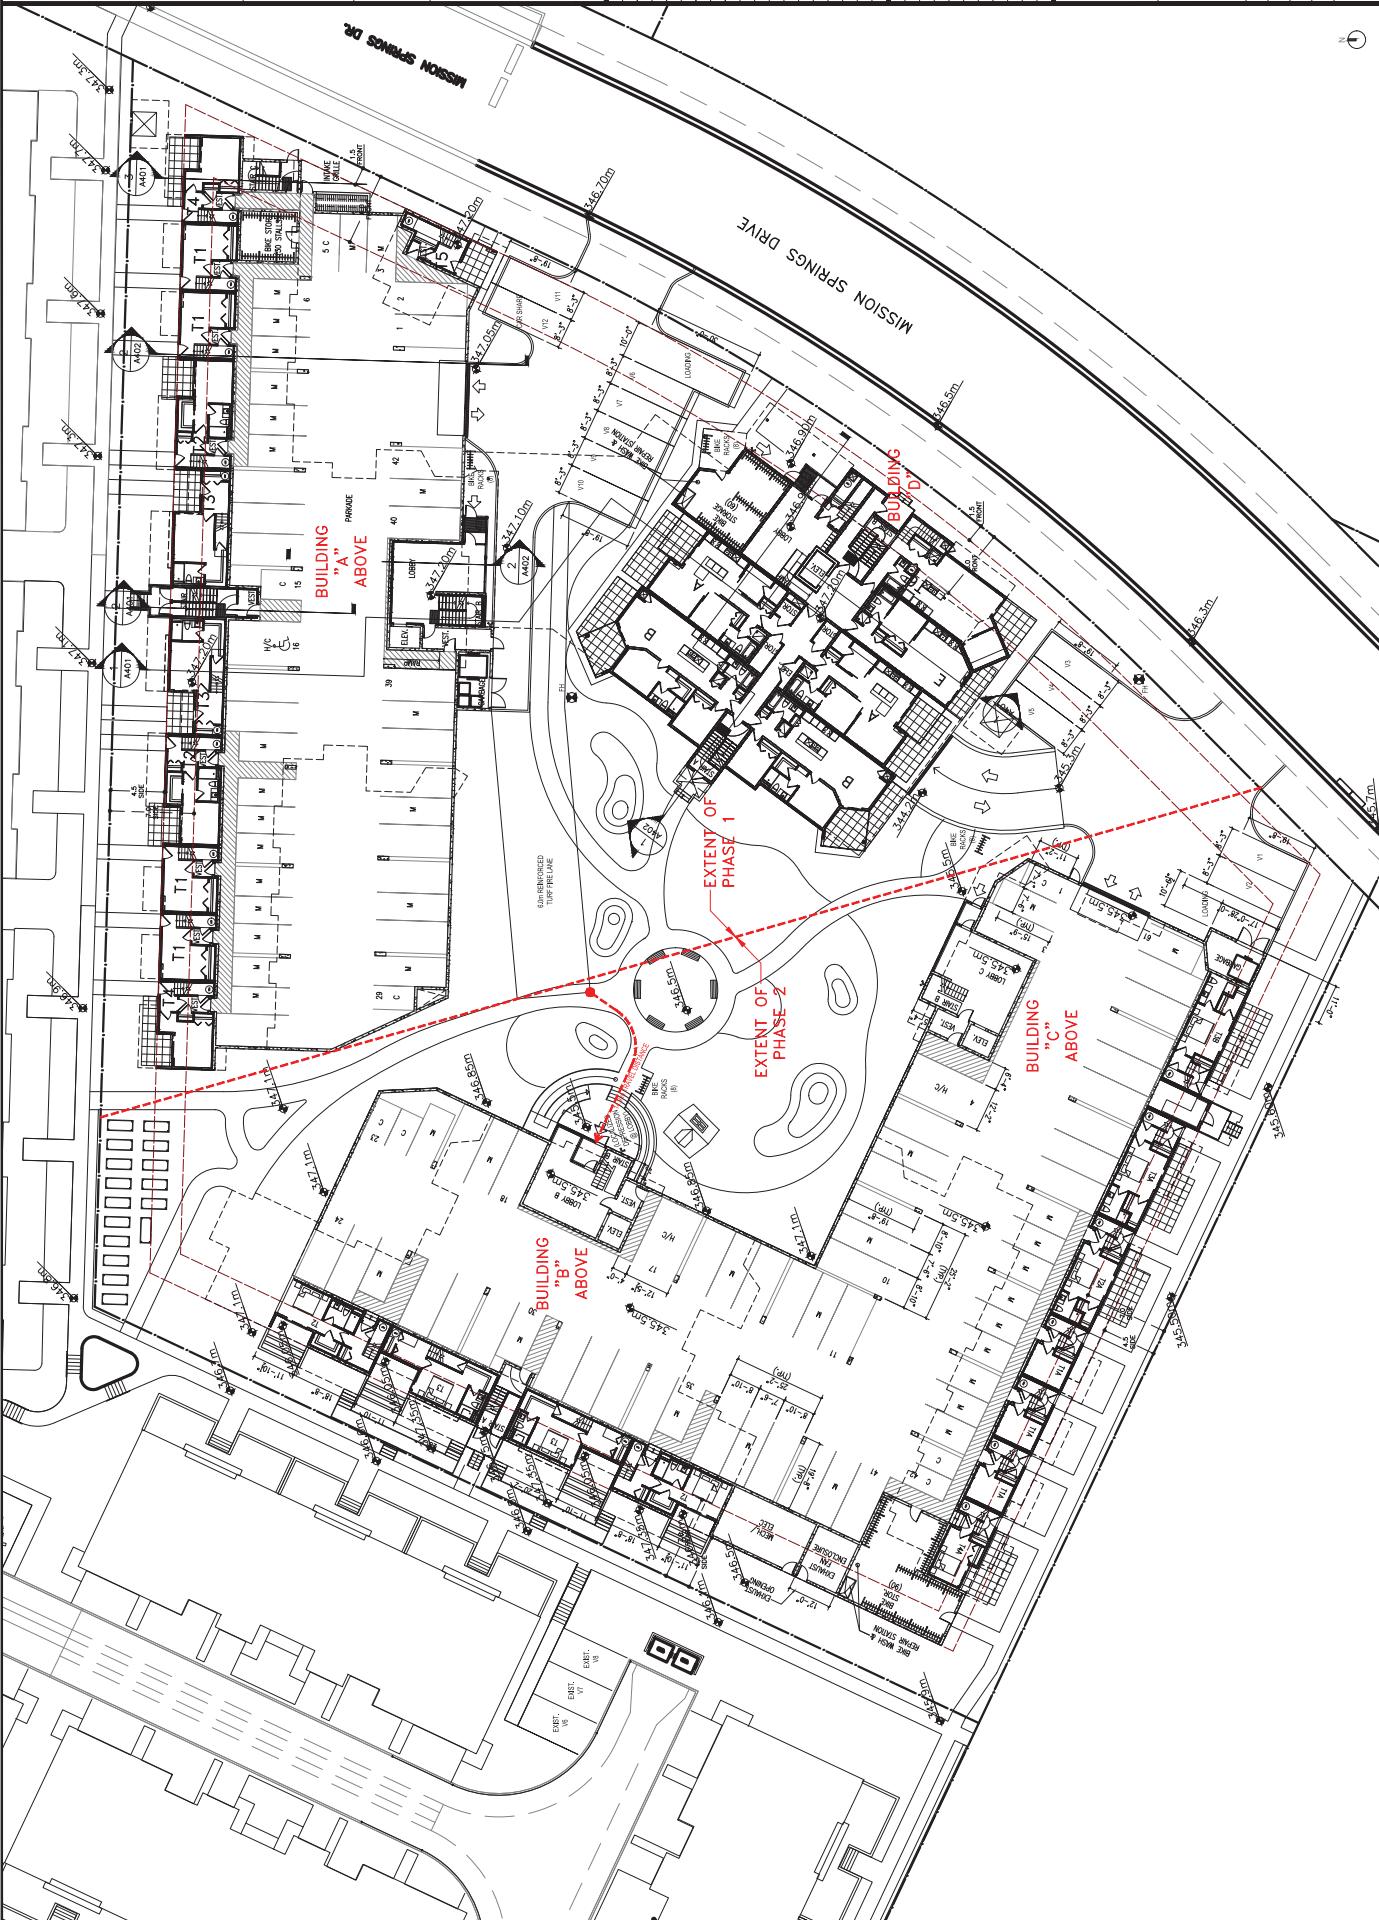
NO.	DATE	REVISION NUMBER
1	17/10/16	Revised
2	17/10/16	Revised
3	17/10/16	Revised
4	17/10/16	Revised

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4	17/10/16	Revised





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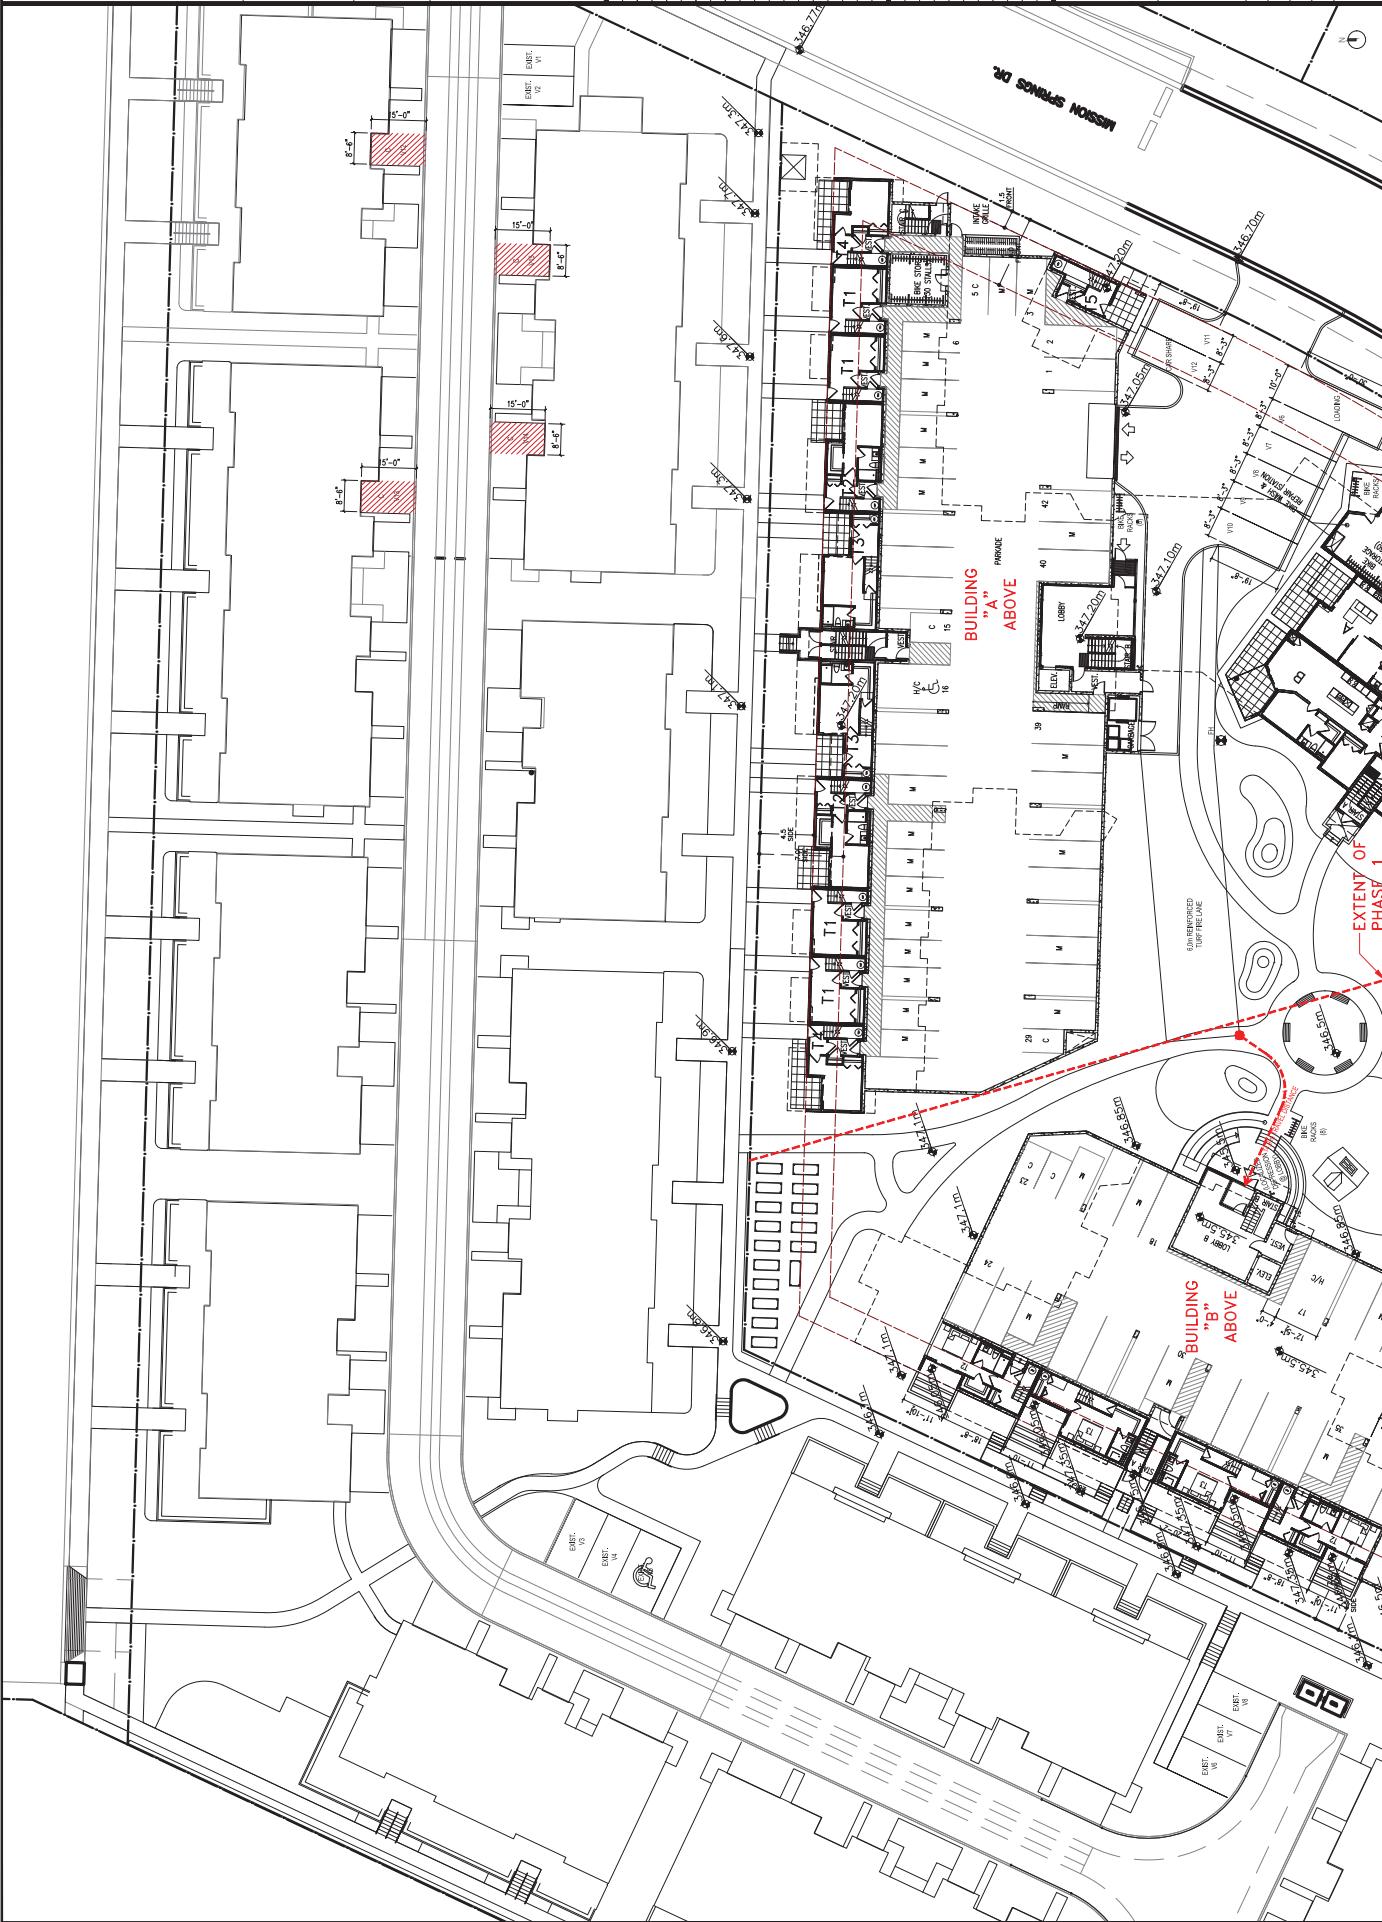


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Site



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A2 2

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This architectural site plan illustrates the footprint and setbacks of four buildings (A, B, C, D) relative to a street grid. The plan includes various rooms, hallways, and structural details. Red dashed lines indicate the 'EXTENT OF PHASE 1' and 'EXTENT OF PHASE 2' of the construction project. Building A is labeled 'BUILDING "A"' and shows internal room numbers like 101, 102, 103, etc. Building B is labeled 'BUILDING "B"'. Building C is labeled 'BUILDING "C"'. Building D is labeled 'BUILDING "D"'. A note at the top right specifies 'BUILDING GA 12,280 SQ.FT.'. A legend in the bottom left corner defines symbols for 'SYNTHETIC TURF ROOF (SEE LANDSCAPE)' and 'SOIL STORE'. A north arrow is located in the lower center area.



104

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Those damages are measured as the value of the direct property of the victim, and compensation is requested from the contractor which the affected party will be in person.

The damage is not to be scaled. The general contractor can only demand damages for any loss or damage due to non-observance of work agreements or contracts, and he is required to verify this by the affected party.

BUILDING GEA 10,780 SQ.FT.

This architectural floor plan illustrates the layout of Building A, spanning multiple levels. The plan includes various rooms such as BATH, KITCHEN, PANTRY, BREAKFAST ROOM, LIVING ROOM, DINING ROOM, and several SLEEPING PORCHES. Stairs are indicated throughout the plan, leading between different levels. A legend in the bottom right corner identifies symbols for BATH, CLO., KITCHEN, PANTRY, PORCH, SLEEPING PORCH, and STAIR. A red dashed line outlines the building's footprint, and a red arrow points to the main entrance. A north arrow is located in the top left corner. The total building area is noted as 10,980 SQ.FT.

The diagram illustrates the relationship between the extent of phase 1 (x_1) and the extent of phase 2 (x_2). A horizontal dashed line represents the total extent of the system, labeled "TOTAL". A vertical dashed line extends from the origin to the point where the total extent line meets the curve. The area under the curve up to this point is shaded blue and labeled "EXTENT OF PHASE 1". The remaining area under the curve is shaded red and labeled "EXTENT OF PHASE 2".

The diagram shows a detailed floor plan of a building, specifically 'BUILDING "B"', as indicated by red text at the top left. The plan includes several rooms labeled with letters A through S. An additional area labeled 'EXT PRT' is shown at the top right, representing an exterior or patio space.

The image shows an architectural floor plan of a building, specifically 'BUILDING C', as indicated by the red text on the left side. The plan includes various rooms, hallways, and stairs. A red dashed line, also labeled 'BUILDING D' in red text at the top left, runs diagonally across the upper portion of the drawing. A small circle containing the number '100' is located near the center of this dashed line. The plan uses black lines for walls and furniture, with room numbers (e.g., 1, 2, 3, 99, 100) and arrows indicating room functions. A scale bar at the bottom right indicates distances from 0 to 100 units.

An architectural floor plan of a building section, likely a multi-story residential or institutional structure. The plan shows various rooms, including what appears to be a central hall, several bedrooms, and a kitchen/dining area. A prominent feature is a large staircase leading between different levels. The plan is drawn with black lines on a white background, with some areas shaded in grey.

Job Number	17-123
Date	2017 08 15
Scale	1/16" = 1'-0"
Revision Number	A
Drawing Number	A2.3

A2.3



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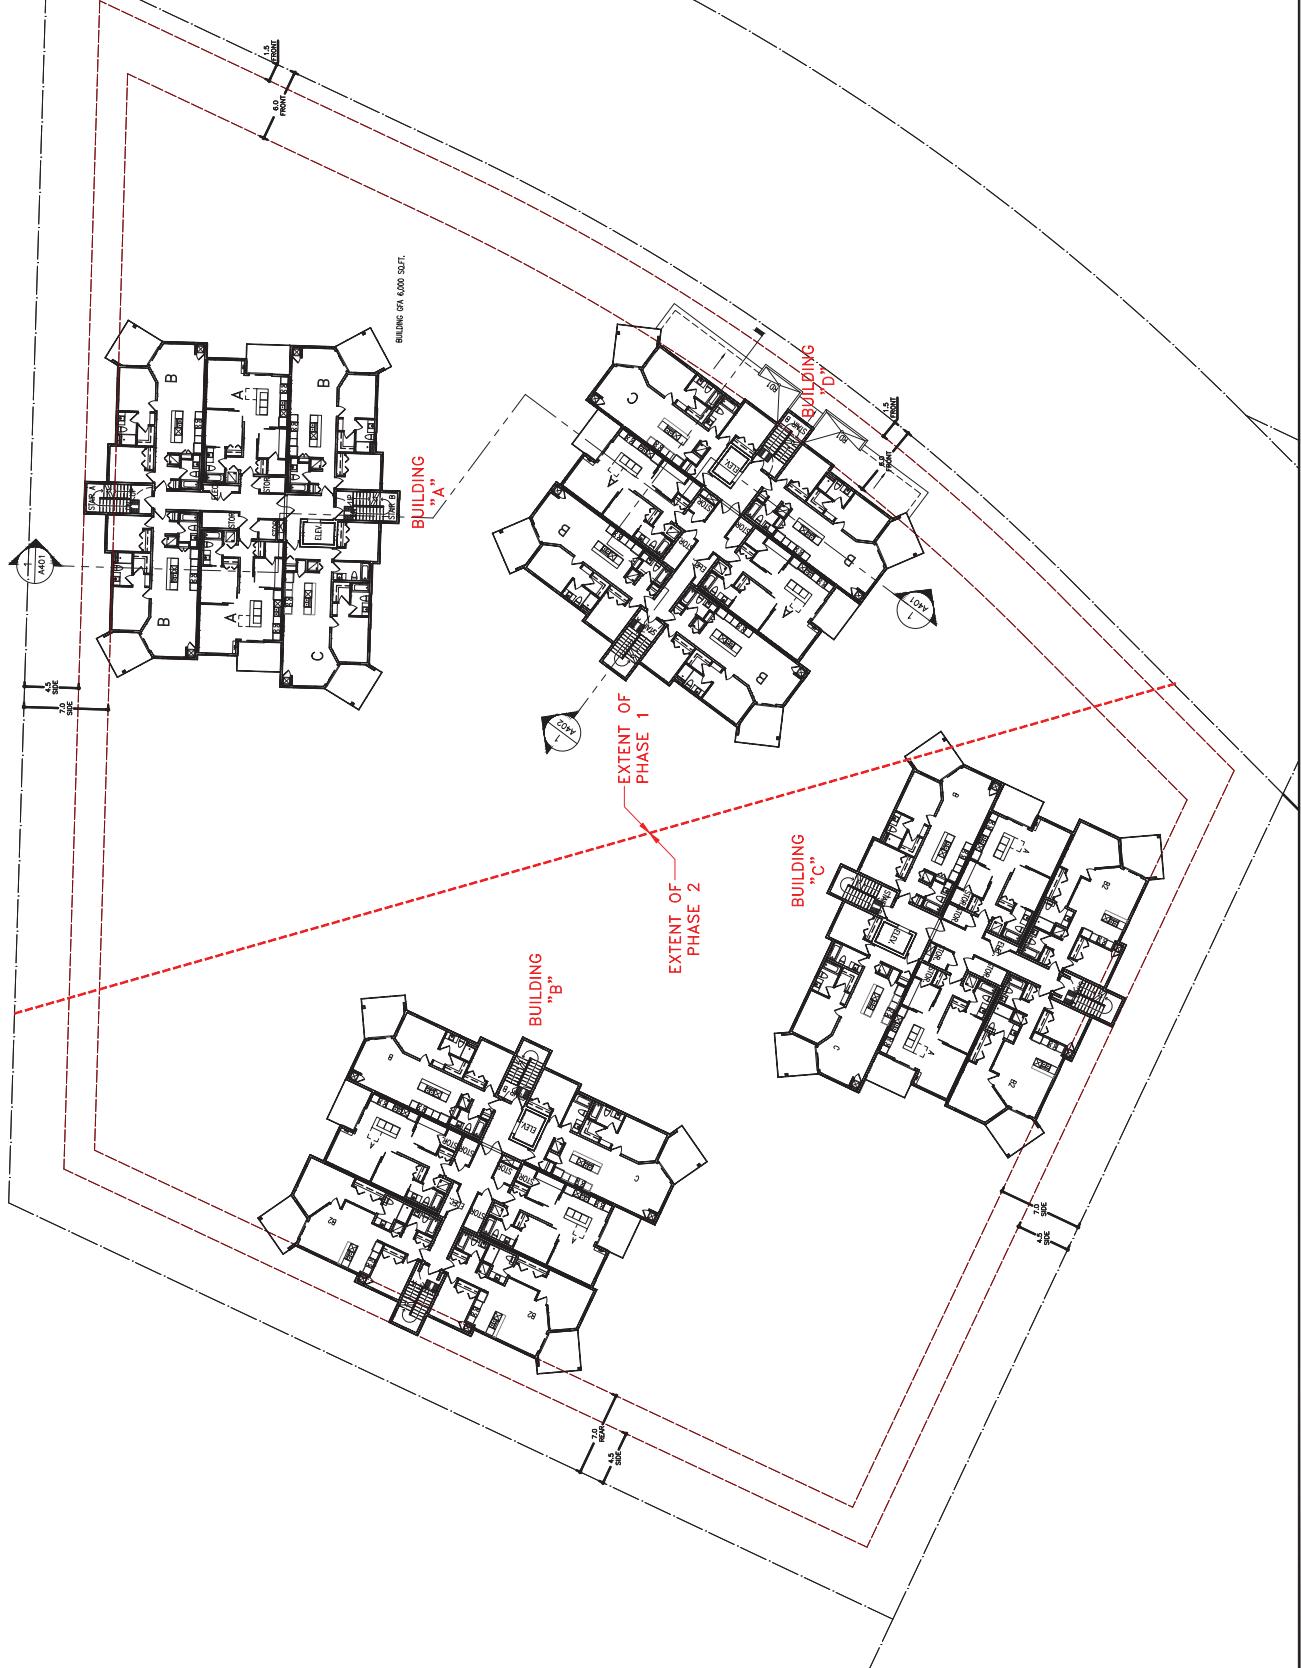
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Checklist



LEVEL 4 & 5

SITE PLAN

Project Name: 17-173

Date: 2017/08/15

Sheet: 1 of 1 - G

Number of Sheets:

#

Drawing Number:

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Drawing Title:

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Scale:

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Architect:

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Designer:

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Reviewer:

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Approver:

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Date:

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Comments:

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Signature:

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Date:



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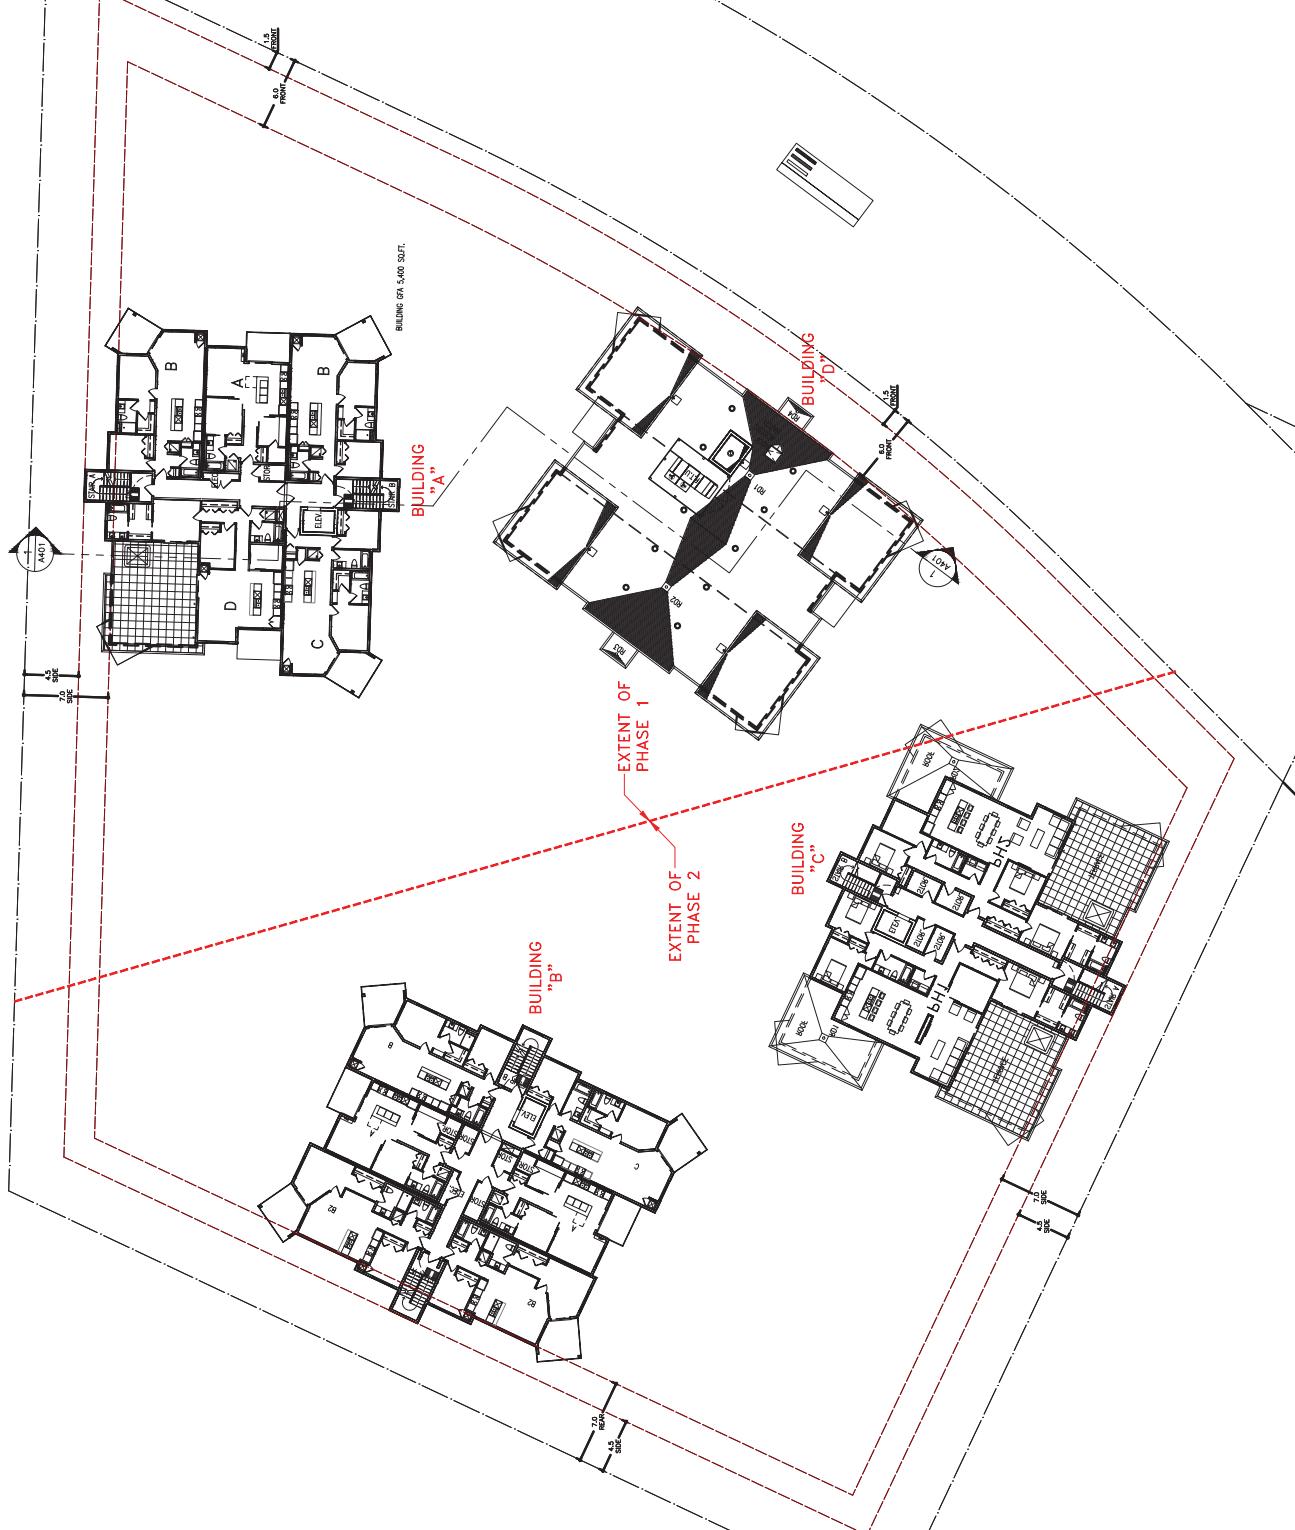


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■ KELowna

17.1.23
2017/08/15
10/16 1-G

Drawing No. 1000
Title Block

A2.6



Project No.: 17.1.23

Date: 2017/08/15

Sheet: 10/16 1-G

#

Drawing No. 1000

Title Block

Project:

Phase 1

Building:

Green Square

Reference:

Phase 1: Buildings A, D

Location:

30 Mission Springs Dr.

Kelowna, BC V1V 4B8

Drawn By:

Check By:

Approved By:

Architect:

Engineer:

Surveyor:

Other:

Date:

10/16/17

Time:

10:00 AM

Comments:

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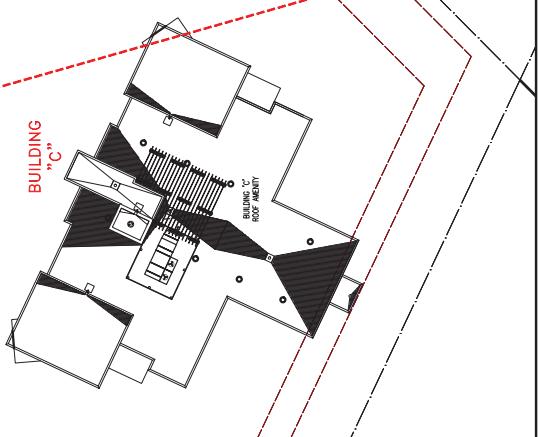
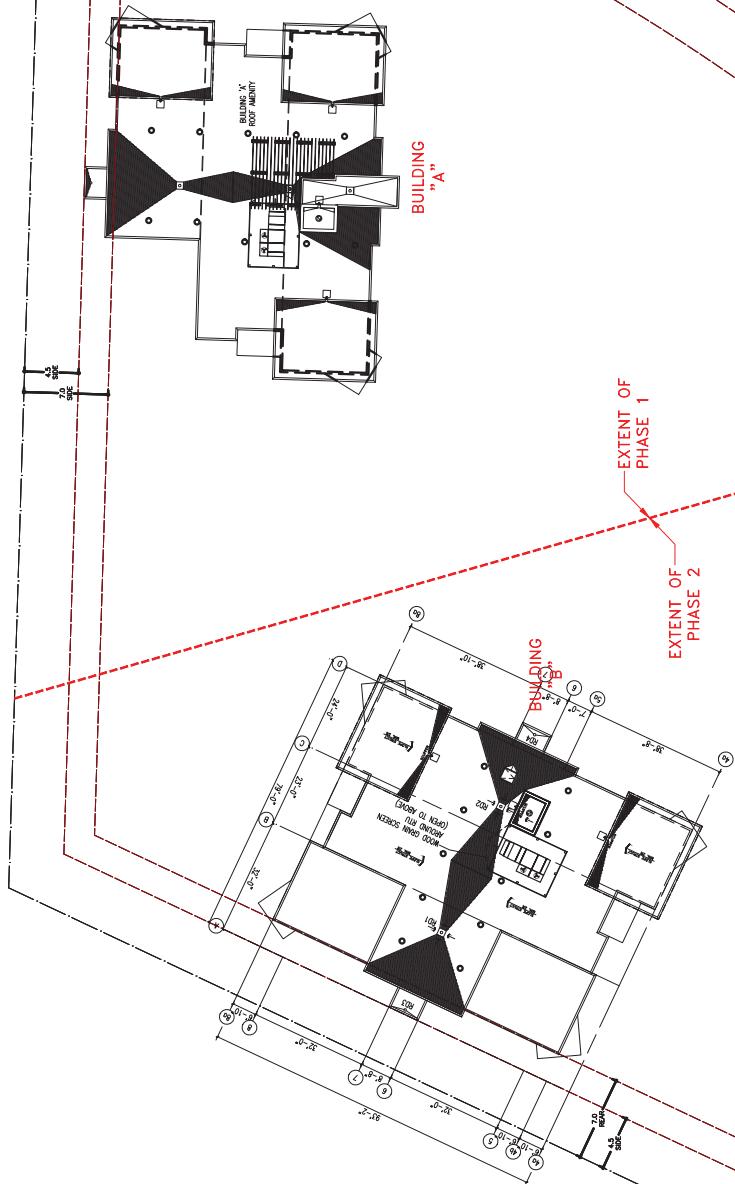
30 Mission Springs Dr.

Kelowna, BC V1V 4B8

Drawn By:

Check By:

Approved By:



EXTENT OF PHASE 2

BUILDING
"C"

BUILDING
"A"

LEVEL 8
SITES PLAN


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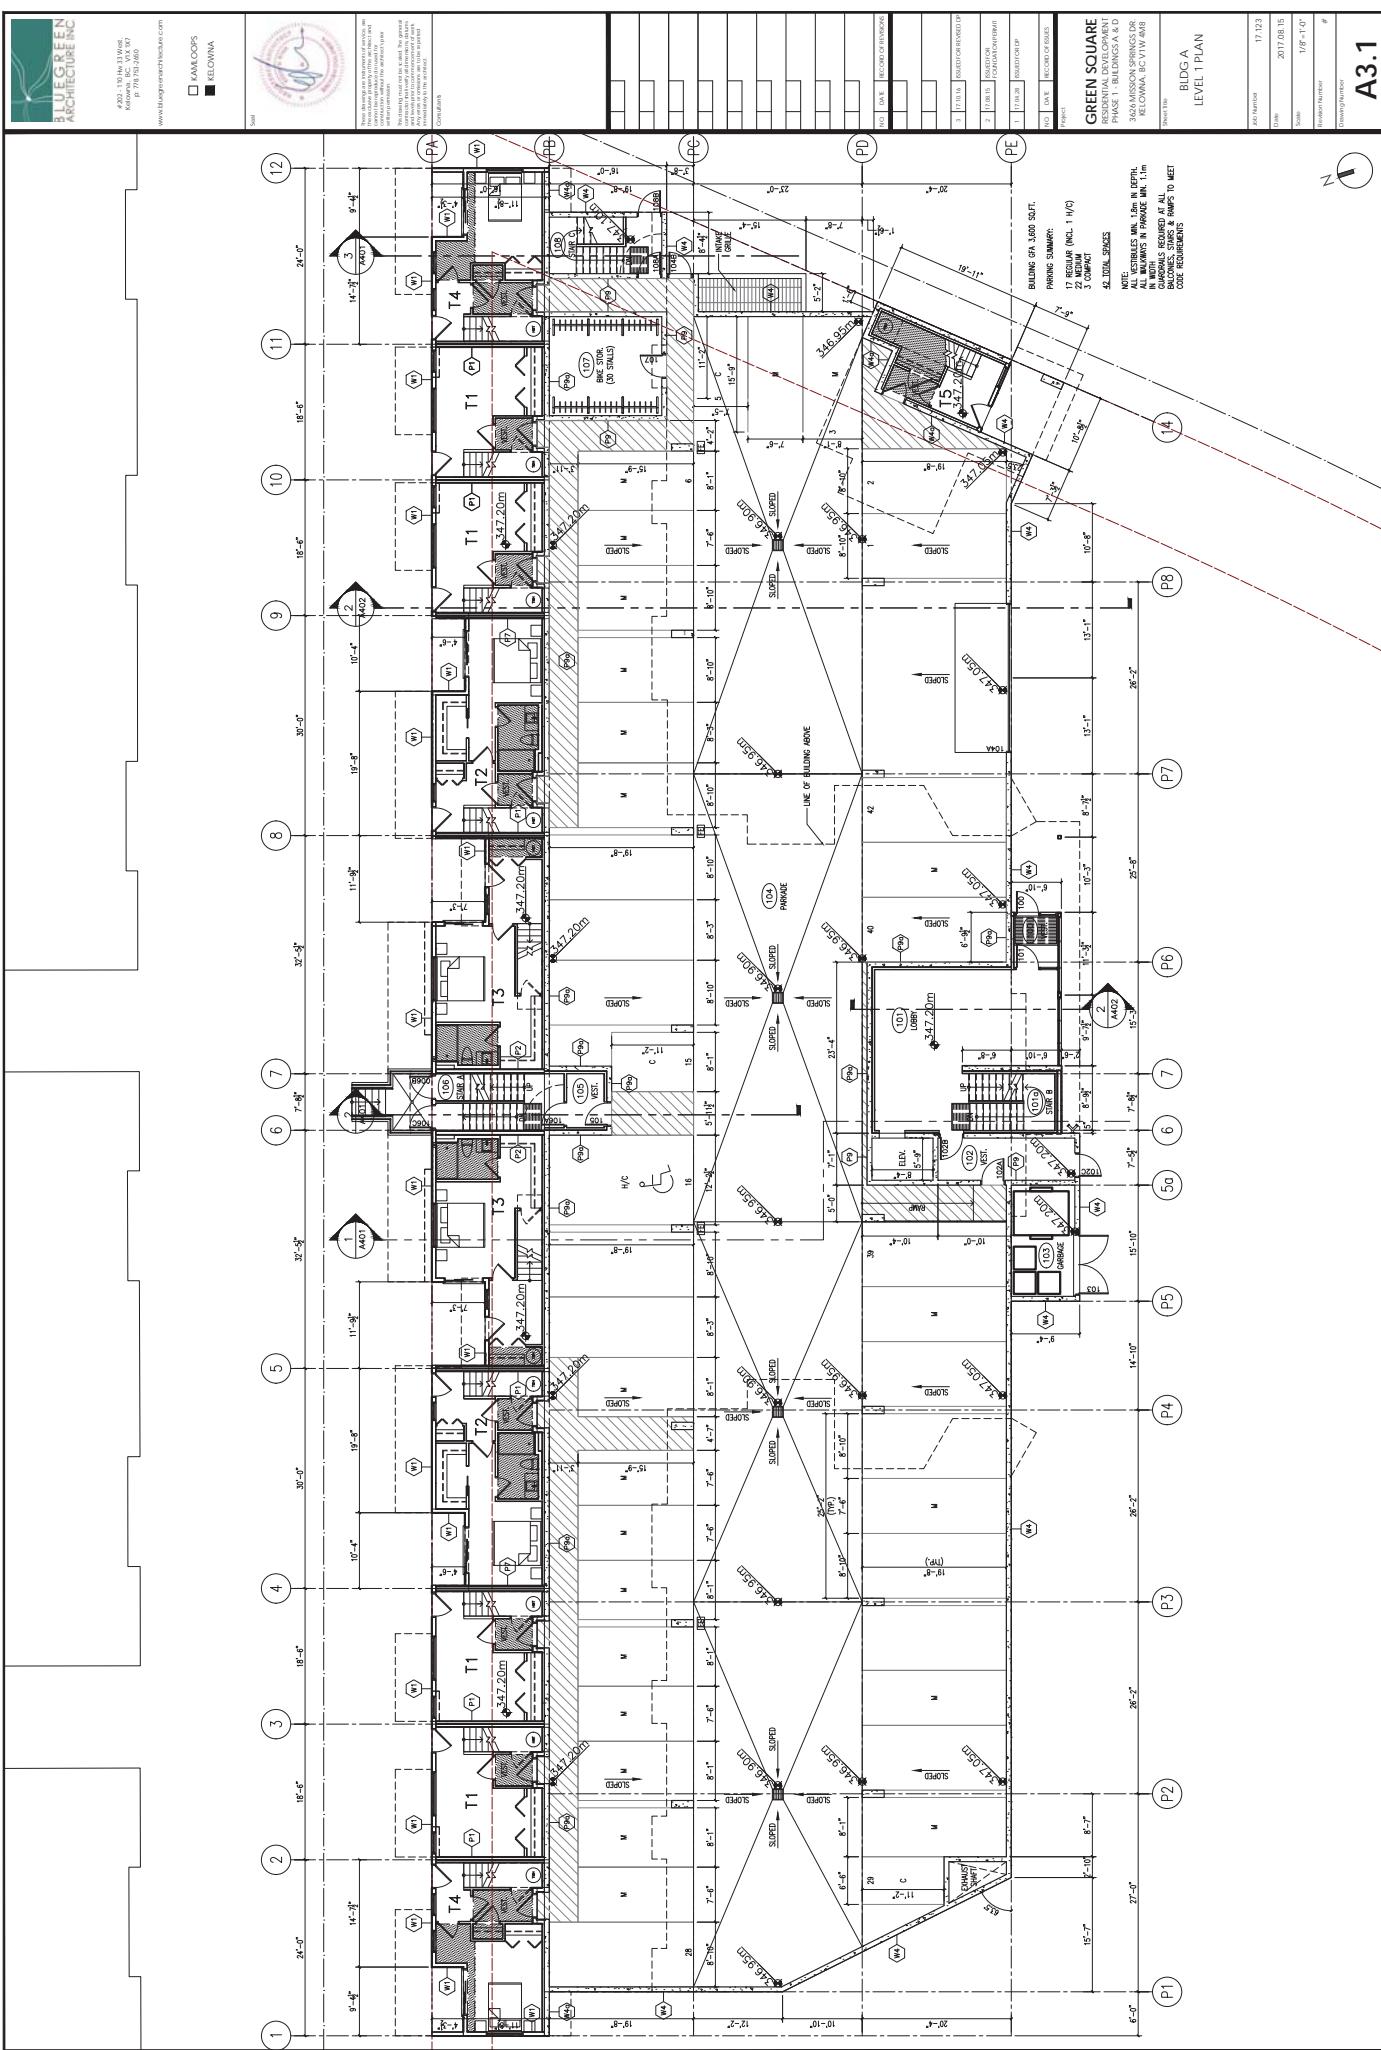




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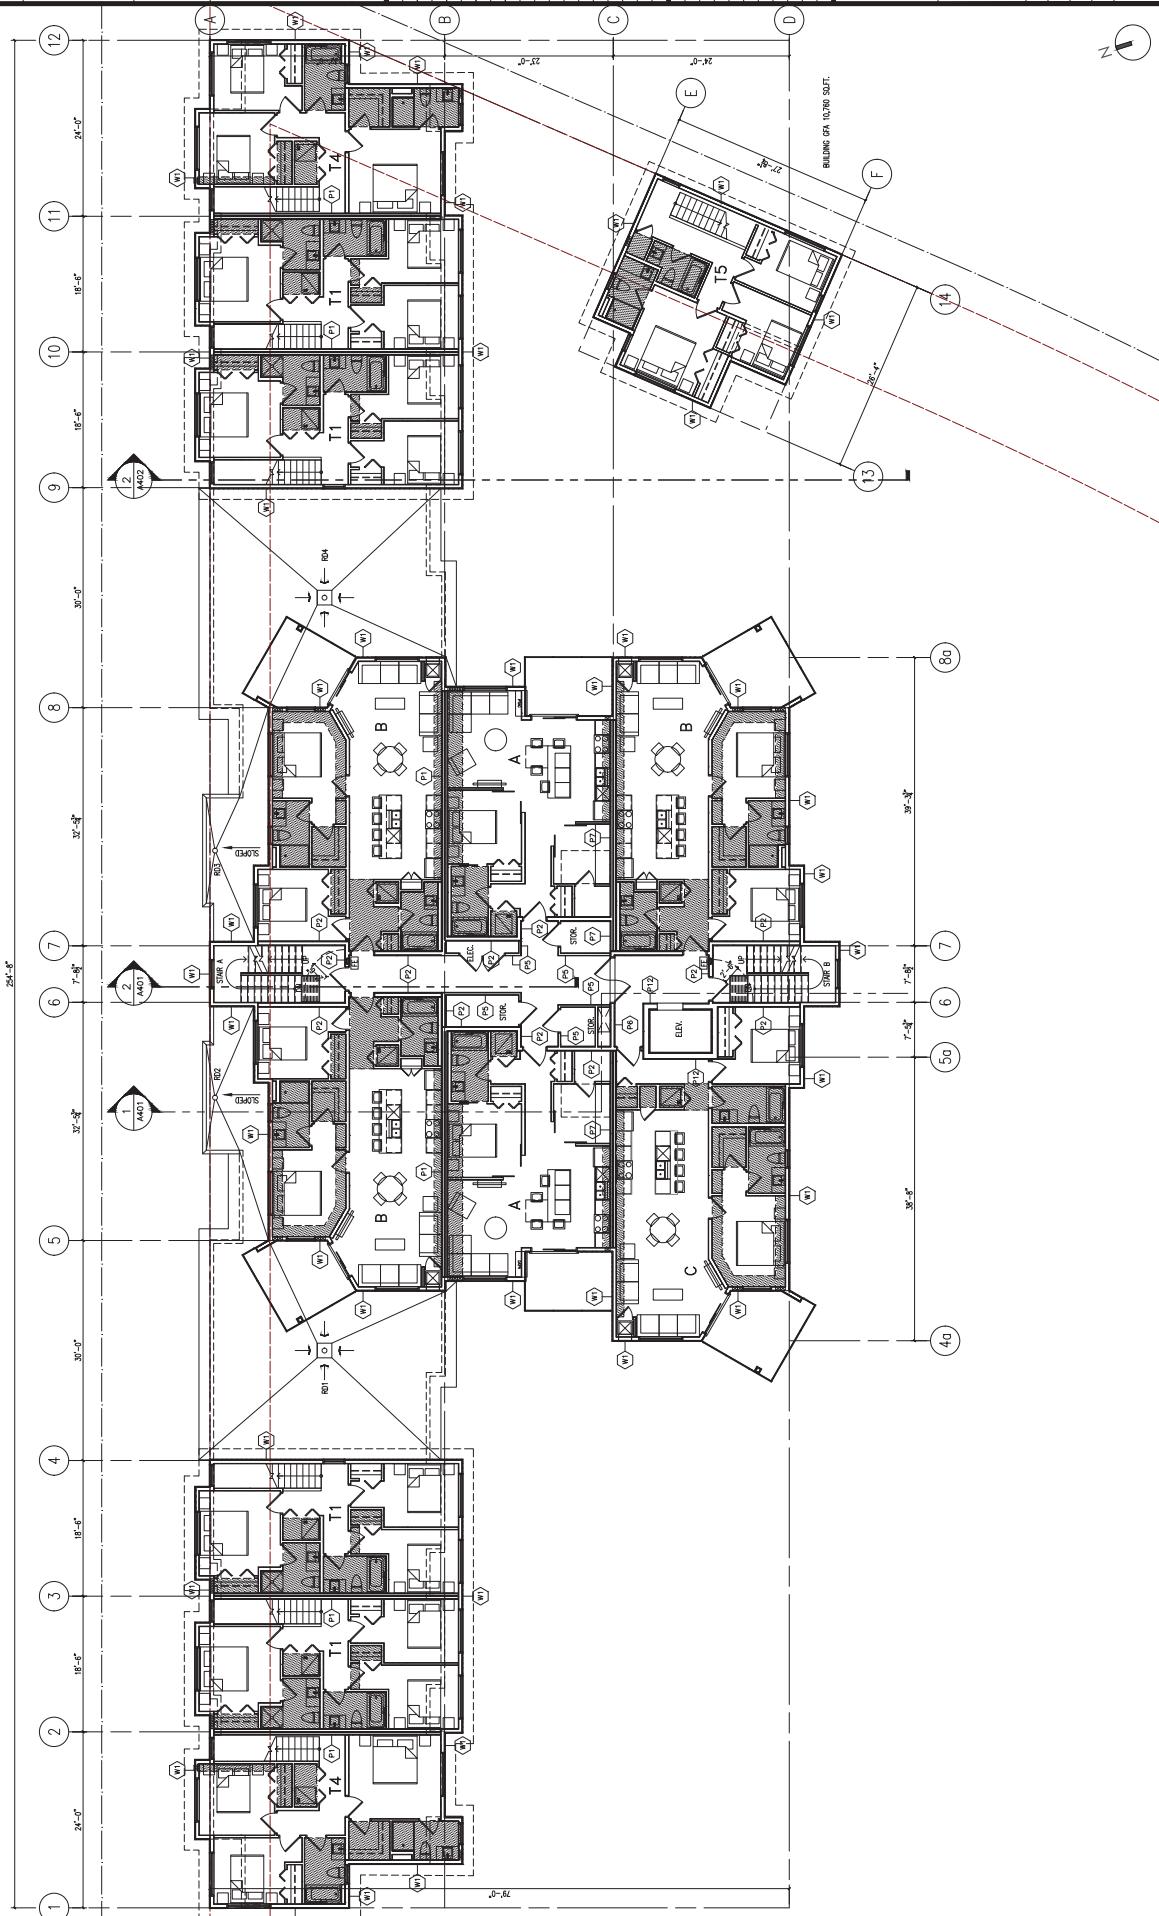
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These developed an awareness of service and its place in property offices. The Head and Governor were particularly anxious for contact with the Head of the Primary School in the town.

The following year did not bring the general concern about quality of education, diversity and equality which had been prior to construction of school.





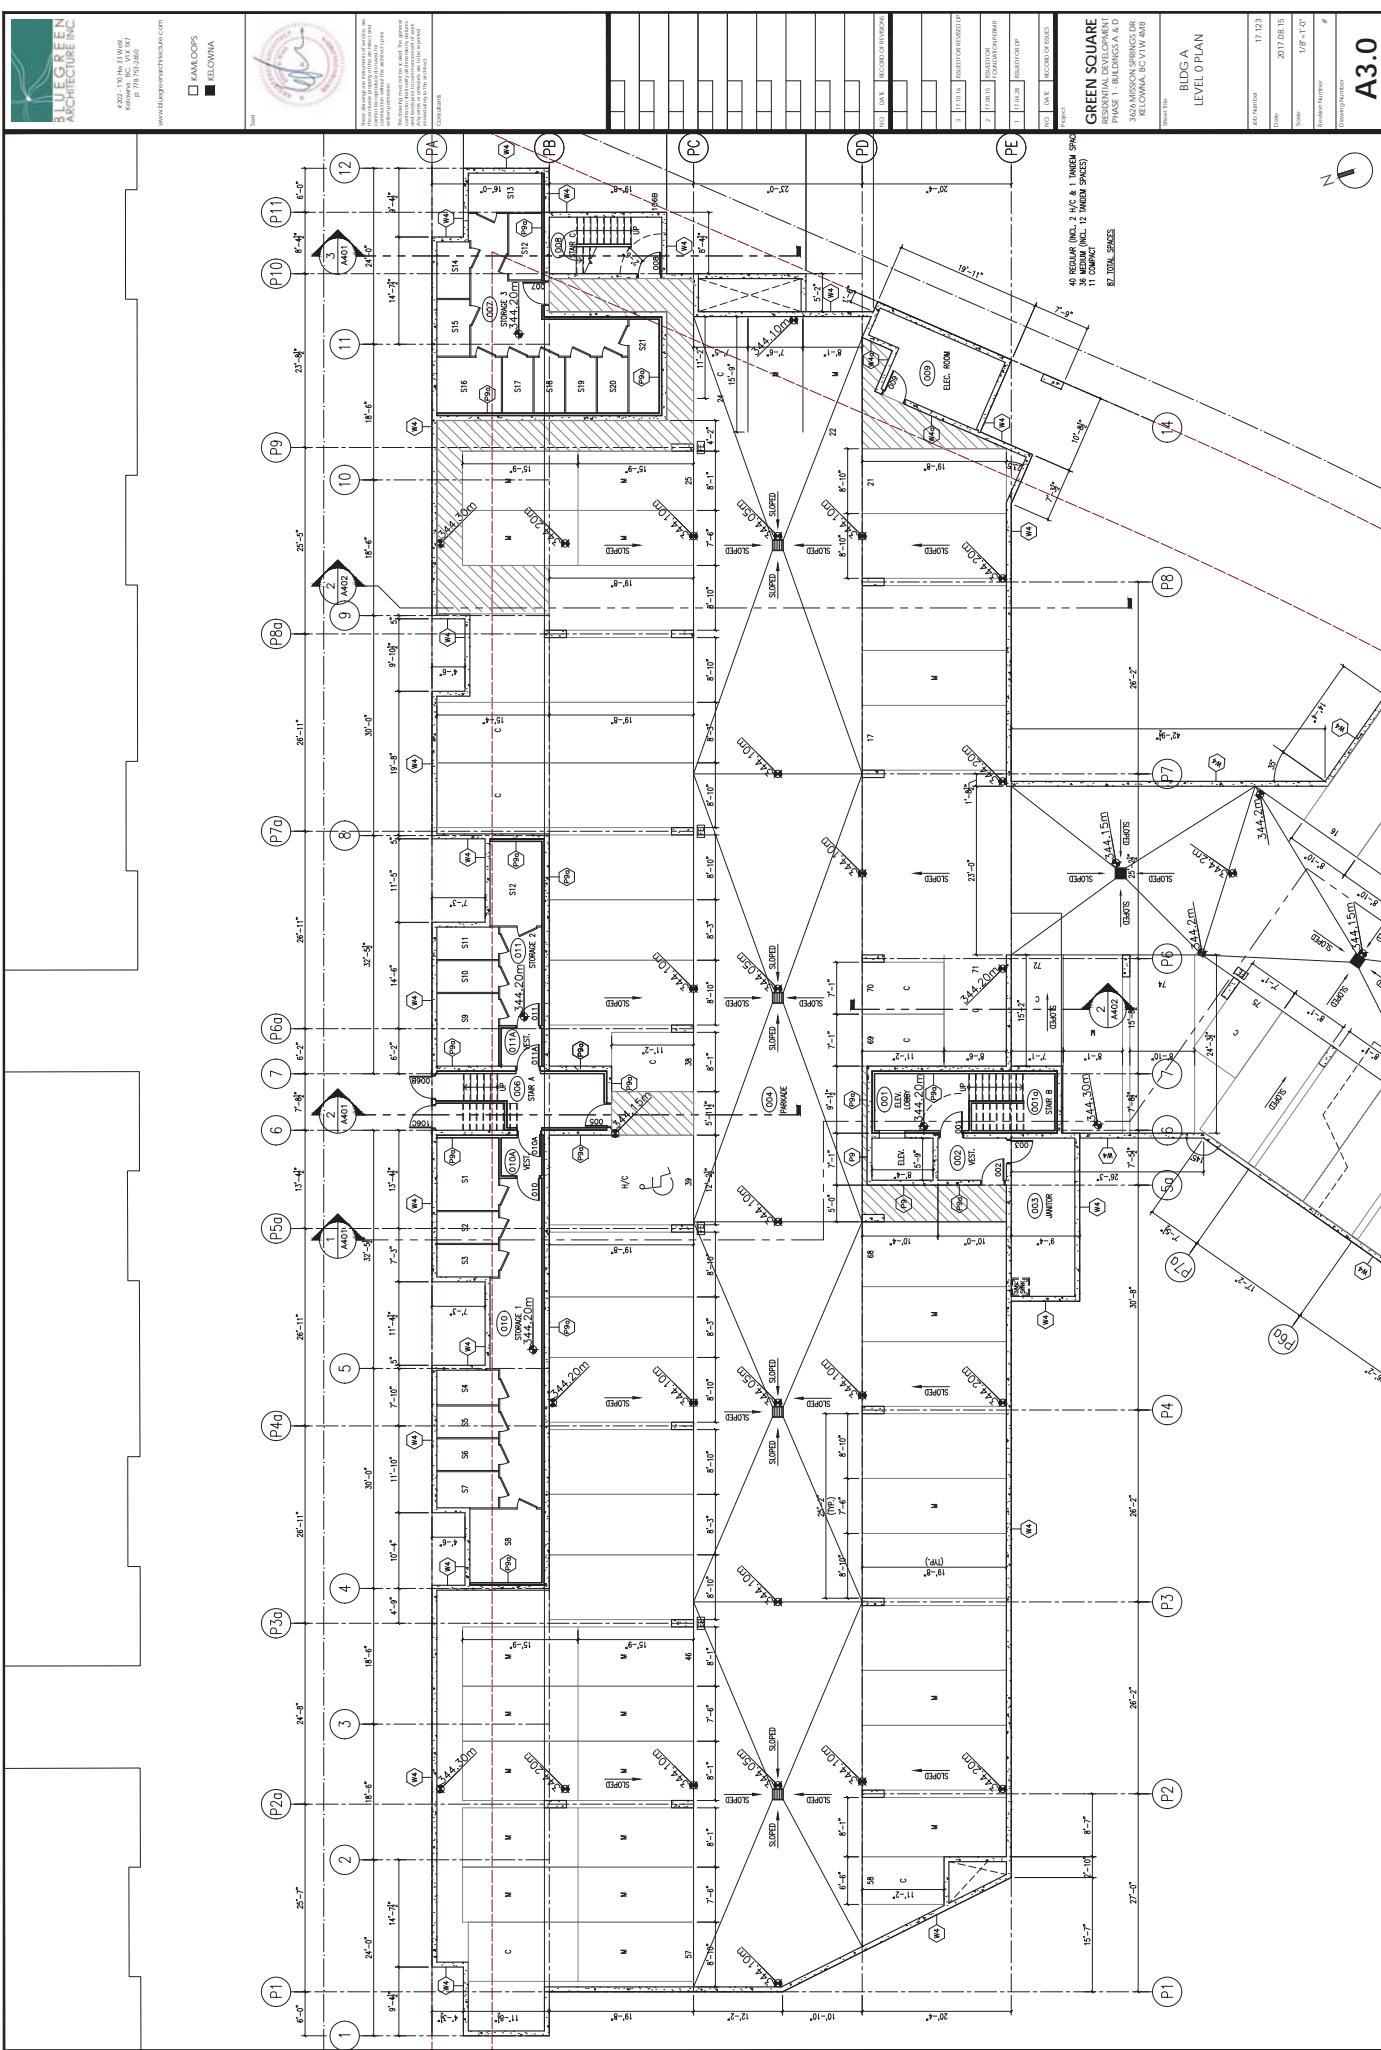

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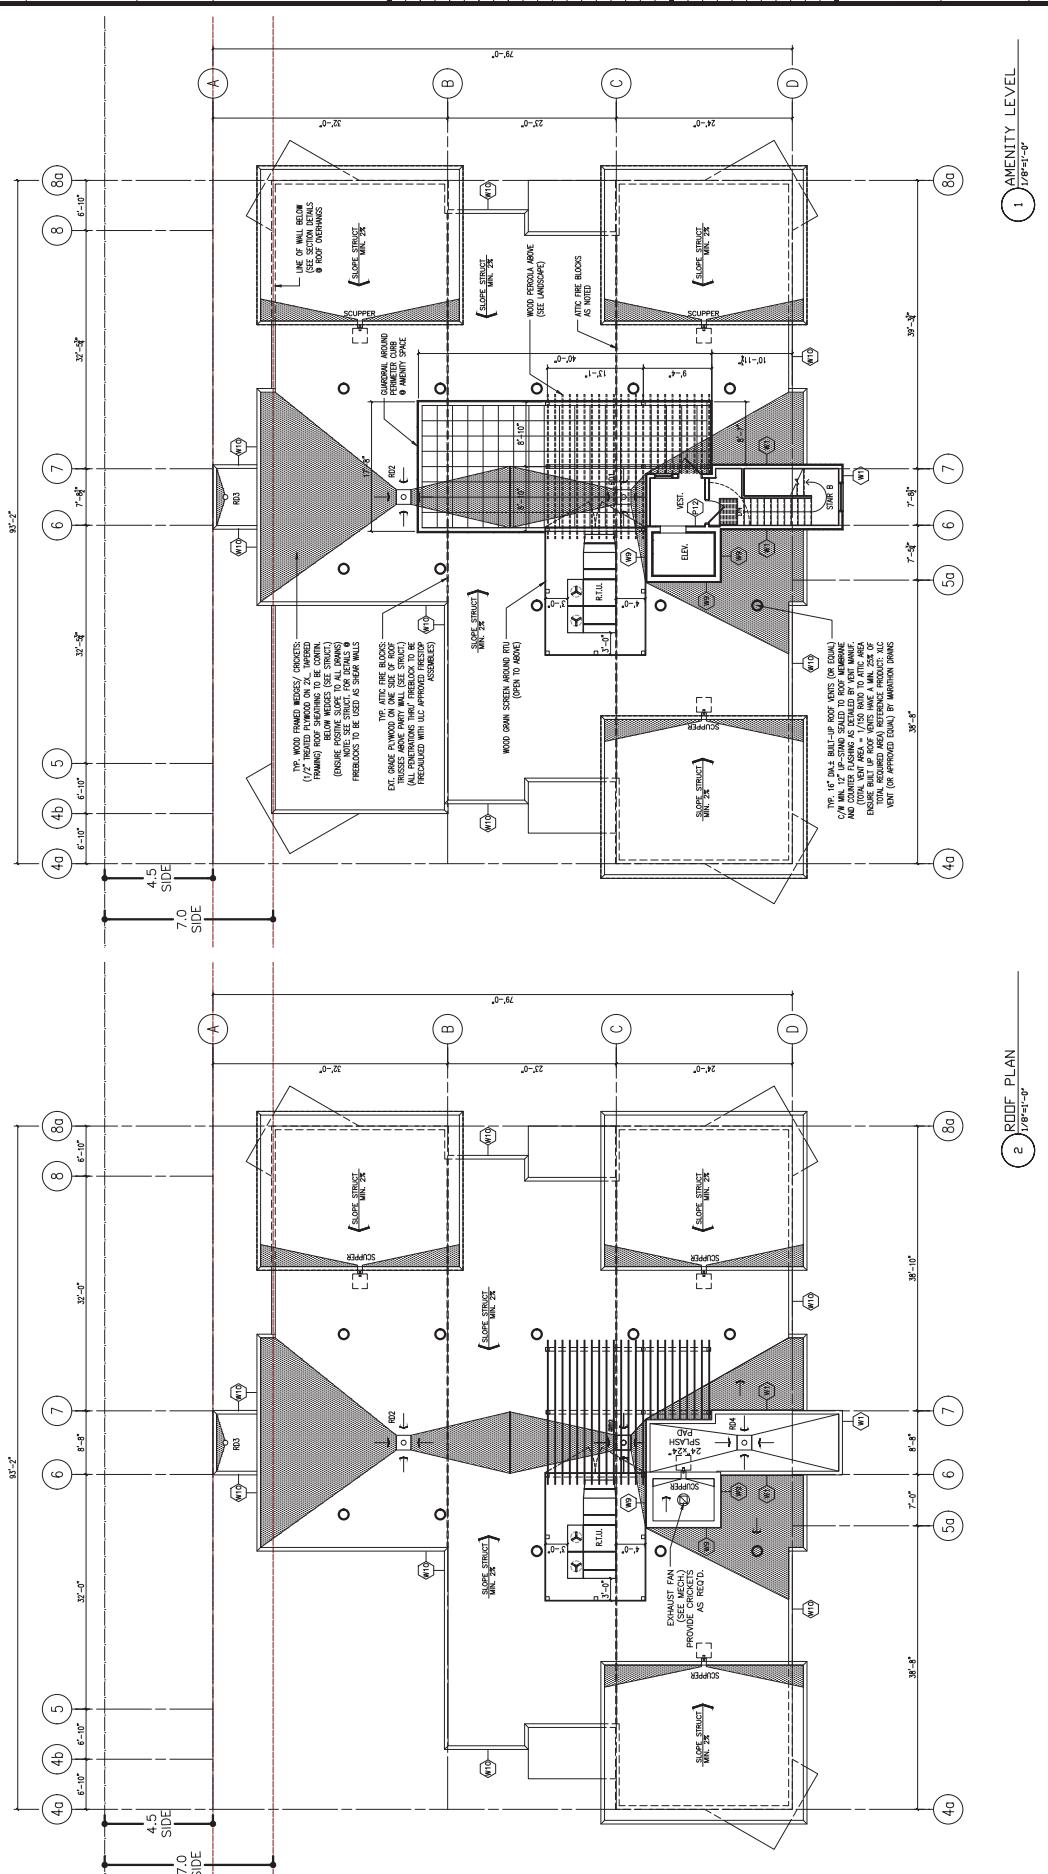
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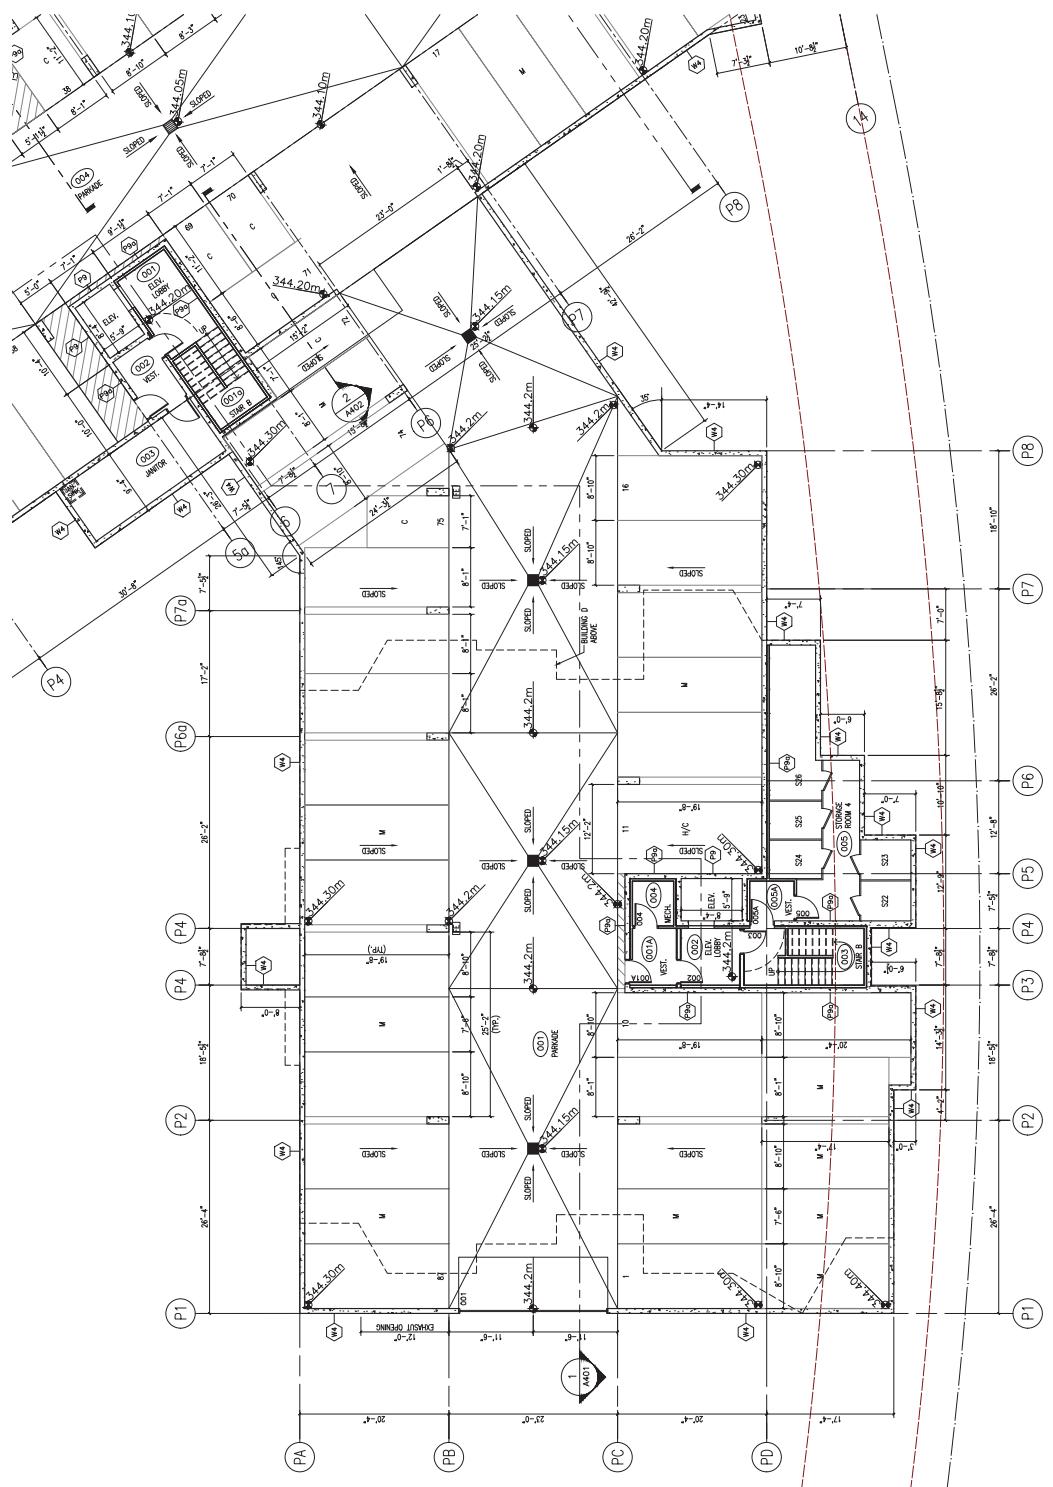


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These changes are reflected in the following sections, and will be clearly evident to those who have had the opportunity to look at the revised version of the document. It is intended that the revised paper will be submitted to the appropriate journal.

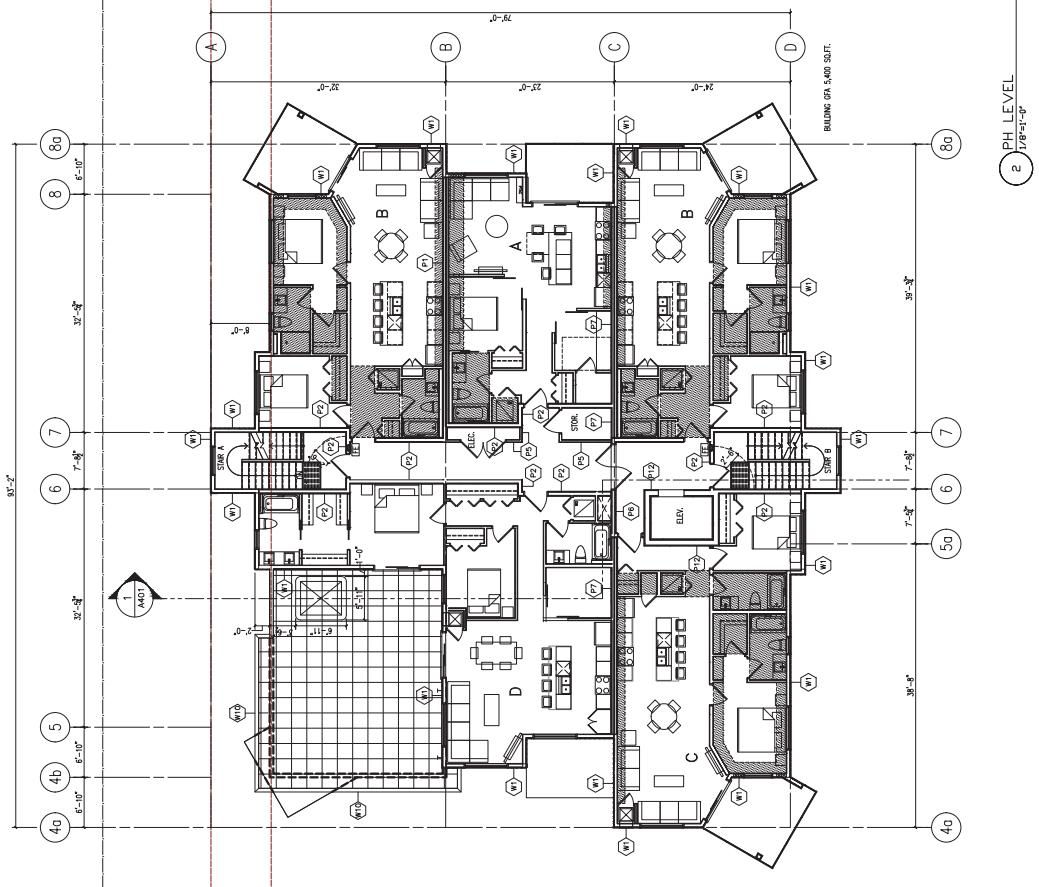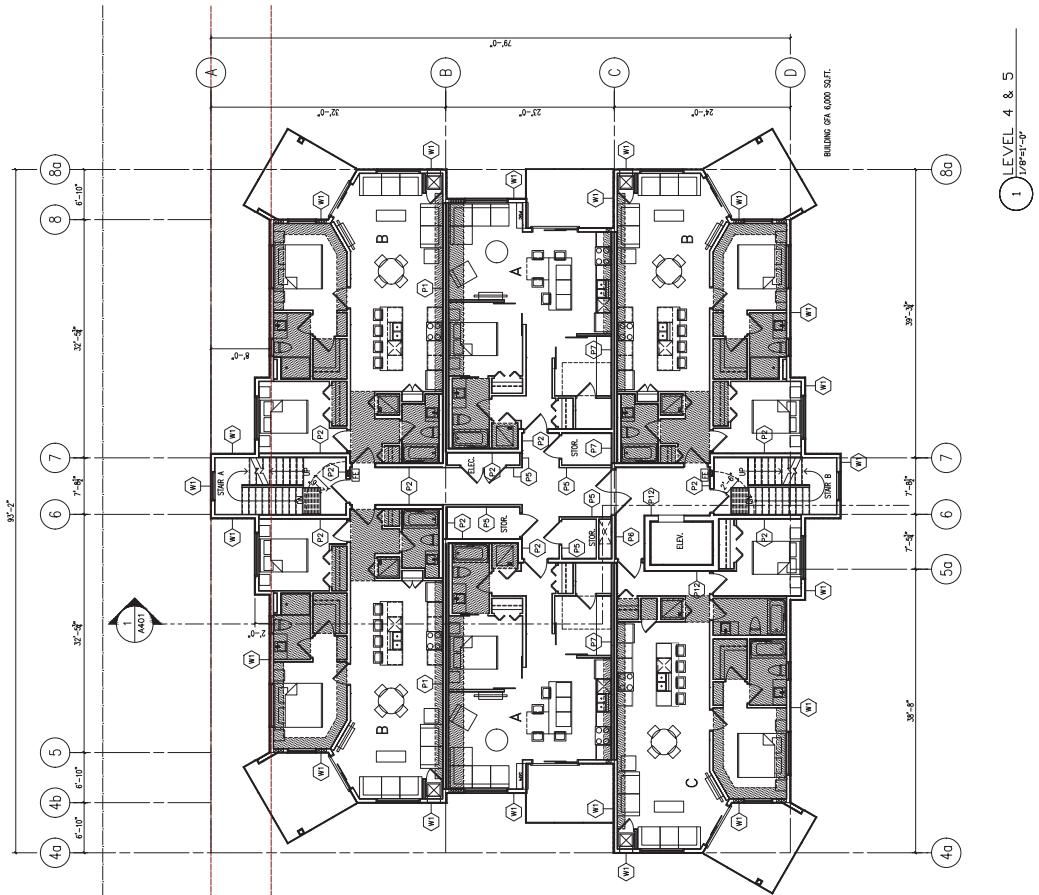

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2017.08.15

ANSWER


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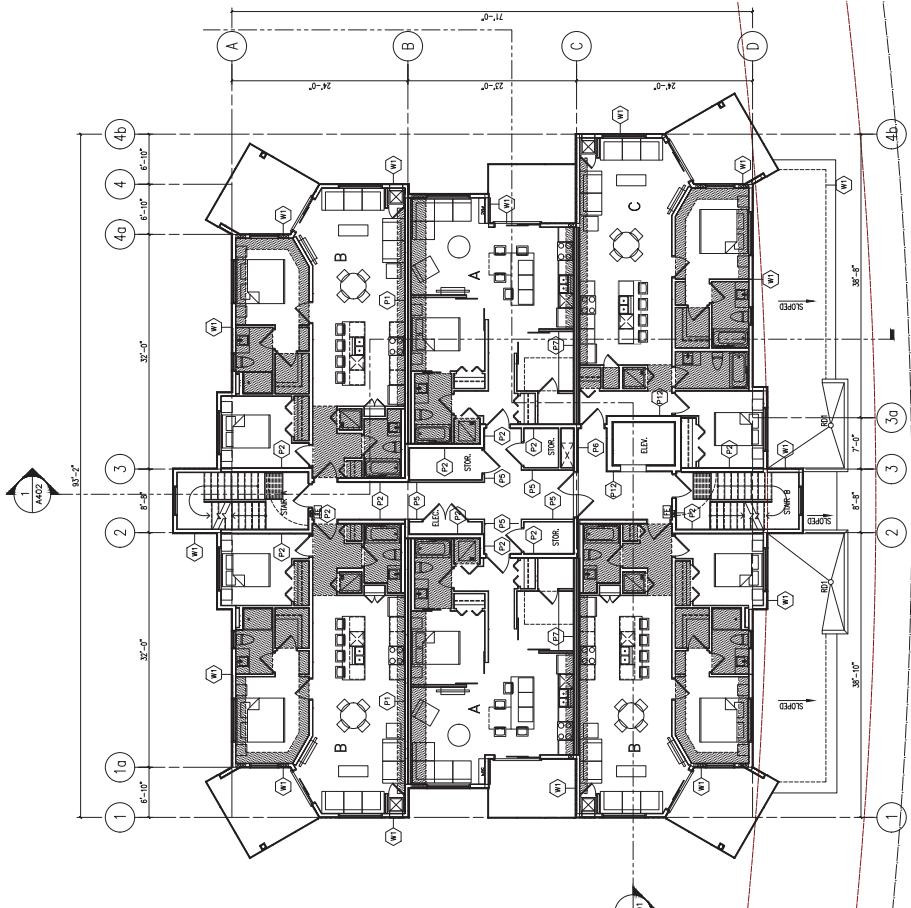


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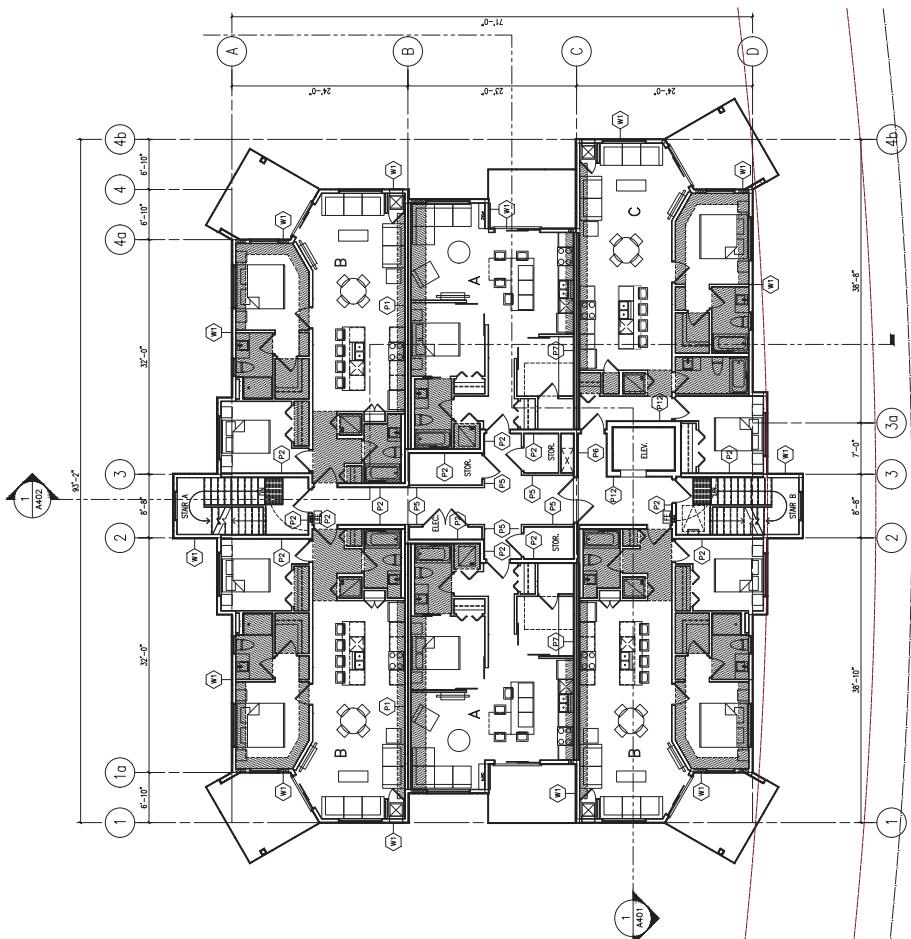
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LEVEL 3 & 4
1/8"=1'-0"




LEVEL 5
2 1/8"=1'-0"

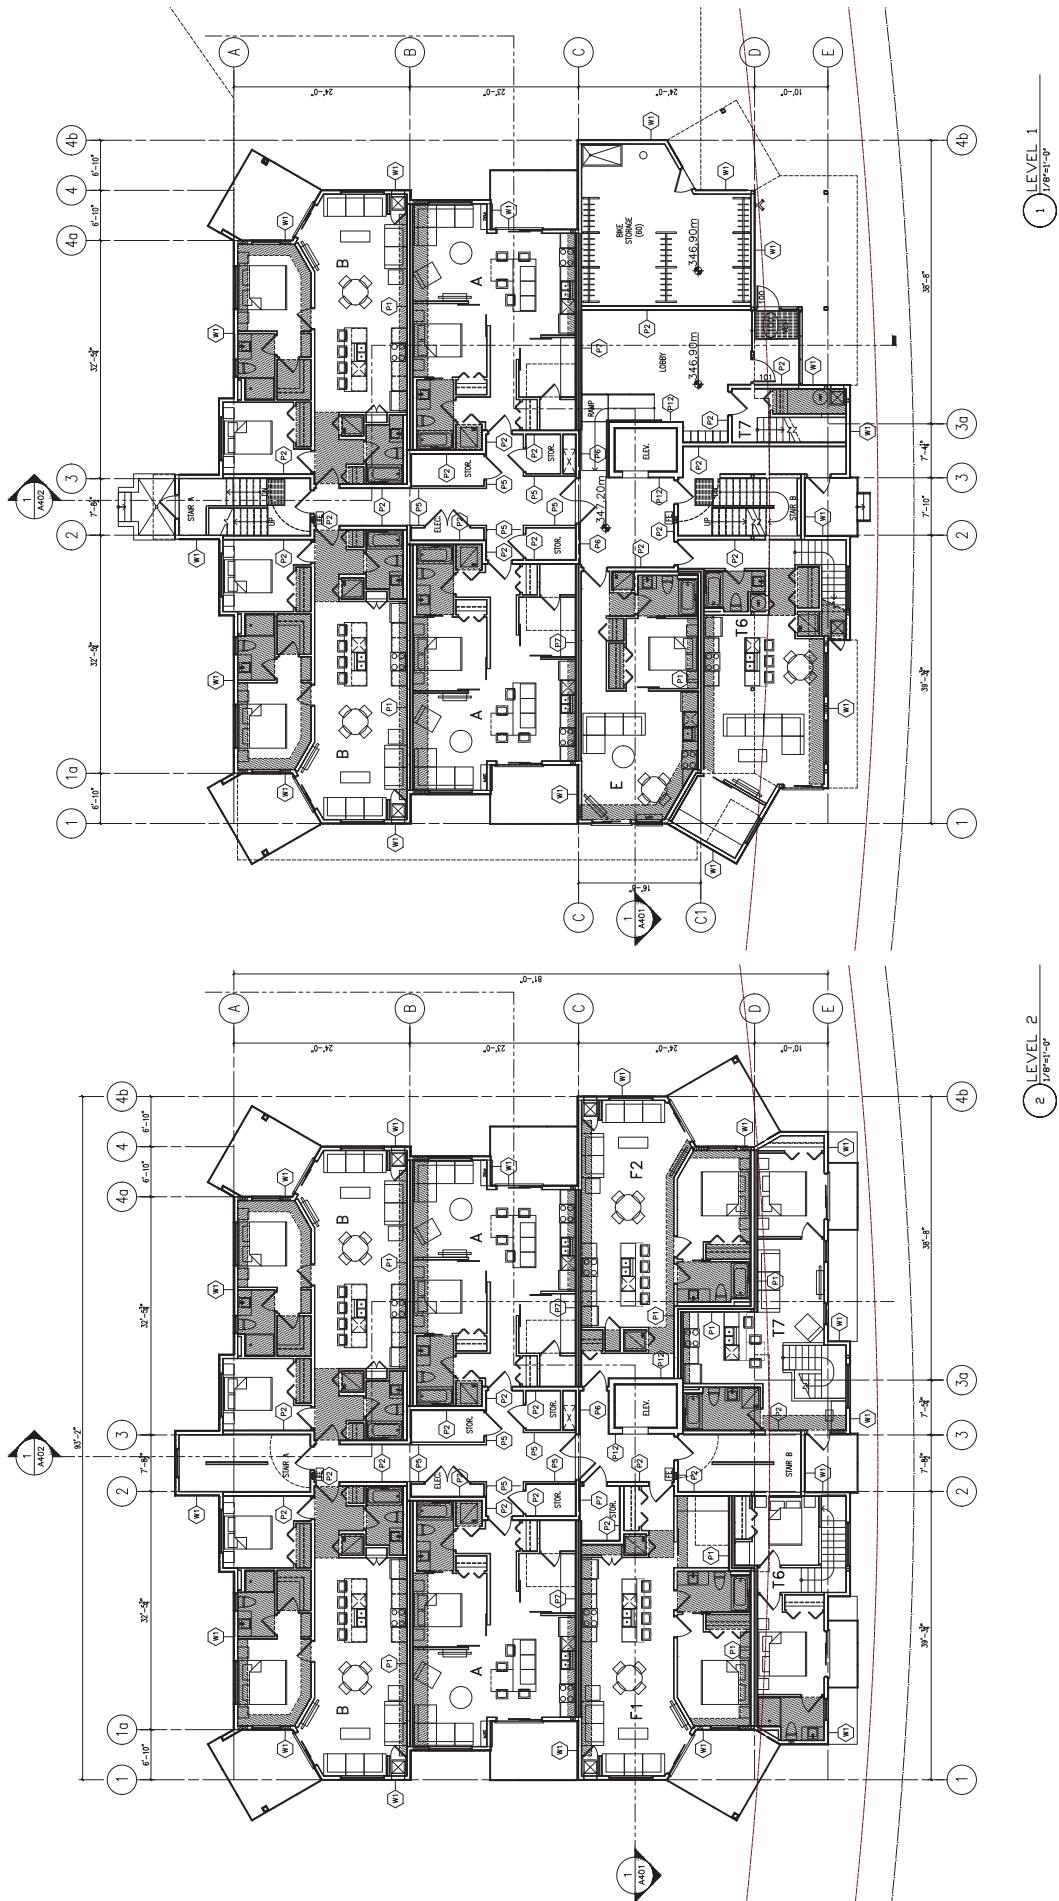

A 3 8

whose character and nature of the property or class of property to which it relates, and to report to the Board of Control for consideration without the aid of legal counsel or attorney, and shall be liable to punishment.

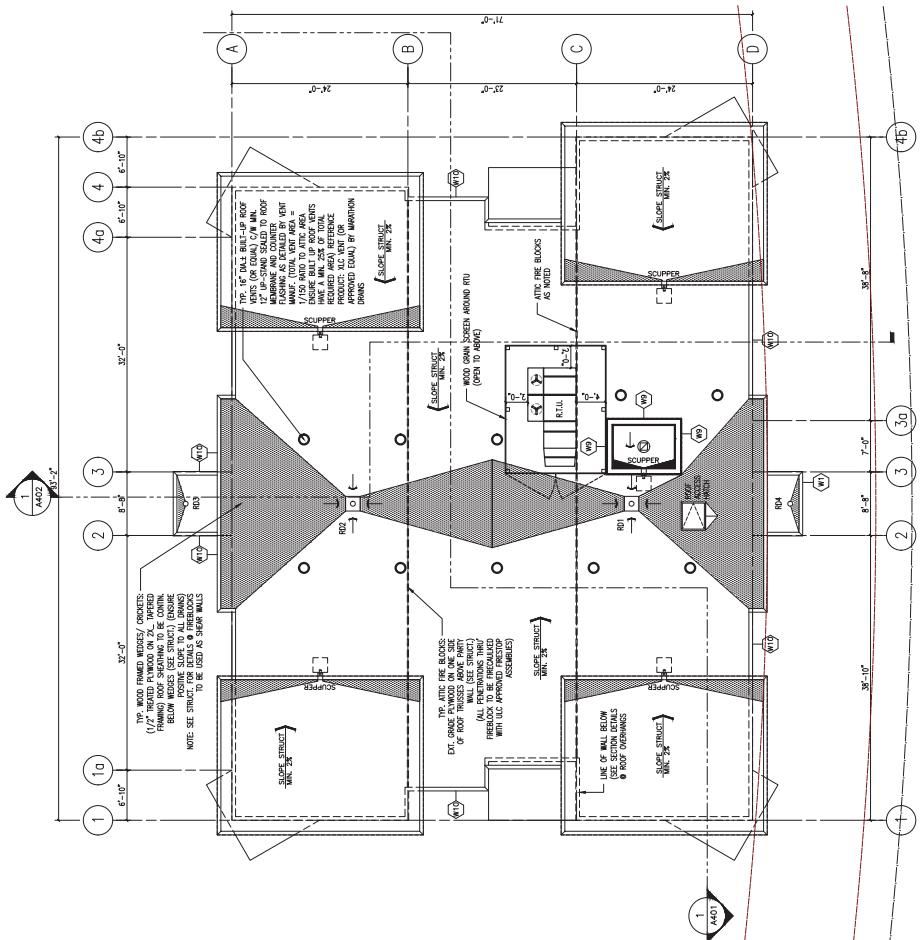

ROOF PLAN
1 1/8'-0"

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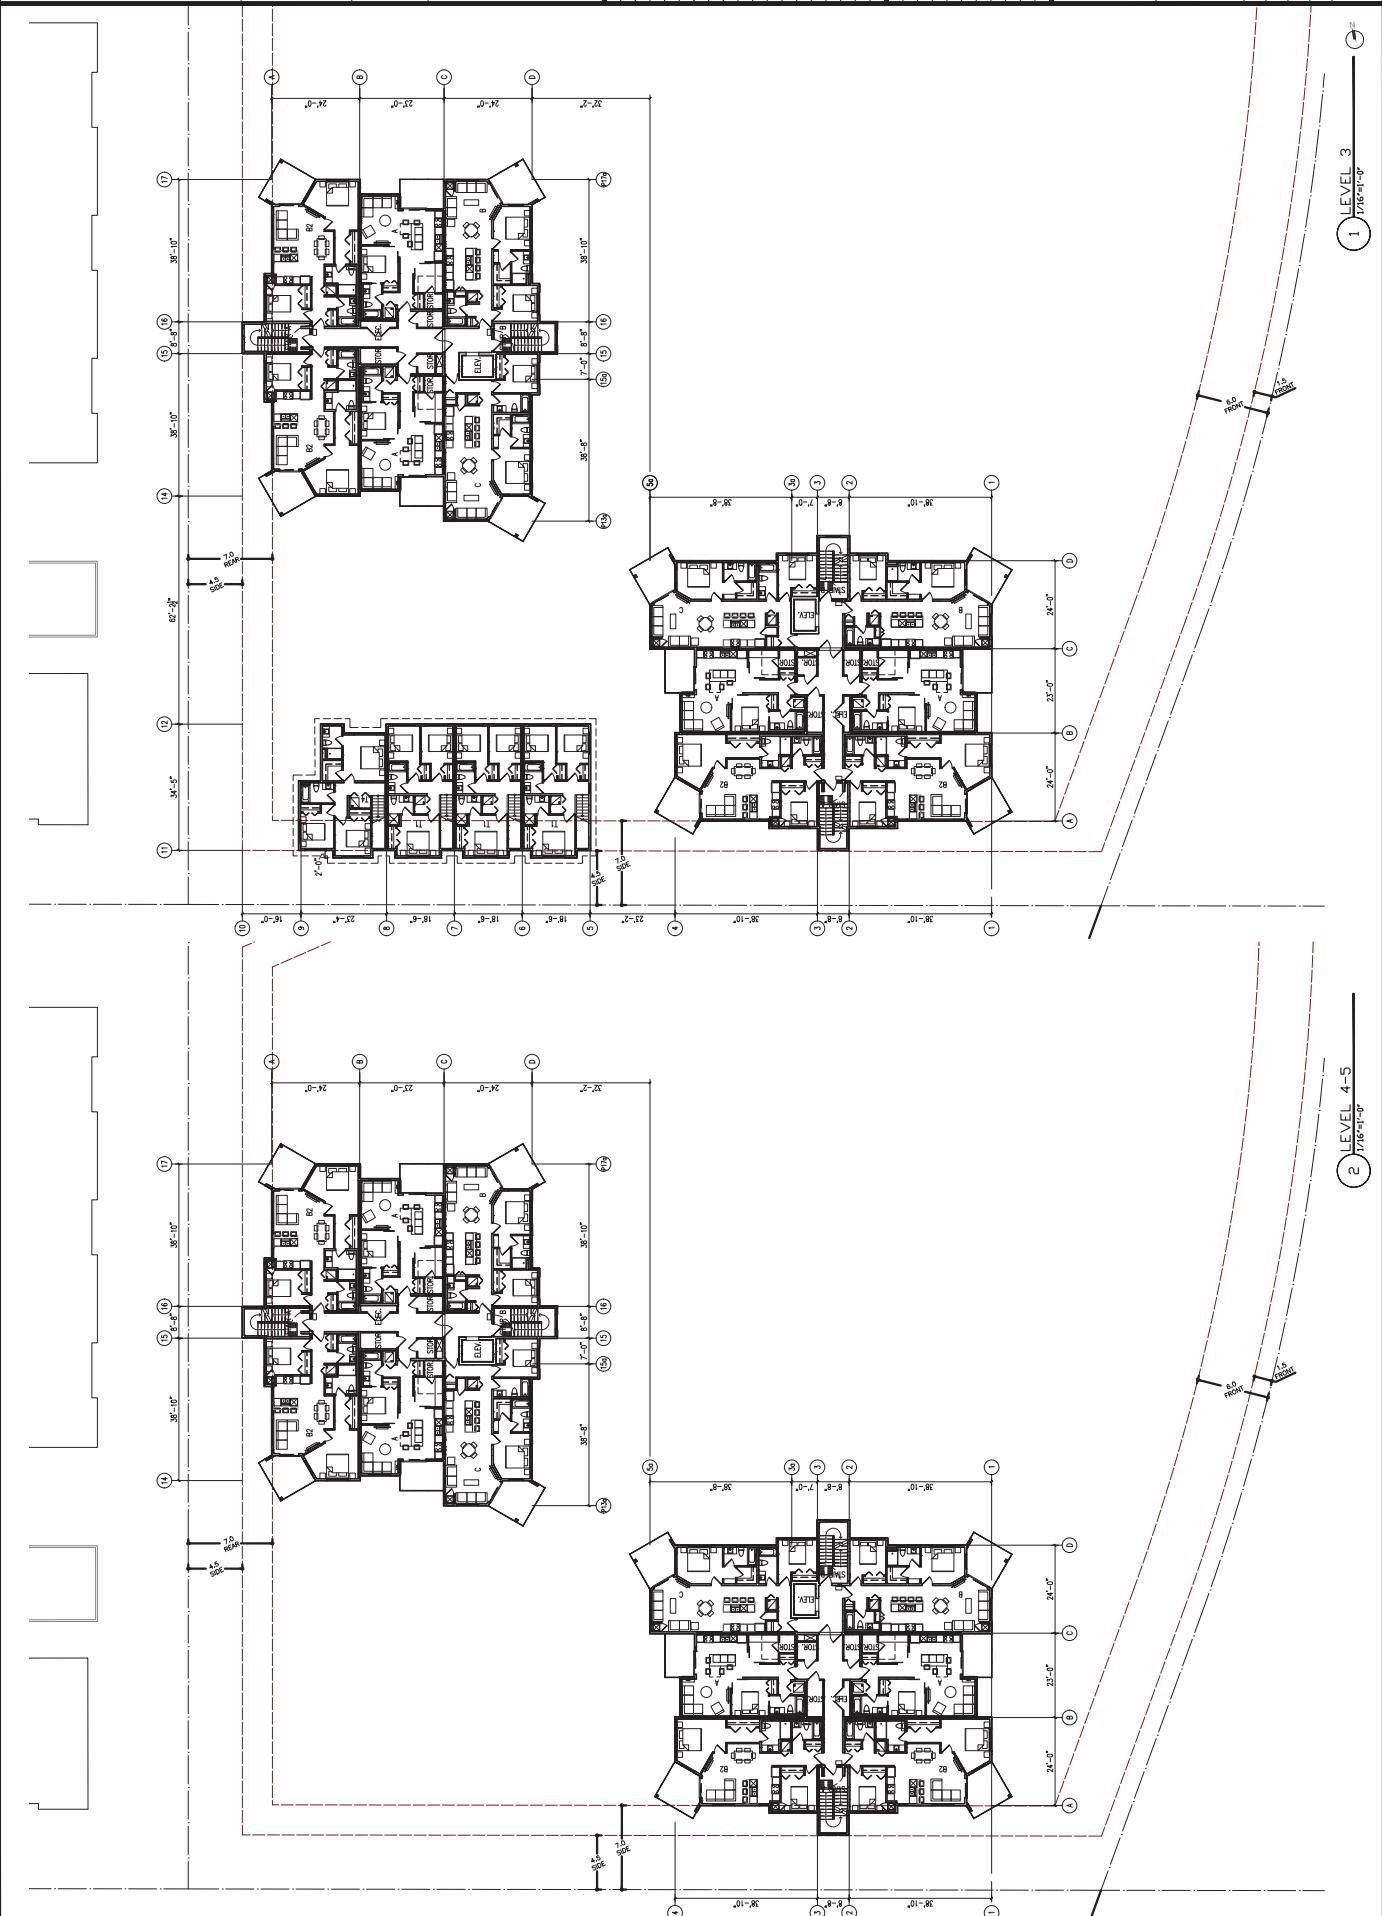


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KELOWNA

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Architect: Bluegreen Architecture Inc.
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City: Kelowna
Province: BC
Postal Code: V1Y 4X7
Phone: 250-824-2450
Fax: 250-824-2450
E-mail: kamloops@bluegreenarchitecture.com



A3.2.BC









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City of
KAMLOOPS
KELLOGG

Planning
Development
and
Community
Services



LEVEL 7
1/16'-0"-0"

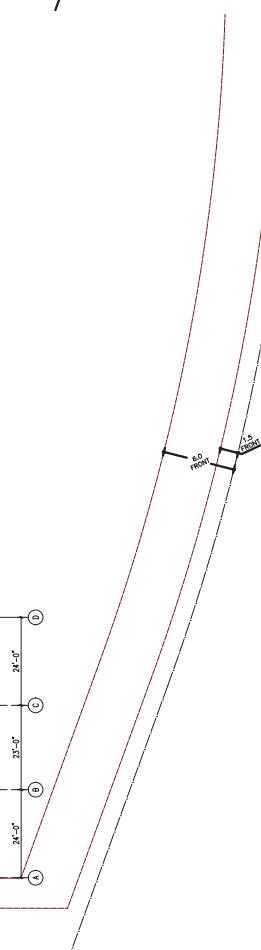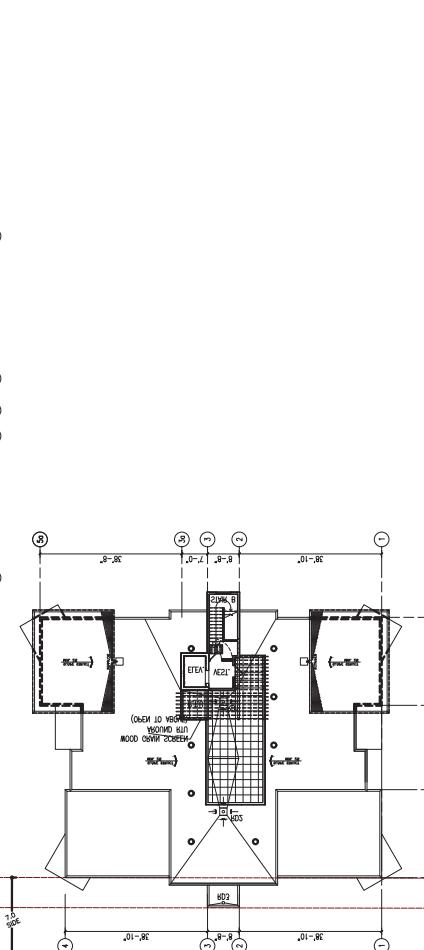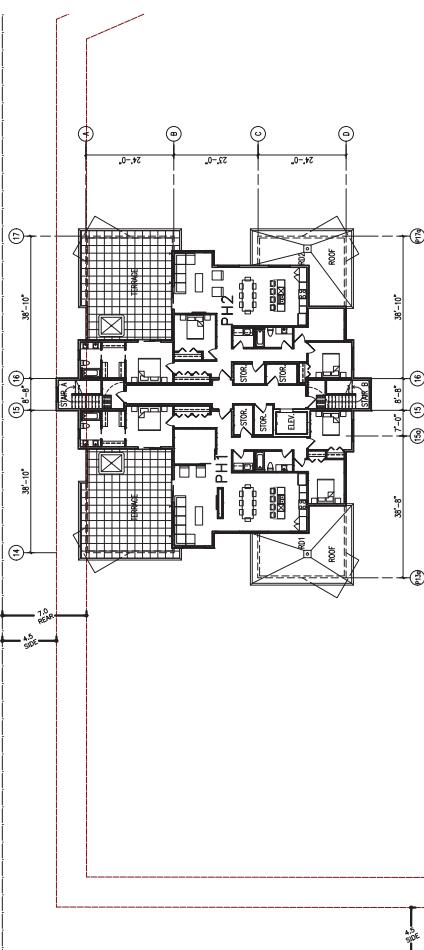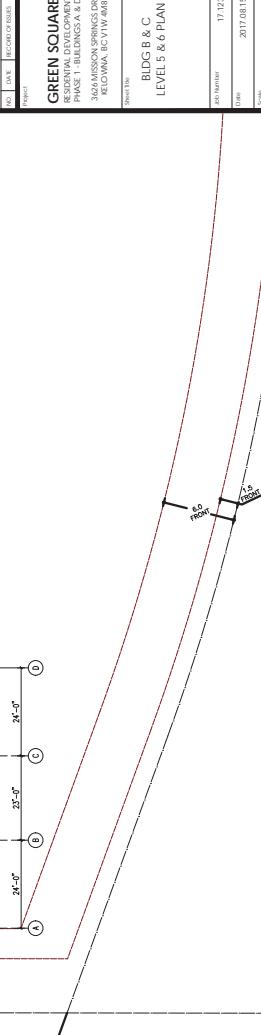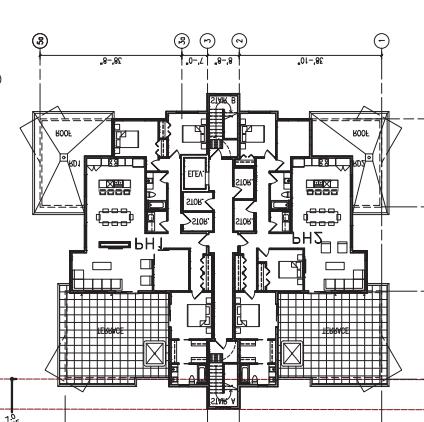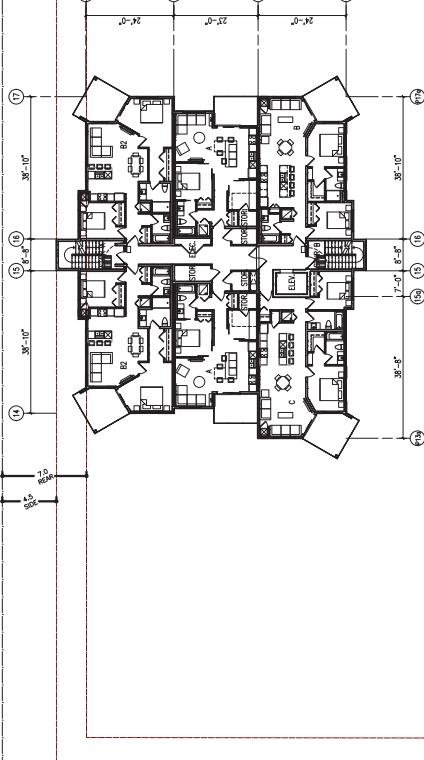LEVEL 6
1/16'-0"-0"

A3.3.BC


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2017.08.15
Scales
1/16'-0"
Sheet number
Title



420 - 1010 11th Street
Kelowna, BC V1Y 4J7
p: 778-242-0000
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■ KELLOWSA

Project Name: Green Square
Architect: Bluegreen Architecture Inc.
Address: 1013 Barnes Ave
City: Kelowna
Province: BC
Postal Code: V1Y 4J7
Phone: 778-242-0000
Fax: 778-242-0001
E-mail: info@bluegreenarchitecture.com
Web Address: www.bluegreenarchitecture.com
Architectural Drawing No.: A3.4.BC
Date Drawn: 2011/04/28
Scale: 1/16" = 1'-0"
Drawing No.: #
Comments: Blueprints prepared by Bluegreen Architecture Inc.

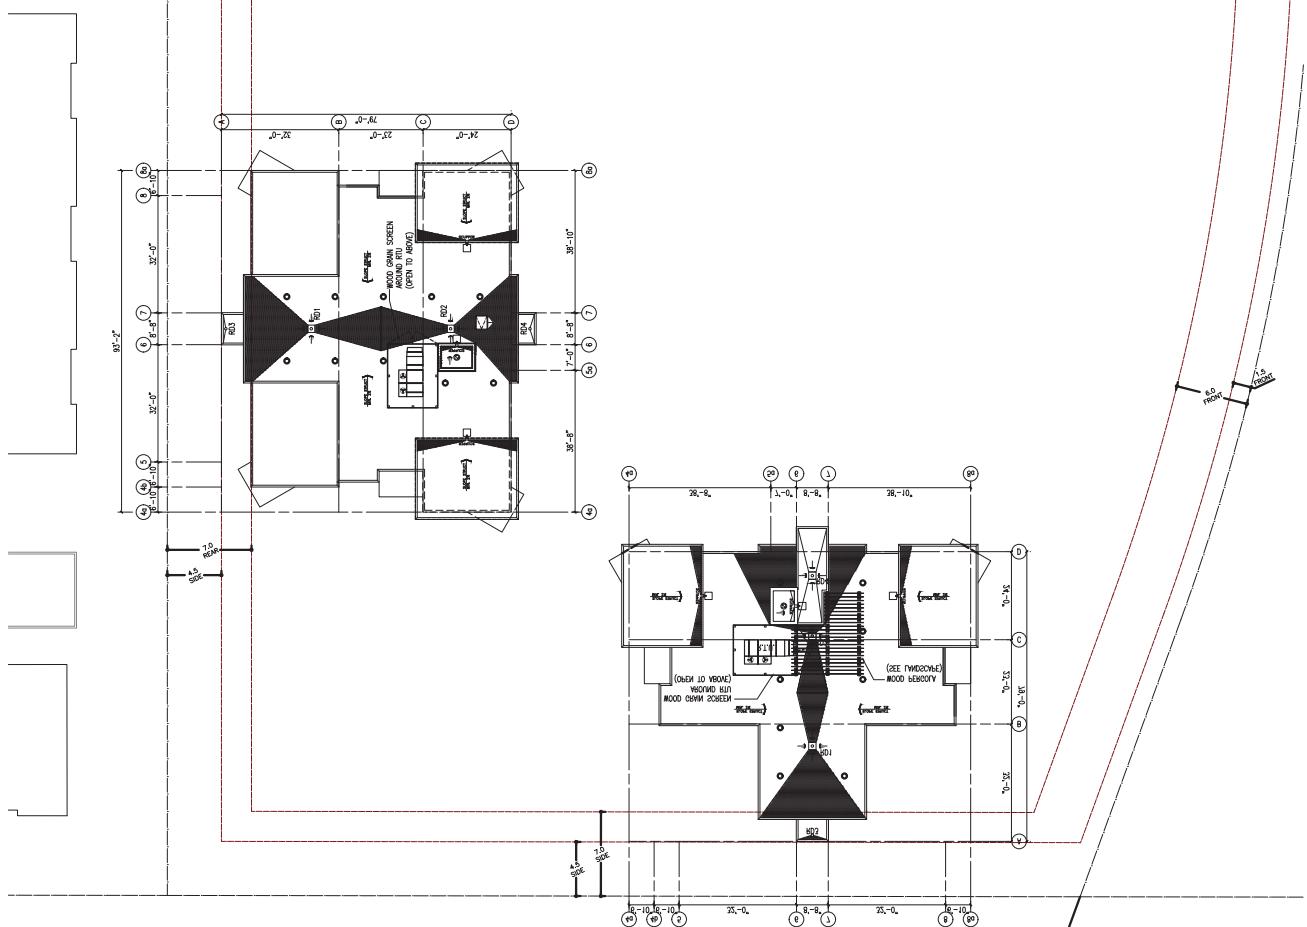

1/16" = 1'-0"
1013 Barnes Ave
Kelowna, BC
V1Y 4J7

Bluegreen Architecture Inc.

1 ROOF PLAN

A3.4.BC

BLUE GREEN
ARCHITECTURE INC.

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■ KELLOGG

Sect

TRIM BOARD



WOOD GRAIN CLADDING



FIBRE CEMENT PANEL



NL.T. PANEL



HORIZONTAL FIBRE CEMENT BOARDS

ELEVATION KEY NOTES, LEGEND
REFERENCE MATERIAL BOARD FOR COLOR SECTIONS

- HORIZONTAL FIBRE CEMENT BOARD
- FIBRE CEMENT PANEL, SMOOTH / ATTENS
- PRETENSED METAL LUGGING
- ALUM. SLIDING FRONT WINDOWS & DOORS □ LOW E CLEAR GLAZING
- NON-COMBUSTIBLE WOOD GRAIN HORIZONTAL
- NON-COMBUSTIBLE WOOD GATE SCREEN
- NL.T. AMPLIFIED THERM (NL) PANEL
- DUL-LAM BEAM C/W ANODIZED ALUM. SUPPORT STRUCTURE
- SAFETY GLASS / ALUM. GRANULARS
- WOOD PRIVACY SCREEN
- EPIK BRAD FLATNING, #8 BSC FACE SEE UNLOADING

BL 100'-0" U/F ROOF TRUSS
BL 141'-0" LEVEL 6
BL 111'-0" LEVEL 5
BL 100'-0" LEVEL 4
BL 111'-0" LEVEL 3
BL 100'-0" LEVEL 2
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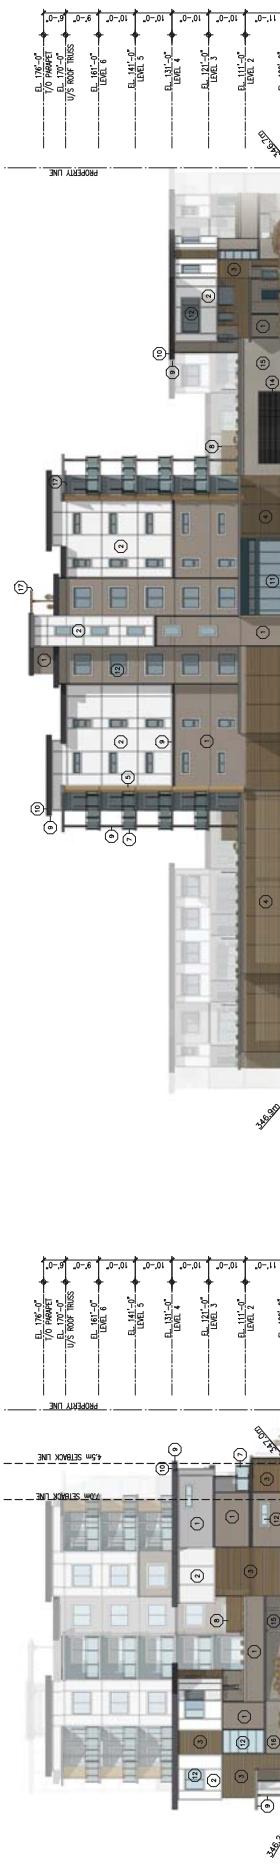
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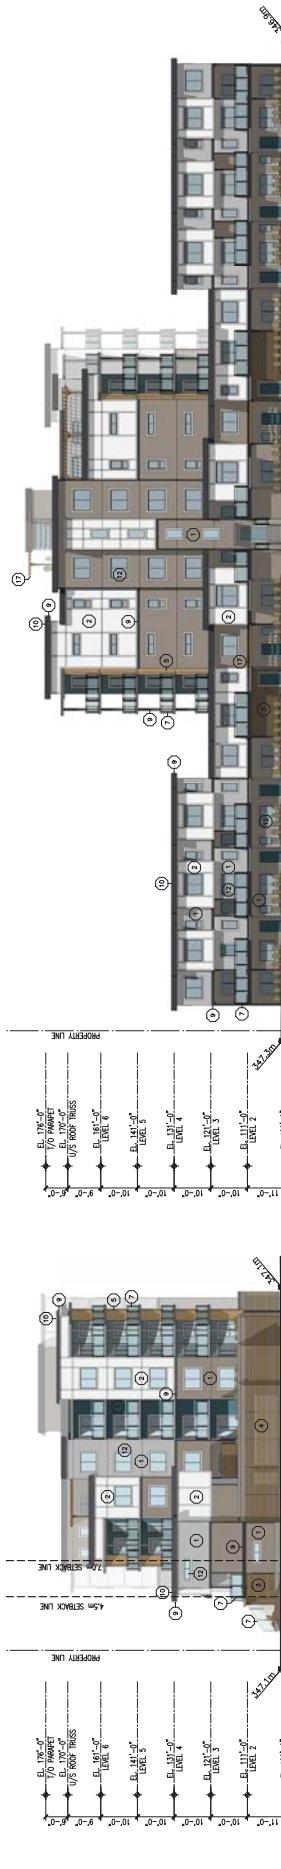
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SOUTH ELEVATION 2



SOUTH ELEVATION 1



NORTH ELEVATION



WEST ELEVATION



A5.1

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■ KELowna

SHEET




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Architect: *Architect*
Date: *Date*
Scale: *Scale*
Drawing No.: *Drawing No.*

TRIM BOARD



DARK GREY

WOOD GRAIN CLADDING

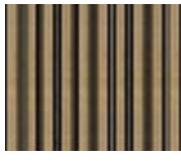

NATURAL WOOD FINISH WOOD GRAIN APPEARANCE

FIBRE CEMENT PANEL



WHITE

NL.T. PANEL



LIGHT BLUE

HORIZONTAL FIBRE CEMENT BOARDS



LIGHT BROWN

LUMBER



LIGHT GREY




ELEVATION NOTES LEGEND	
REFERENCE MATERIAL COLOR FOR COLOR SELECTIONS	
(1) HORIZONTAL FIBRE CEMENT BOARD	
(2) FIBRE CEMENT PANEL, SONG LUMBER, SONG	
(3) WOOD CONCRETE, WOOD, SONG, SONG	
(4) PREFINISHED METAL EAVE	
(5) WOOD, SONG, CONCRETE, WOOD, SONG, SONG	
(6) WOOD, SONG, CONCRETE, WOOD, SONG, SONG	
(7) SAFETY GLASS / WOOD GUARDRAILS	
(8) WOOD PRIVACY SCREEN	
(9) FIBRE CEMENT BM, FASCIA	
(10) PREFINISHED METAL EAVE	
(11) WOOD, SONG, CONCRETE, WOOD, SONG, SONG	
(12) WOOD, SONG, CONCRETE, WOOD, SONG, SONG	
(13) PAINTED METAL DOORS	
(14) PAINTED METAL DOORS	
(15) EXPOSED CONCRETE WALLS	
(16) BEVELLED FANNING ■ BRICK FACE (SEE ANNOTATE)	

1 WEST ELEVATION

1/16'-0"

HORIZONTAL FIBRE CEMENT BOARDS	FIBRE CEMENT PANEL	N.L.T. PANEL	WOOD GRAIN CLADDING	TRIM BOARD
--------------------------------	--------------------	--------------	---------------------	------------

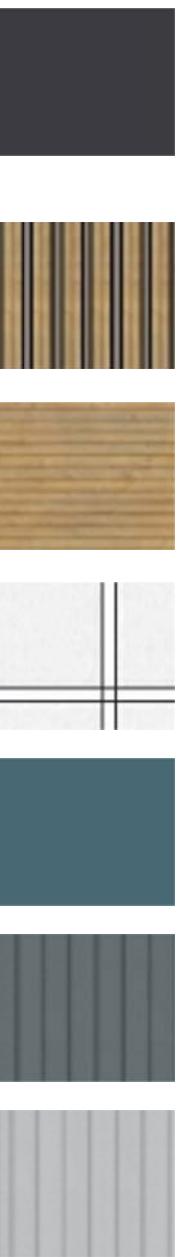

NATURAL WOOD FINISH WOOD GRAIN APPEARANCE DARK GREY
DARK GREY/BLUE LIGHT BLUE WHITE

FIBRE CEMENT PANEL N.L.T. PANEL



NATURAL WOOD FIN
ITE

TRIM BOARD



DARK GREY

D GRAIN CLADDING



D GRAIN APPEARAI

N.L.T. PANEL




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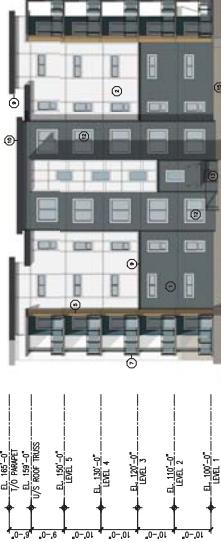
RDS



LIGHT GREY DARK GREY/BLUE

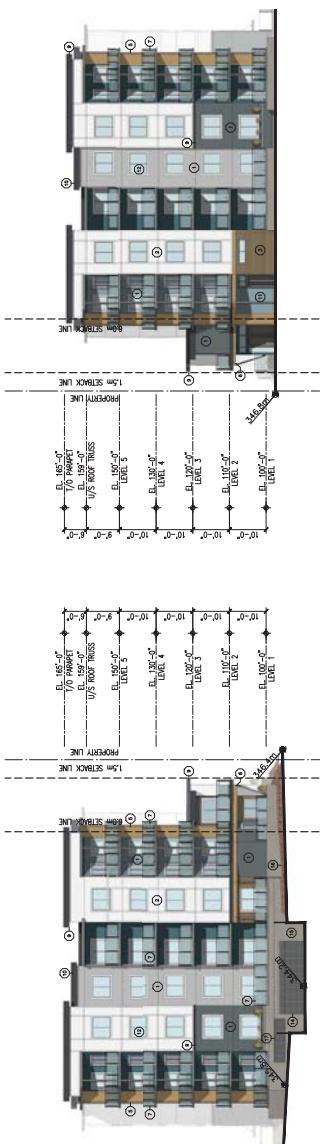

NORTH ELEVATION
1/16" = 1'-0"
4



WEST ELEVATION
1/16" = 1'-0"



EAST ELEVATION


Comments



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KAMLOOPS
■ KELOWNA
Surrey

Project Name: Green Square Residential Development
Architect: Blue Green Architecture Inc.
Location: 1013 Barnes Ave, Kelowna, BC
Completion Date: 2017
Architectural Style: Contemporary
Number of Units: 100
Building Type: Multi-family residential
Building Height: 6 stories
Building Material: Steel frame, concrete, and glass
Exterior Finish: Light-colored stone and wood siding
Interior Finish: Modern, open-concept floor plans with stainless steel appliances
Parking: Secure underground parking garage
Landscaping: Landscaped grounds with paved walkways and bike paths
Community Amenities: Swimming pool, fitness center, and social gathering spaces
Architectural Details: Large windows, cantilevered balconies, and a mix of building heights.

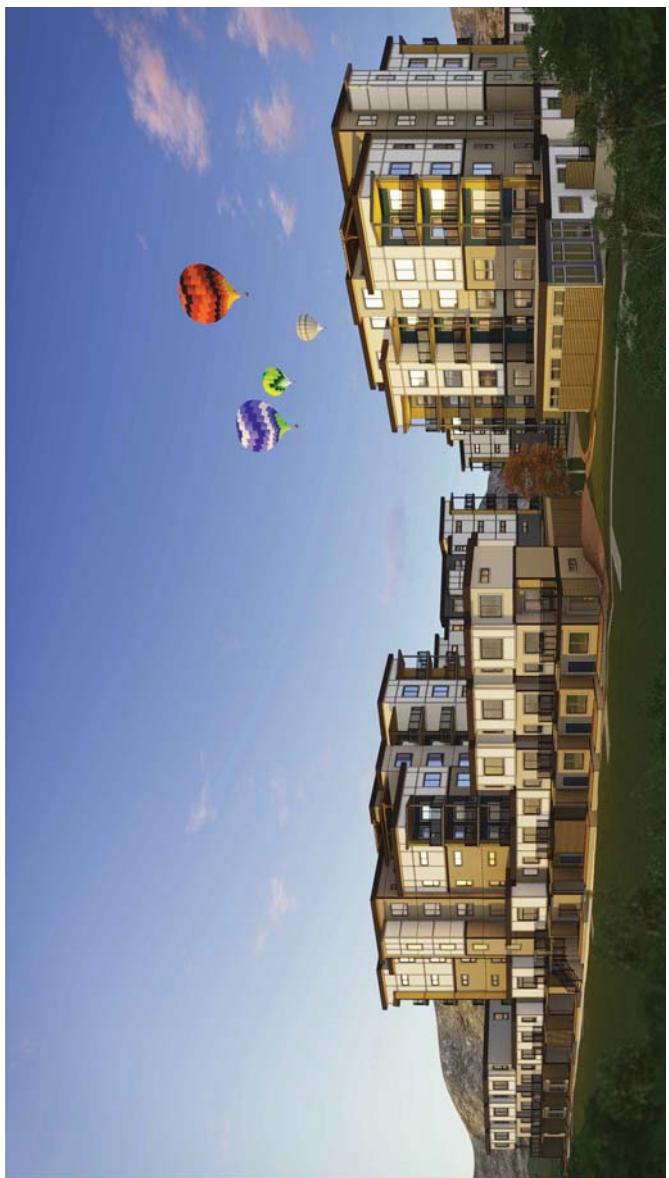

VIEW LOOKING SOUTH EAST BETWEEN BUILDINGS A & B ALONG NORTH PROPERTY LINE



VIEW LOOKING NORTH WEST BETWEEN BUILDINGS C & D ALONG MISSION SPRINGS DR



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www.BlueGreenArchitecture.com

KAMLOOPS
■ KELOWNA

Sect

Project Name: Green Square Residential
Architect: Blue Green Architecture Inc.
Location: Kelowna, BC
Completion Date: 2017
Architectural Style: Modern
Building Type: Residential
Number of Units: 100
Total Building Area: 10,000 sq ft
Total Site Area: 10,000 sq ft
Architectural Details:
- Multi-story residential building with a mix of unit types.
- Exposed steel frame and concrete columns.
- Large windows and glass doors.
- Vertical wood siding on the exterior.
- Ground floor includes retail or common areas.
- Landscaping includes a central square, paved walkways, and green roofs.



VIEW LOOKING WEST INTO THE CENTRAL SQUARE ALONG BUILDING A TURF LANE



VIEW LOOKING NORTH INTO CENTRAL SQUARE FROM BUILDING C

A6.2



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KAMLOOPS
 KELOWNA

Site

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VIEW LOOKING WEST ALONG MISSION SPRINGS DR



VIEW LOOKING NORTH AT BUILDING C FROM SOUTHERN PROPERTY LINE

A6.3



OUTLAND DESIGN
LANDSCAPE ARCHITECTURE

2006-1889 Spal Road
Kelowna, BC V1Y 4Y2
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FIGURE 1 TITLE
GREEN SQUARE RMS

SUBDIVISION:
3626 MISSION SPRINGS
DRIVE

LEGAL LOT C/P
PLAN: EPS944
Kelowna, BC
www.outlanddesign.ca

DATE OF DRAWING
17/04/20

Development Permit
17/26/19

Building Department Permit
17/27/24

Planning Department Permit
17/27/24

Water Department Permit
17/10/10

SEAL



WATER NUMBER

L1 / 1

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