June 6, 2018

Kimberly Brunet, Planner City of Kelowna Planning Department 1435 Water Street Kelowna BC V1Y 1J4

RE: Development Proposal Application – Design & Parking Rationale

Site Location: 365 Highway 33 E, Kelowna, British Columbia (corner of Hwy 33 and Mallach Rd)

365 Highway 33 E, Kelowna, British Columbia (the "**Property**") is a constrained site located on a high traffic area both for vehicular and pedestrian traffic. The current use of the site is a low density single family dwelling that is quite dated from the outside but renovated in the inside. Frankly, the building is a bit of an eye sore and the development of this corner lot would be beneficial to the values of neighboring properties.

The Property is just within the Rutland Urban Center and is surrounded by other multifamily developments. The Property has been the subject of previous development applications, however, due to the extensive road dedications, setbacks and parking requirements it has not been economically feasible to remove the existing structure and to replace it with a product that fits the neighbourhood. Our proposal is intended to provide a mix of unit types that take into consideration that the Property is in the Urban Center and on major bus routes. The Property is close to UBCO, Rutland's Town Center, South Rutland Elementary School and Big White Mountain truly allowing for an urban lifestyle where the need for a vehicle is largely reduced. It is the developer's intention through to work with the City to determine what incentives the developer can provide to future occupants such as ride share subsidies and public transit subsidies that promote urban living in consideration of the parking variance request.

At a time where attainable housing is in very short supply, this project would add much needed rental supply in a manner that is not desirable to all, but crucial to those that cannot afford a vehicle.

The development consists of (2) three storey buildings with a total of (4) units.


Building One – The first building includes (2) two-bedroom plus den units with roof top patios and a parking garage for the development (1 stall for each unit – 4 total). The first building is closer to the lane allowing for parking access off the lane. As determined in a meeting with City of Kelowna staff, any driveway access in the middle of the lot was deemed undesirable due to proximity to Highway 33.

Building Two - The second building, adjacent to Highway 33, includes (2) two-bedroom plus den ground oriented units. The units have a partially sunk-in unfinished basement and are designed to be attractive to young families. These unfinished basements have rear yard access and can be used for a rec room, home gym, and storage.

Due to the narrowness of the site after accounting for road dedications, the maximum amount of parking that would fit on site while allowing for a viable project is four parking stalls. The parking stall requirement for this development totals six stalls (1.5 stalls per two bedroom unit x 4 units = 6 stalls

required). This development is proposing four parking stalls at a one to one ratio and "cash in lieu" would be provided for the remaining two stalls. Street parking along Mallach road is also available.

This project will provide the neighborhood with a necessary facelift through its beautiful exterior finishes, low/no maintenance landscaping and privacy fencing and hedges. We hope that the City of Kelowna will allow this project to come to life by working through the various site constraints.

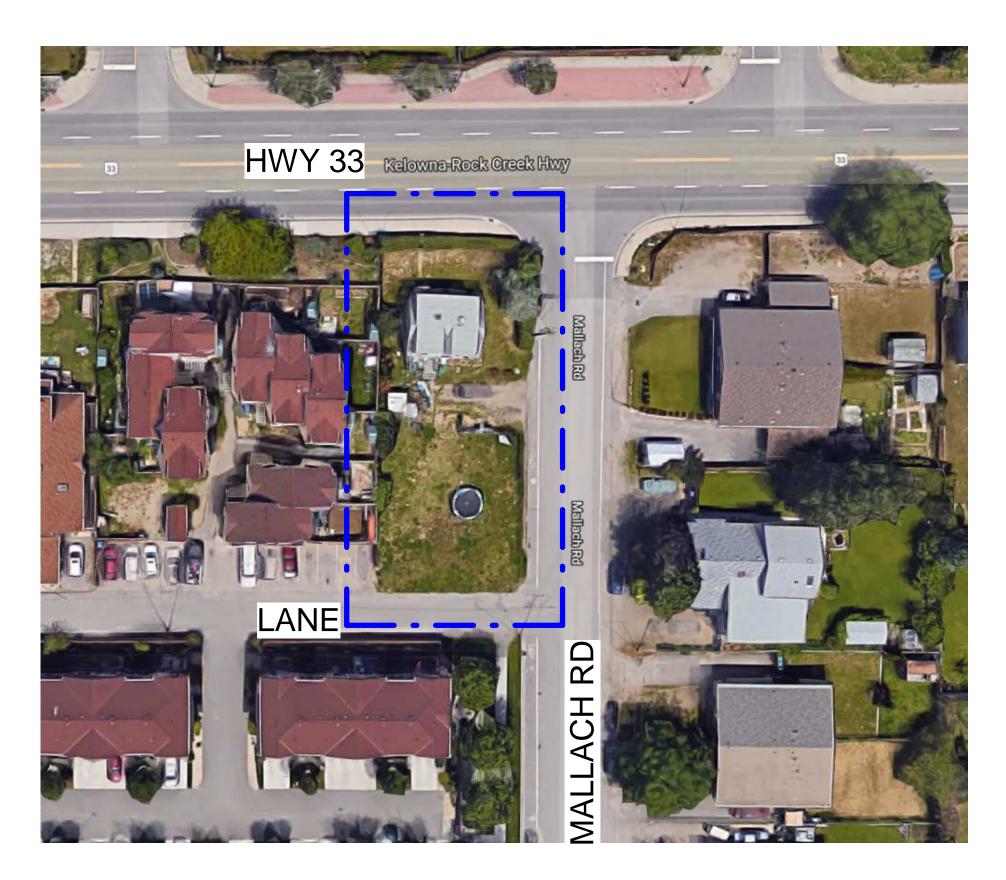







365 HWY 33 E KELOWNA, BC BUILDING 1

ISSUE FOR DEVELOPMENT PERMIT

	SHEET INDEX
ID	NAME
A0.0	COVER PAGE
A0.1	SITE LOCATION
A0.2	STREET VIEWS
A0.3	SITE PLAN
A1.0	FOUNDATION & GROUND LEVEL PLAN
A1.1	MAIN FLOOR & UPPER FLOOR PLAN
A1.2	ROOF TOP PATIO & ROOF PLAN
A2.0	ELEVATIONS
	•

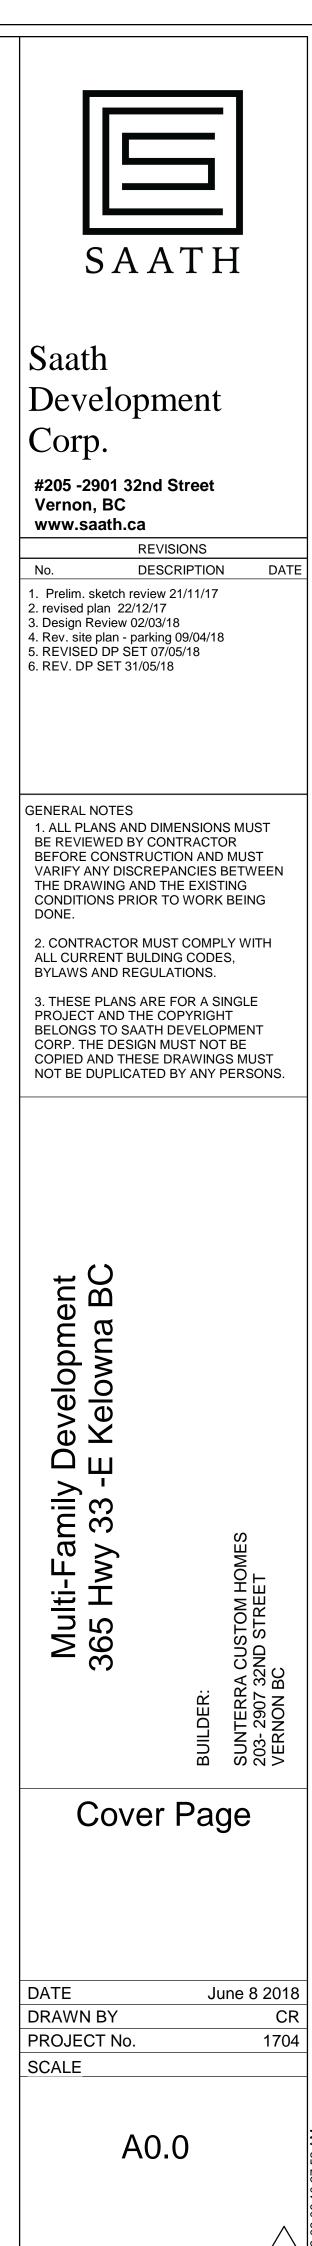



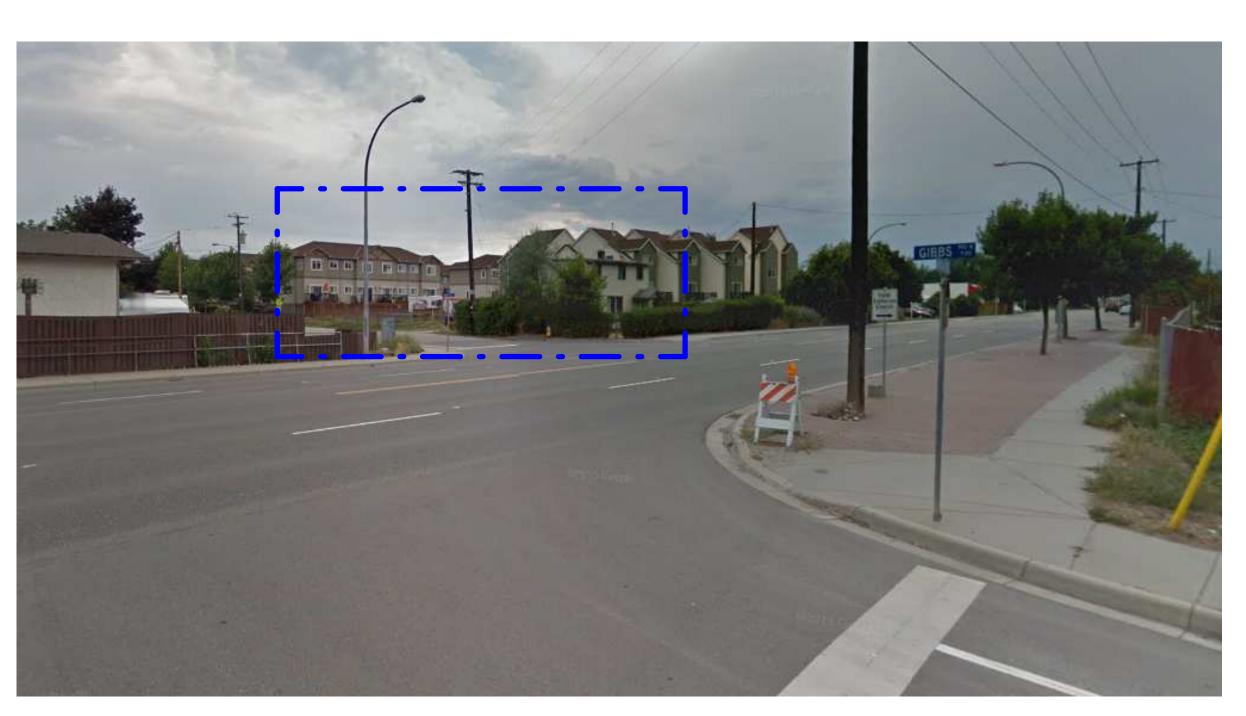


STREET VIEW LOOKING WEST

SITE LOCATION 365 HWY 33 E



STREET VIEW LOOKING EAST

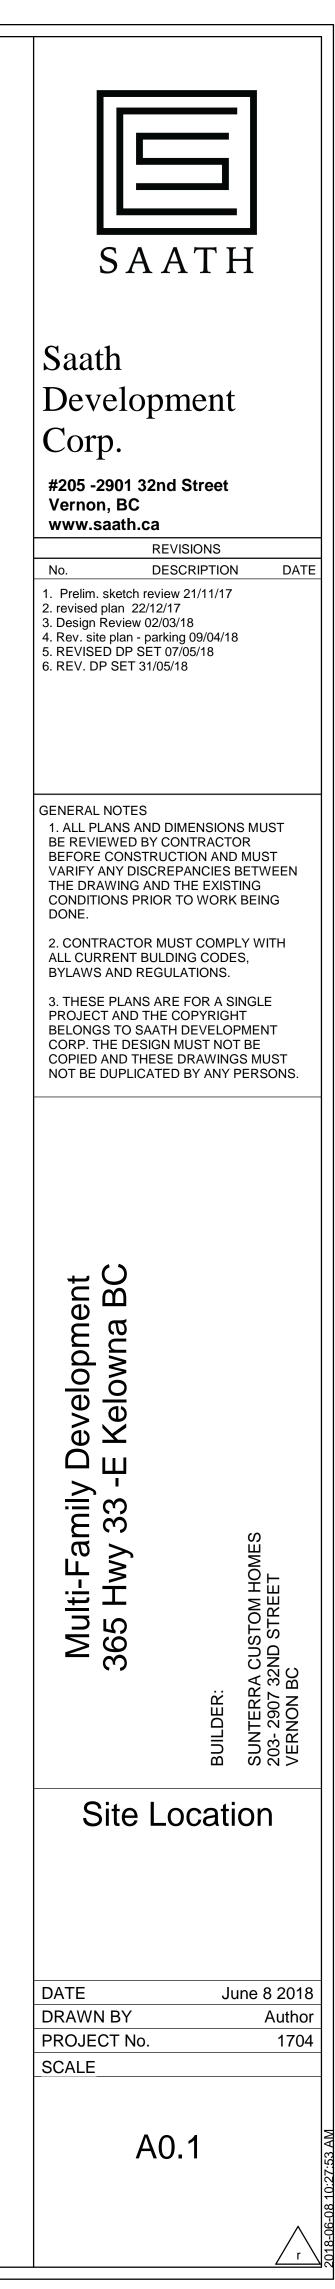

STREET VIEW MALLACH RD LOOKING NORTH

STREET VIEW MALLACH RD LOOKING WEST




STREET VIEW HWY 33 CORNER NTS





SAATH
Saath Development Corp. #205 - 2901 32nd Street Vernon, BC www.saath.ca No. DESCRIPTION DATE 1. Prelim. sketch review 21/11/17 2. revised plan 22/12/17 3. Design Review 02/03/18 4. Rev. site plan - parking 09/04/18 5. REVISED DP SET 07/05/18 6. REV. DP SET 31/05/18
 GENERAL NOTES 1. ALL PLANS AND DIMENSIONS MUST BE REVIEWED BY CONTRACTOR BEFORE CONSTRUCTION AND MUST VARIFY ANY DISCREPANCIES BETWEEN THE DRAWING AND THE EXISTING CONDITIONS PRIOR TO WORK BEING DONE. 2. CONTRACTOR MUST COMPLY WITH ALL CURRENT BULDING CODES, BYLAWS AND REGULATIONS. 3. THESE PLANS ARE FOR A SINGLE PROJECT AND THE COPYRIGHT BELONGS TO SAATH DEVELOPMENT CORP. THE DESIGN MUST NOT BE COPIED AND THESE DRAWINGS MUST NOT BE DUPLICATED BY ANY PERSONS.
Multi-Family Development 365 Hwy 33 -E Kelowna BC BUILDER: BUILDER: SUNTERRA CUSTOM HOMES 203- 2907 32ND STREET VERNON BC
Street Views
DATE June 8 2018 DRAWN BY Author PROJECT No. 1704 SCALE
A0.2

PROPERTY ADDRESS: 365 HWY 33 -E RUTLAND BC LEGAL ADDRESS: KID 326886, PLAN 5012, LOT C LOT SIZE: 0.21 ACRES (849.83 M2) PROPOSED DEVELOPMENT: 4 UNITS TOTAL

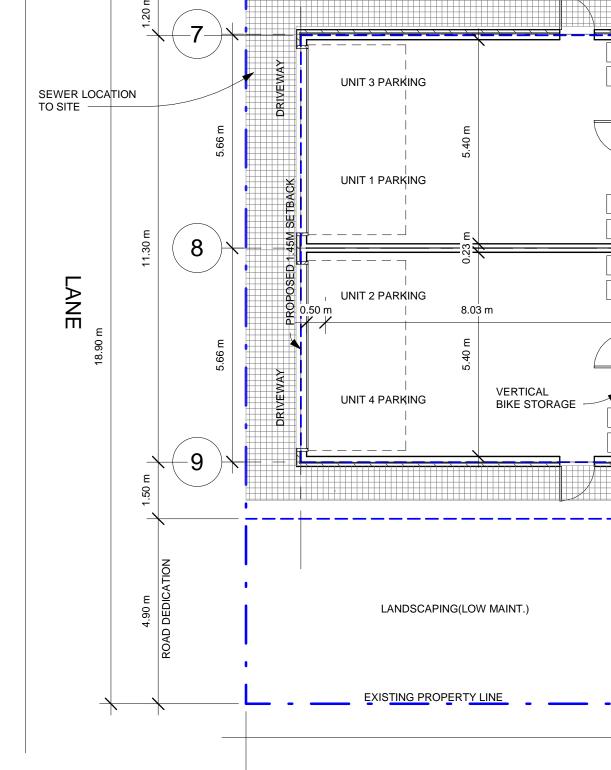


1

1.45 m


8.84 m


14.02 m

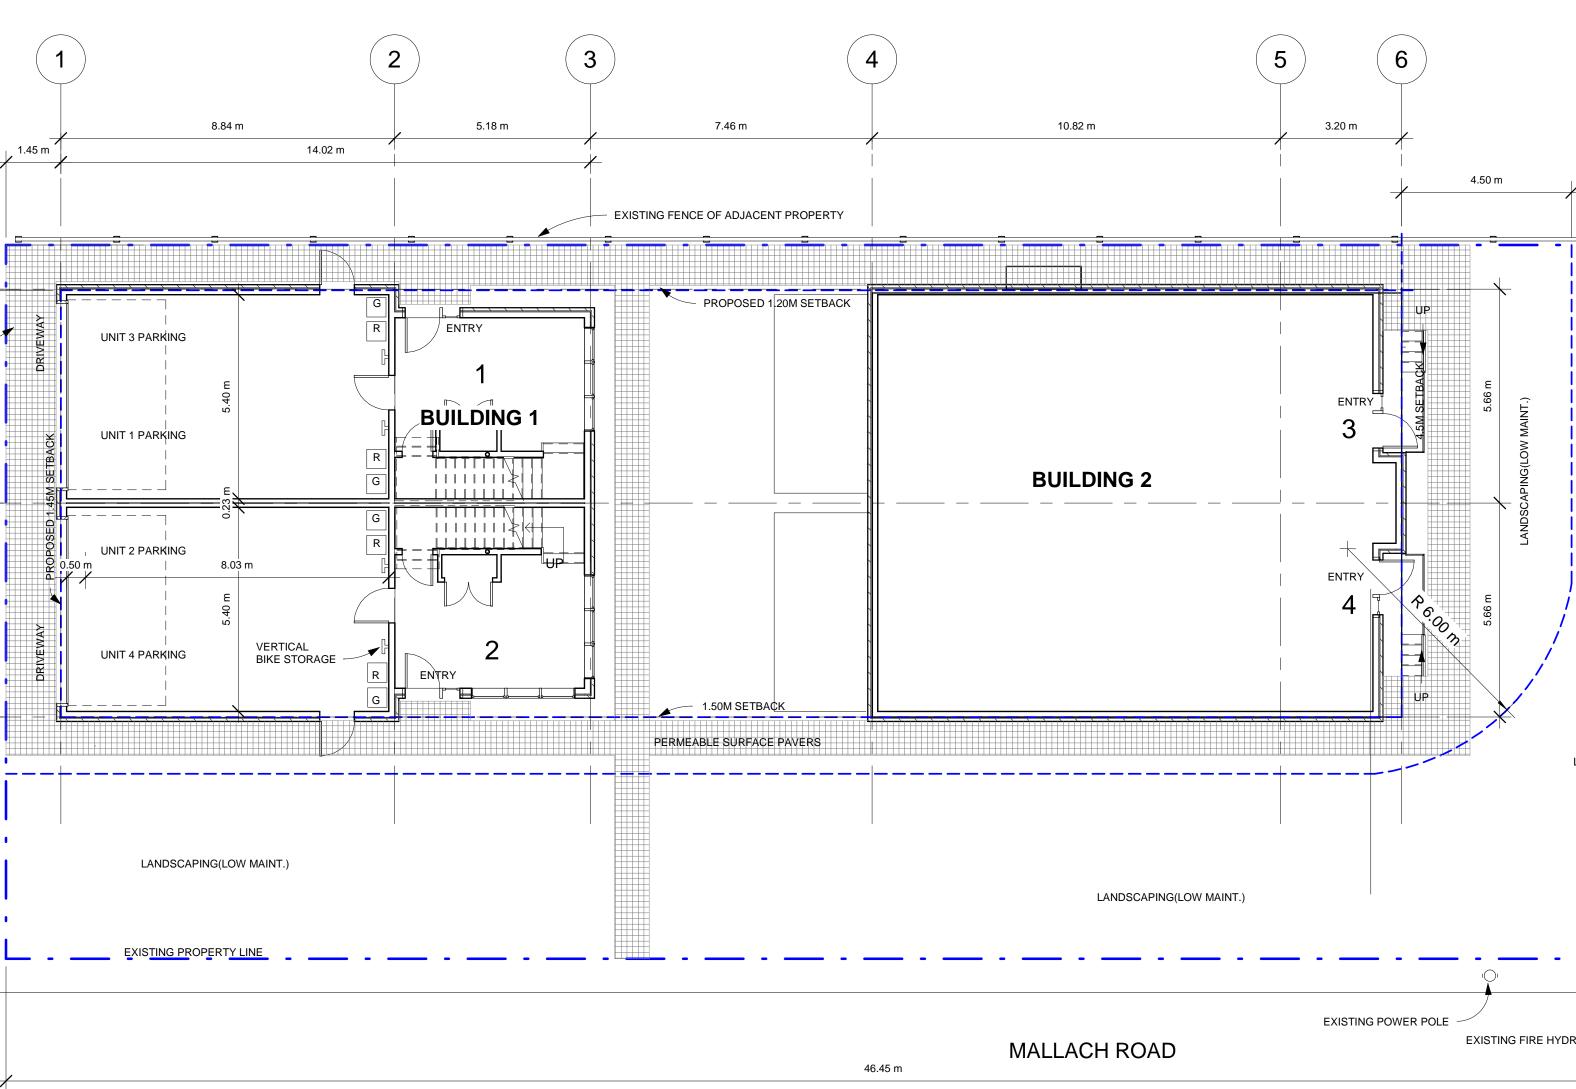


PROPERTY ADDRESS: 365 HWY 33 -E RUTLAND BC _EGAL ADDRESS: KID 326886, PLAN 5012, LOT C	<u>SECTION 6.4 PROJECTIONS INTO SIDE YARDS</u> MAX PROJECTION 0.6M	BC BUILDING CODE:	
_OT SIZE: 0.21 ACRES (849.83 M2)		DIV B PART 9 - TABLE 9.10	<u>0.14.4.A</u>
	OPEN TREAD STAIR AND LANDING FOR UNITS 5& 6 = 0.6M INTO SIDE YARD	LIMITING DISTANCE-	
PROPOSED DEVELOPMENT: 4 UNITS TOTAL	SECTION 8: PARKING AND LOADING	MAX FACE OVER 100M2, 6 OPENINGS = 19% FOR EA	
JNITS 1,2,3,4 = 3 STOREY 2 BED + DEN, 2.5 BATH WITH ROOF TOP PATIO, 3UILDING 2 - UNFINISHED GROUND FLOOR	PARKING STALL SIZE = 6.0M X 2.5M, BESIDE A COLUMN OR WALL 2.70M	OPEININGS = 19% FOR EA	CH BUILDING FACE
SOLDING 2 - UNFINISHED GROUND FLOOR	ARRING OTALE OIZE - 0.0M X 2.0M, DECIDE A COECOMIN OR WALL 2.10M	BLDG 1	BLDG 2
ZONING BYLAW No. 8000	TABLE 8.1 PARKING SCHEDULE APARTMENT PARKING:	(DISTANCE BETWEEN BL	
ZONING: SECTION 13.9 - RM3 LOW DENSITY MULTIPLE HOUSING	AFARTMENT FARKING.	WALL FACE = 124.30M2	WALL FACE = 125.14
SITE LOCATED WITHIN THE URBAN CENTRE)	1.5 SPACES PER 2 BEDROOM - 1.5 x 4 UNITS=6	OPENINGS = 20.06M2	OPENINGS = 22.11M
	TOTAL REQUIRED SPACES = 6	= 16%	= 18%
SECTION 13.9.6 - DEVELOPMENT REGULATIONS	PROVIDED 4 STALLS, WITH CASH IN LEU FOR THE REMAINING 2 STALLS		
MAX FLOOR AREA RATIO IS 0.75 + 0.05 FOR SCREENED PARKING	STREET PARKING ALONG MALLACH RD		
+ 0.1 FOR SITE LOCATED WITHIN THE URBAN CENTRE		<u>3.2.2.52 - GROUP C, UP TO</u>	
= 0.90 MAX FLOOR AREA RATIO	TABLE 8.3 BICYCLE PARKING	FACING TWO STREETS -	
BLDG 1 BLDG 2	CLASS 1 - FOR RESIDENTS 0.5 PER DWELLING	NOT SPRINKLERED, COM	BUSTABLE OR NON CUN
GROUND LEVEL - 211SF GROUND LEVEL - 1430 SF	= 0.5 X 4 = 2 STALLS REQUIRED	CONSTRUCTION	
GROUND LEVEL - 211SFGROUND LEVEL - 1430 SFMAIN LEVEL - 1418 SFMAIN LEVEL - 1388 SFJPPER LEVEL - 1218 SFUPPER LEVEL - 1418 SFROOF TOP PATIO - 610 SFROOF TOP PATIO - 586 SF	PROVIDED 1 PER UNIT, VERTICAL RACK INSIDE GARAGE		
JPPER LEVEL - 1218 SF UPPER LEVEL - 1418 SF	TOTAL BIKE PARKING PROVIDED = 4 STALLS	PROPOSED BUILDING FO	UTRINT FOR BUTH BUI
ROOF TOP PATIO - 610 SF ROOF TOP PATIO - 586 SF NOT INCLUDING PARKING,STAIRWELLS, AND MECH RMS		3.3.4.2 (1) FIRE SEPARATI	ON
	<u>SECTION 13.9.7</u> OPEN SPACE REQUIRED PER UNIT -	FIRE SEPARATION BETW	
PROPOSED = 8279 SF (769.14M2) / 849.83M2 = 0.90	25M2 PER 2 OR MORE BEDROOMS	TINE SEFARATION DETW	
SITE COVERAGE	TOTAL REQUIRED OPEN SPACE= 100 M2		
MAX BUILDING SITE COVERAGE: 40%, W/ PRIVATE OPEN SPACE PER			
JNIT MAX ALLOWED 50%			
	PROVIDED: 2 BEDROOM UNITS - ROOF TOP PATIO		
BUILDING FOOTPRINT:	610SF X 2 PLUS 586SF X 2= 2392 SF 222 M2		
BLDG 1 = 155.07M2			
BLDG 2 = 157.46M2	TOTAL PROVIDED USABLE OPEN SPACE = 222 M2		
312.53M2 / 849.83M2 = 37%			
MAX SITE COVERAGE FOR DRIVEWAYS AND PARKING = 10%,	GROUND LEVEL LANDSCAPEING AREA = 420.30 M2		
MAX SITE COVERAGE FOR DRIVEWAYS AND PARKING = 10%, MAY BE INCREASED TO 15% WITH PERMEBLE SURFACES			
	SECTION 7: LANDSCAPING AND SCREENING		
PERMEABLE SIDEWALKS =117 M2	OLOTION I. LANDOONTING AND CONLEMING		
17 M2 / 849.83M2= 14%	7.3 REFUSE AND RECYCLE BINS		
	(NOTED ON THE DEVELOPEMENT PERMIT CHECK LIST - 5 OR MORE RESIDENTIAL UNITS		
FOTAL COMBINED SITE COVERAGE (50% + 15%= 65%) = PROVIDED 51%	REQUIRES A COMMERCIAL BIN)		
	PROVIDED - 4 STANDARD RESIDENTIAL GARBAGE AND RECYCLE BINS,		
IAX HEIGHT: LESSER OF 1M OR 3 STOREYS	ONE EACH PER UNIT LOCATED IN GARAGE ROLL TO CURB (LANE) DAY OF PICK UP		
ROPOSED BUILDING HEIGHT = TOP TO ROOF DECK 9.96M			
PLUS 2.65M ADDITIONAL HEIGHT TO TOP OF ENCLOSED STAIR ACCESS ROOF			
STAIR ACCESS HEIGHT NOT INCLUDED IN CALC. PER SECTION 6.6 , SENTANCE 6.6.1)			
ROAD DEDICATIONS:			
IWY 33 - 5M, MALLACH RD - 4.9M, WITH 6M RADIUS CORNER ROUNDING			
FRONT: REQUIRED 4.5M (HWY 33), PROVIDED 4.5M			
SIDE FROM LANE: REQUIRED 3.0M, PROVIDED 1.45M -VARIANCE REQUIRED			
SIDE YARD: REQUIRED 1.5M (MALLACH RD) -URBAN CENTER, PROVIDED 1.5M SIDE YARD: REQUIRED 4.5M , PROPOSED 1.20M -VARIANCE REQUIRED			
JUL TAND. NEQUINED HJWI, F NOFOJED 1.20WI "VANIANGE REQUIRED			


5.00 m ROAD DEDICATION			SAATH
	EXISTING PROPERTY LINE	HWY 33 -E RUTLAND	Saath Development Corp. #205 -2901 32nd Street Vernon, BC www.saath.ca <u>REVISIONS</u> <u>No. DESCRIPTION DATE</u> 1. Prelim. sketch review 21/11/17 2. revised plan 22/12/17 3. Design Review 02/03/18 4. Rev. site plan - parking 09/04/18 5. REVISED DP SET 07/05/18 6. REV. DP SET 31/05/18
LANDSCAPING(LOW MAINT.)		EXISTING SIDEWALK	GENERAL NOTES 1. ALL PLANS AND DIMENSIONS MUST BE REVIEWED BY CONTRACTOR BEFORE CONSTRUCTION AND MUST VARIFY ANY DISCREPANCIES BETWEEN THE DRAWING AND THE EXISTING CONDITIONS PRIOR TO WORK BEING DONE. 2. CONTRACTOR MUST COMPLY WITH ALL CURRENT BULDING CODES, BYLAWS AND REGULATIONS. 3. THESE PLANS ARE FOR A SINGLE PROJECT AND THE COPYRIGHT BELONGS TO SAATH DEVELOPMENT CORP. THE DESIGN MUST NOT BE COPIED AND THESE DRAWINGS MUST NOT BE DUPLICATED BY ANY PERSONS.
LOWABLE 5.14M2 11M2 750M2 CUMBUSTABLE BUILDINGS = 312.53M2 NITS 1 HR			Multi-Family Development 365 Hwy 33 -E Kelowna BC BUILDER: BUILDER: SUNTERRA CUSTOM HOMES 203- 2907 32ND STREET VERNON BC
			Site plan
			DATEJune 8 2018DRAWN BYCRPROJECT No.1704SCALE1 : 100
			A0.3

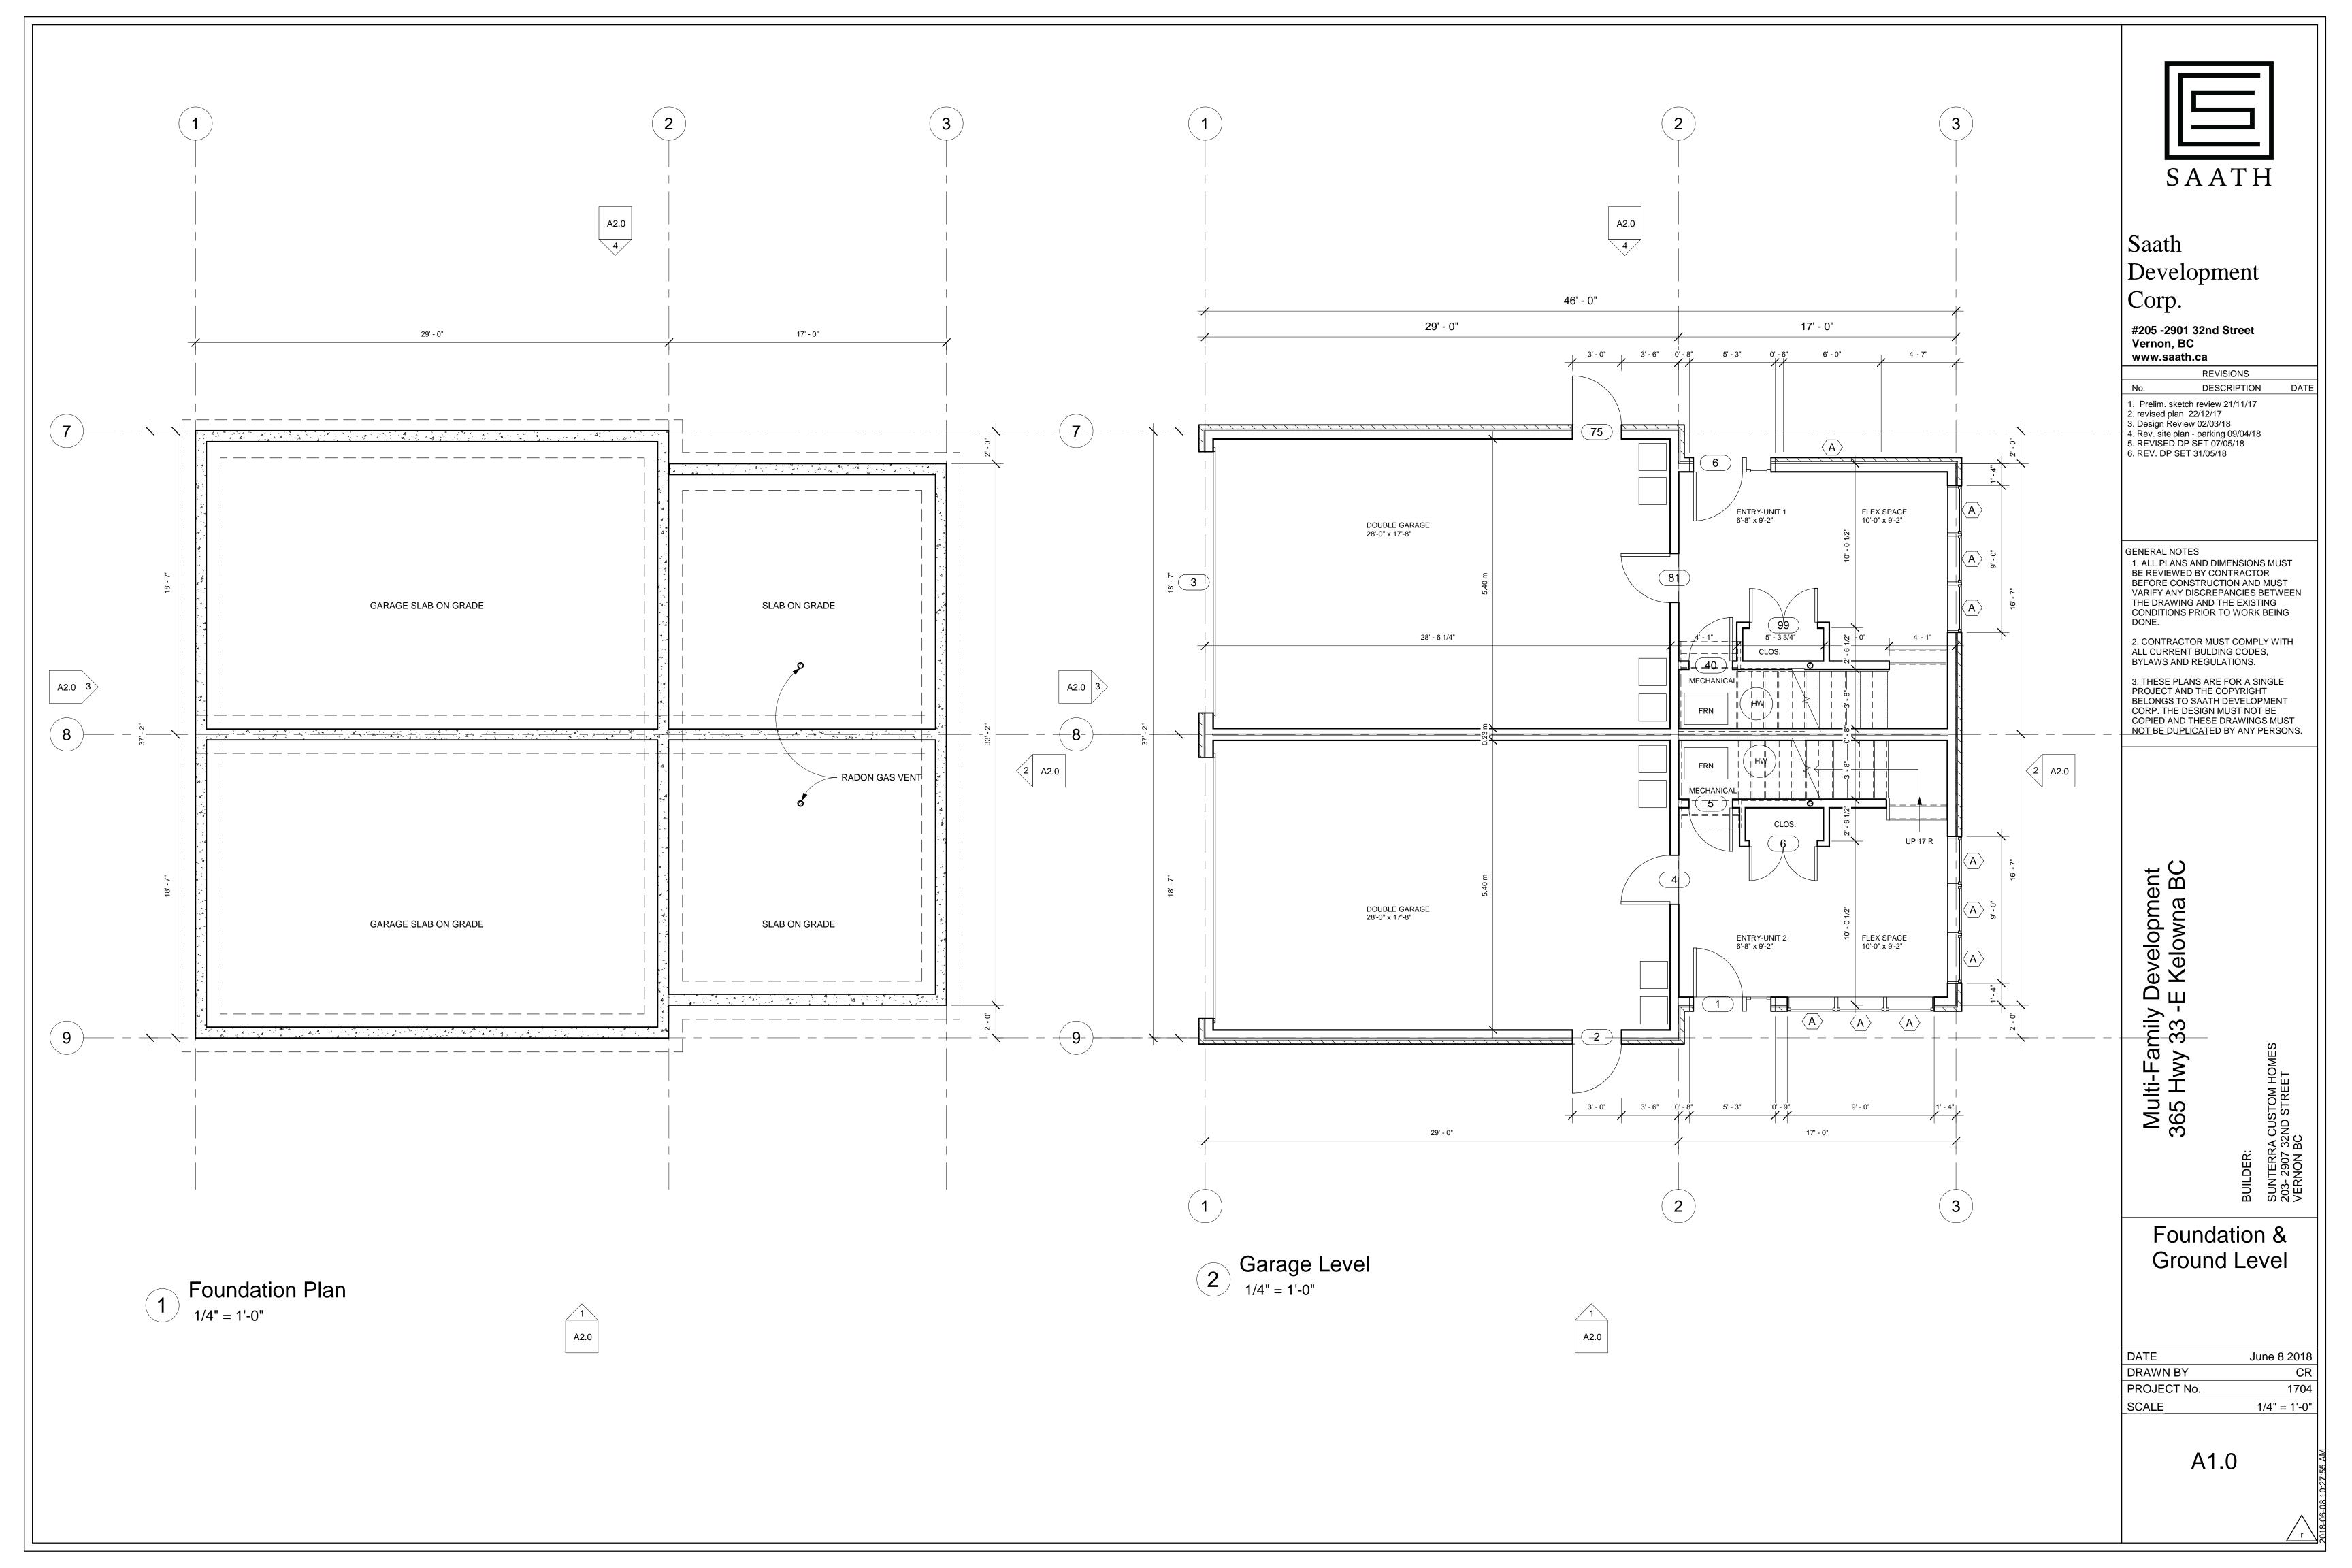

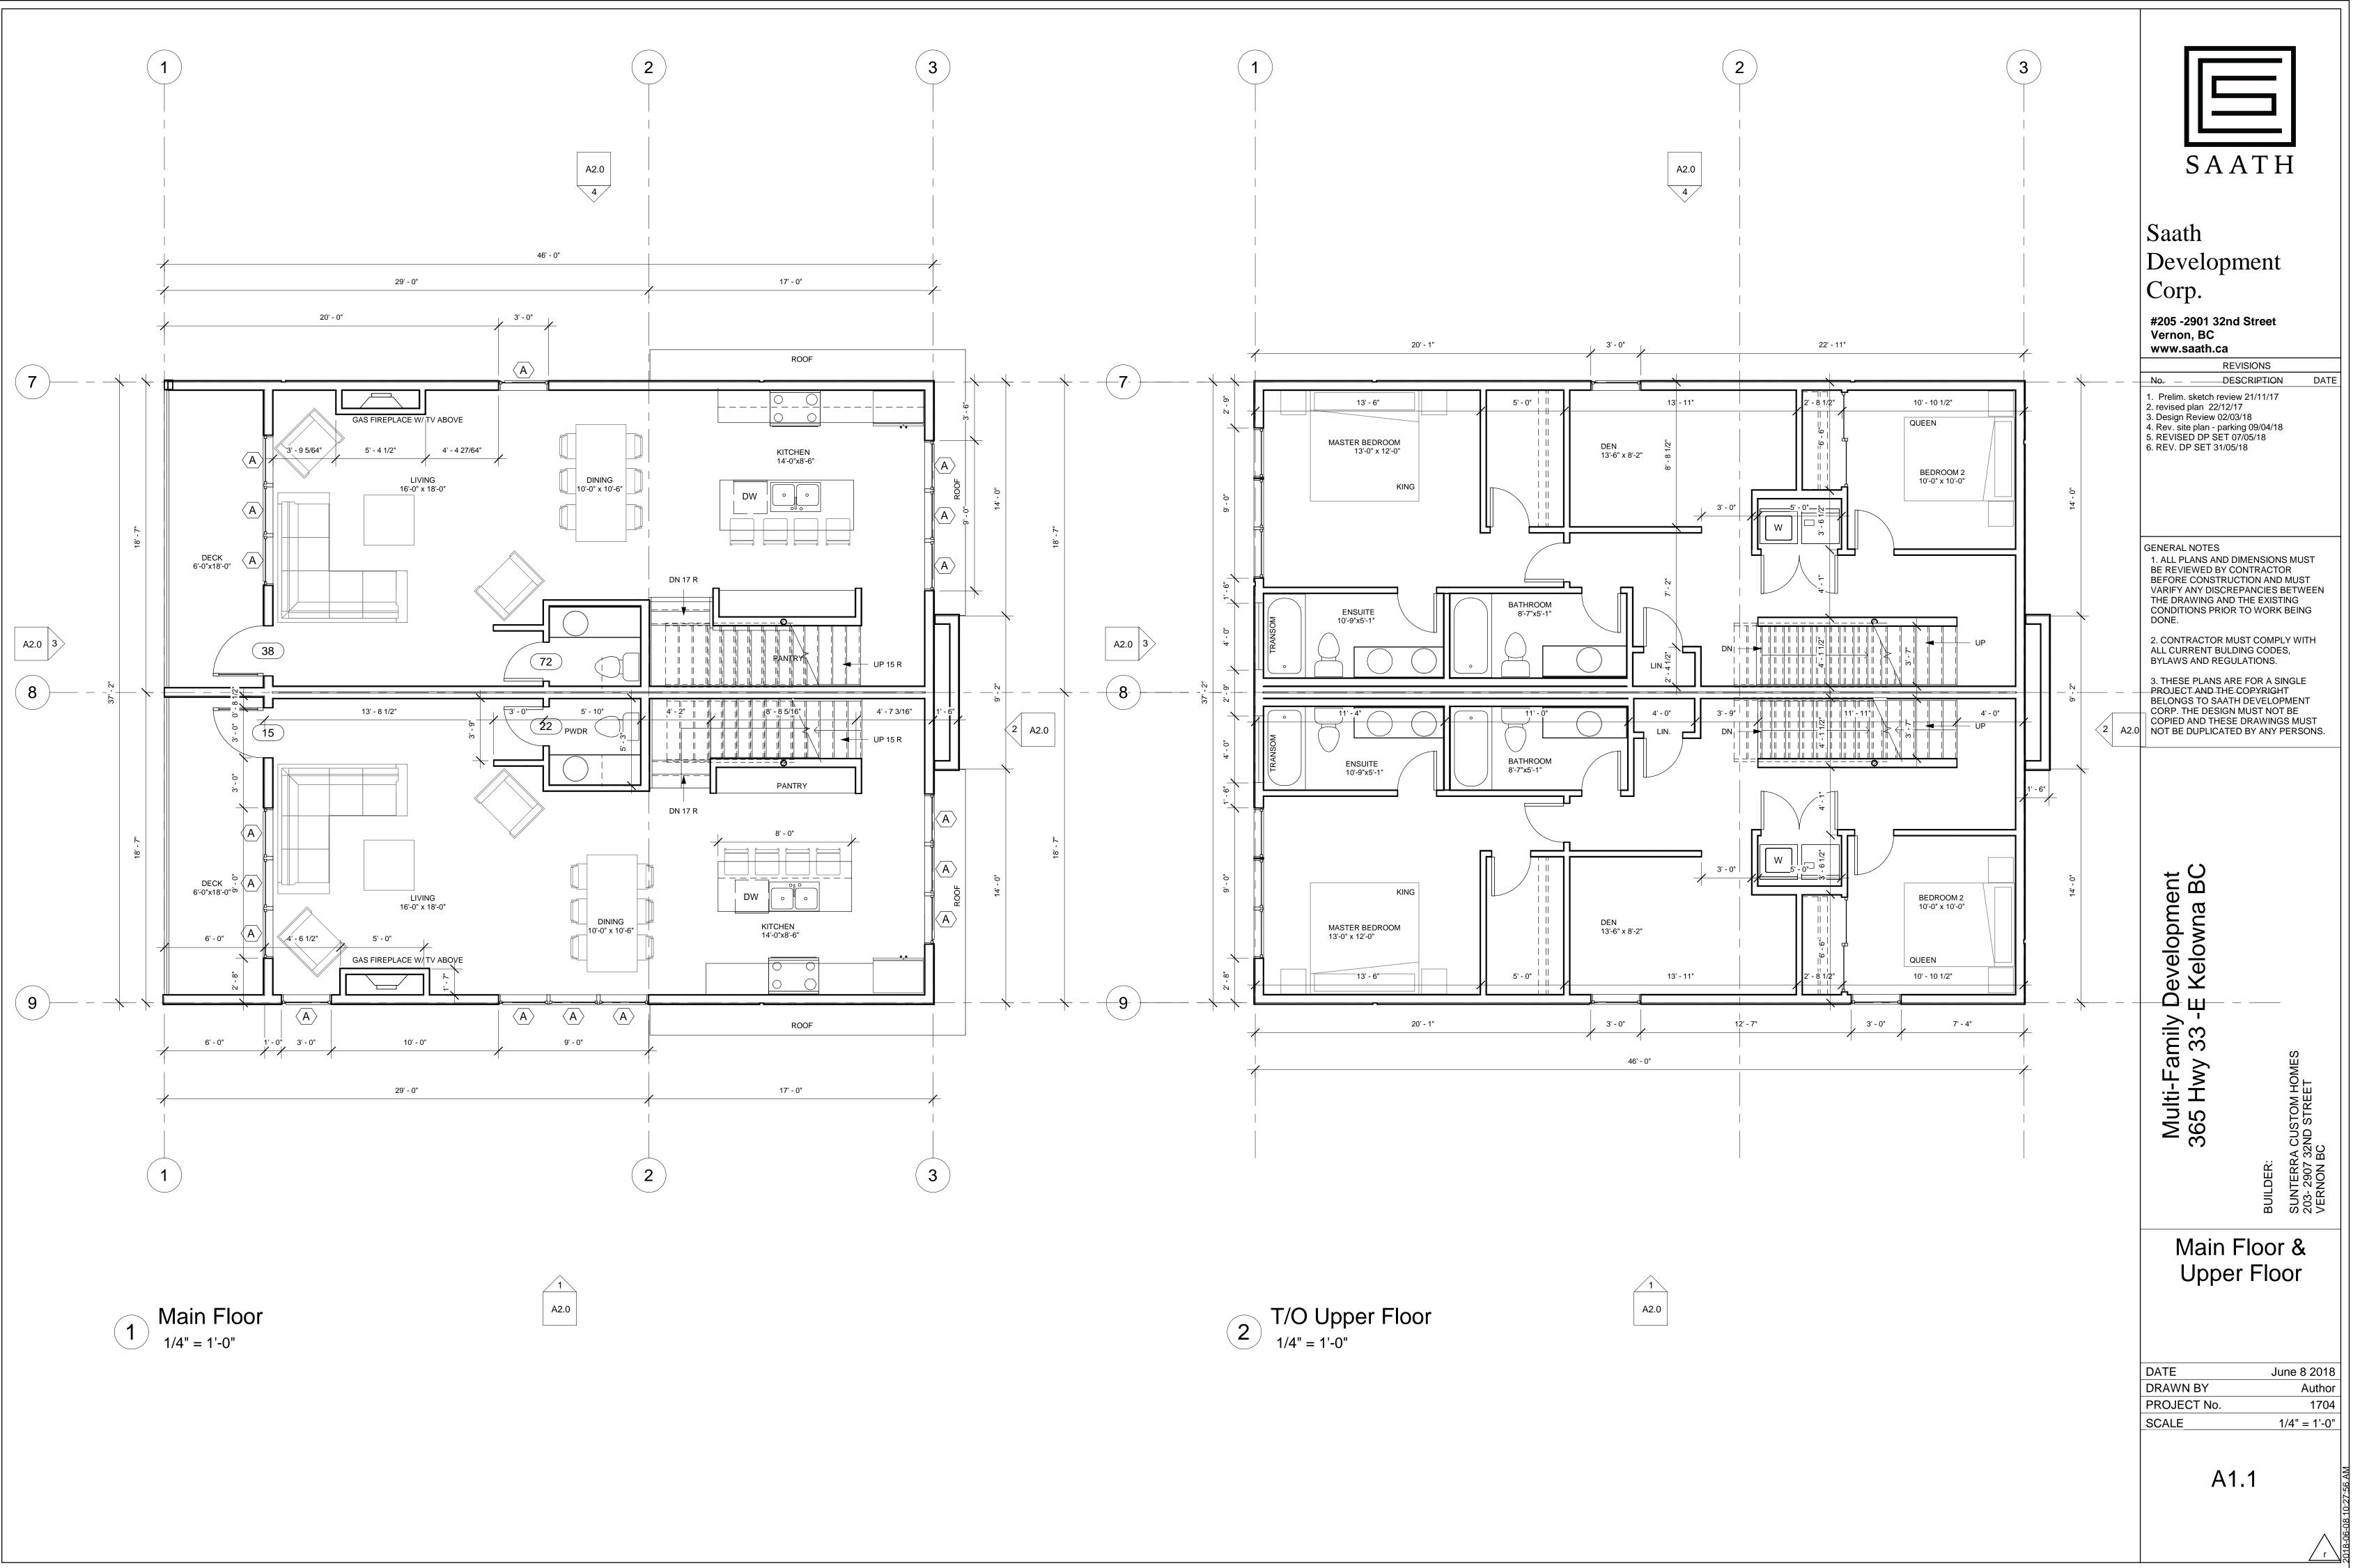

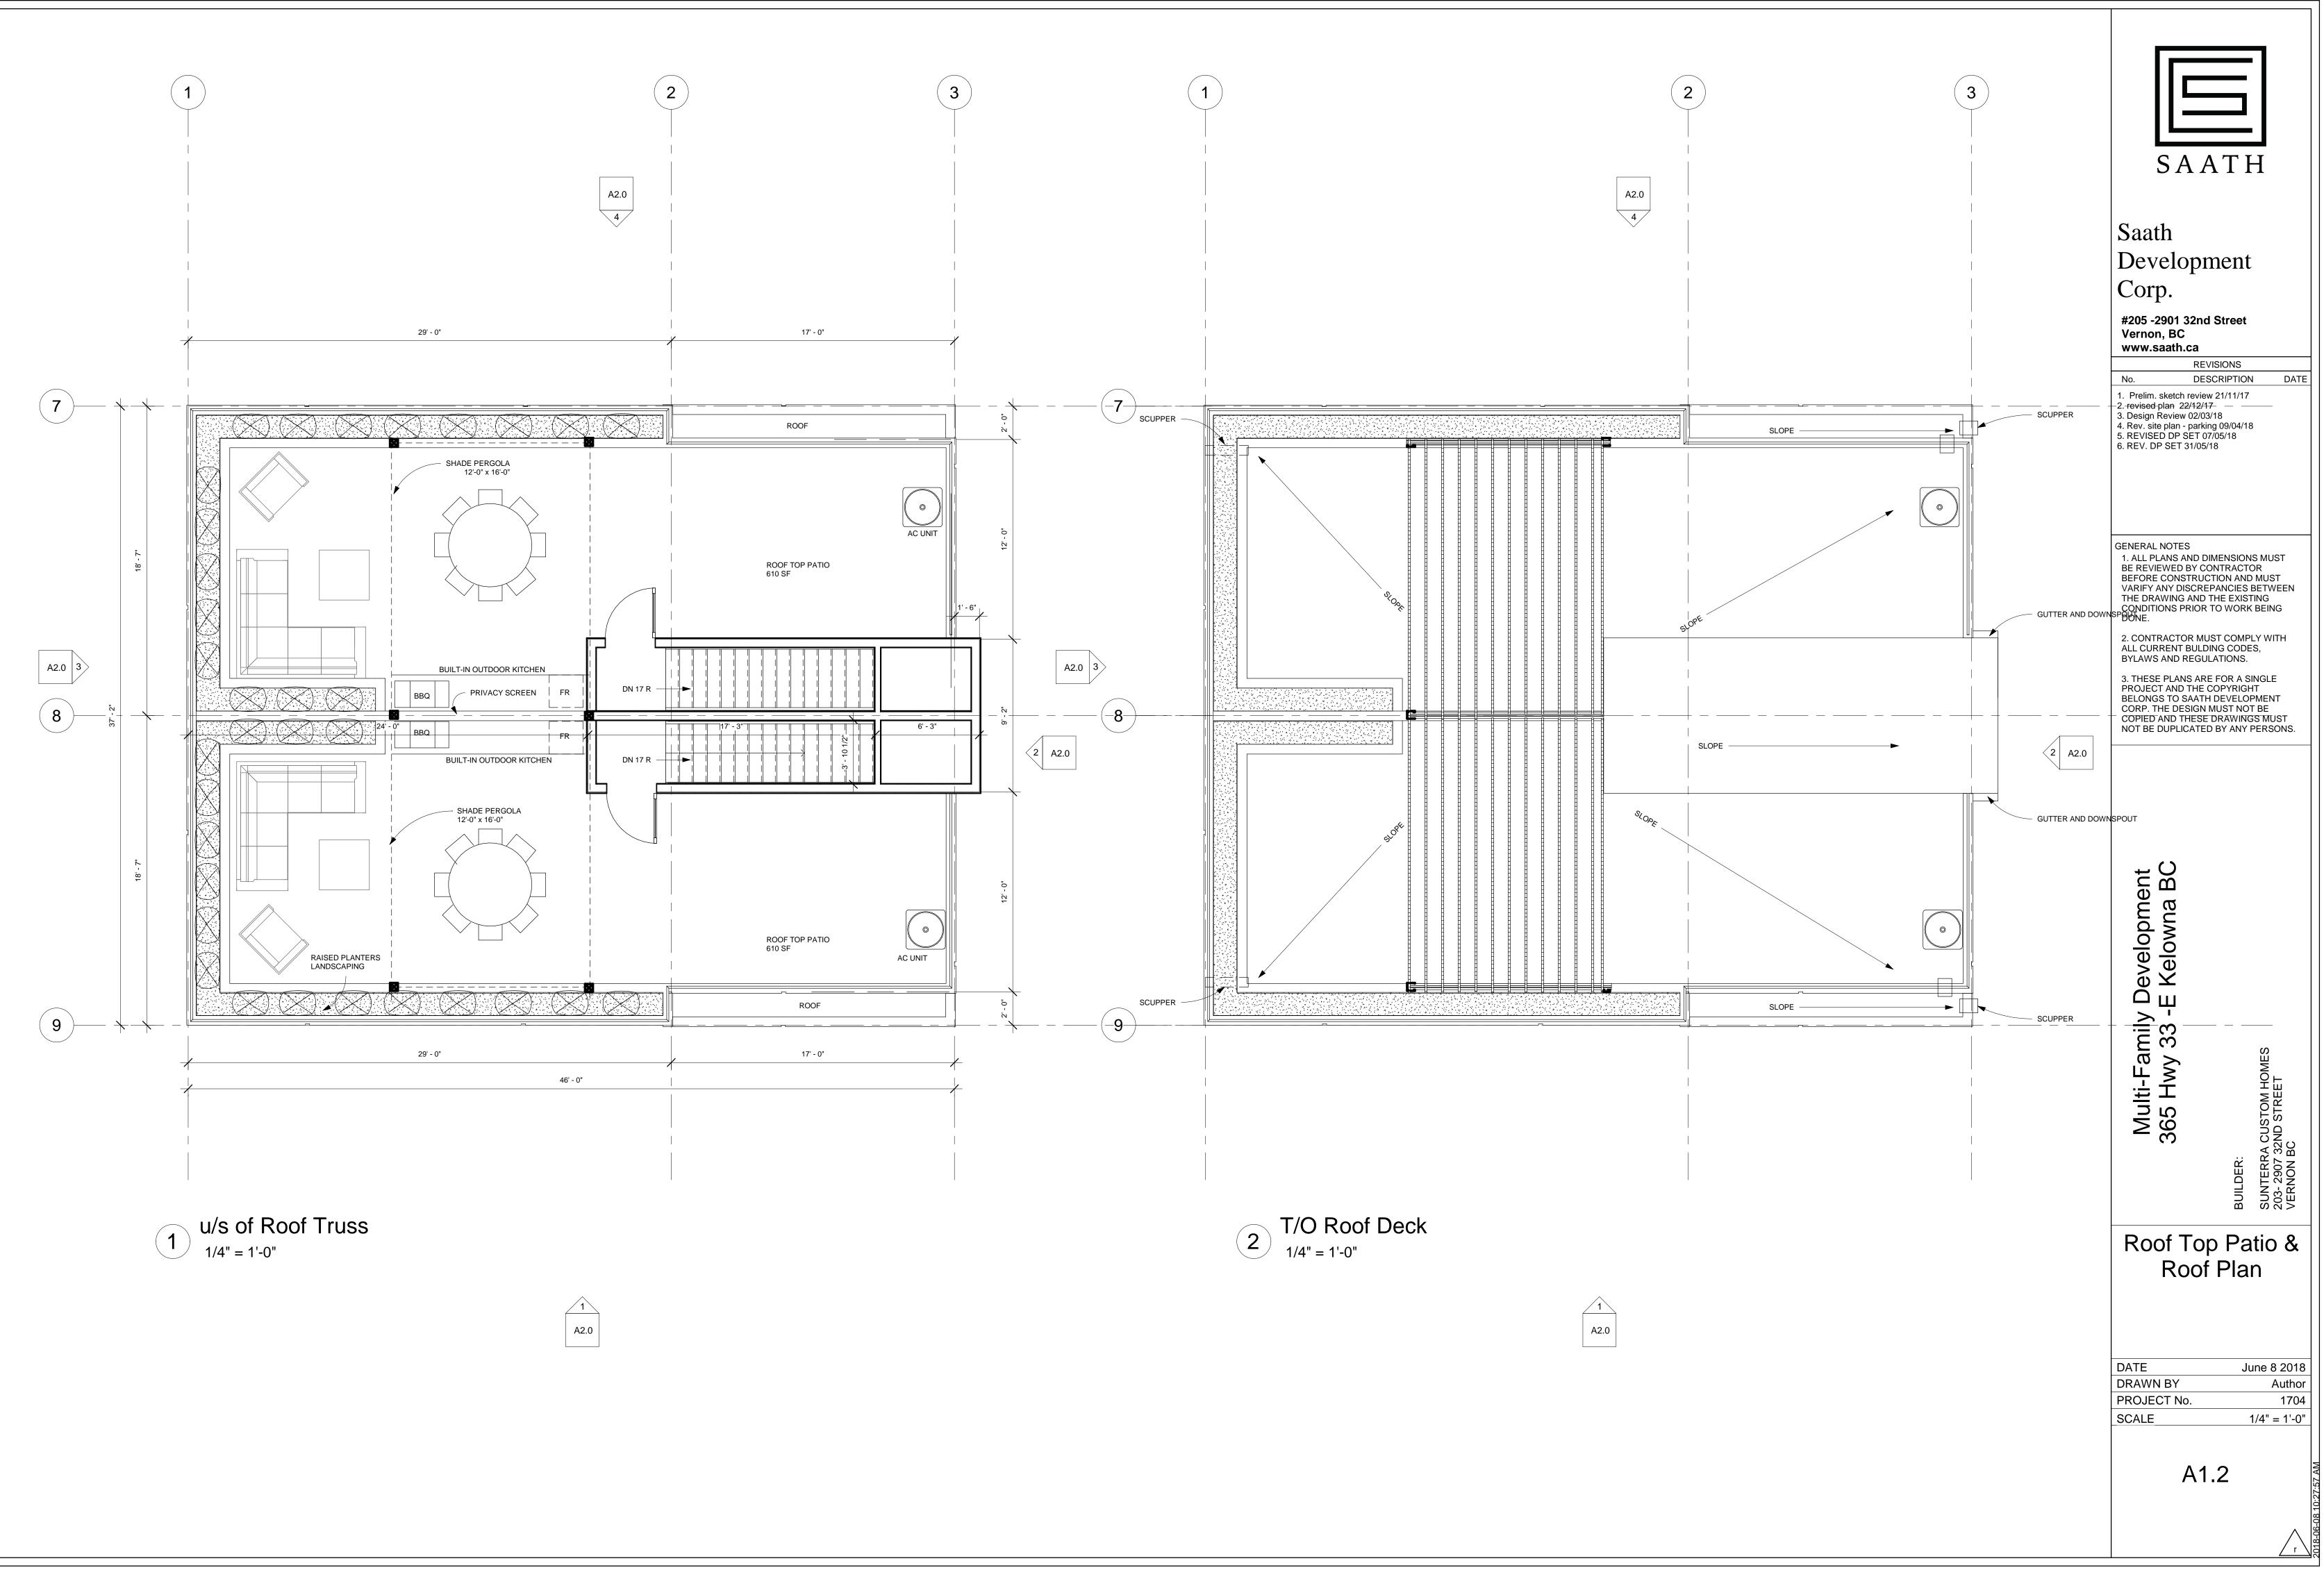



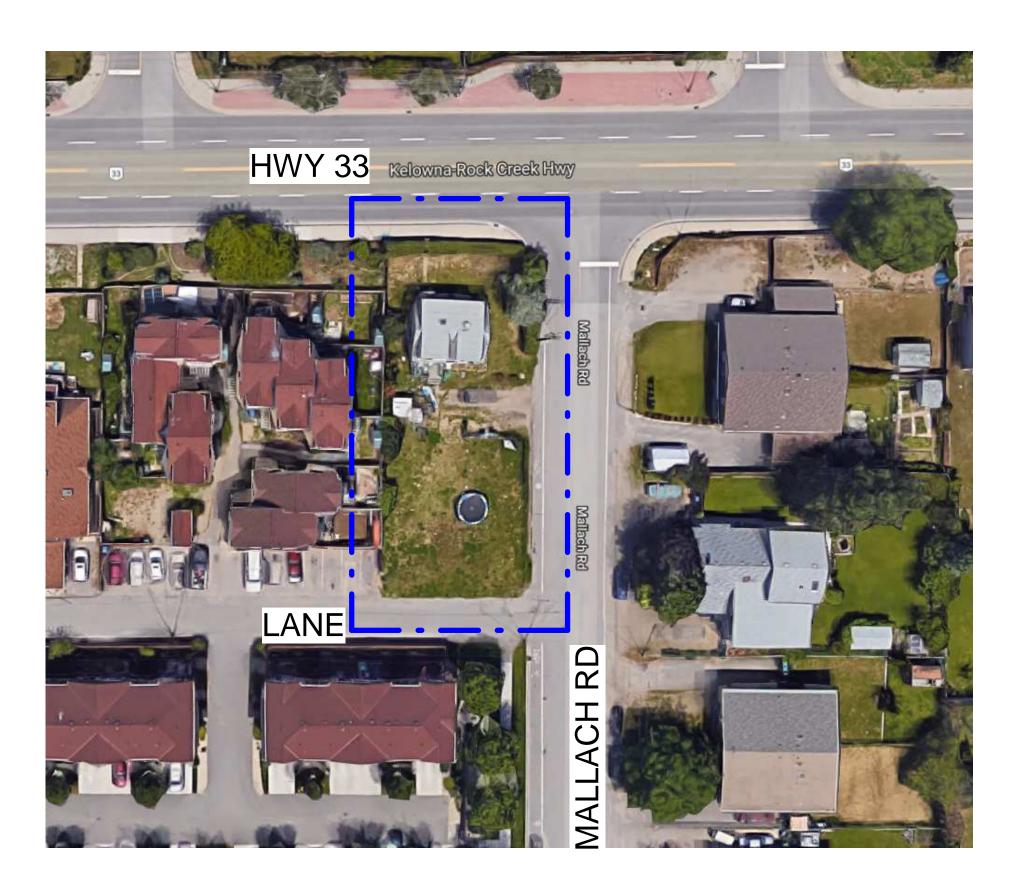




MULTI-FAMILY DEVELOPMENT


365 HWY 33 E KELOWNA, BC **BUILDING 2**

ISSUE FOR DVELOPMENT PERMIT

	SHEET INDEX
ID	NAME
A0.0	COVER PAGE
A0.1	SITE LOCATION
A0.2	STREET VIEWS
A0.3	SITE PLAN
A1.0	FOUNDATION & GROUND LEVEL PLAN
A1.1	MAIN FLOOR & UPPER FLOOR PLAN
A1.2	ROOF TOP PATIO & ROOF PLAN
A2.0	ELEVATIONS

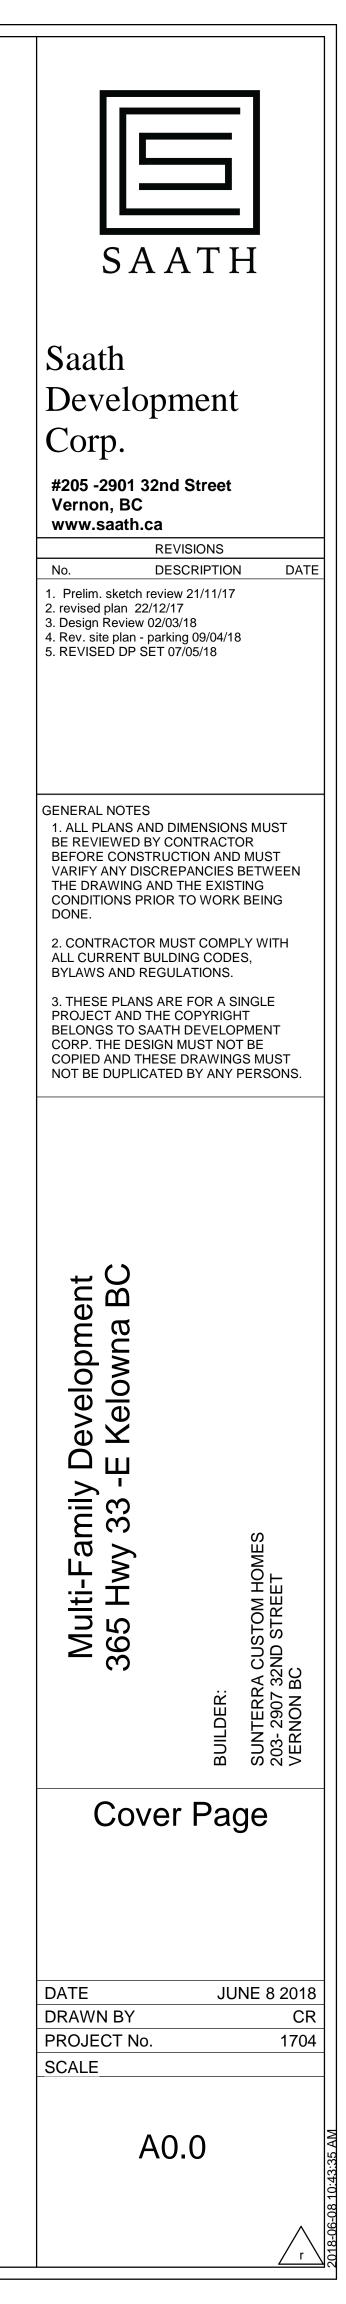



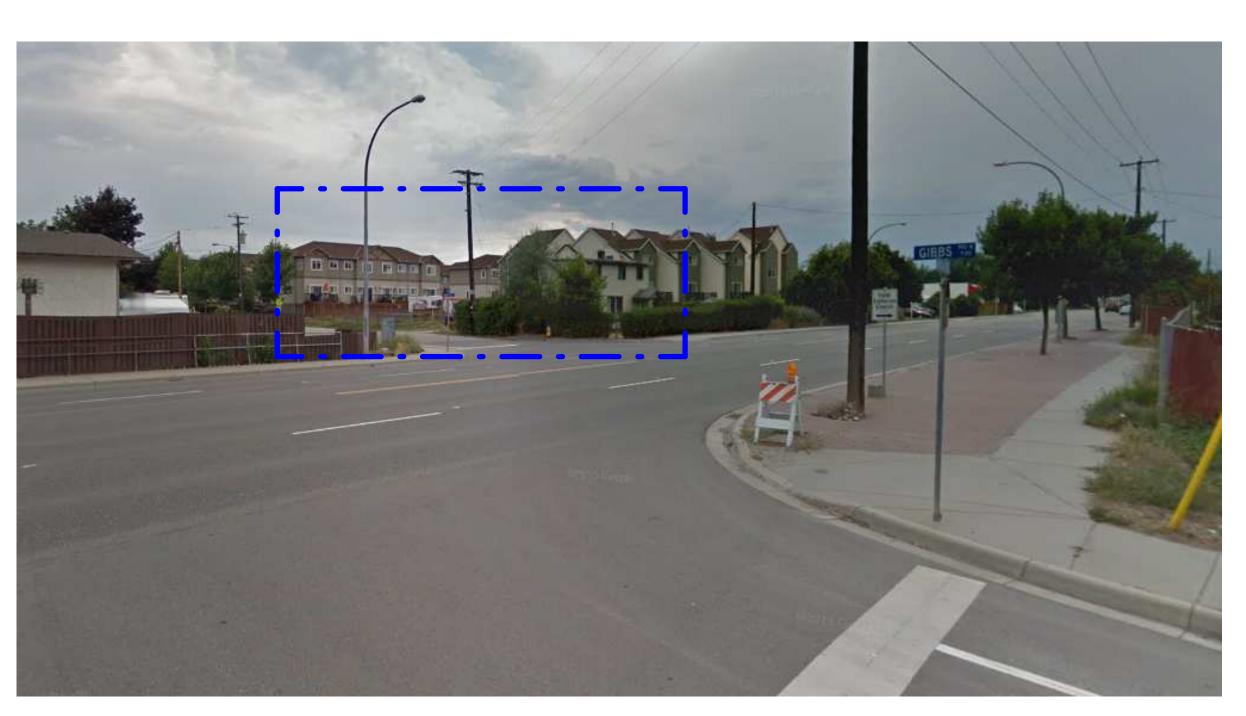


STREET VIEW LOOKING WEST

SITE LOCATION 365 HWY 33 E



STREET VIEW LOOKING EAST

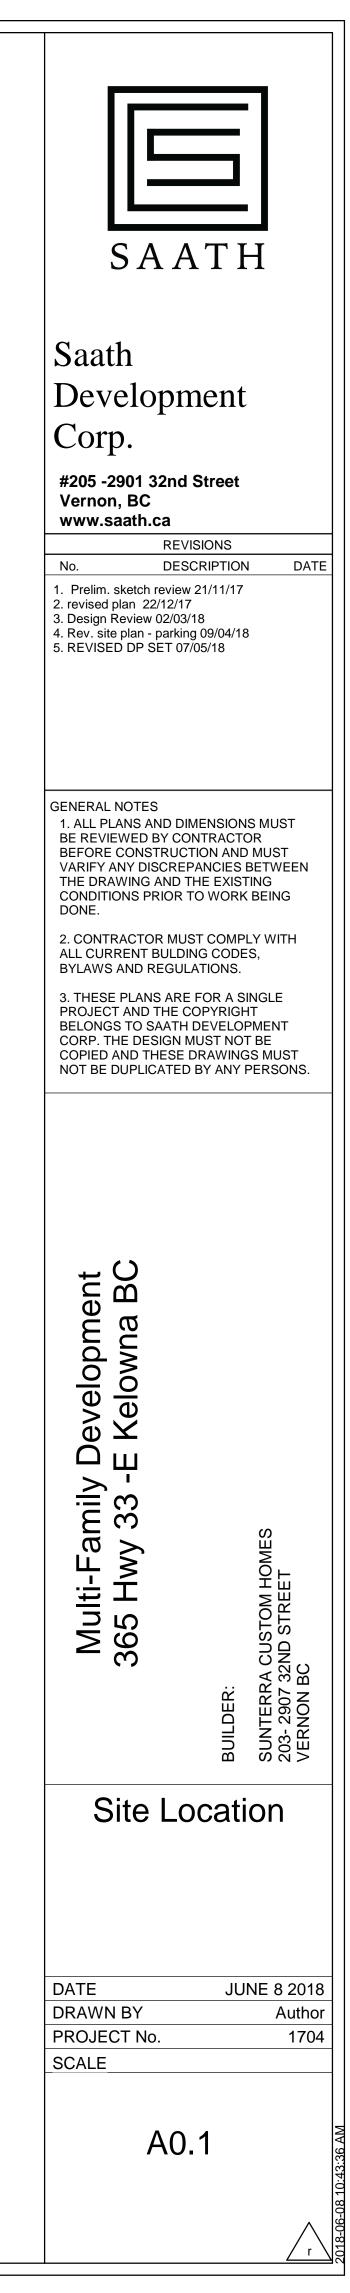

<u>STF</u> NTS

STREET VIEW MAI

STREET VIEW MALLACH RD LOOKING WEST





STREET VIEW HWY 33 CORNER



STREET VIEW MALLACH RD LOOKING NORTH



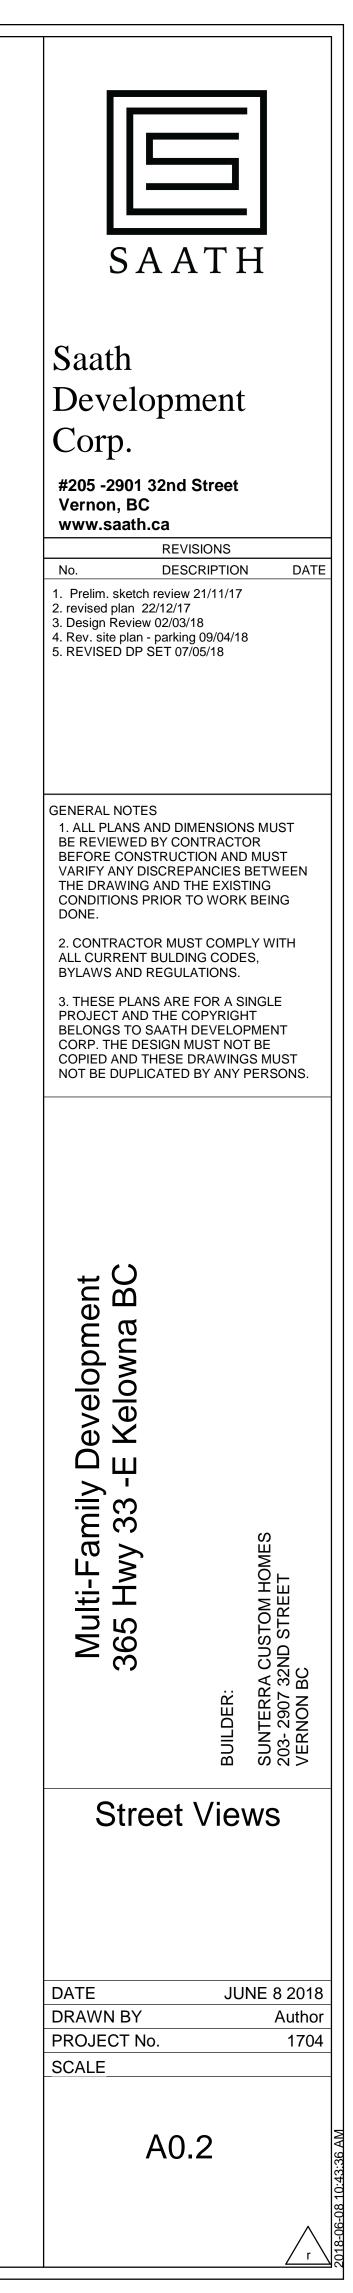

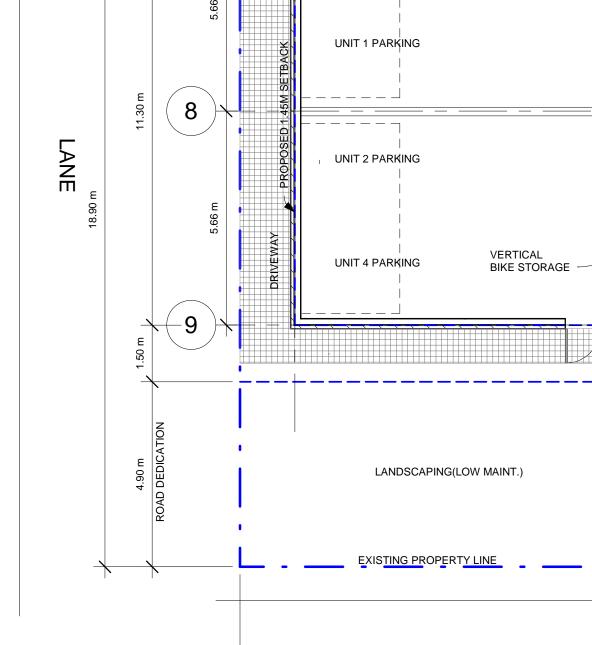

1


1.45 m

SEWER LOCATION

8.84 m


UNIT 3 PARKING


14.02 m

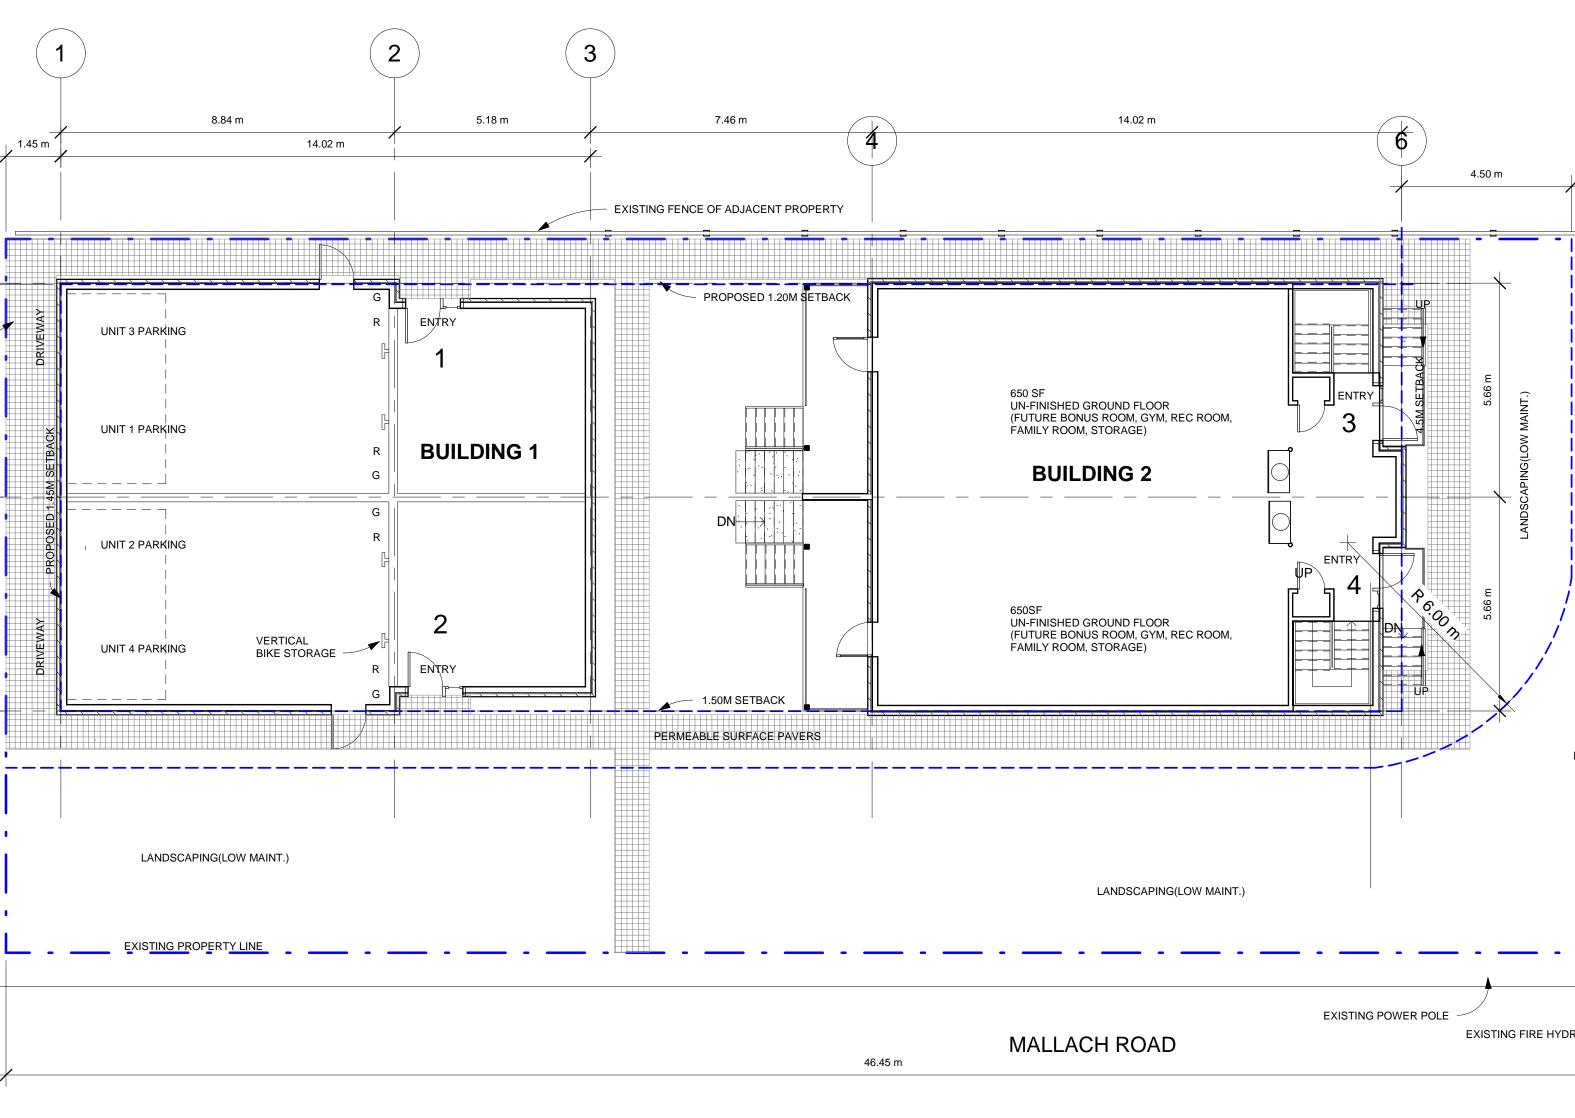


PROPERTY ADDRESS: 365 HWY 33 -E RUTLAND BC	SECTION 6.4 PROJECTIONS INTO SIDE YARDS	BC BUILDING CODE:	
LEGAL ADDRESS: KID 326886, PLAN 5012, LOT C	MAX PROJECTION 0.6M	DIV B PART 9 - TABLE 9.10	1440
LOT SIZE: 0.21 ACRES (849.83 M2)	OPEN TREAD STAIR AND LANDING FOR UNITS 5& 6 = 0.6M INTO SIDE YARD	LIMITING DISTANCE-	<u></u>
PROPOSED DEVELOPMENT: 4 UNITS TOTAL		MAX FACE OVER 100M2, 6	.0M APART = MAX ALLOV
UNITS 1,2,3,4 = 3 STOREY 2 BED + DEN, 2.5 BATH WITH ROOF TOP PATIO,	SECTION 8: PARKING AND LOADING	OPENINGS = 19% FOR EA	
BUILDING 2 - UNFINISHED GROUND FLOOR	PARKING STALL SIZE = 6.0M X 2.5M, BESIDE A COLUMN OR WALL 2.70M		
		BLDG 1	BLDG 2
ZONING BYLAW No. 8000	TABLE 8.1 PARKING SCHEDULE	(DISTANCE BETWEEN BL	DGS 7.54M)
	APARTMENT PARKING:		
ZONING: SECTION 13.9 - RM3 LOW DENSITY MULTIPLE HOUSING	1.5 SPACES PER 2 BEDROOM - 1.5 x 4 UNITS=6	WALL FACE = 124.30M2	WALL FACE = 125.14 OPENINGS = 22.11M2
(SITE LOCATED WITHIN THE URBAN CENTRE)	TOTAL REQUIRED SPACES = 6	OPENINGS = 20.06M2 = 16%	= 18%
SECTION 13.9.6 - DEVELOPMENT REGULATIONS	PROVIDED 4 STALLS, WITH CASH IN LEU FOR THE REMAINING 2 STALLS	- 1078	= 1078
MAX FLOOR AREA RATIO IS 0.75 + 0.05 FOR SCREENED PARKING	STREET PARKING ALONG MALLACH RD		
+ 0.1 FOR SITE LOCATED WITHIN THE URBAN CENTRE		3.2.2.52 - GROUP C, UP TC	3 STOREYS
= 0.90 MAX FLOOR AREA RATIO	TABLE 8.3 BICYCLE PARKING	FACING TWO STREETS - N	
BLDG 1 BLDG 2	CLASS 1 - FOR RESIDENTS 0.5 PER DWELLING	NOT SPRINKLERED, COM	BUSTABLE OR NON CUM
GROUND LEVEL - 211SF GROUND LEVEL - 1430 SF	= 0.5 X 4 = 2 STALLS REQUIRED	CONSTRUCTION	
GROUND LEVEL - 211SFGROUND LEVEL - 1430 SFMAIN LEVEL - 1418 SFMAIN LEVEL - 1388 SFUPPER LEVEL - 1218 SFUPPER LEVEL - 1418 SF	PROVIDED 1 PER UNIT, VERTICAL RACK INSIDE GARAGE		
UPPER LEVEL - 1218 SF UPPER LEVEL - 1418 SF	TOTAL BIKE PARKING PROVIDED = 4 STALLS	PROPOSED BUILDING FO	OTPRINT FOR BOTH BUI
ROOF TOP PATIO - 610 SF ROOF TOP PATIO - 586 SF			<u></u>
*NOT INCLUDING PARKING, STAIRWELLS, AND MECH RMS	SECTION 13.9.7	3.3.4.2 (1) FIRE SEPARATIO	
PROPOSED = 8279 SF (769.14M2) / 849.83M2 = 0.90	OPEN SPACE REQUIRED PER UNIT -	FIRE SEPARATION BETWE	EEN RESIDENTIAL UNITS
	25M2 PER 2 OR MORE BEDROOMS		
<u>SITE COVERAGE</u> MAX BUILDING SITE COVERAGE: 40%, W/ PRIVATE OPEN SPACE PER	TOTAL REQUIRED OPEN SPACE= 100 M2		
UNIT MAX ALLOWED 50%			
	PROVIDED: 2 BEDROOM UNITS - ROOF TOP PATIO		
BUILDING FOOTPRINT:	610SF X 2 PLUS 586SF X 2= 2392 SF 222 M2		
BLDG 1 = 155.07M2			
BLDG 2 = 157.46M2	TOTAL PROVIDED USABLE OPEN SPACE = 222 M2		
312.53M2 / 849.83M2 = 37%			
	GROUND LEVEL LANDSCAPEING AREA = 420.30 M2		
MAX SITE COVERAGE FOR DRIVEWAYS AND PARKING = 10%,			
MAY BE INCREASED TO 15% WITH PERMEBLE SURFACES			
PERMEABLE SIDEWALKS =117 M2	SECTION 7: LANDSCAPING AND SCREENING		
117 M2 / 849.83M2= 14%	7.3 REFUSE AND RECYCLE BINS		
	(NOTED ON THE DEVELOPEMENT PERMIT CHECK LIST - 5 OR MORE RESIDENTIAL UNITS		
TOTAL COMBINED SITE COVERAGE (50% + 15%= 65%) = PROVIDED 51%	REQUIRES A COMMERCIAL BIN)		
	PROVIDED - 4 STANDARD RESIDENTIAL GARBAGE AND RECYCLE BINS,		
MAX HEIGHT: LESSER OF 1M OR 3 STOREYS	ONE EACH PER UNIT LOCATED IN GARAGE ROLL TO CURB (LANE) DAY OF PICK UP		
PROPOSED BUILDING HEIGHT = TOP TO ROOF DECK 9.96M			
PLUS 2.65M ADDITIONAL HEIGHT TO TOP OF ENCLOSED STAIR ACCESS ROOF			
(STAIR ACCESS HEIGHT NOT INCLUDED IN CALC. PER SECTION 6.6, SENTANCE 6.6.1)			
ROAD DEDICATIONS:			
HWY 33 - 5M, MALLACH RD - 4.9M, WITH 6M RADIUS CORNER ROUNDING			
SETBACKS:			
FRONT: REQUIRED 4.5M (HWY 33), PROVIDED 4.5M			
SIDE FROM LANE: REQUIRED 3.0M, PROVIDED 1.45M -VARIANCE REQUIRED			
SIDE YARD: REQUIRED 1.5M (MALLACH RD) -URBAN CENTER, PROVIDED 1.5M			
SIDE YARD: REQUIRED 4.5M, PROPOSED 1.20M -VARIANCE REQUIRED			


5.00 m ROAD DEDICATION	*			
		HWY 33 -E RUTLAND	Saath Development Corp. #205 -2901 32nd Street Vernon, BC www.saath.ca REVISIONS No. DESCRIPTION 1. Prelim. sketch review 21/11/17 2. revised plan 22/12/17 3. Design Review 02/03/18 4. Rev. site plan - parking 09/04/18 5. REVISED DP SET 07/05/18	N DATE
LANDSCAPING(LOW MAINT.)		EXISTING SIDEWALK	GENERAL NOTES 1. ALL PLANS AND DIMENSION BE REVIEWED BY CONTRACTOR BEFORE CONSTRUCTION AND VARIFY ANY DISCREPANCIES THE DRAWING AND THE EXIST CONDITIONS PRIOR TO WORK DONE. 2. CONTRACTOR MUST COMP ALL CURRENT BULDING CODE BYLAWS AND REGULATIONS. 3. THESE PLANS ARE FOR A S PROJECT AND THE COPYRIGH BELONGS TO SAATH DEVELO CORP. THE DESIGN MUST NOT COPIED AND THESE DRAWING NOT BE DUPLICATED BY ANY	OR D MUST BETWEEN TING K BEING PLY WITH ES, SINGLE HT PMENT T BE GS MUST
LOWABLE 5.14M2 11M2 750M2 CUMBUSTABLE BUILDINGS = 312.53M2 NITS 1 HR			Multi-Family Development 365 Hwy 33 -E Kelowna BC BULDER:	SUNTERRA CUSTOM HOMES 203- 2907 32ND STREET VERNON BC
			Site plar	 ו
			DATE JU DRAWN BY PROJECT No. SCALE A0.3	INE 8 2018 CR 1704 1 : 100
			AU.3	1018-06-08 10:43:37 AM

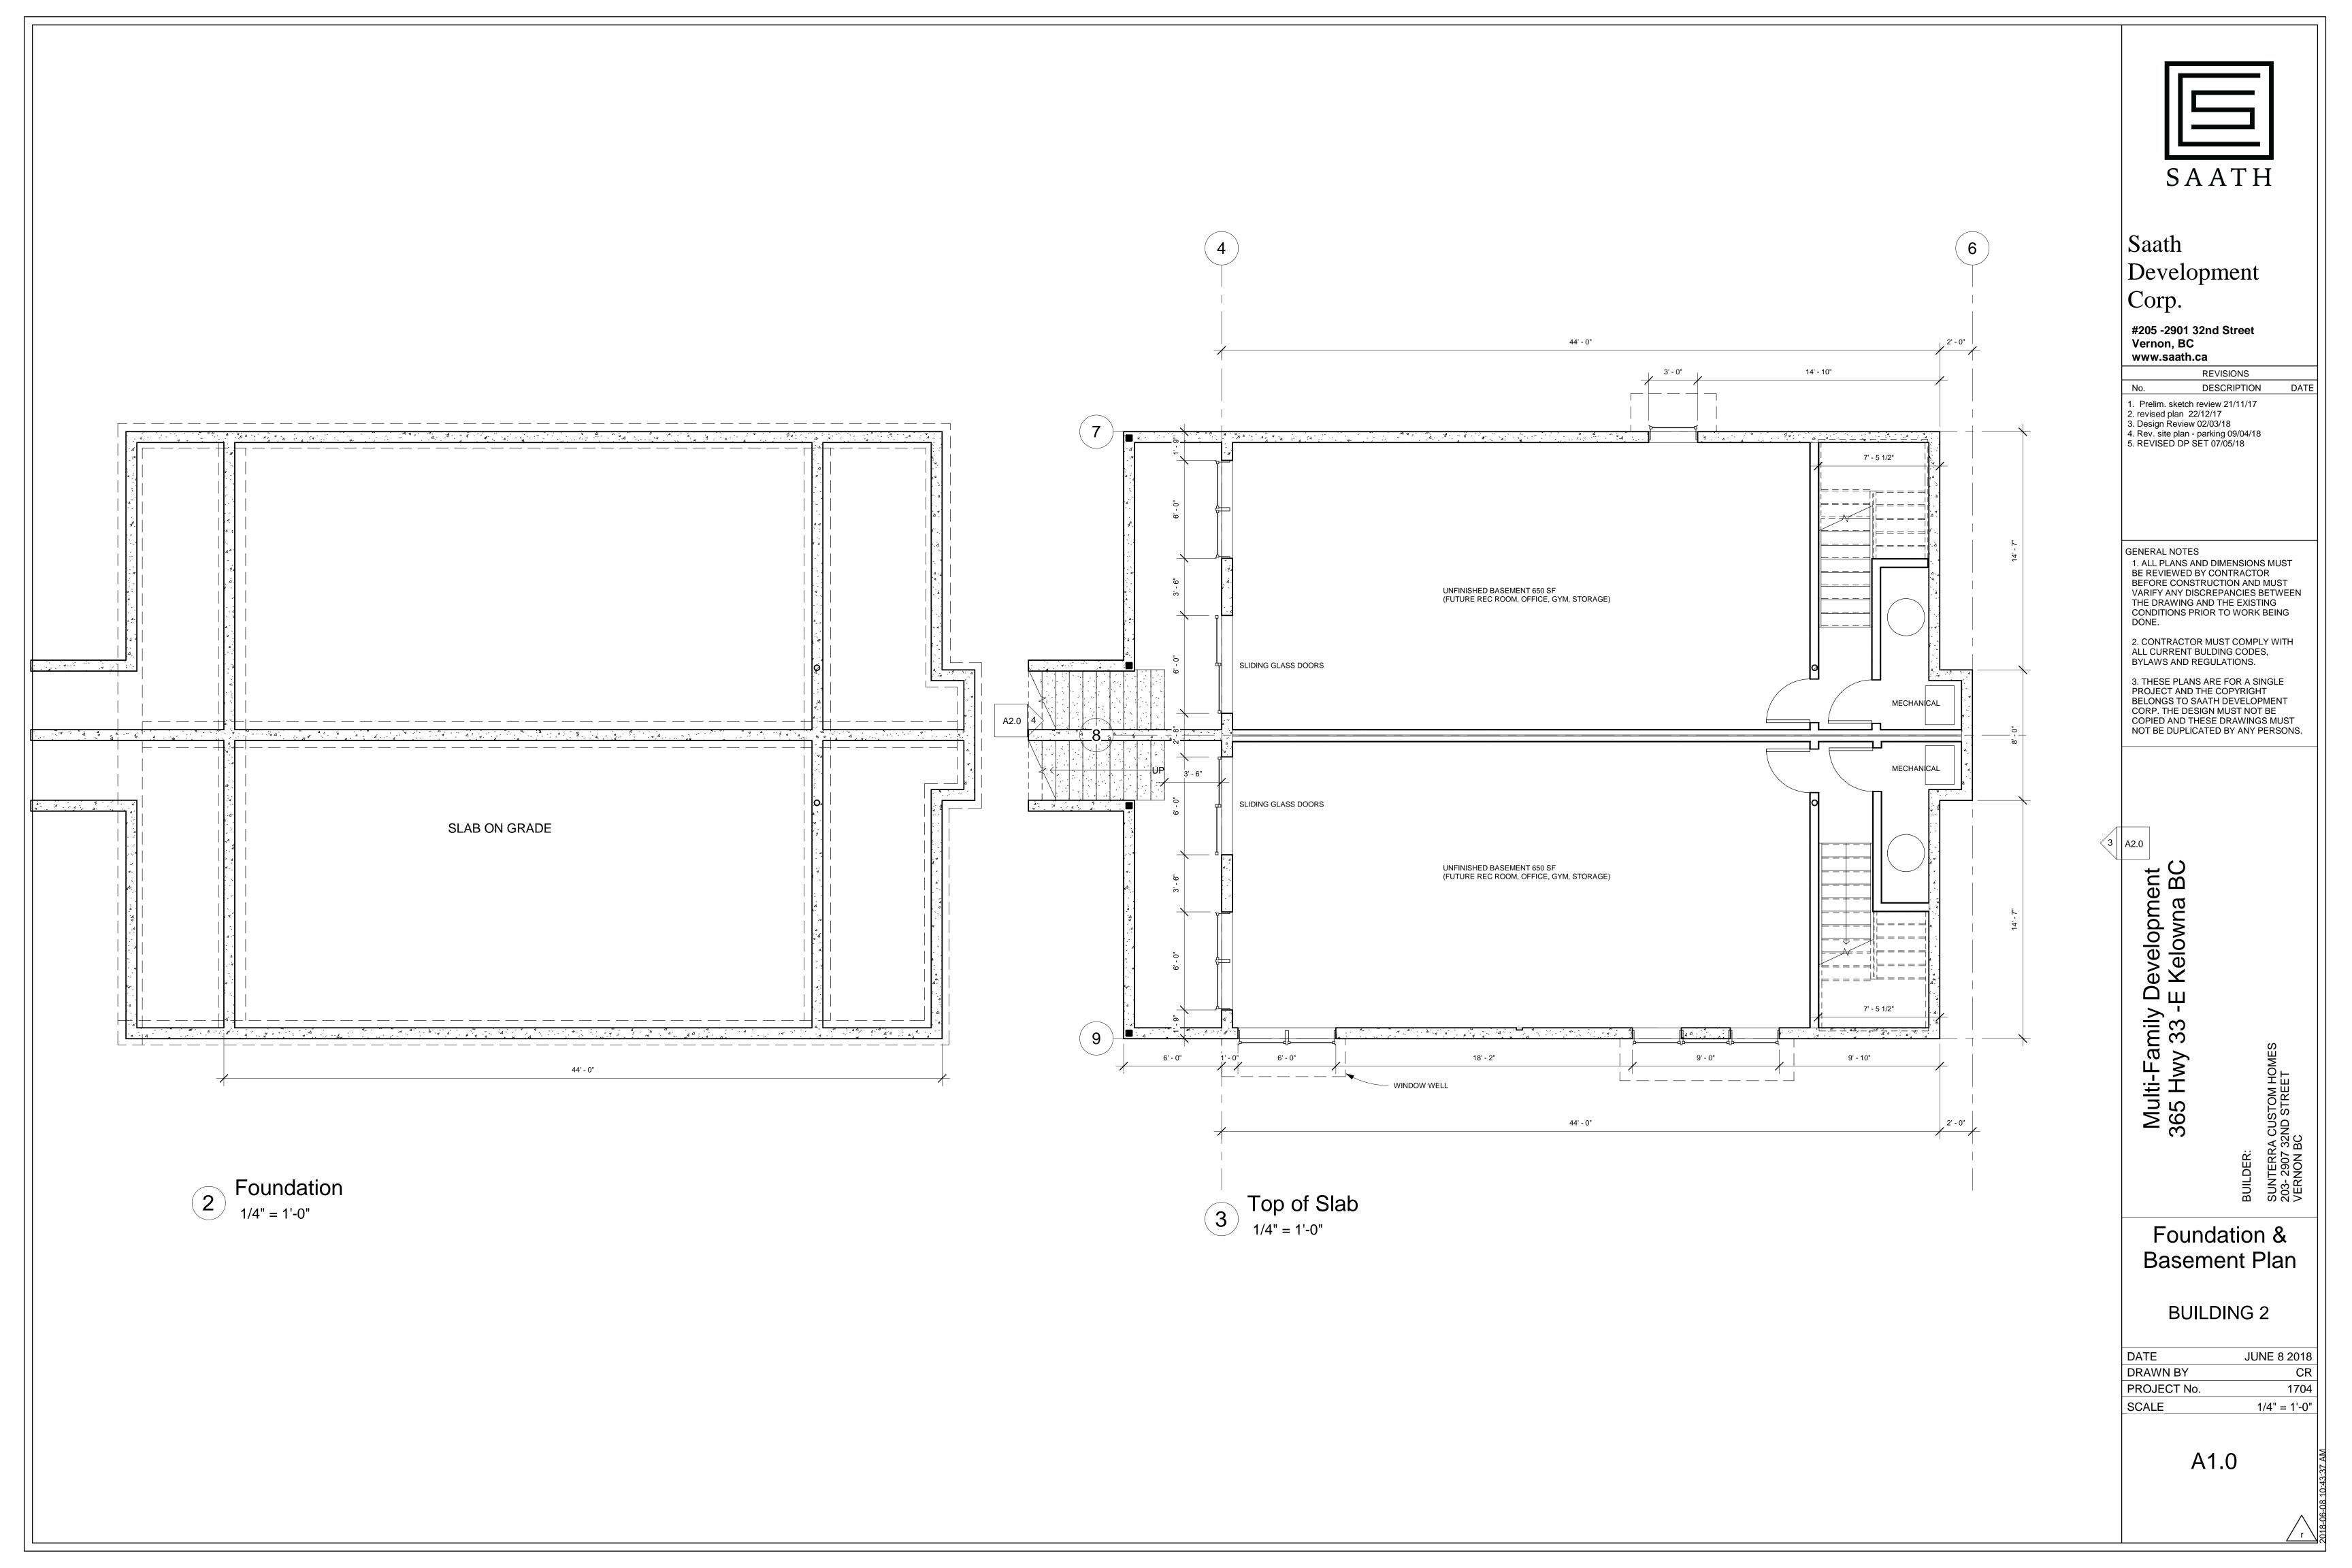

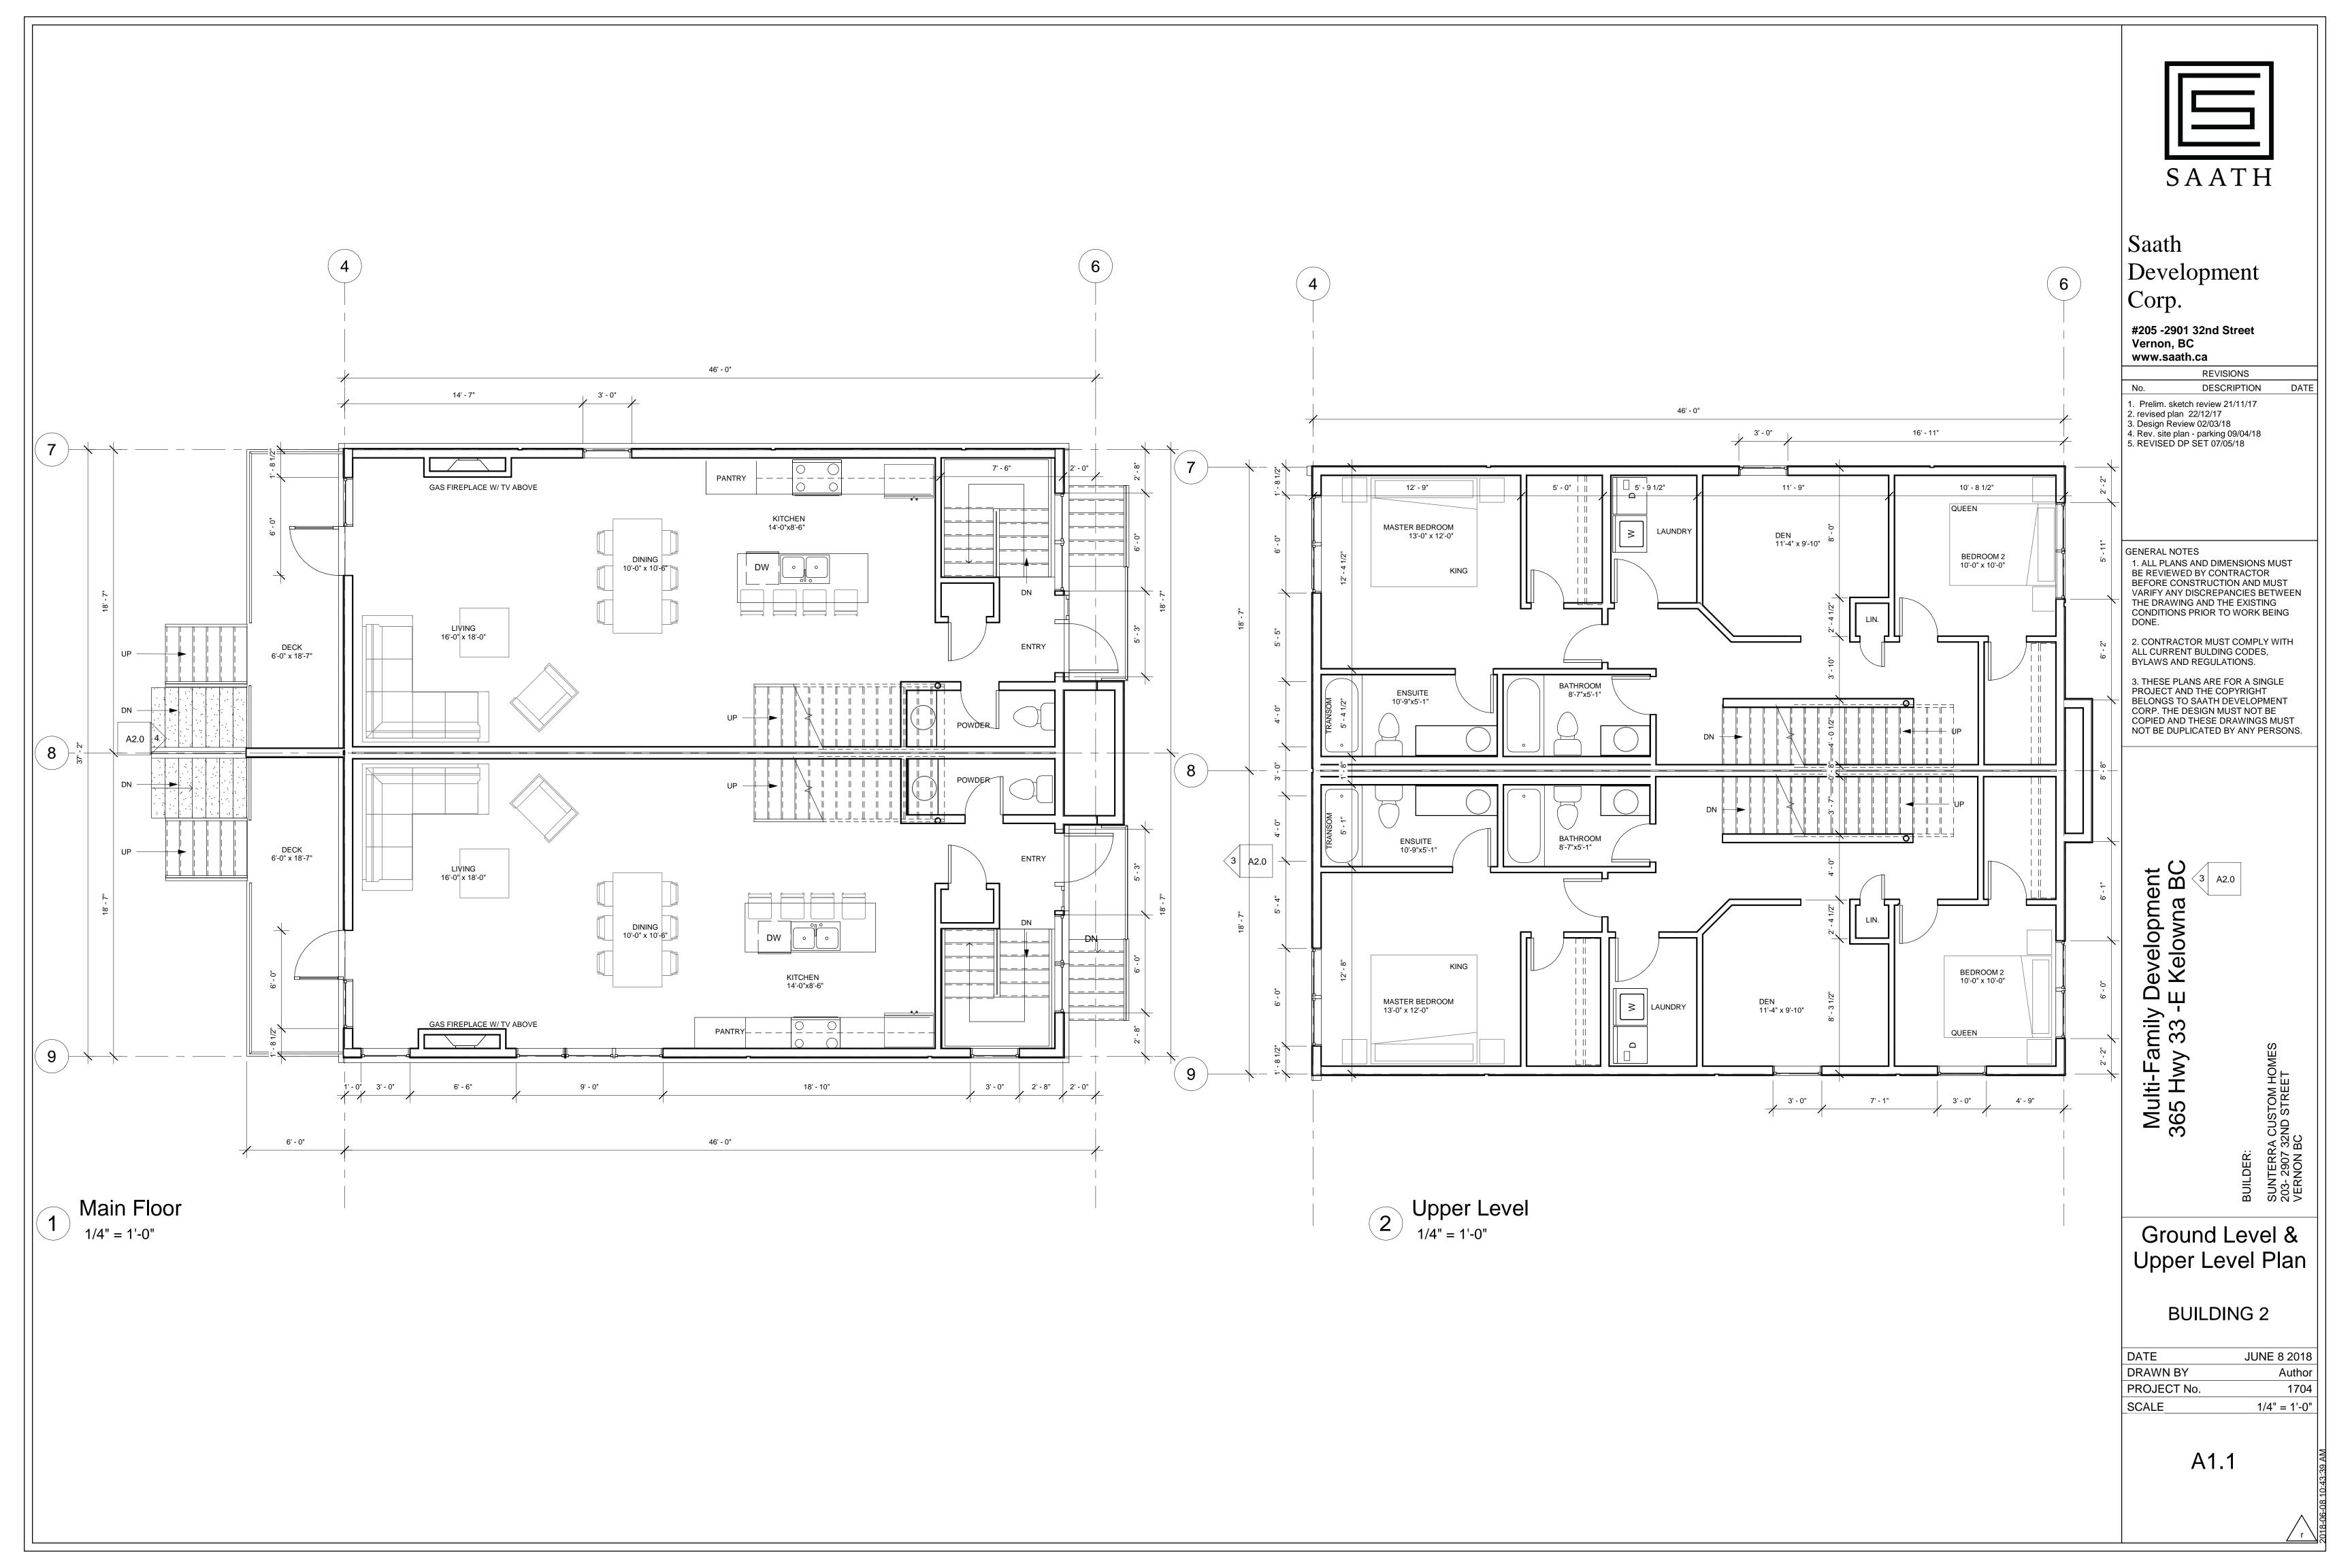

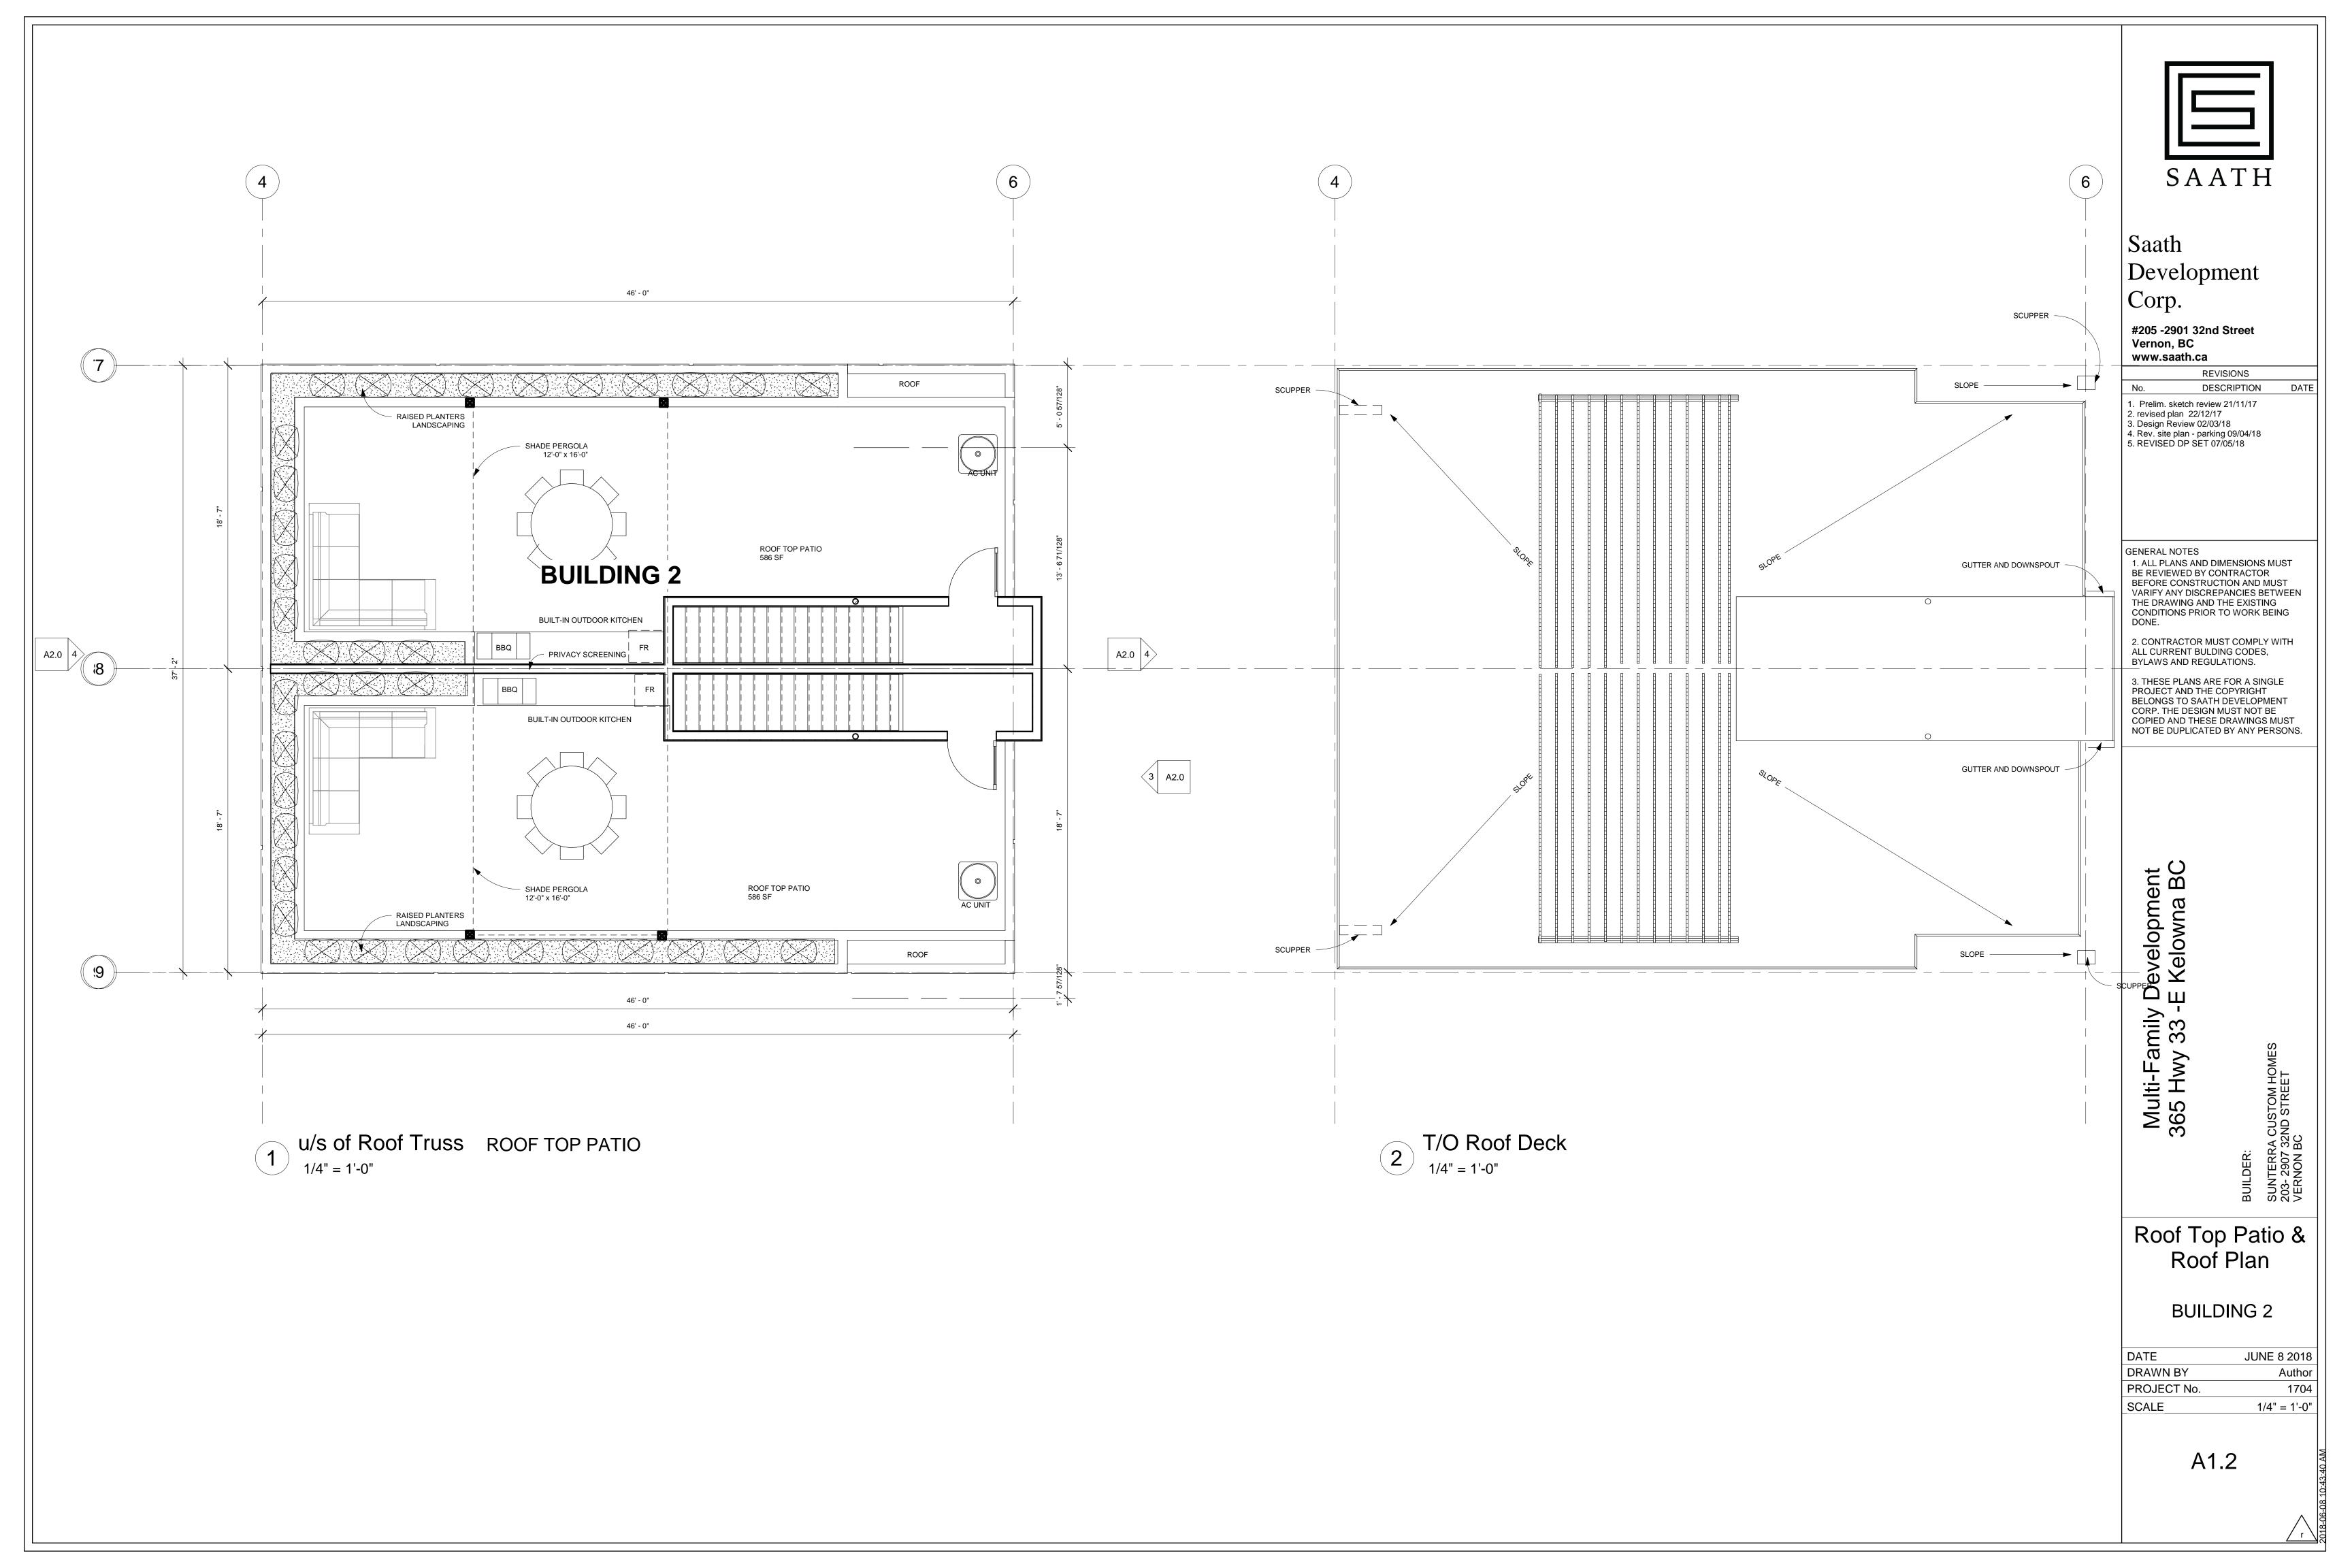



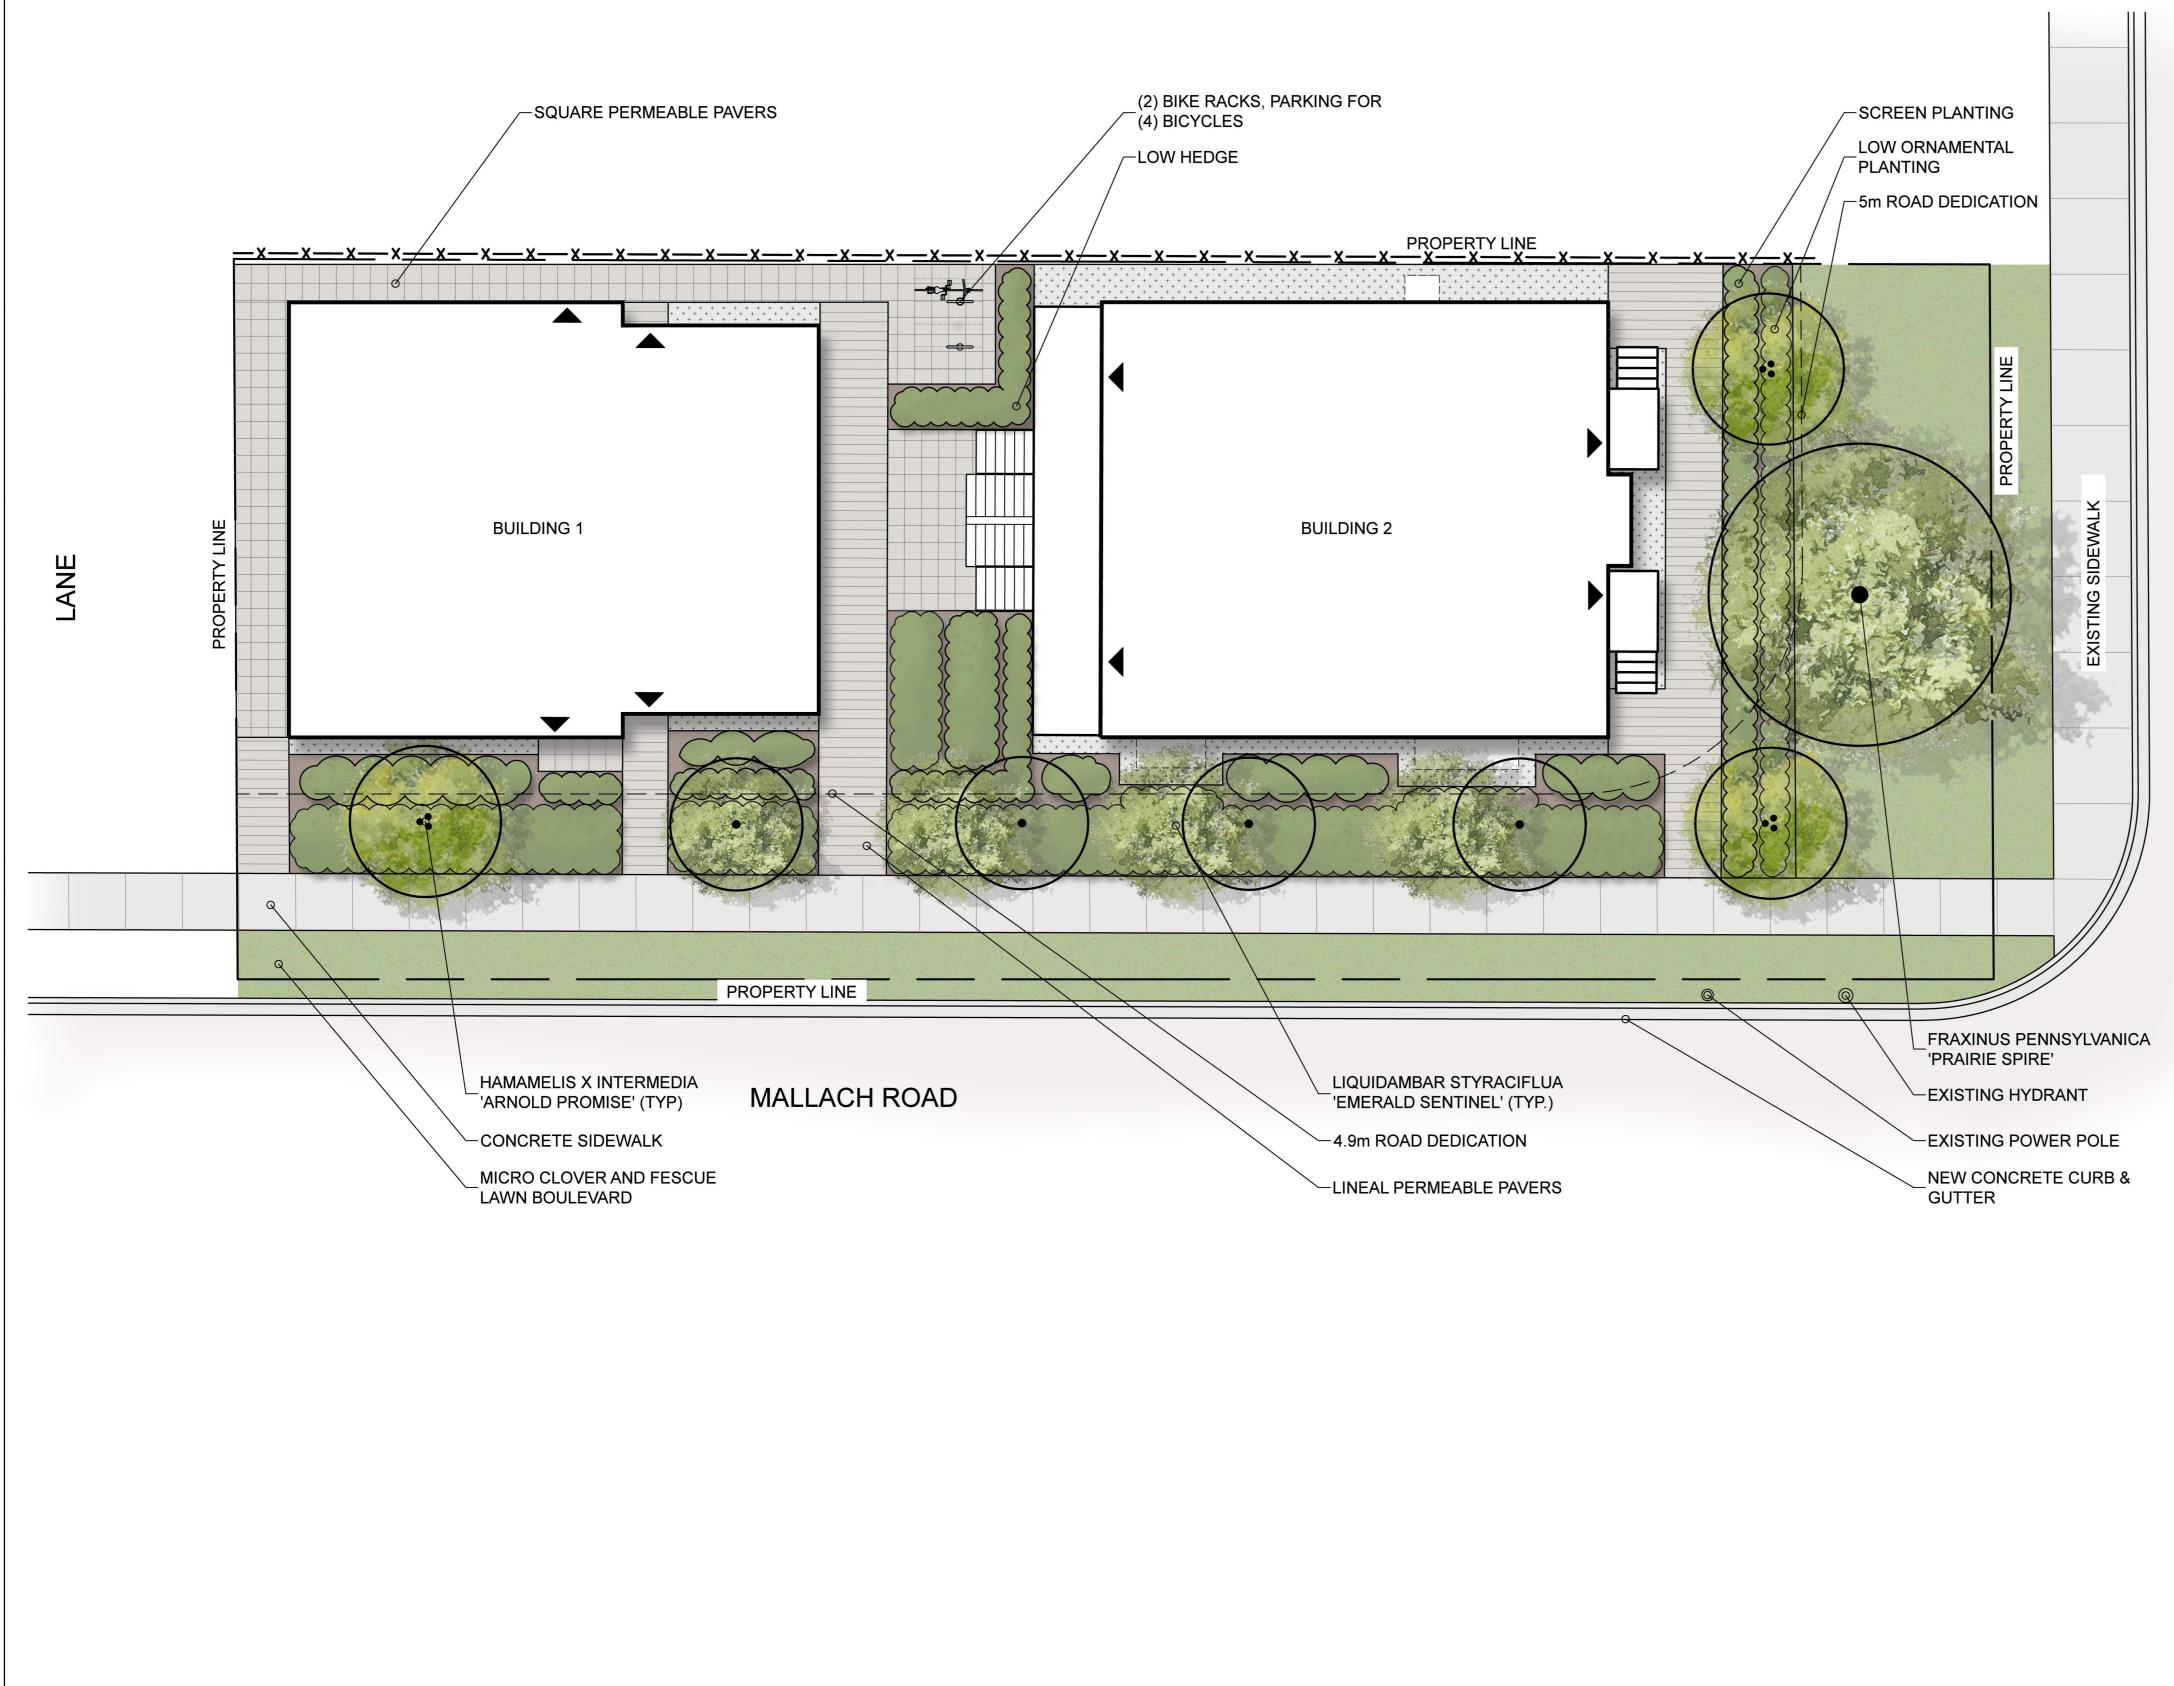


REVISIONS / ISSUED					
3	JUN 08/18	RE-ISSUED FOR DP			
2	MAY 02/18	ISSUED FOR DP			
1	APR 24/18	ISSUED FOR REVIEW			
NO.	DATE	DESCRIPTION			

PROJECT

365 HIGHWAY 33 MULTI-FAMILY SAATH DEVELOPMENT CORP. 

1 2 3 4 5 6 7 8 9 10m SCALE: 1:100 NOT FOR CONSTRUCTION

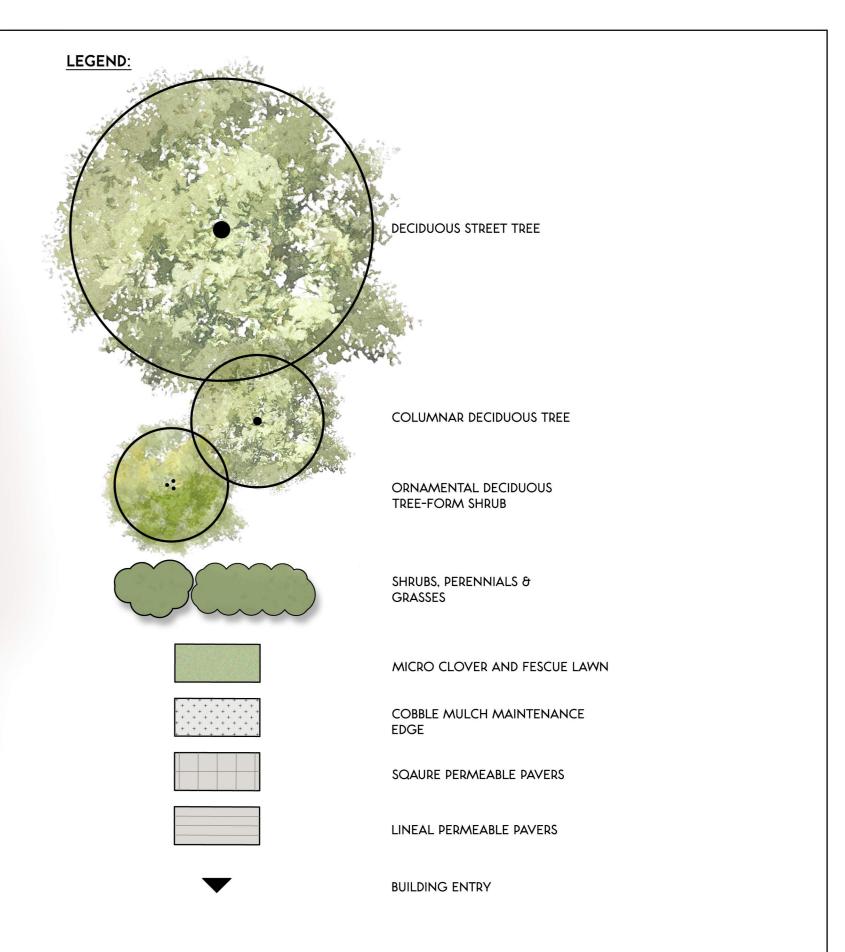

DEVELOPMENT PERMIT NOTES:

- A PLANT MATERIALS AND CONSTRUCTION METHODS SHALL CONFORM TO MINIMUM STANDARDS ESTABLISHED IN THE LATEST EDITION OF THE B.C. LANDSCAPE STANDARDS, PUBLISHED BY B.C.L.N.A. AND B.C.S.L.A. AS WELL AS THE CITY OF KELOWNA LANDSCAPE STANDARDS IN BYLAW 7900.
- B THE LANDSCAPE DESIGN DESIGNATED HEREIN IS CONCEPTUAL BUT REFLECTS THE MINIMUM CITY OF KELOWNA FORM AND CHARACTER REQUIREMENTS
 C PLANT MATERIAL SELECTIONS ARE CONCEPTUAL ONLY. FINAL PLANTING SELECTIONS MAY VARY DEPENDING
- UPON AVAILABILITY AT THE TIME OF CONSTRUCTION. D TREES SHALL BE INSTALLED IN DEFINED SOIL PITS OR PLANTING BED AREAS. ADEQUATE SOIL VOLUME SHALL BE
- PROVIDED BASED ON THE SPECIFIED TREE SPECIES AND LOCATION. E ORNAMENTAL SHRUB, GRASS AND PERENNIAL CLUSTERS ARE TO BE PLACED WITHIN DEFINED PLANTING BEDS. ALL PLANTING BEDS SHALL HAVE A MIN. OF 450mm (18") IMPORTED GROWING MEDIUM AND 75mm (3") OF COMPOSTED MULCH OR APPROVED EQUAL.
- F DECORATIVE ROCK AREAS SHALL HAVE A MIN. OF 75mm (3") OF DECORATIVE ROUND ROCK. COMMERCIAL GRADE LANDSCAPE FABRIC SHALL BE INSTALLED BELOW ALL DECORATIVE ROCK AREAS.
 H SEEDED MICRO CLOVER & FESCUE LAWN AREAS SHALL BE LOW WATER USE 'CERTIFIED CANADA NO. 1' SEED WITH
- A MIN, OF 150mm (6") IMPORTED GROWING MEDIUM.
 I A HIGH EFFICIENCY IRRIGATION SYSTEM SHALL BE INSTALLED FOR ALL ORNAMENTAL LANDSCAPE AREAS AND SHALL CONFORM TO THE CITY OF KELOWNA'S IRRIGATION STANDARDS IN BYLAW 7900.

PLANT LIST:

TREES			
Botanical Name	Common Name	Size	Root
Fraxinus pennsylvanica 'Prairie Spire'	Green ash	6 cm Cal.	B&B
Hamamelis x intermedia 'Arnold Promise'	Arnold Promise witch hazel	1.8m Ht.	Potted Potted
Hamamelis x intermedia 'Jelena'	Jelena witch hazel	1.8m Ht.	
Liquidambar styraciflua 'Emerald Sentinel'	American sweetgum	6 cm Cal.	B&B
SHRUBS			
Botanical Name	Common Name	Size/Spacing	Root
Buxus 'Green Velvet'	Boxwood	#02 Cont./1.0m O.C.	Potted
Erica carnea 'Springwood Pink'	Winter heath	#02 Cont./0.45m O.C.	Potted
Weigela florida 'Alexandra'	Wine & Roses weigela	#02 Cont/1.5m O.C.	Potted
PERENNIALS			
Botanical Name	Common Name	Size/Spacing	Root
Nepeta racemosa 'Walker's Low'	Walker's Low catmint	#01 Cont./0.9m O.C.	Potted
GRASSES			
Botanical Name	Common Name	Size/Spacing	Root
Calamagrostis acutiflora 'Karl Foerster'	Feather reed grass	#02 Cont./0.9m O.C.	Potted
Pennisetum alepocuroides 'Hameln'	Fountain grass	#01 Cont./0.6m O.C.	Potted
Sesleria autumnalis	Autumn moor grass	#01 Cont./0.3m O.C.	Potted






SHEET TITLE LANDSCAPE PLAN SHEET NO.


PROJECT #

L-1

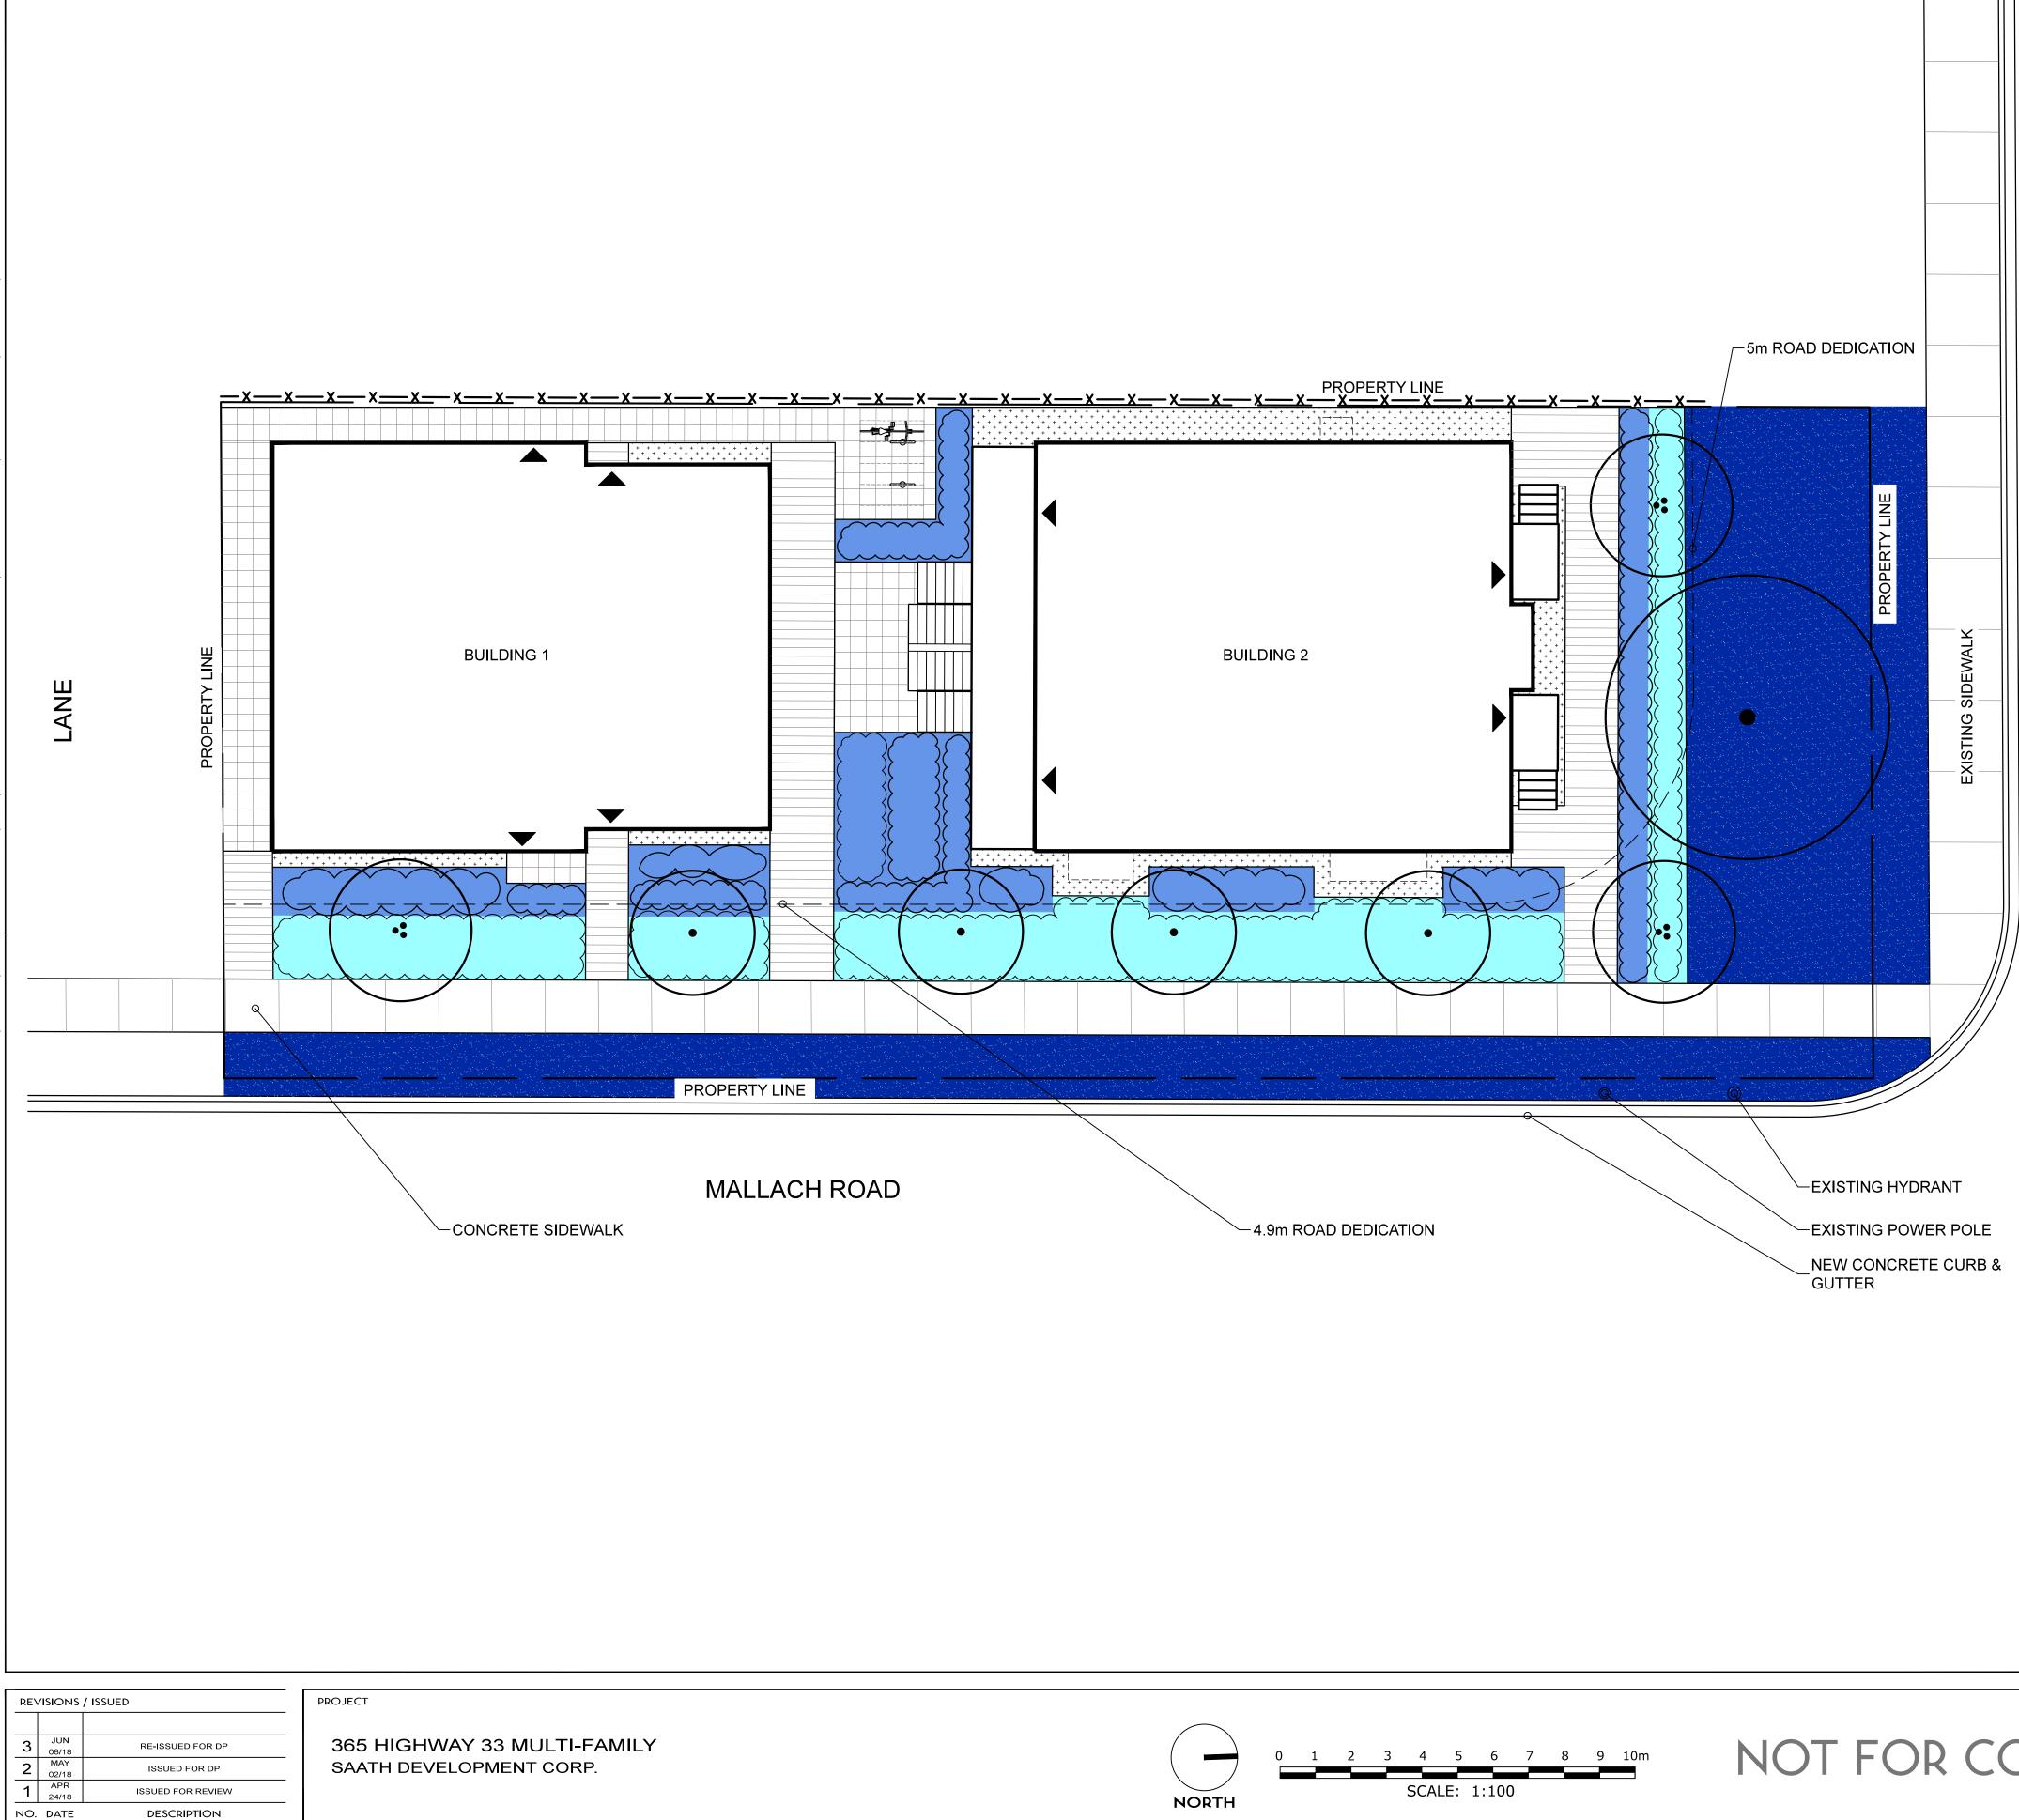

NOT FOR CONSTRUCTION

LEGEND:

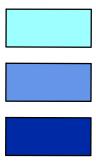

LOW WATER USE

MODERATE WATER USE

HIGH WATER USE



SHEET TITLE HYDROZONE PLAN

SHEET NO.

L-2

PROJECT # 18-014 SCALE 1:100