HANS P. NEUMANN ARCHITECT INC.

1520 Highland Drive North, Kelowna, B.C. V1Y 4K5 Phone: (250) 868-0878 Fax: (250) 868-0837 Principal: Hans P. Neumann, Architect AIBC, B.Arch., B.E.S.

July 31, 2019

The Honourable Mayor Colin Basran and City of Kelowna Council 1435 Water Street Kelowna, B.C. V1Y 1J4

Re: Proposed Residential Project @ 1659 Water Street


We are submitting the above-noted project for Development Variance Permit and request the following variances to the C7 - Central Business Commercial zone. The extremely unique triangular site configuration requires the following variances in order to reasonably develop the property in a manner that generally complies with the OCP vision for the area, and attempts to comply with the current Zoning Bylaw No. 8000 as much as possible.

The rationale for requesting the bylaw variances is:

- 1. REQUIRED ON-SITE PARKING SPACES: The C7 Parking Schedule requires 1.3 spaces per 100 sq.m. of Gross Floor Area (GFA), which would equate to 15 spaces. The site dimensions simply do not support any kind of drive aisle & parking spaces, as the frontage on the lane side is only 1.78m (5'-10"), and the frontage off of Leon Avenue is 8.6m (28'-2"), which is substantially below the 13m required for a drive aisle plus parking stall depth, even using compact vehicle/motorcycle parking space dimensions. In preliminary discussions, it was suggested that the city traffic & engineering department would not even consider any access off of Leon Avenue or Water Street. As such we are requesting a variance to 0 spaces, which we feel is reasonable given the sites' location in a designated Urban Centre, proximity to public transit and the City's encouragement for the reduction of dependence on automobiles. We are proposing the provision of increased secure bicycle parking above what is required by the zoning bylaw to partially compensate for the shortfall.
- 2. REQUIRED ON SITE LOADING PARKING SPACE: As above, the required one (1) 28 sq.m. (300 sq.ft.+) loading space cannot be accommodated on the site.
- 3. REQUIRED FRONT & SIDE SETBACKS ABOVE HEIGHT OF 16m: Complying with this requirement would make the top floor & roof deck not possible and would limit the height of the building to five storeys. This would essentially make any type of building uneconomical by removing the prime highest revenue space, as well as deleting a key common amenity space from the potential tenants.
- 4. FUNCTIONAL COMMERCIAL SPACE ALONG LEON AVENUE: The only workable location for the building elevator reduces the functional space to 72% of minimal building frontage along Leon Avenue. The triangular site & floor plate configuration do not allow for the elevator & internal circulation to be placed in any alternative location.
- 5. FUNCTIONAL COMMERCIAL SPACE ALONG WATER STREET: The prime reason for requesting this variance to 55% of minimal building frontage, is to accommodate the required location & clearances for the Fortis electrical transformer servicing the site. Alternate solutions were unsuccessfully explored. In addition direct exterior access for the electrical room, as well as the fire protection sprinkler water entry facilities greatly reduced the available frontage. We propose to glaze the street frontage of the electrical/mechanical room to match the commercial space on the other side of the transformer to at least provide a consistent aesthetic along Leon Avenue.

We trust that you will favourably consider this application, as this building would contribute to the desired energy & activity of this area.


HANS P. NEUMANN, Architect AIBC

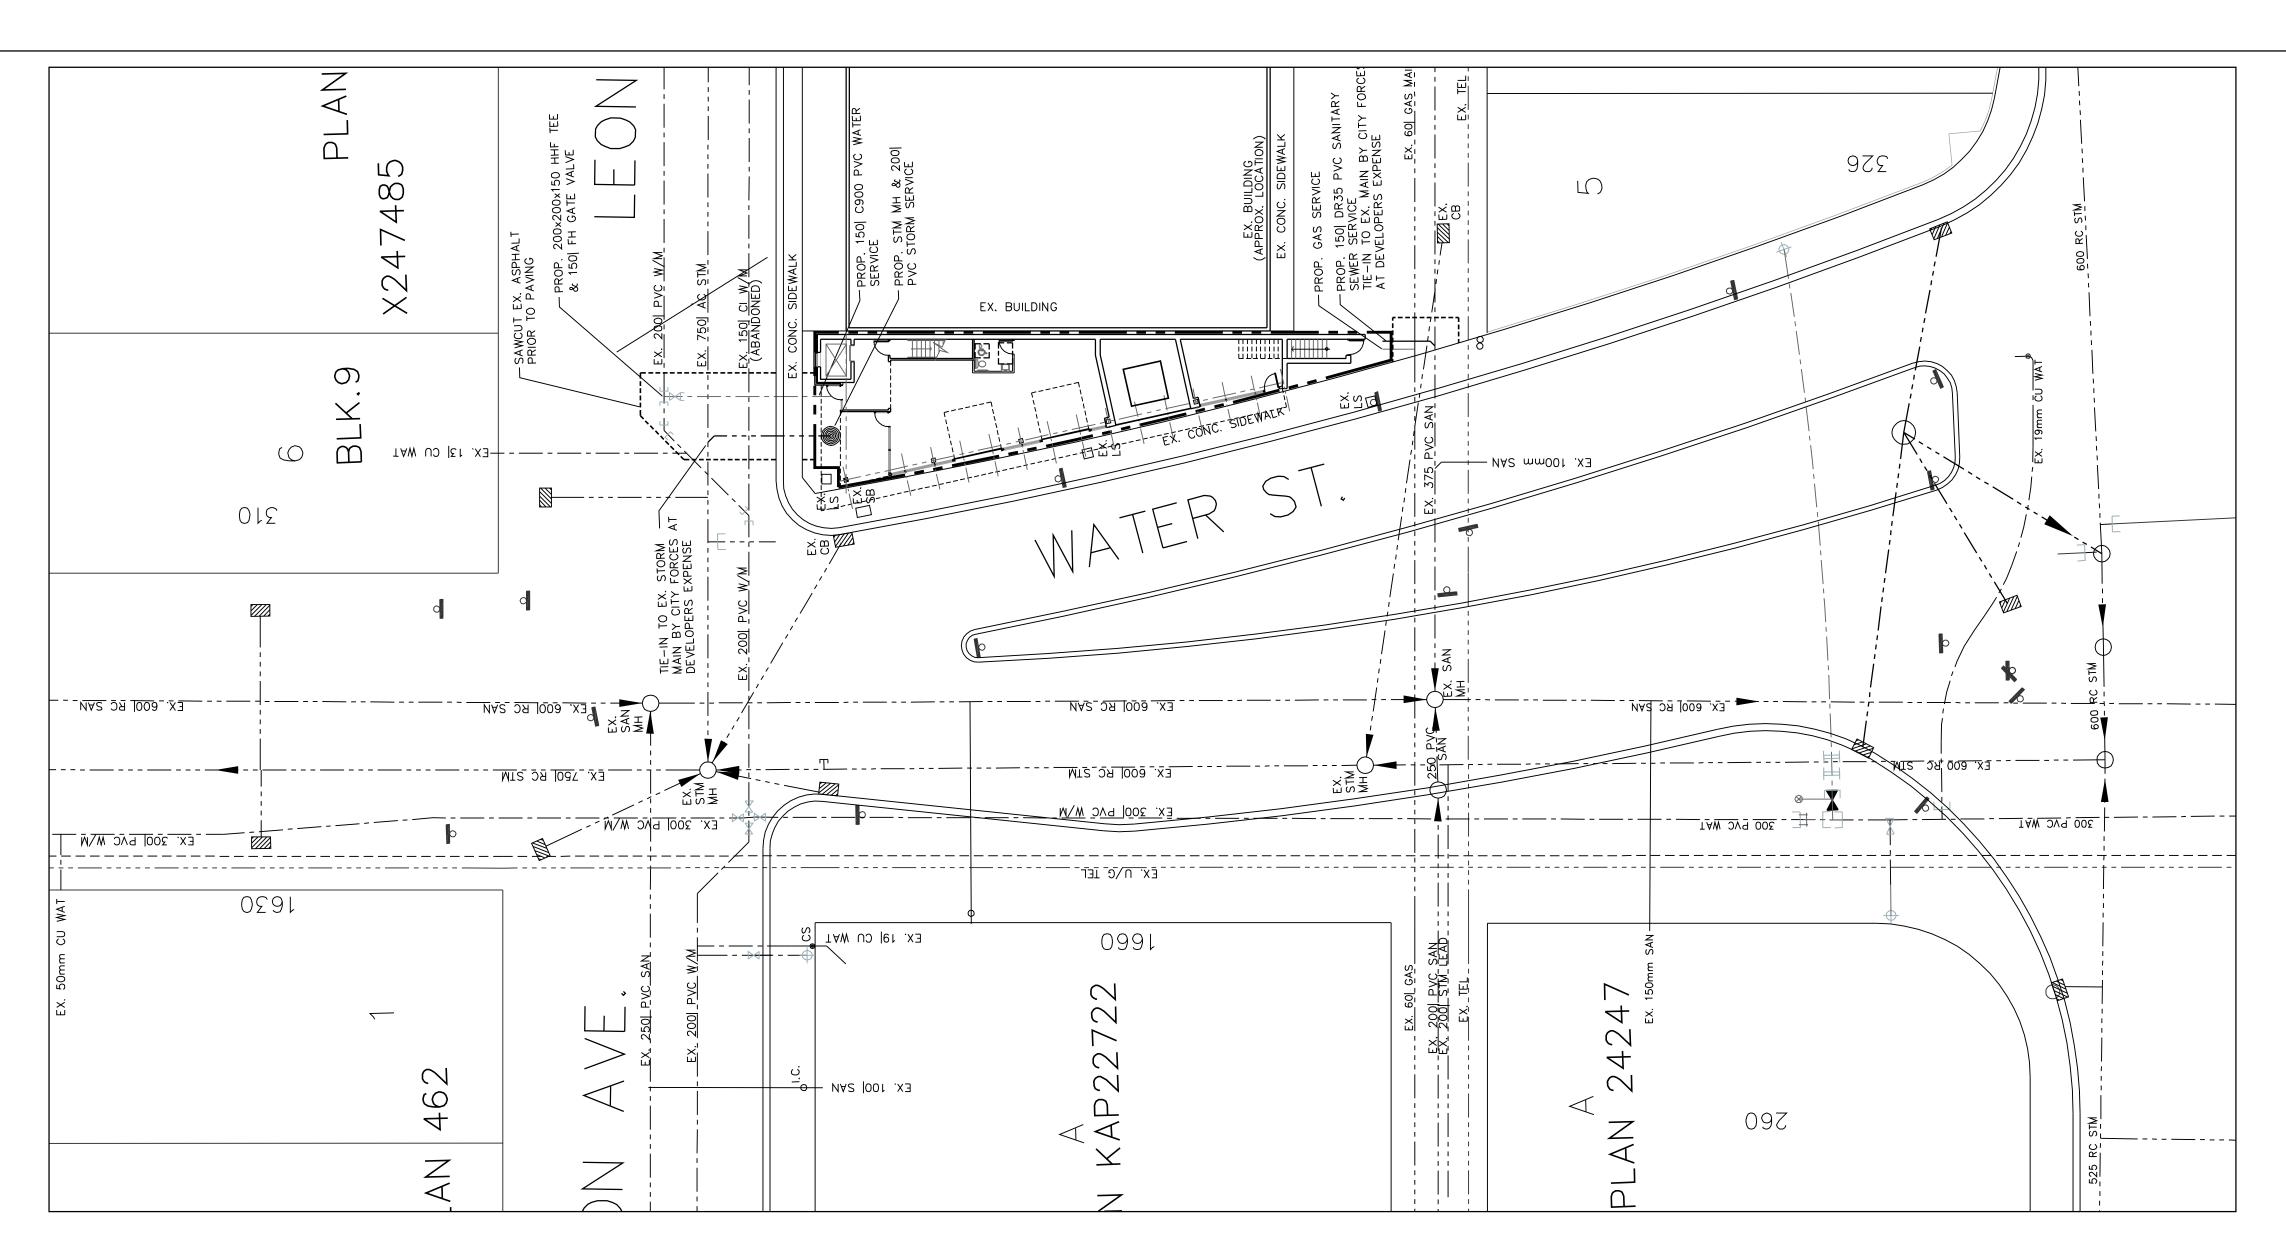

SITE PLAN SCALE: |" = 20'-0"




LEON AVE ELEVATION

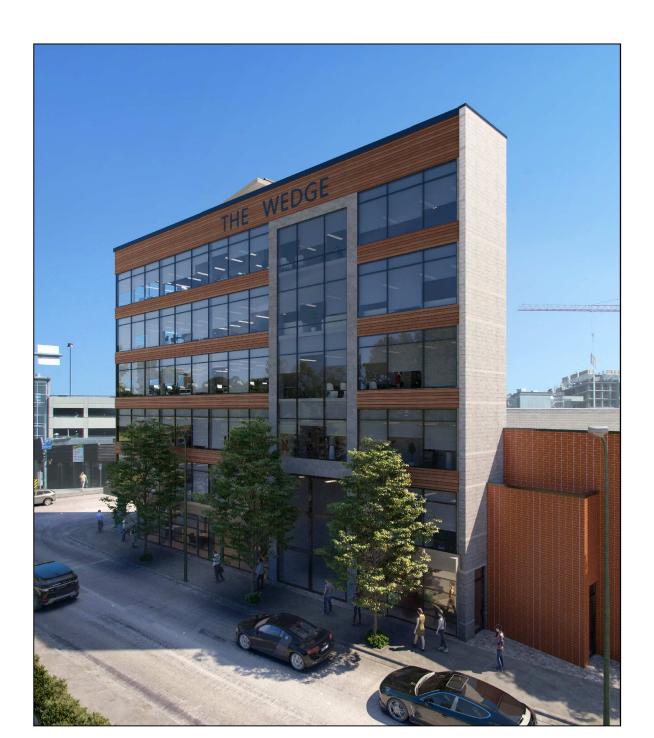

WATER STREET ELEVATION

VARIANCES REQUIRED


- FRONT SETBACK OF BUILDING ABOVE 16m FROM 3.0m REQUIRED TO 0.025m PROPOSED.
- 2. SIDE (EAST) SETBACK OF BUILDING ABOVE 16m FROM 4.0m REQUIRED TO 0,025m PROPOSED.
- 3. SIDE (WATER STREET) SETBACK OF BUILDING ABOVE 16m FROM 3.0m REQUIRED TO 0.025m PROPOSED.
- 4. FUNCTION COMMERCIAL SPACE FRONTAGE ALONG LEON AVENUE FROM 90% REQUIRED TO 72% PROPOSED.
- 5. FUNCTION COMMERCIAL SPACE FRONTAGE ALONG WATER STREET FROM 90%
- REQUIRED TO 55% PROPOSED.
- 6. NUMBER OF PARKING SPACES FROM 15 STALLS REQUIRED TO 0 STALLS
- PROPOSED. 7. NUMBER OF LOADING SPACES FROM 1 STALL REQUIRED TO 0 STALLS PROPOSED.

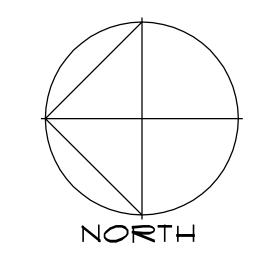


PROJECT DATA	4	
CIVIC ADDRESS: 1659 WATER ST., KEI	LOWNA, BC	
EGAL DESCRIPTION: LOT 12, PLAN KAP46	52, DL 139, EXCEPT PLAN	KAP82841, O.D.Y.D.
CURRENT ZONING: C7 — CENTRAL BUSII	NESS COMMERCIAL	
ZONING BYLAV	V REQUIRE	MENTS
SITE AREA = 2,437 SQ.FT. (226.40 SQ.M.)		
BUILDING AREA (NET):		
MAIN FLOOR (RETAIL/OFFICES) SECOND FLOOR (OFFICES)	= 1,388 SQ.FT. (128.9 = 1,114 SQ.FT. (103.5 S = 1,564 SQ.FT. (145.3	SQ.M.) SQ.M.)
THIRD FLOOR (OFFICES) FOURTH FLOOR (OFFICES)	= 1,564 SQ.FT. (145.3 = 1,564 SQ.FT. (145.3	SQ.M.) SQ.M.)
FIFTH FLOOR (OFFICES) SIXTH FLOOR (OFFICES)	= 1,564 SQ.FT. (145.3 = 1,564 SQ.FT. (145.3 = 1,564 SQ.FT. (145.3	SQ.M.)
SEVENTH FLOOR (COMMON AREA)		<u>SQ.M.)</u>
TOTAL NET BUILDING AREA:	=10,267 SQ.FT. (953,8 S	SQ.M.)
BUILDING AREA (GROSS):	- 1507 COFT /140 C	SOMA
MAIN FLOOR (RETAIL/OFFICES) SECOND FLOOR (OFFICES)	= 1,507 SQ.FT. (140.0 = 1,533 SQ.FT. (142.4	SQ.M.)
FOURTH FLOOR (OFFICÉS)	= 1,835 SQ.FT. (170.5 = 1,835 SQ.FT. (170.5	sq.M.)
FIFTH FLOOR (OFFICES) SIXTH FLOOR (OFFICES)	= 1,835 SQ.FT. (170.5 = 1,835 SQ.FT. (170.5	SQ.M.)
SEVENTH FLOOR (COMMON AREA)	= 1,664 SQ,FT, (154,6	SQ.M.)
TOTAL GROSS BUILDING AREA:	=12,044 SQ.FT. (1,118.9	SQ.M.)
	ZONE REQUIREMENT	<u>PROPOSED</u>
LOT WIDTH	6.0m	8,6m
LOT DEPTH	30,0m	36,02m
LOT AREA	200 sq.m.	226.4 sq.m.
FLOOR AREA RATIO (FAR)		2.81 (1,937.0 sq.m.)
HEIGHT (m)	76.5m	26.5m/ 6 STOREYS
SETBACKS (m)	0.0	0.005
FRONT (LEON AYENUE) FRONT ABOVE 16m (LEON AYENUE)	0.0m 3.0m	0.025m 0.025m *
SIDE (EAST)	0.0m	0.152m
SIDE ABOVE 16m (EAST)	4.0m	0.152m *
SIDE (WATER STREET)	0.0m	0.025m
SIDE ABOVE 16m (WATER STREET)	3.0m	0.025m *
REAR (LANE)	0.0m	1.64m
REAR ABOVE 16m (LANE)	3.0m	6.60m
FLOOR PLATE ABOVE 16m (14.7.5) (h) AREA	1,221 sq. m.	177.5 sq. m.
(II) AREA FUNCTIONAL COMMERCIAL SPACE FRONTAGE	•	177.5 Sq. III.
LEON AVENUE	8.6m x 90%=7.75m	5.87m/68% *
WATER STREET	36.02m x 90%=32.42m	14.2m/39.4% *
<u>PARKING</u> COMMERCIAL @ 1.3/100 sq.m. GFA x 1,11	80 com -	
COMMERCIAL W 1.3/100 Sq.m. GFA X 1,11	8.9 sq.m. = 15 STALLS	O STALLS *
LOADING @ 1/1900 sq.m. GFA =	1 STALLS	O STALLS *
BICYCLE PARKING		
•	3 SPACES	
CLASS II @ $0.6/100$ sq.m. GLA =	7 SPACES	7 SPACES
LANDSCAPE BUFFERS (m)	0.0	0.0~
FRONT (LEON AVENUE) SIDE (EAST)	0.0m 0.0m	0.0m 0.0m
SIDE (WATER STREET) REAR (LANE)	0.0m 0,0m	0.0m 0.0m
NEAN (LANE)	U,UIII	U,UIII
LANDSCAPE TREATMENT LEVELS		o'n
FRONT (LEON AVENUE)	NOT REQ'D NOT REQ'D	
SIDE (EAST)	NUI RE	ע ט
SIDE (EAST) SIDE (WATER STREET) PEAR (SOUTH)	NOT RE	Q'D
SIDE (EAST) SIDE (WATER STREET) REAR (SOUTH) * VARIANCE REQUIRED		Q'D


* VARIANCE REQUIRED

SCALE: 1" = 20'-0"DATE: JULY 23,2019 DRAWN: MAC CHECKED: HPN

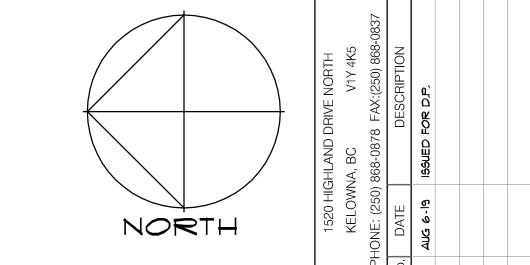

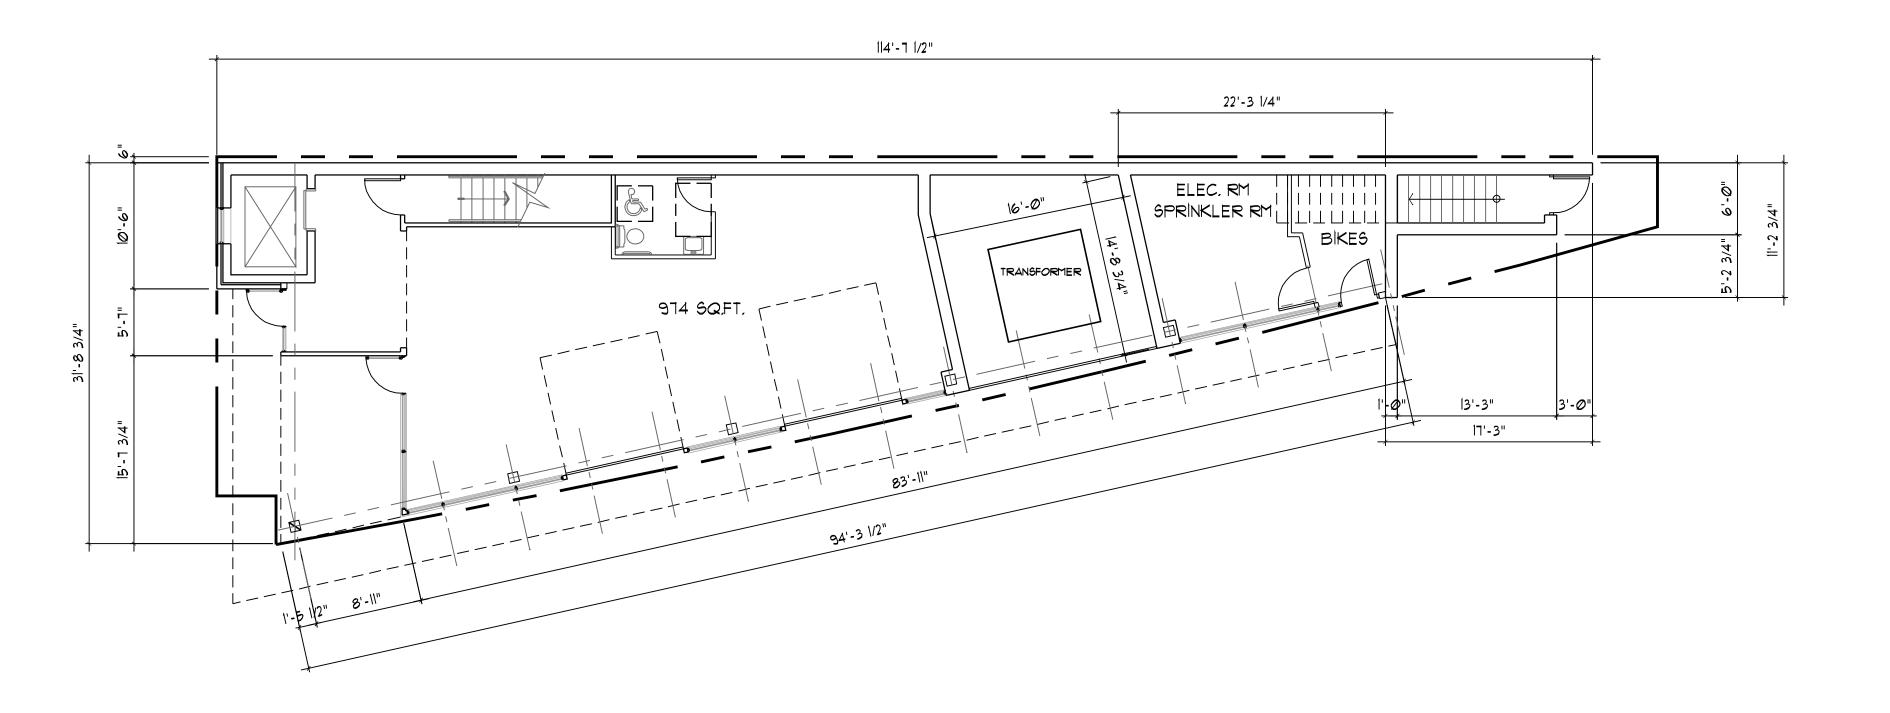



MAIN FLOOR PLAN 9CALE: 1/8" = 1'-0"

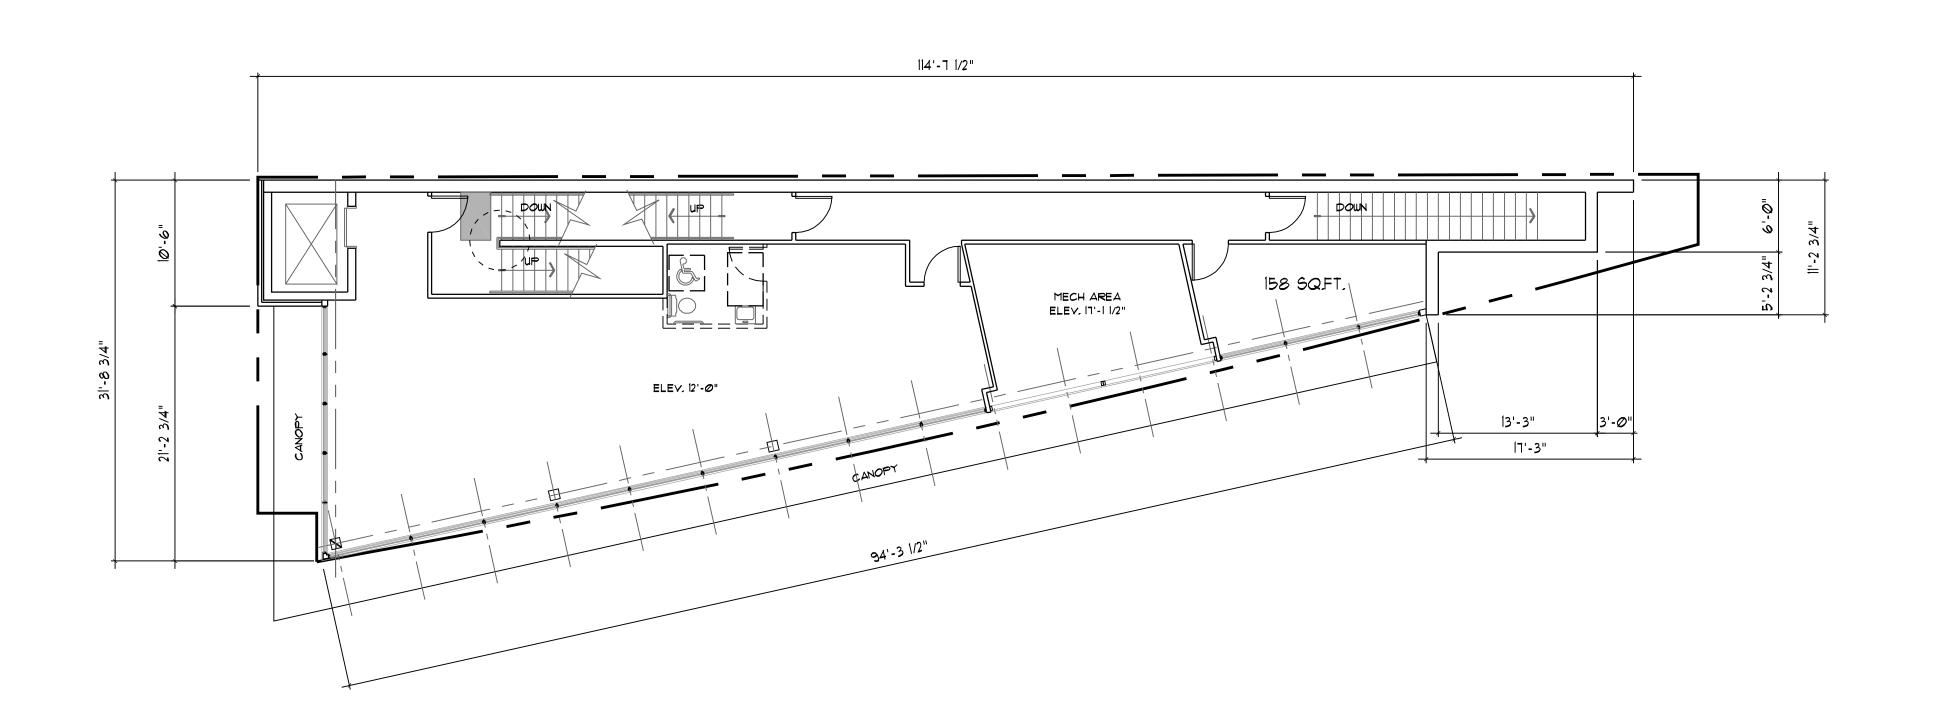


SECOND FLOOR PLAN SCALE: 1/8" = 1'-0"

CHITECT C.		COMMERCIAL DEVELOPMENT 1659 WATER STREET, KELOWNA, BC.
A		PROJECT
NNNN		NS SN'
σ.		PLANS
S Z Z F	DRAWN: N	Y 23,2019 MAC HPN
· <u>/</u>	Drawing No.	1

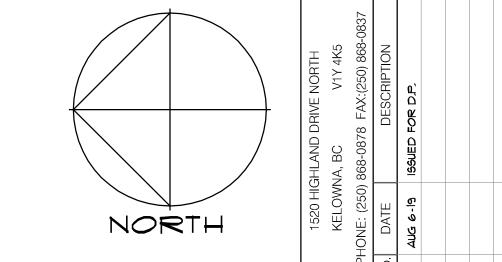

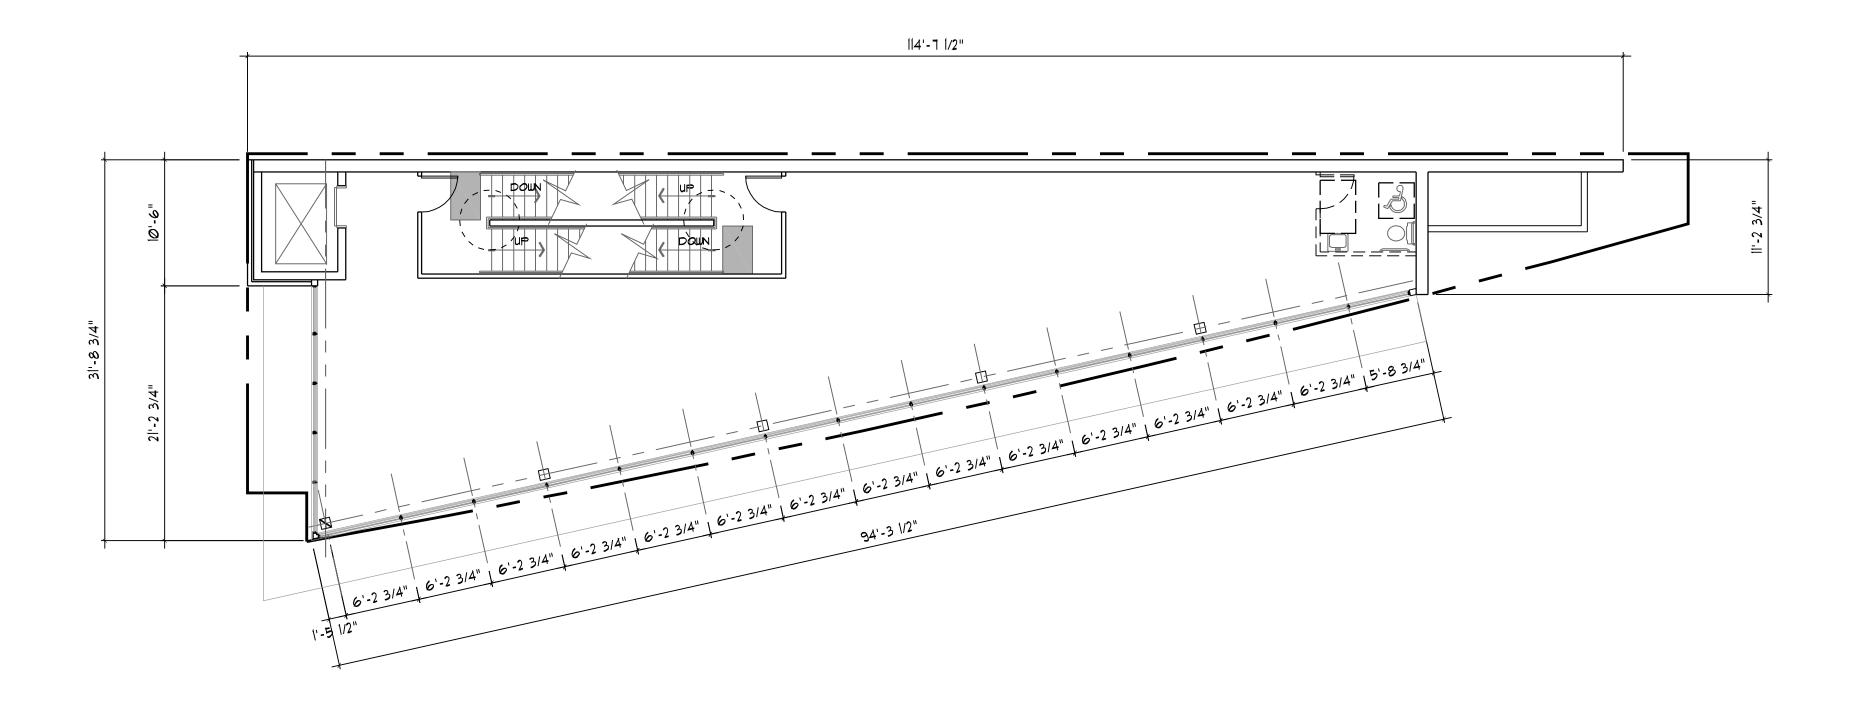


THIRD - SIXTH FLOOR PLAN SCALE: 1/8" = 1'-0"

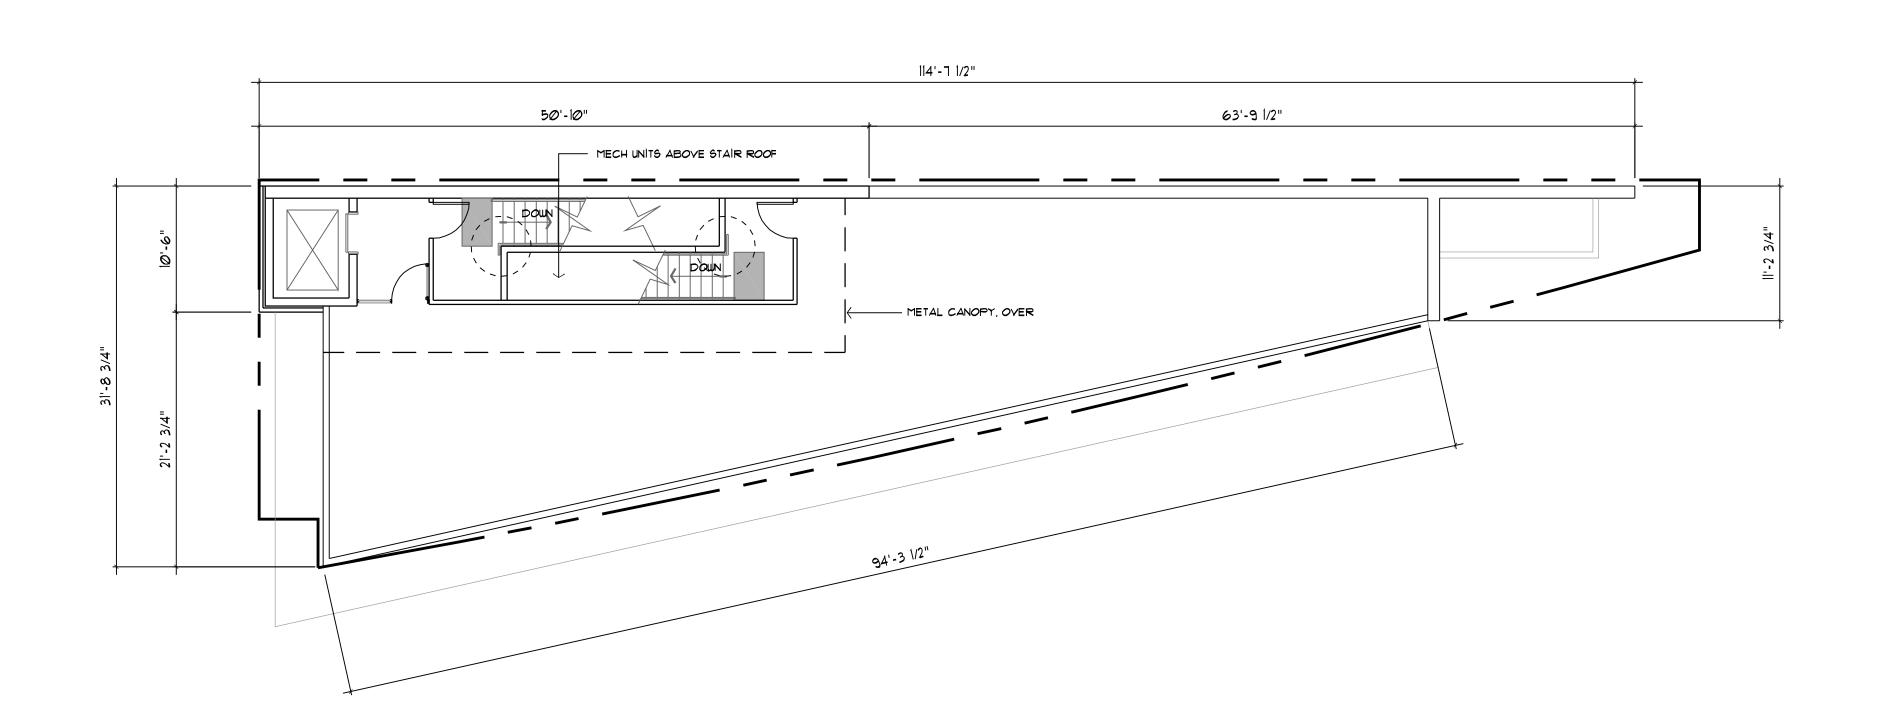


ROOF PATO PLAN SCALE: 1/8" = 1'-0"

ARCHITECT IN C.	PROJECT COMMERCIAL DEVELOPMENT 1659 WATER STREET, KELOWNA, BC.
NNNN	
H A N S	Y 23,2019 MAC HPN

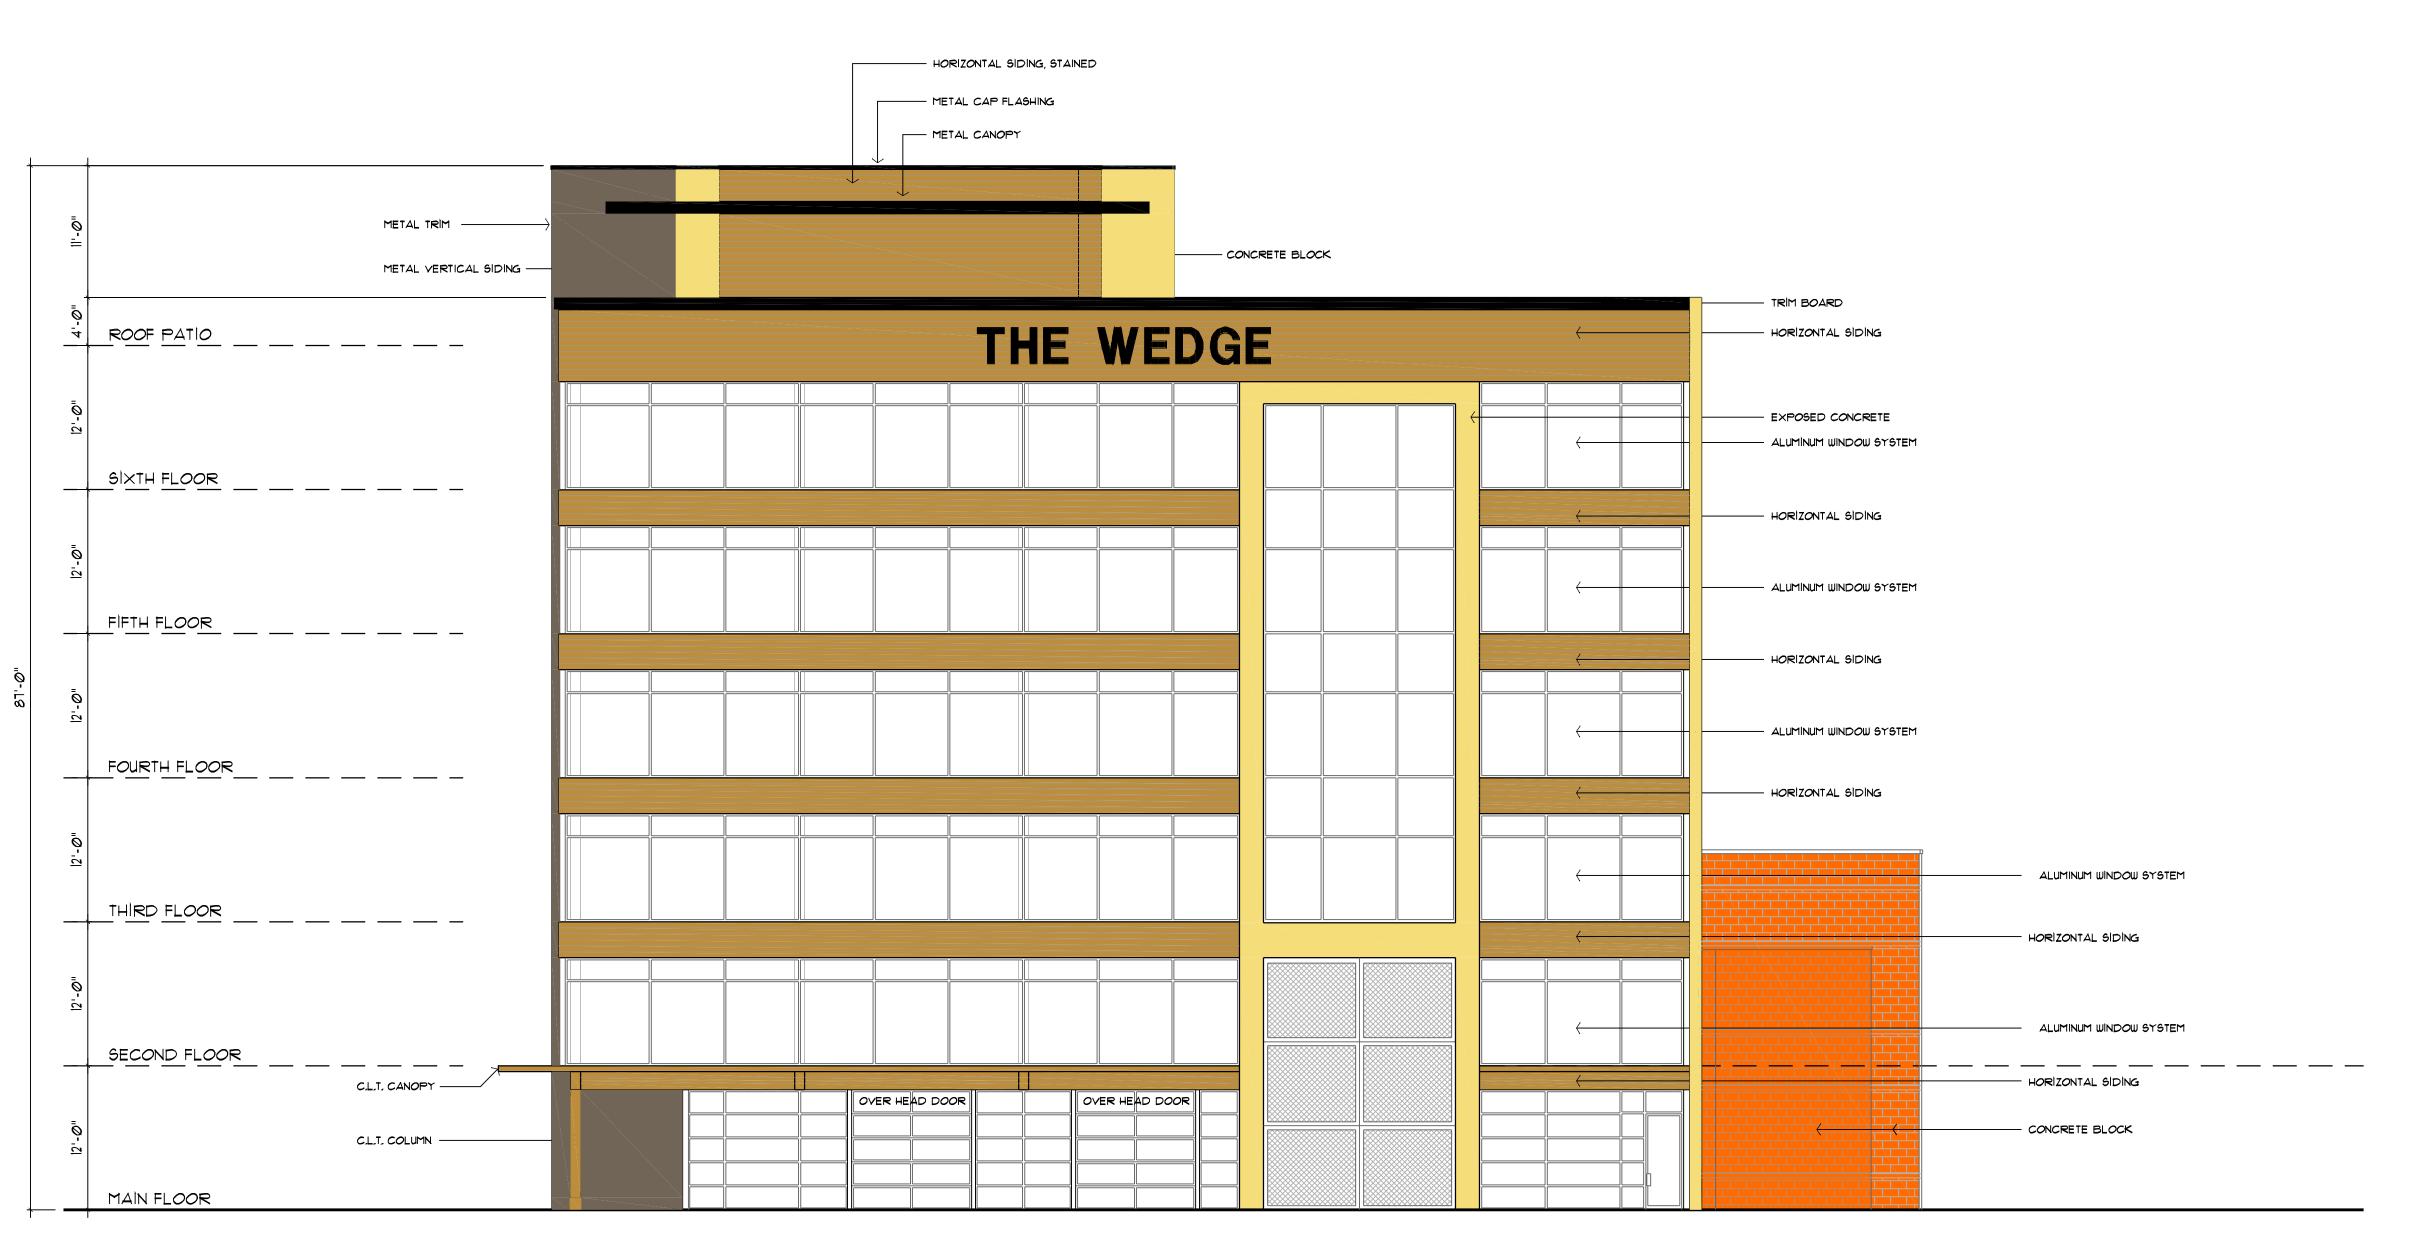

WATER STREET - WEST ELEVATION SCALE: 1/8" = 1'-0"

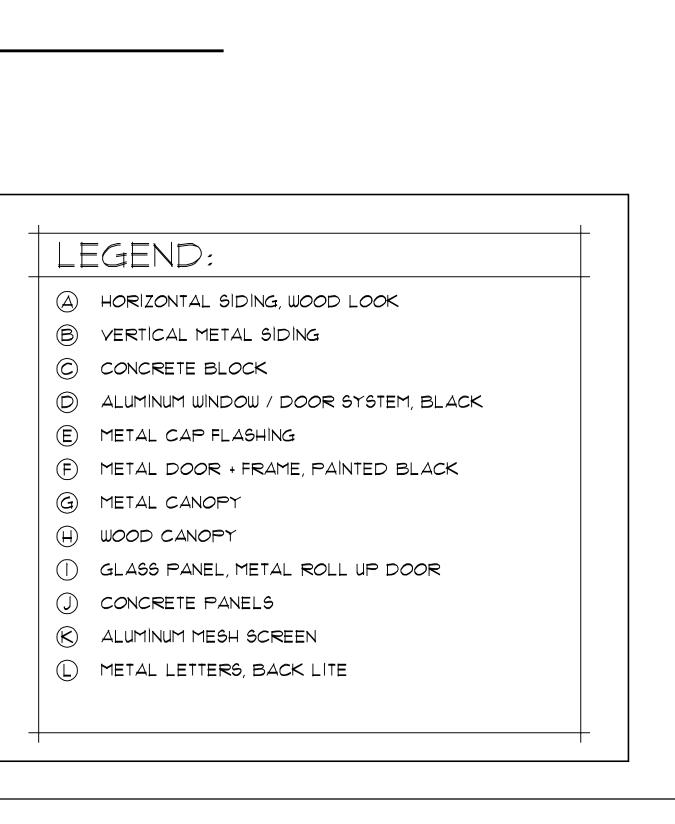


COMMERCIAL DEVELOPMENT 1659 WATER STREET, KELOWNA, BC.

SCALE: 1/8" = 1'-0"


DATE: JULY 23,2019
DRAWN: MAC

CHECKED: HPN

Drawing No.

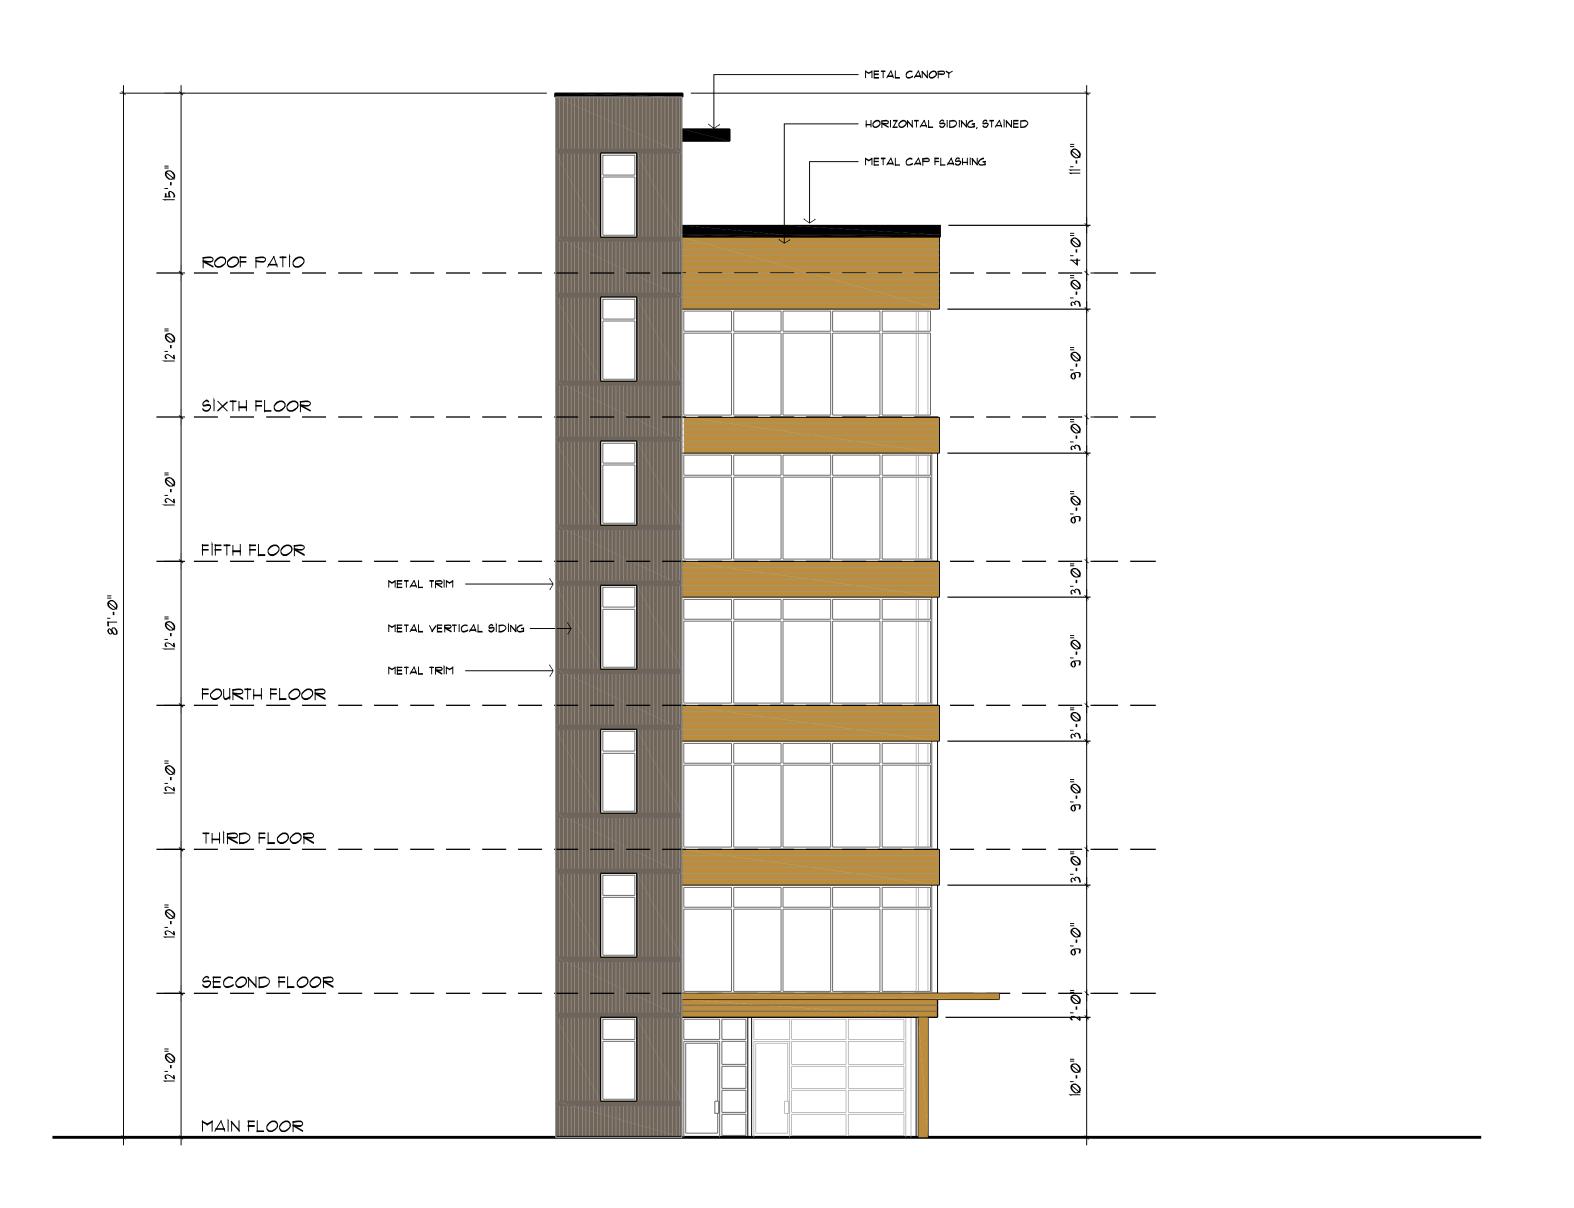

LEON AVE - NORTH ELEVATION SCALE: 1/8" = 1'-0"

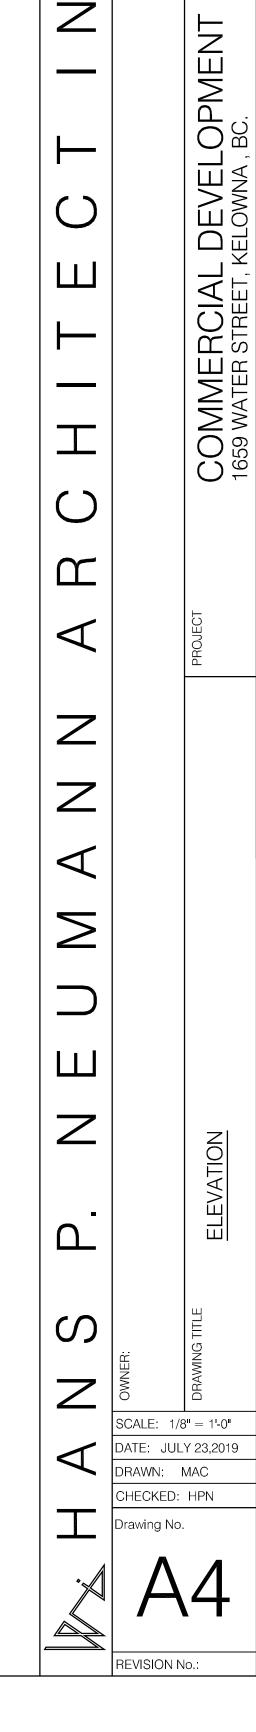

LEGEND:

A HORIZONTAL SIDING, WOOD LOOK

D ALUMINUM WINDOW / DOOR SYSTEM, BLACK

F METAL DOOR + FRAME, PAINTED BLACK

() GLASS PANEL, METAL ROLL UP DOOR

B VERTICAL METAL SIDING

E METAL CAP FLASHING

© CONCRETE BLOCK


G METAL CANOPY

H WOOD CANOPY

(J) CONCRETE PANELS

K ALUMINUM MESH SCREEN

(L) METAL LETTERS, BACK LITE

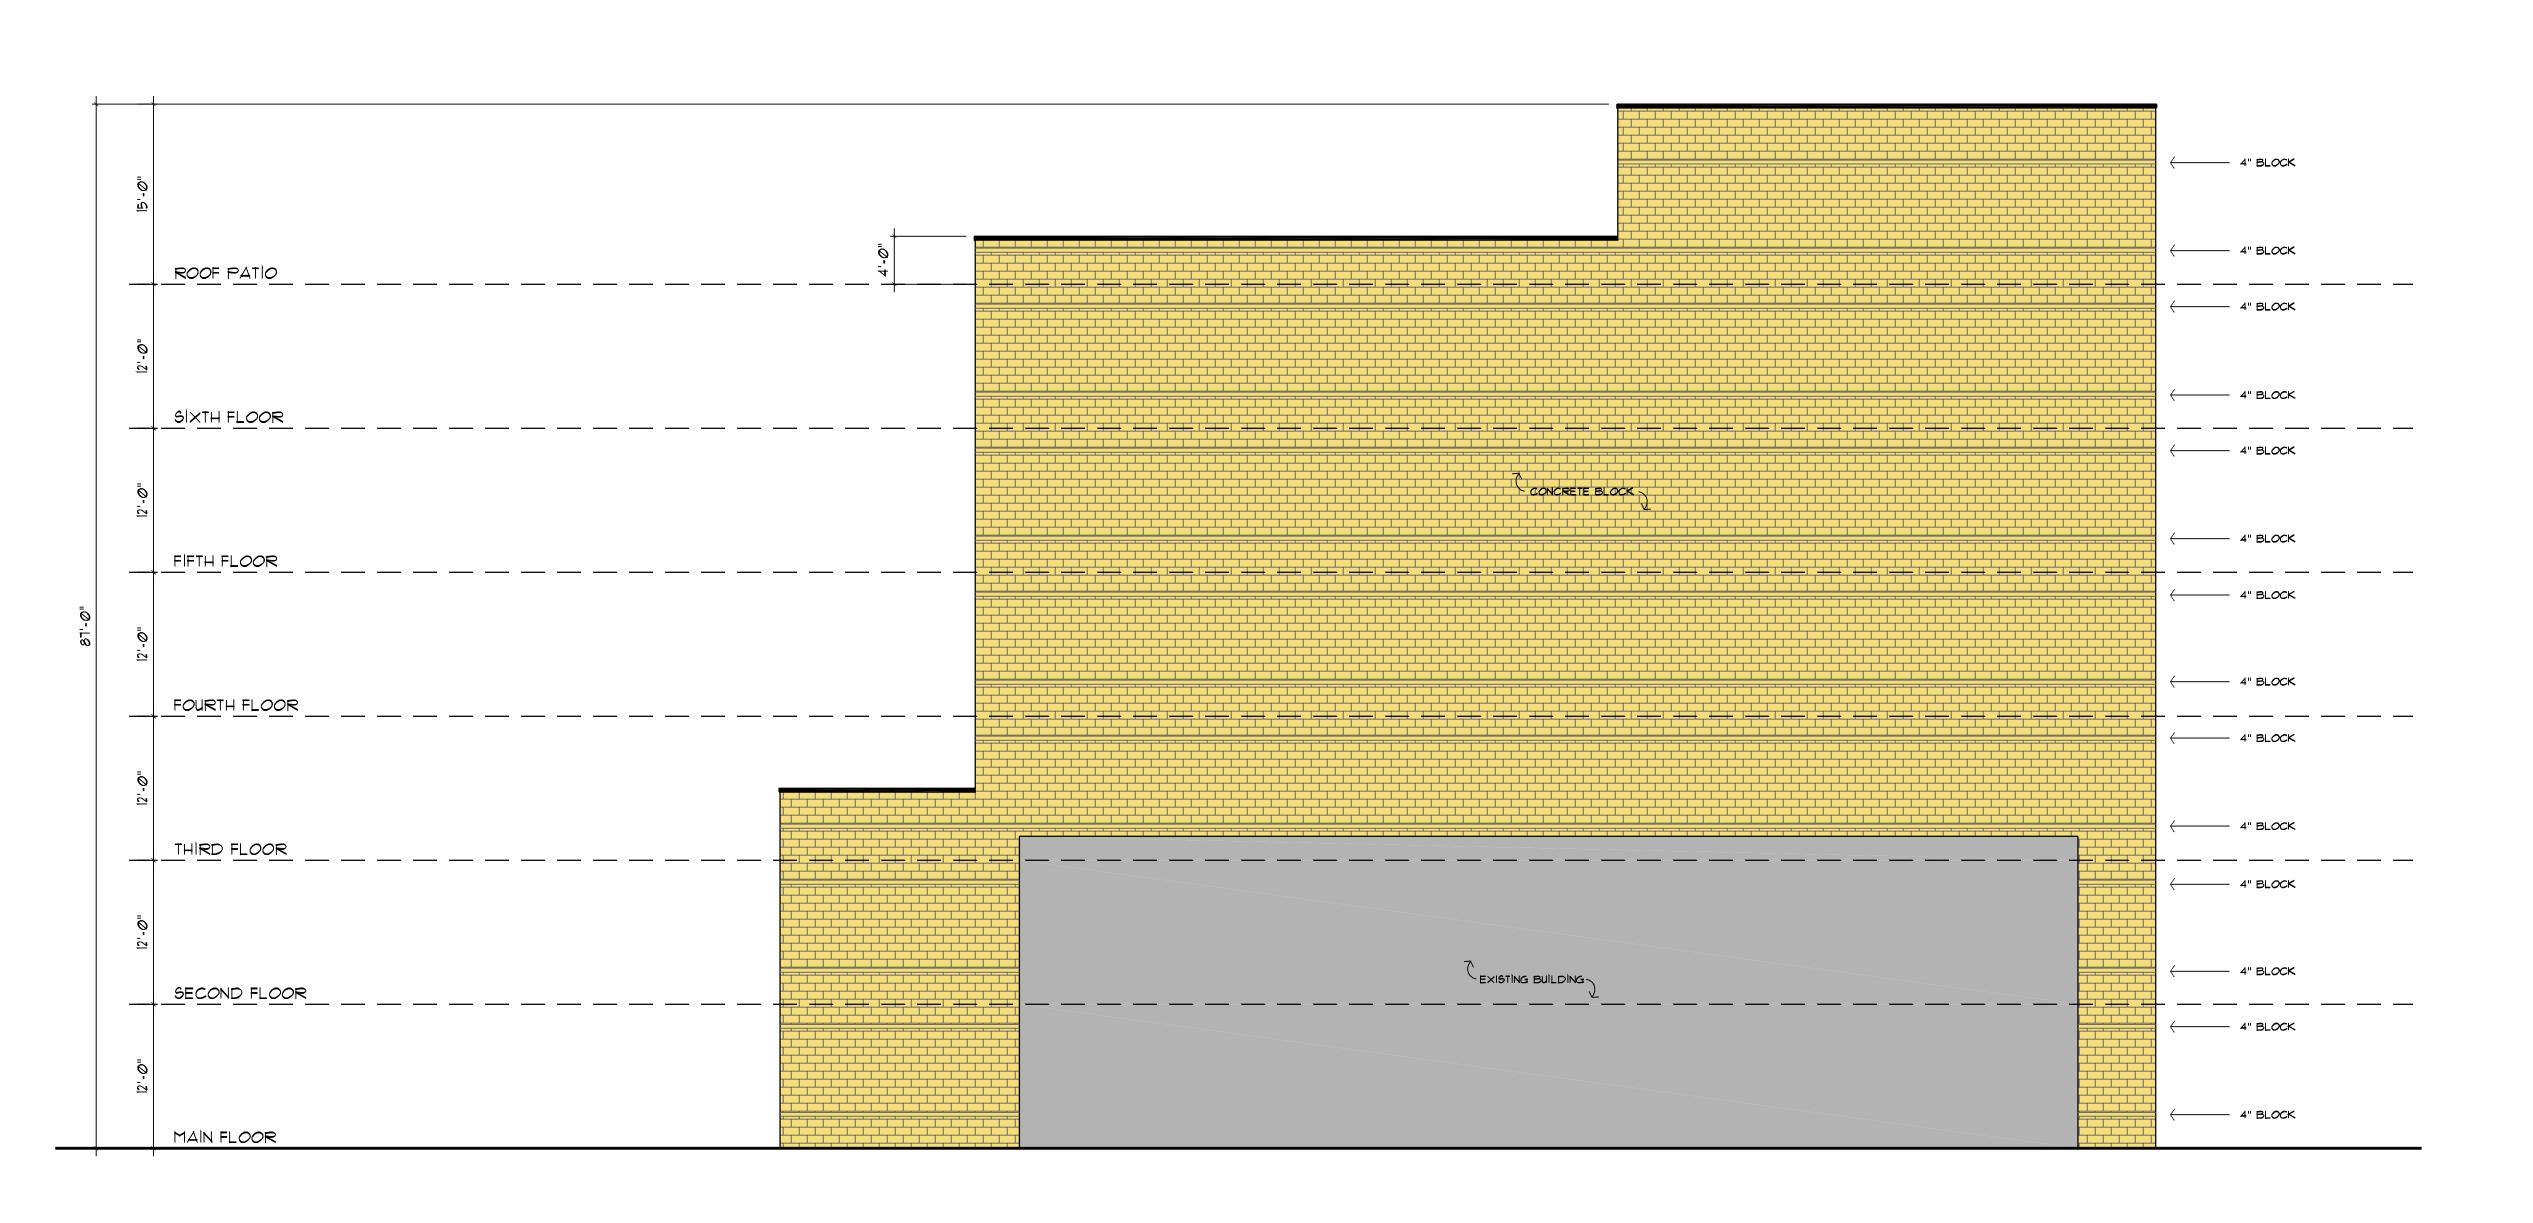

EAST ELEVATION

SCALE: 1/8" = 1'-0"



COMMERCIAL DEVELOPMENT 1659 WATER STREET, KELOWNA, BC. SCALE: 1/8" = 1'-0" DATE: JULY 23,2019 DRAWN: MAC CHECKED: HPN