





BUILDING AND FLOOR AREAS - BLDG A						
UNIT TYPES		UNIT NFA ±sf	UNIT NFA ±sm	UNIT COUNT		
Α	1 BED	588	55	15		
A5	MICRO	312	29	20		
A8	1 BED	554	51	4		
A9	STUDIO	433	40	4		
A10	STUDIO	465	43	15		
B5	2 BED	675	63	5		
В6	2 BED	820	76	5		
В7	2 BED	720	67	10		
C1	2 BED	907	84	4		
SUBTOTAL BLDG A		44,286	4,114.3			
CRU-5		1,720	160			
CRU-6		2,770	257			
SUBTOTAL COMMERCIAL GFA		4,490	417			
TOTAL E	BLDG A	48,776	4,531.4	82		

BUILDING AND FLOOR AREAS - BLDG E						
UNI	T TYPES	UNIT NFA ±sf	UNIT NFA ±sm	UNIT COUNT		
Α	1 BED	588	54.6	12		
A1	1 BED	609	56.6	12		
A2	STUDIO	488	45.3	12		
A3	STUDIO	397	36.9	6		
A4	1 BED	580	53.9	6		
A5	MICRO	312	29	24		
A6	1 BED	682	63.4	4		
A7	MICRO	312	29	8		
В	2 BED	697	64.8	6		
B1	2 BED	700	65	12		
B2	2 BED	866	80.5	6		
В3	2 BED	905	84.1	4		
B4	2 BED	694	64.5	12		
С	2 BED	995	92.4	6		
SUBTO	ΓAL BLDG E	74,490	6,920			
CRU-3+4		1,785	165.8			
CRU-MEZZ		350	32.5			
SUBTOTAL COMMERCIAL GFA		2,135	198.3			
TOTAL	BLDG E	76,625	7,118.7	130		
	. 5,525					

BLDG A - GFA			
	±sf	±sm	
Level 1	13,450	1,250	
Level 2	9,480	881	
Level 3	10,900	1,013	
Level 4	10,900	1,013	
Level 5	10,900	1,013	
Level 6	10,900	1,013	
TOTAL RESIDENTAL GFA	66,530	6,181	
PARKADE	51,785	4,811	
SITE COVERAGE			
Bldg A - footprint area Level 1 :	±1,250 sm		

BLDG E - GFA			
	±sf	±sm	
Level 1	15,290	1,420	
Level 2	15,290	1,420	
Level 3	15,290	1,420	
Level 4	15,290	1,420	
Level 5	15,290	1,420	
Level 6	15,290	1,420	
TOTAL RESIDENTAL GFA	91,740	8,523	
CRU-3+4	1,785	165.8	
CRU-MEZZ	350	32.5	
TOTAL COMMERCIAL GFA	2,135	198.3	
PARKADE	51,785	4,811	
SITE COVERAGE			
Bldg E - footprint area Level 1 :	±1,420 sm		

PARKING CALCULATIONS												
REQUIRED												
STALL SIZE	WIE	DTH	LENG	TH	HEIGH	-T		PARKIN	G RATIO			
							requ	uired	Provide			
FULL SIZE STALL	8'-3"	2.5m	19'-8"	6.0m				-	-			
MEDIUM SIZE STALL (40% max)	7'-6"	2.3m	15'-9"	4.8m	6'-6"	2.0m	max	143.3	70			
COMPACT SIZE STALL (10% max)	6'-6"	2.0m	11'-2"	3.4m		2.5111	max	35.8	22			
DISABLED STALL	12'-2"	3.7m	19'-8"	6.0m				4	6			
DRIVE AISLES (2-way 90° pkg)	23'-0"	7.0m										
PARKING REQUIREMENTS:												
		BUILDIN	IG E		BUI	LDING A		BL	IILDING F	BUILD	ING B	
	no of u	unit	no of st	all	no of unit	no	of stall	no of uni	t no of stall	no of unit	no of stall	
0.75 stall per bachelor	50		37.5		39	29	.25					
0.9 stall per 1 bed	34		30.6		19	17	.10					
1.0 stall per 2 & 3 bed	46		46		24	2	24					
cru (1 stall per 100sm)	198s	m	1.98		417sm	4.	17					
Total unit	130	1			82			80		108		400
Total no of stall required			116.08			74	.52		70.2		96.75	358.20
PROVIDED												
	no of	stall										
Parkade Phase 1	20	3										
Parkade Phase 2	152	2										
L1 Parkade CG-A	24											
Sub-total	379)										
stalls on grade	14											
Total	390	3										

Туре	sm			
bachelor	7			
1 bed	12			
2 bed	18			
BUII D	ING A			
0125		Required	Р	rovide
		±sm	±sf	±sm
Level 1		0	0	0
Level 2		157	1,651	153.4
Level 3		200	1,414	131
Level 4		200	1,414	131
Level 5		200	1,414	131
Level 6		200	1,414	131
TOTAL		957	7,307	679
BUILD	ING E			
		Required	Р	rovide
		±sm	±sf	±sm
Level 1		217	1,496	139
Level 2		217	2,262	210.1
Level 3		265	1,854	172
Level 4		265	1,854	172
Level 5		265	1,854	172
Level 6		265	1,854	172
TOTAL		1,229	11,174	1,038.1

NORTH (HARVEY AVE.)	0.0m	Building F	±4.5m min to residential	
		Building B	±4.5m min to residential	
		Building E	±4.5m min to residential	
		Building A	±4.5m min to residential	
SOUTH (REAR)	0.0m	Building F	±4.6 to residential	
		Building B	0m (Parkade to PL) 10.8m (Bldg B to PL)	
		Building E	±14.2m (Bldg E to PL)	
		Building A	±9.6m (Bldg A to Bldg B	
WEST (SIDE)	3.0m	Building F	±8.1m (to Bldg B)	
		Building B	±0.53m (Parkade to PL) ±8.1m (Bldg B to Bldg F	
		Building E	±3.19m to residential	
		Building A	±20.3m (Bldg A to Bldg	
EAST (RICHTER AVE.)	0.0m	Building F	±87.2m (Bldg F to PL)	
		Building B	±5.0m (Parkade to PL) ±3.05m (Townhouse to	
		Building E	±20.3m (Bldg E to Bldg	
		Building A	±4.1m (Bldg A to PL)	
DAYLIGHT ANGLE (IF A TOWER)	N/A	N/A		
PODIUM HEIGHT (IF PROPOSED)	N/A	N/A		
FLOOR PLATE SIZE (IF REQUIRED)	N/A	N/A		

BUILDING E & BUILDING A					
DDRESS	Building E: 1720 R				
EONI DECODIREION	Building A: 1710 R		elowna		
EGAL DESCRIPTION EVELOPMENT PERMIT AREA	LOT 1, Plan 92715		-NIT		
	CENTRAL GREEN				
XISTING ZONING XISTING LEGAL USE	CD22 CENTRAL C				
GRADES	2 EXISTING RENTAL BUILDINGS ON PARKADE EXISTING AVERAGE - LEVEL FINISH AVERAGE - LEVEL				
IUMBER OF BUILDINGS	BUILDING F: 5 ST				
OMBER OF BOILDINGS	BUILDING B: 5 ST				
	BUILDING E: 6 ST				
	BUILDING A: 6 ST				
DITERIA FOR	CD22 CENTI	RAI GREE	N CC	JMPREHE	NSIVE ZONE
CRITERIA FOR	ODZZ OLIVII	INAL OINEL	-14 00		NOIVE ZOIVE
ALL TYPES OF APPLICATION:	ZONING ST	ANDARD		PROPOS	SAL
ITE AREA (sm)	14,375			14,375	
SITE WIDTH (m)	N/A			N/A	
SITE DEPTH (m)	N/A			N/A	
PFF-STREET PARKING	358 stalls			393 stalls	
RIVATE OPEN SPACE	Building F	955 sm		Building F	391 sm
	Building B	1,269 sm		Building B	904 sm
	Building E	1,229 sm		Building E	1,038 sm
	Building A	957 sm		Building A	679 sm
	Total	4,410 sm		Total	10,573 sm
		-			
EIGHT OF BUILDING (S)/# OF STOREYS	72m MAX.			Building F	±20.5m / 5 storeys
				Building B	±20.5m / 5 storeys
				Building E	±22.7m / 6 storeys
				Building A	±22.7m / 6 storeys
ITE COVERAGE OF BUILDING(S) (%)	50% max.		Buildin	g F - Level 1	1,026 / 14,375 = 7.1± %
THE COVERAGE OF BOILDING(3) (70)	30 % IIIax.			g B - Level 1	1,439 / 14,375 = 10± %
				g E - Level 1	1,420 / 14,375 = 9.9± %
				g A - Level 1	1,250 / 14,375 = 8.7± %
		-	Total		35.7±%
ITE COVERAGE INCLUDING BUILDINGS,	N/A	<u>'</u>		N/A	
RIVEWAYS AND PARKING (%)					
DDITIONAL REQUIREMENTS FOR OMMERCIAL, INDUSTRIAL AND	CD22 CENTI	RAL GREE	EN CC	OMPREHE	NSIVE ZONE
IULTIPLE UNIT / INTENSIVE ESIDENTIAL APPLICATIONS:	ZONING ST	ANDARD		PROPOS	SAL
UMBER OF BICYCLE PARKING SPACES	Class I: 0.5 per dwelling unit x 400 units Total = 200 bikes min.			Class I: 200 bike racks within parkade	
	Class II: 0.1 per dw	elling unit x 400 Total = 40 bike			
UMBER OF LOADING SPACES	N/A			N/A	
RIVE AISLE WIDTH (m) (IF PROPOSED)	7.0m			6.0m / 7.0m	
ETBACKS TO PARKING (m):					
ORTH (FRONT,HARVEY AVE.)	N/A			N/A	
OUTH (REAR)	N/A			N/A	
VEST (SIDE)	3.0m			3.0m	
AST (SIDE,RICHTER AVE.)	N/A			N/A	
LOOR AREA NET	± 57,500sm max.	net area		Building F	4082.2 sm
				Building B	5736.9 sm
				Building E	7118.7 sm
				Building A	4,531.4 sm
LOOP AREA RATIO (T.A.E.)				Total	21,469 sm
LOOR AREA RATIO (F.A.R.)	4.0 may			21 469 / 14	375 = 1 /10

2019-11-04

No. Date Revision
1 2019-11-04 DP SUBMISSION Revision CENTRAL GREEN E & A

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Consultant Seal



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4.0 max.

FLOOR AREA RATIO (F.A.R.)

Drawn Checked

Drawing Number A1.01

21,469 / 14,375 = 1.49

BLDG E

BUILDING CODE REVIEW		(BUILDING E)				
	BUILDING E				PARKADE:	
OCCUPANCY	GROUP C	GROUP A2 (LEVEL1 ONLY)	GROUP D (LEVEL1 ONLY)	GROUP E (LEVEL1 ONLY)	GROUP F3 (LEVEL 0)	
ARTICLE	3.2.2.50	3.2.2.50 (5)	3.2.2.58	3.2.2.50 (5)	3.2.2.80	
NO. OF STOREYS	6 STOREY	6 STOREY	6 STOREY	6 STOREY	1	
NO. OF STREETS FACING	2	2	2	2	1	
BUILDING AREAS:	PROPOSED		CODE MAXIMUM		CODE MAXIMUM	
	±1,420sm		1,500sm/comp. 3.2.2.50 (I)		UNLIMITED	
CONSTRUCTION TYPE	COMBUSTIBLI	COMBUSTIBLE				
SPRINKLERED	YES				YES	
ASSEMBLY RATINGS:	·					
FLOOR	1 HR (LEVEL 1	-6)	2 HR @ CRU		2 HR	
WALLS / BEARING STRUCTURE	1 HR (LEVEL 1	-6)	2 HR @ CRU		2 HR	
ROOFS	1 HR	1 HR				

FIRE PROTECTIO	N:	3.2.4./ 3.2.5./ 3.2.6.
LOCATION OF HYDRANT TO SIAMESE CONNECTION	45 m MAX.	3.2.5.5.
STANDPIPE/HOSE	YES (IN EACH STAIR SHAF	T) 3.2.5.8.
SPRINKLERED	YES	
FIRE ALARM SYSTEM	YES	3.2.4.1.(2)(f)
EXIT LIGHTS	YES	
EMERGENCY LIGHTING	YES	

F	REQUIRED FIRE S	3.1.3.1.	
TE	ENANTS / MAJOR OCCUPANCIES		
GF	ROUP C TO C	1 HR	3.3.1.1.
GF	ROUP F3 TO C	2 HR	3.2.1.2.
GF	ROUP E TO C	2 HR	
GF	ROUP A2 TO C	2 HR	
GF	ROUP D TO C	1 HR	
SE	ERVICES ROOMS	1 HR	3.6.2.
JA	ANITOR ROOM	Non-Rated Fire Separation	

BUILDING FIRE SAFETY					
SOFFIT PROTECTION	N/A (SPRINKLERED)	3.2.3.16.			
FLAME SPREAD RATINGS	COMPLY WITH	3.1.13.2			
METAL DECK ASSEMBLIES	N/A	3.1.14.2.			
ROOF COVERING					
CLASSIFICATION	CLASS "A"	3.1.15.2.			
ATTIC FIRESTOPS	N/A	3.1.11.			
MAX. ATTIC AREA	N/A	3.1.11.5.			
MAX. CRAWLSPACE AREA	N/A	3.1.11.6.			
CONCEALED FLOOR AREA	N/A	3.1.11.5.			

OCCUPANT LOAD				
46sm / PERSON X 4,811 sm	105 PERSONS			
RESID. LEVELS:				
2 PERSONS/SLEEPING RMS x 23 RMS	46 PERSONS			
2 PERSONS/SLEEPING RMS x 23 RMS	46 PERSONS			
2 PERSONS/SLEEPING RMS x 27 RMS	54 PERSONS PER FLOOR			
COMMERCIAL UNITS:				
1 PERSON/ 3.7 SM x 198± SM	54 PERSONS			
	54 PERSONS			
	46sm / PERSON X 4,811 sm 2 PERSONS/SLEEPING RMS x 23 RMS 2 PERSONS/SLEEPING RMS x 23 RMS 2 PERSONS/SLEEPING RMS x 27 RMS			

EXIT FACILITIES		3.1 TO 3.6
REQUIRED EXITS	2 MIN. PER FLOOR	
	REQUIRED WIDTHS	PROVIDED WIDTHS
	min. 800mm door width as per 3.4.3.2.(A)	
	min. 1100mm stair width as per 3.4.3.2.(A)	
PARKADE LEVEL:	6.1mm/ person x 105 persons = 800 mm MIN.	4 doors @ 3'-0" = 12'-0" (3656mm)
RESIDENTIAL LEVELS:		
LEVEL 1 - 6 (doors)	6.1mm /person x 54 persons max = 800 mm MIN.	min. 2 doors @ 3'-0" width per floor = 6'-0" (1829mm)
LEVEL 1 - 6 (stairs)	8.0mm /person x 54 persons max = 1100 mm MIN.	min. 2 stairs @ 3'-10" width per floor = 7'-8" (2337mm)
COMMERCIAL UNITS:		
LEVEL 1 (doors)	6.1mm/ person x 54 persons max.	min. 2 doors @ 3'-0"
	= 800 mm MIN.	width = 6'-0" (1829mm)
EXIT THROUGH LOBBY	yes (NO for commercial)	3.4.4.2.
PANIC HARDWARE REQ'D	yes (at exterior stair & lobby doors)	3.4.6.16.(2)
EXIT EXPOSURE	ok	3.2.3.13.
MAX. TRAVEL DISTANCE	45m	3.4.2.5.(1)
EXIT RATINGS REQUIRED:		
STAIR SHAFTS	1 HR (2 HR @ Parkade / CRU)	3.4.4.1.
CORRIDORS	1 HR	3.3.2.6.(4)

ACCESSIBILITY REQUIREMENTS			
REQUIRED	PROVIDED		
YES	YES		
NO	YES		
CRU ONLY	CRU ONLY		
F	REQUIRED YES		

WASHROOM FIXTURES REQUIREMENTS	
MIN. 1 REQ'D./ DWELLING UNIT	3.7.2.2.(11)
WASHROOM REQUIREMENTS FOR CRU TO BE CONFIRMED BY TENANT DURING SEPALEASEHOLD IMPROVEMENTS PERMIT APPLICATION (N.I.C.)	RATE

SPATIAL SEPARATION:		3.2.3.1.E	3.2.3.1.D
	NORTH/SOUTH WALLS	EAST WALL	WEST WALL
WALL AREA	window openings & walls	± 68.7 sm	± 21.0 sm
OPENING AREA	construction un-restricted. limiting distance exceeds 8.0m in all cases. or building faces a street in accordance with 3.2.3.10.(2)	± 28.5 sm	± 1.4 sm
% PROVIDED		± 41.5 %	± 6.6 %
LIMITING DISTANCE		± 12.5 m	± 3.19 m
% PERMITTED		100 %	± 60 %
CONSTRUCTION TYPE		COMBUST.	COMBUST.
CLADDING MATERIAL		NON-COMBUST.	NON-COMBUST.
REQUIRED RATINGS	(BEARING WALLS)	2 HR (CRU ONLY)	1 HR

BLDG A

BUILDING CODE REV	/IEW	(BUILDIN	NG A)			
	BUILDING E					PARKADE:
OCCUPANCY	GROUP C	GROUP A2 (LEVEL1 ONLY)	GROUP D (LEVEL1 ONLY)	GROUP E (LEVEL1 ONLY)	GROUP F3 (LEVEL1 ONLY)	GROUP F3 (LEVEL 0)
ARTICLE	3.2.2.50	3.2.2.50 (5)	3.2.2.58	3.2.2.50 (5)	3.2.2.50 (5)	3.2.2.80
NO. OF STOREYS	6 STOREY	6 STOREY	6 STOREY	6 STOREY	6 STOREY	1
NO. OF STREETS FACING	2	2	2	2	2	1
BUILDING AREAS:	PROPOSED		CODE MAXIMUI	VI		CODE MAXIMUM
•	±1,250sm		1,500sm/comp. 3	3.2.2.50 (I)		UNLIMITED
CONSTRUCTION TYPE	COMBUSTIBLE					NON-COMBUST.
SPRINKLERED	YES					YES
ASSEMBLY RATINGS:						
FLOOR	1 HR (LEVEL 2-	6)	2 HR (LEVEL 1)		2 HR
WALLS / BEARING STRUCTURE	1 HR (LEVEL 2-	6)	2 HR (LEVEL 1)		2 HR
ROOFS	1 HR					2 HR
NOTE: PARKADE (LEVEL 0) TO BE CONS	IDERED AS A SE	PARATE BUILDIN	NG IN ACCORDA	NCE WITH 3.2.1.2	2	

FIRE PROTECTION	N:	3.2.4./ 3.2.5./ 3.2.6.	
LOCATION OF HYDRANT TO			
SIAMESE CONNECTION	45 m MAX.	3.2.5.5.	
STANDPIPE/HOSE	YES (IN EACH STAIR SHAFT	3.2.5.8.	
SPRINKLERED	YES		
FIRE ALARM SYSTEM	YES	3.2.4.1.(2)(f)	
EXIT LIGHTS	YES		
EMERGENCY LIGHTING	YES		

REQUIRED FIRE S	3.1.3.1.	
TENANTS / MAJOR OCCUPANCIES		
GROUP C TO C	1 HR	3.3.1.1.
GROUP F3 TO C	2 HR	3.2.1.2.
GROUP E TO C	2 HR	
GROUP A2 TO C	2 HR	
GROUP D TO C	1 HR	
SERVICES ROOMS	1 HR	3.6.2.
JANITOR ROOM	Non-Rated Fire Separation	

BUILDING FIRE S	SAFETY	
SOFFIT PROTECTION	N/A (SPRINKLERED)	3.2.3.16.
FLAME SPREAD RATINGS	COMPLY WITH	3.1.13.2
METAL DECK ASSEMBLIES	N/A	3.1.14.2.
ROOF COVERING		
CLASSIFICATION	CLASS "A"	3.1.15.2.
ATTIC FIRESTOPS	N/A	3.1.11.
MAX. ATTIC AREA	N/A	3.1.11.5.
MAX. CRAWLSPACE AREA	N/A	3.1.11.6.
CONCEALED FLOOR AREA	N/A	3.1.11.5.

OCCUPANT LOAD		TABLE 3.1.17.1.
PARKADE LEVEL:	46sm / PERSON X 4,811 sm	105 PERSONS
RESID. LEVELS :		
LEVEL 1	NO RESIDENTIAL @ LEVEL 1	-
LEVEL 2	2 PERSONS/SLEEPING RMS x 18 RMS	36 PERSONS
LEVEL 3 TO 6	2 PERSONS/SLEEPING RMS x 23 RMS	46 PERSONS PER FLOOR
COMMERCIAL UNITS :		
LEVEL 1 CRU	1 PERSON/ 3.7 SM x 417± SM	113 PERSONS
TOTAL COMMERCIAL		113 PERSONS

EXIT FACILITIES		3.1 TO 3.6
REQUIRED EXITS	2 MIN. PER FLOOR	
	REQUIRED WIDTHS	PROVIDED WIDTHS
	min. 800mm door width as per 3.4.3.2.(A)	
	min. 1100mm stair width as per 3.4.3.2.(A)	
PARKADE LEVEL:	6.1mm/ person x 105 persons = 800 mm MIN.	4 doors @ 3'-0" = 12'-0" (3656mm)
RESIDENTIAL LEVELS:		
LEVEL 1 - 6 (doors)	6.1mm /person x 46 persons max = 800 mm MIN.	min. 2 doors @ 3'-0" width per floor = 6'-0" (1829mm)
LEVEL 1 - 6 (stairs)	8.0mm /person x 46 persons max = 1100 mm MIN.	min. 2 stairs @ 3'-10" width per floor = 7'-8" (2337mm)
COMMERCIAL UNITS:		
LEVEL 1 (doors)	6.1mm/ person x 113 persons max.	min. 2 doors @ 3'-0"
	= 800 mm MIN.	width = 6'-0" (1829mm)
EXIT THROUGH LOBBY	yes (NO for commercial)	3.4.4.2
PANIC HARDWARE REQ'D	yes (at exterior stair & lobby doors)	3.4.6.16.(2
EXIT EXPOSURE	ok	3.2.3.13
MAX. TRAVEL DISTANCE	45m	3.4.2.5.(1
EXIT RATINGS REQUIRED:		
STAIR SHAFTS	1 HR (2 HR @ Parkade / CRU)	3.4.4.1
CORRIDORS	1 HR	3.3.2.6.(4

UIRED	PROVIDED
	YES
	YES
ONLY	CRU ONLY

WASHROOM FIXTURES REQUIREMENTS		
MIN. 1 REQ'D./ DWELLING UNIT	3.7.2.2.(11)	
WASHROOM REQUIREMENTS FOR CRU TO BE CONFIRMED BY TENANT DURING SEPARATE LEASEHOLD IMPROVEMENTS PERMIT APPLICATION (N.I.C.)		

SPATIAL SE	3.2.3.1.D	
	NORTH/SOUTH/EAST WALLS	WEST WALL
WALL AREA	window openings & walls	± 27.3 sm
OPENING AREA	8.0m in all cases. or building faces a street in accordance with	± 10.1 sm
% PROVIDED		± 37.1 %
LIMITING DISTANCE		± 12.5 m
% PERMITTED		100 %
CONSTRUCTION TYPE		COMBUST.
CLADDING MATERIAL		NON-COMBUST.
REQUIRED RATINGS	(BEARING WALLS)	1 HR

2019-11-04

 No.
 Date
 Revision

 1
 2019-11-04
 DP SUBMISSION
 Revision

Project Title CENTRAL GREEN E & A

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Consultant Seal




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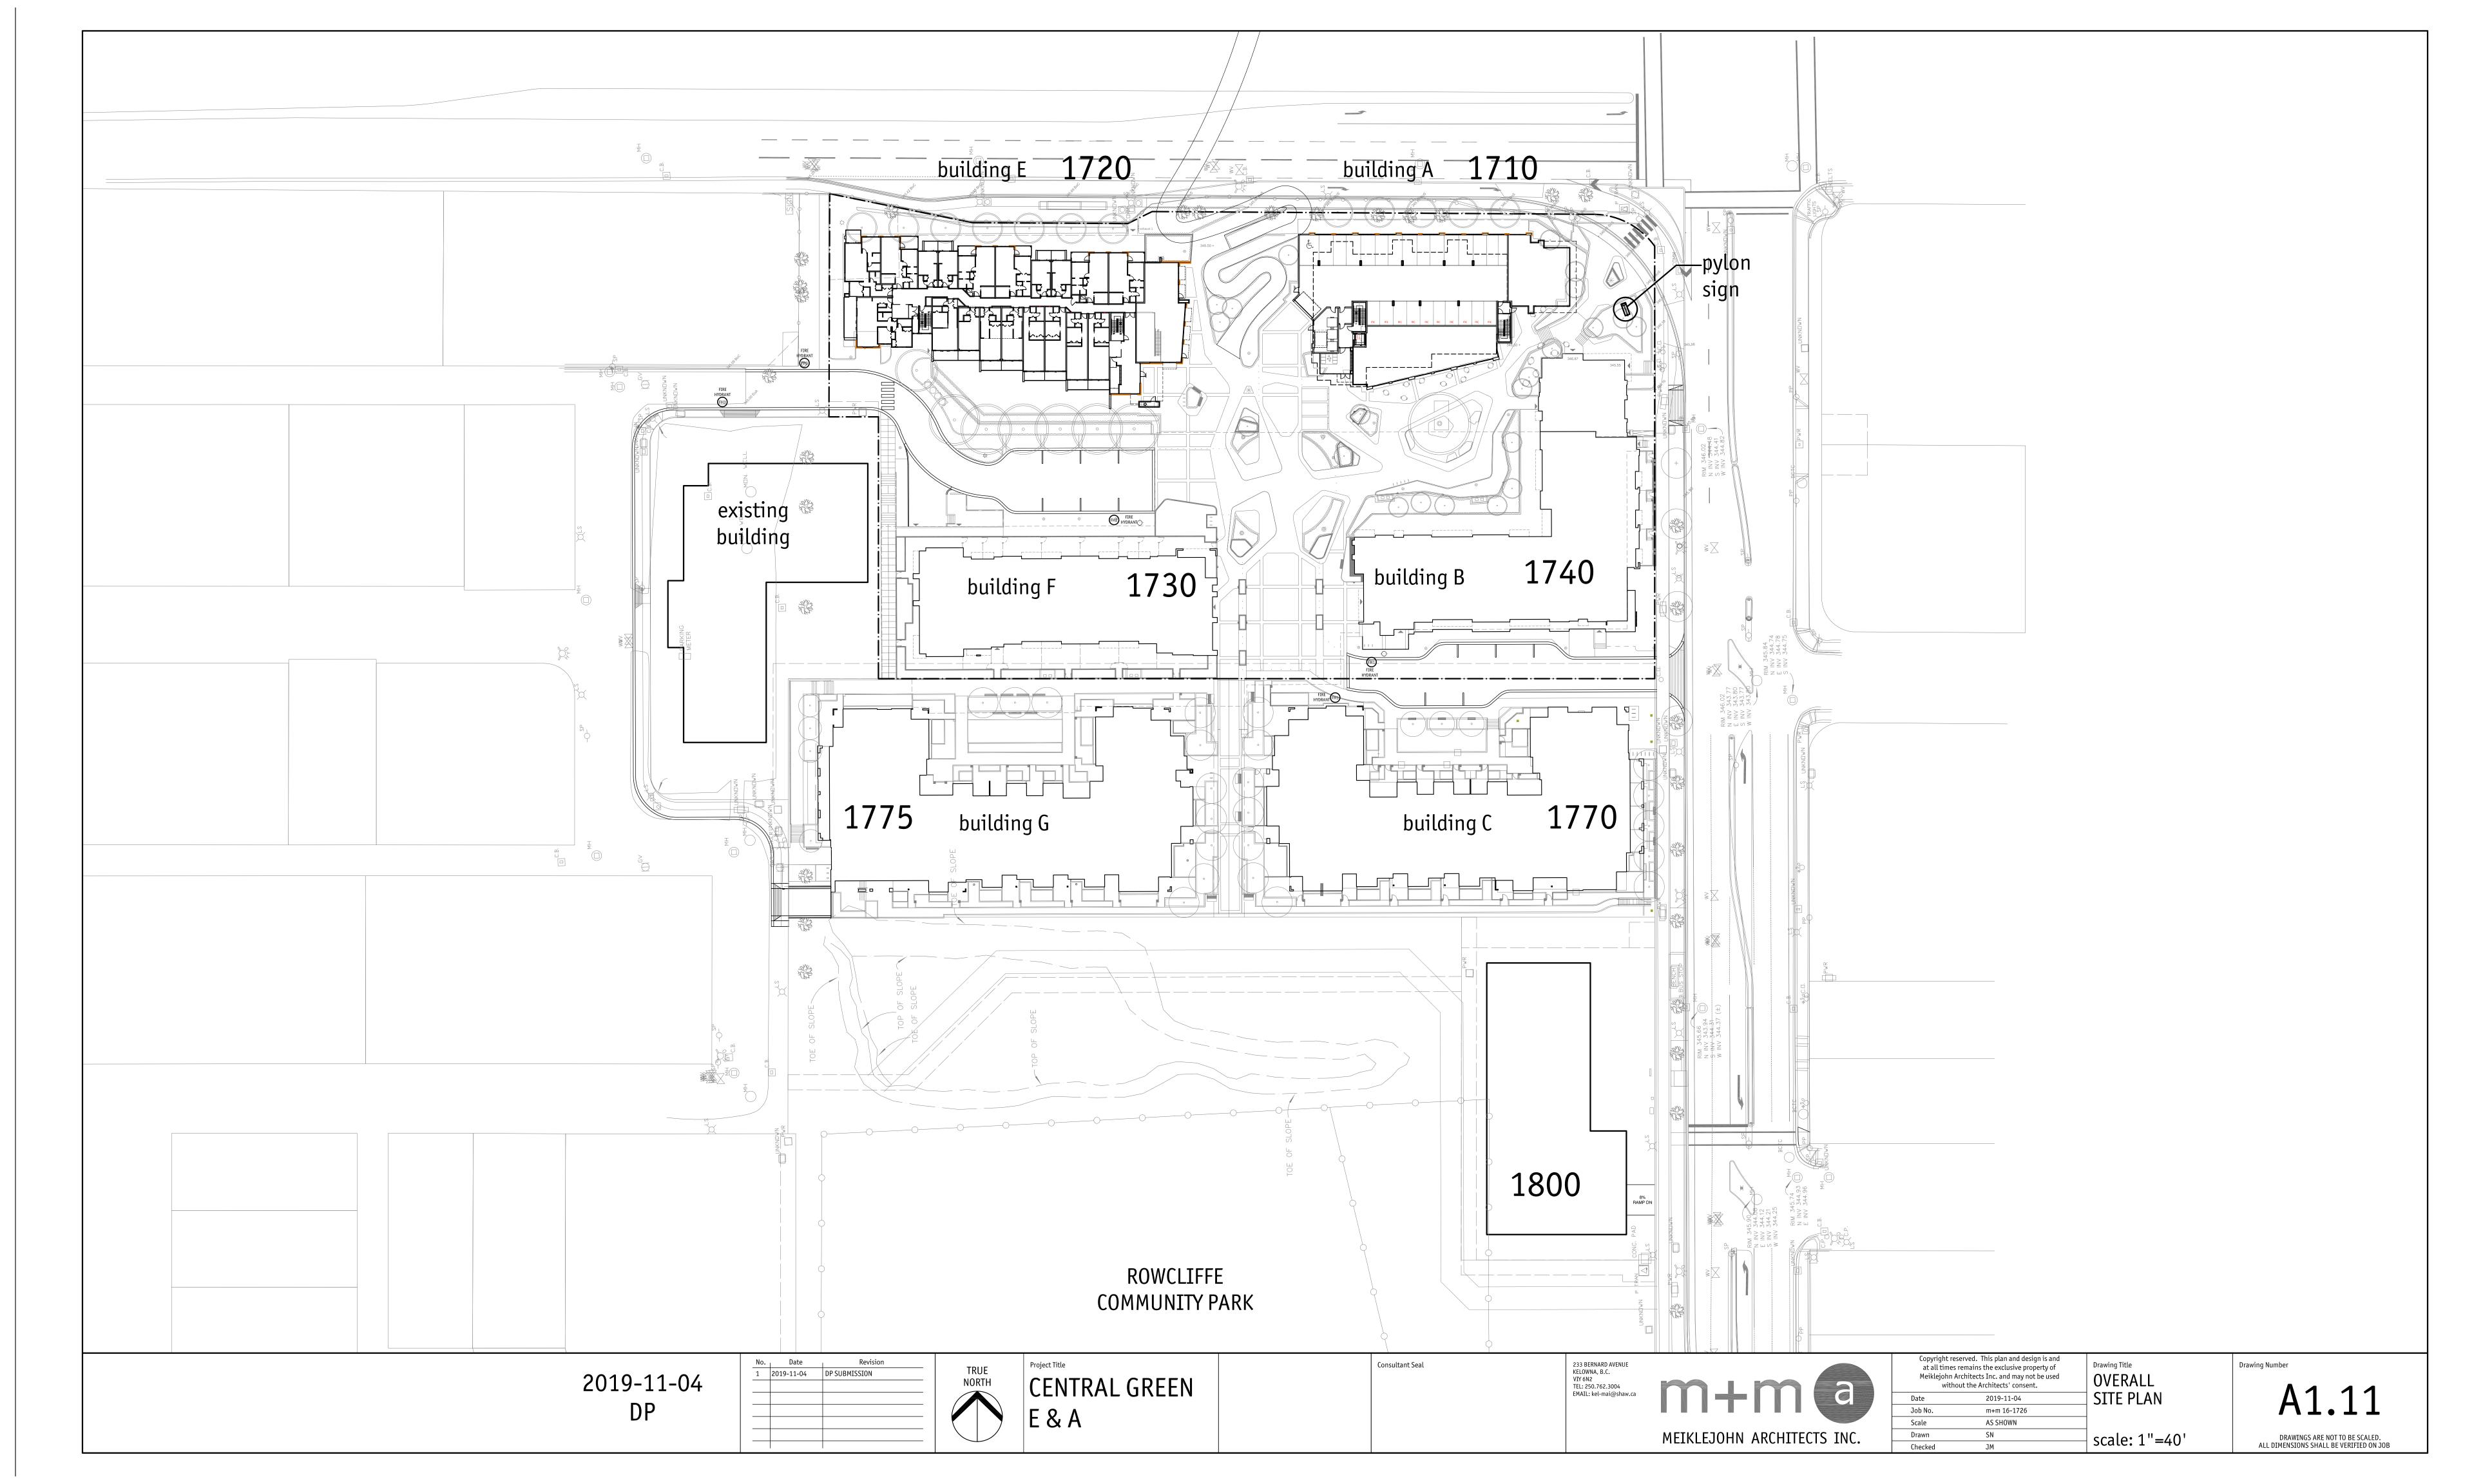
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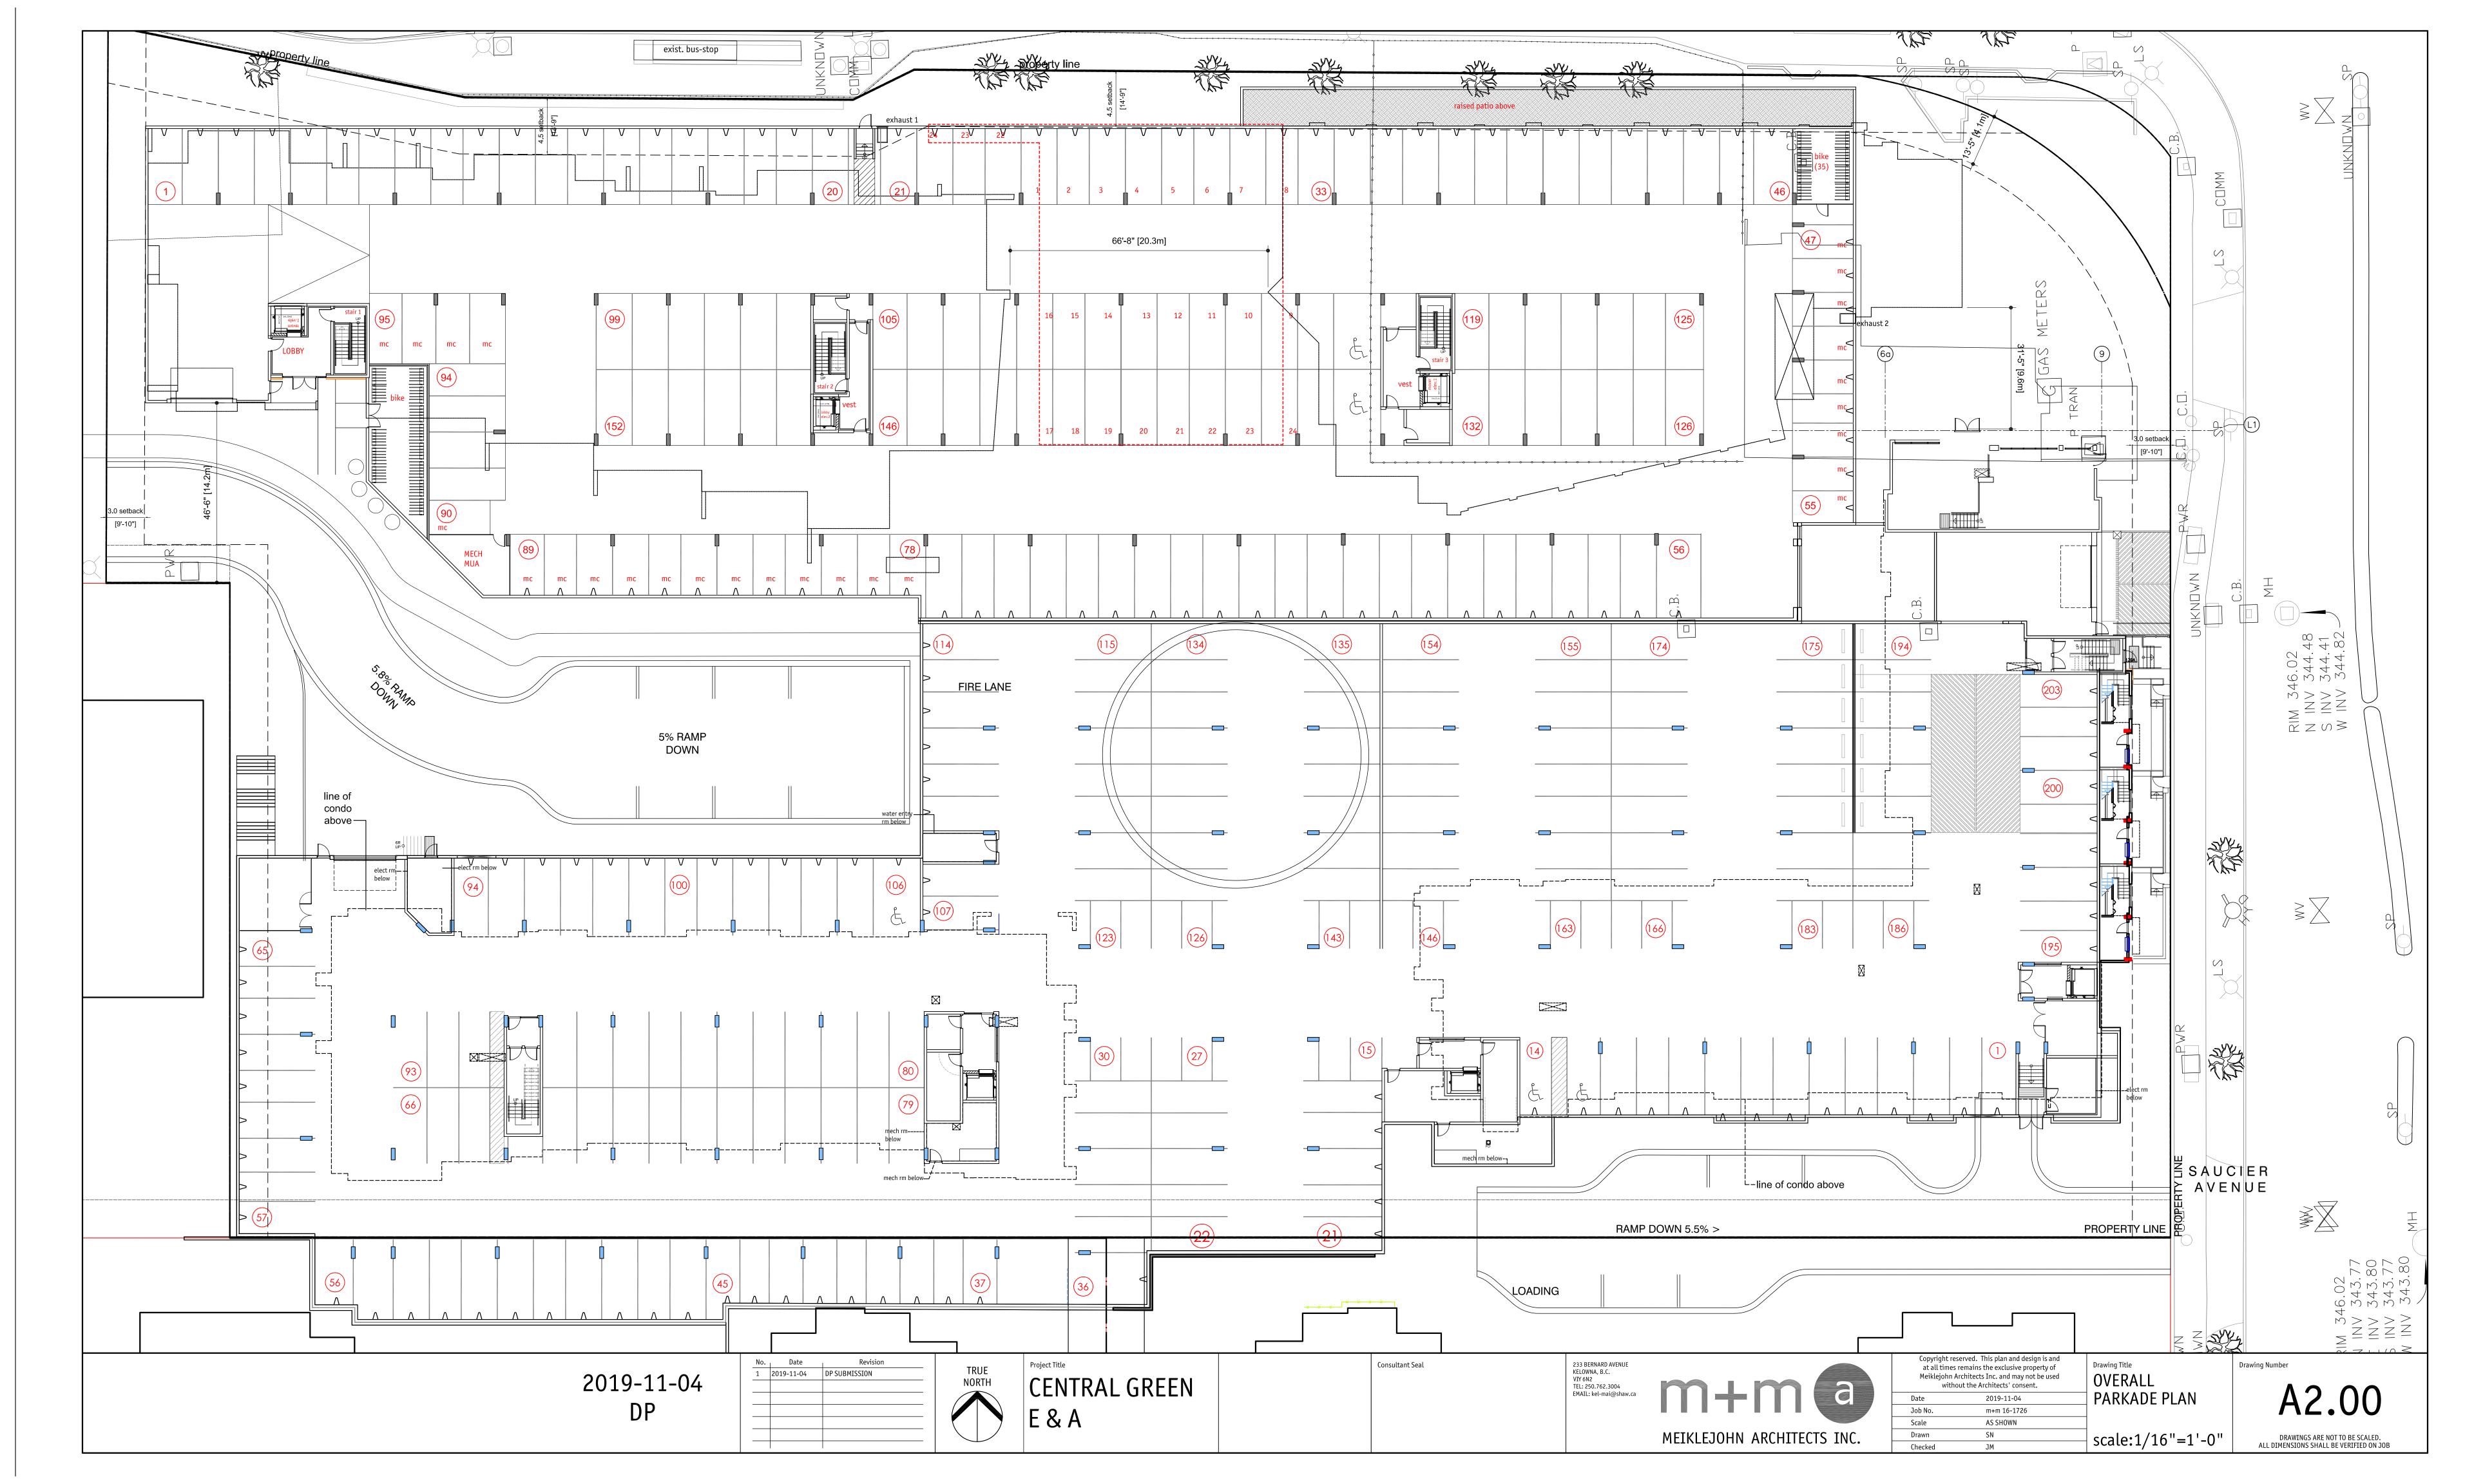
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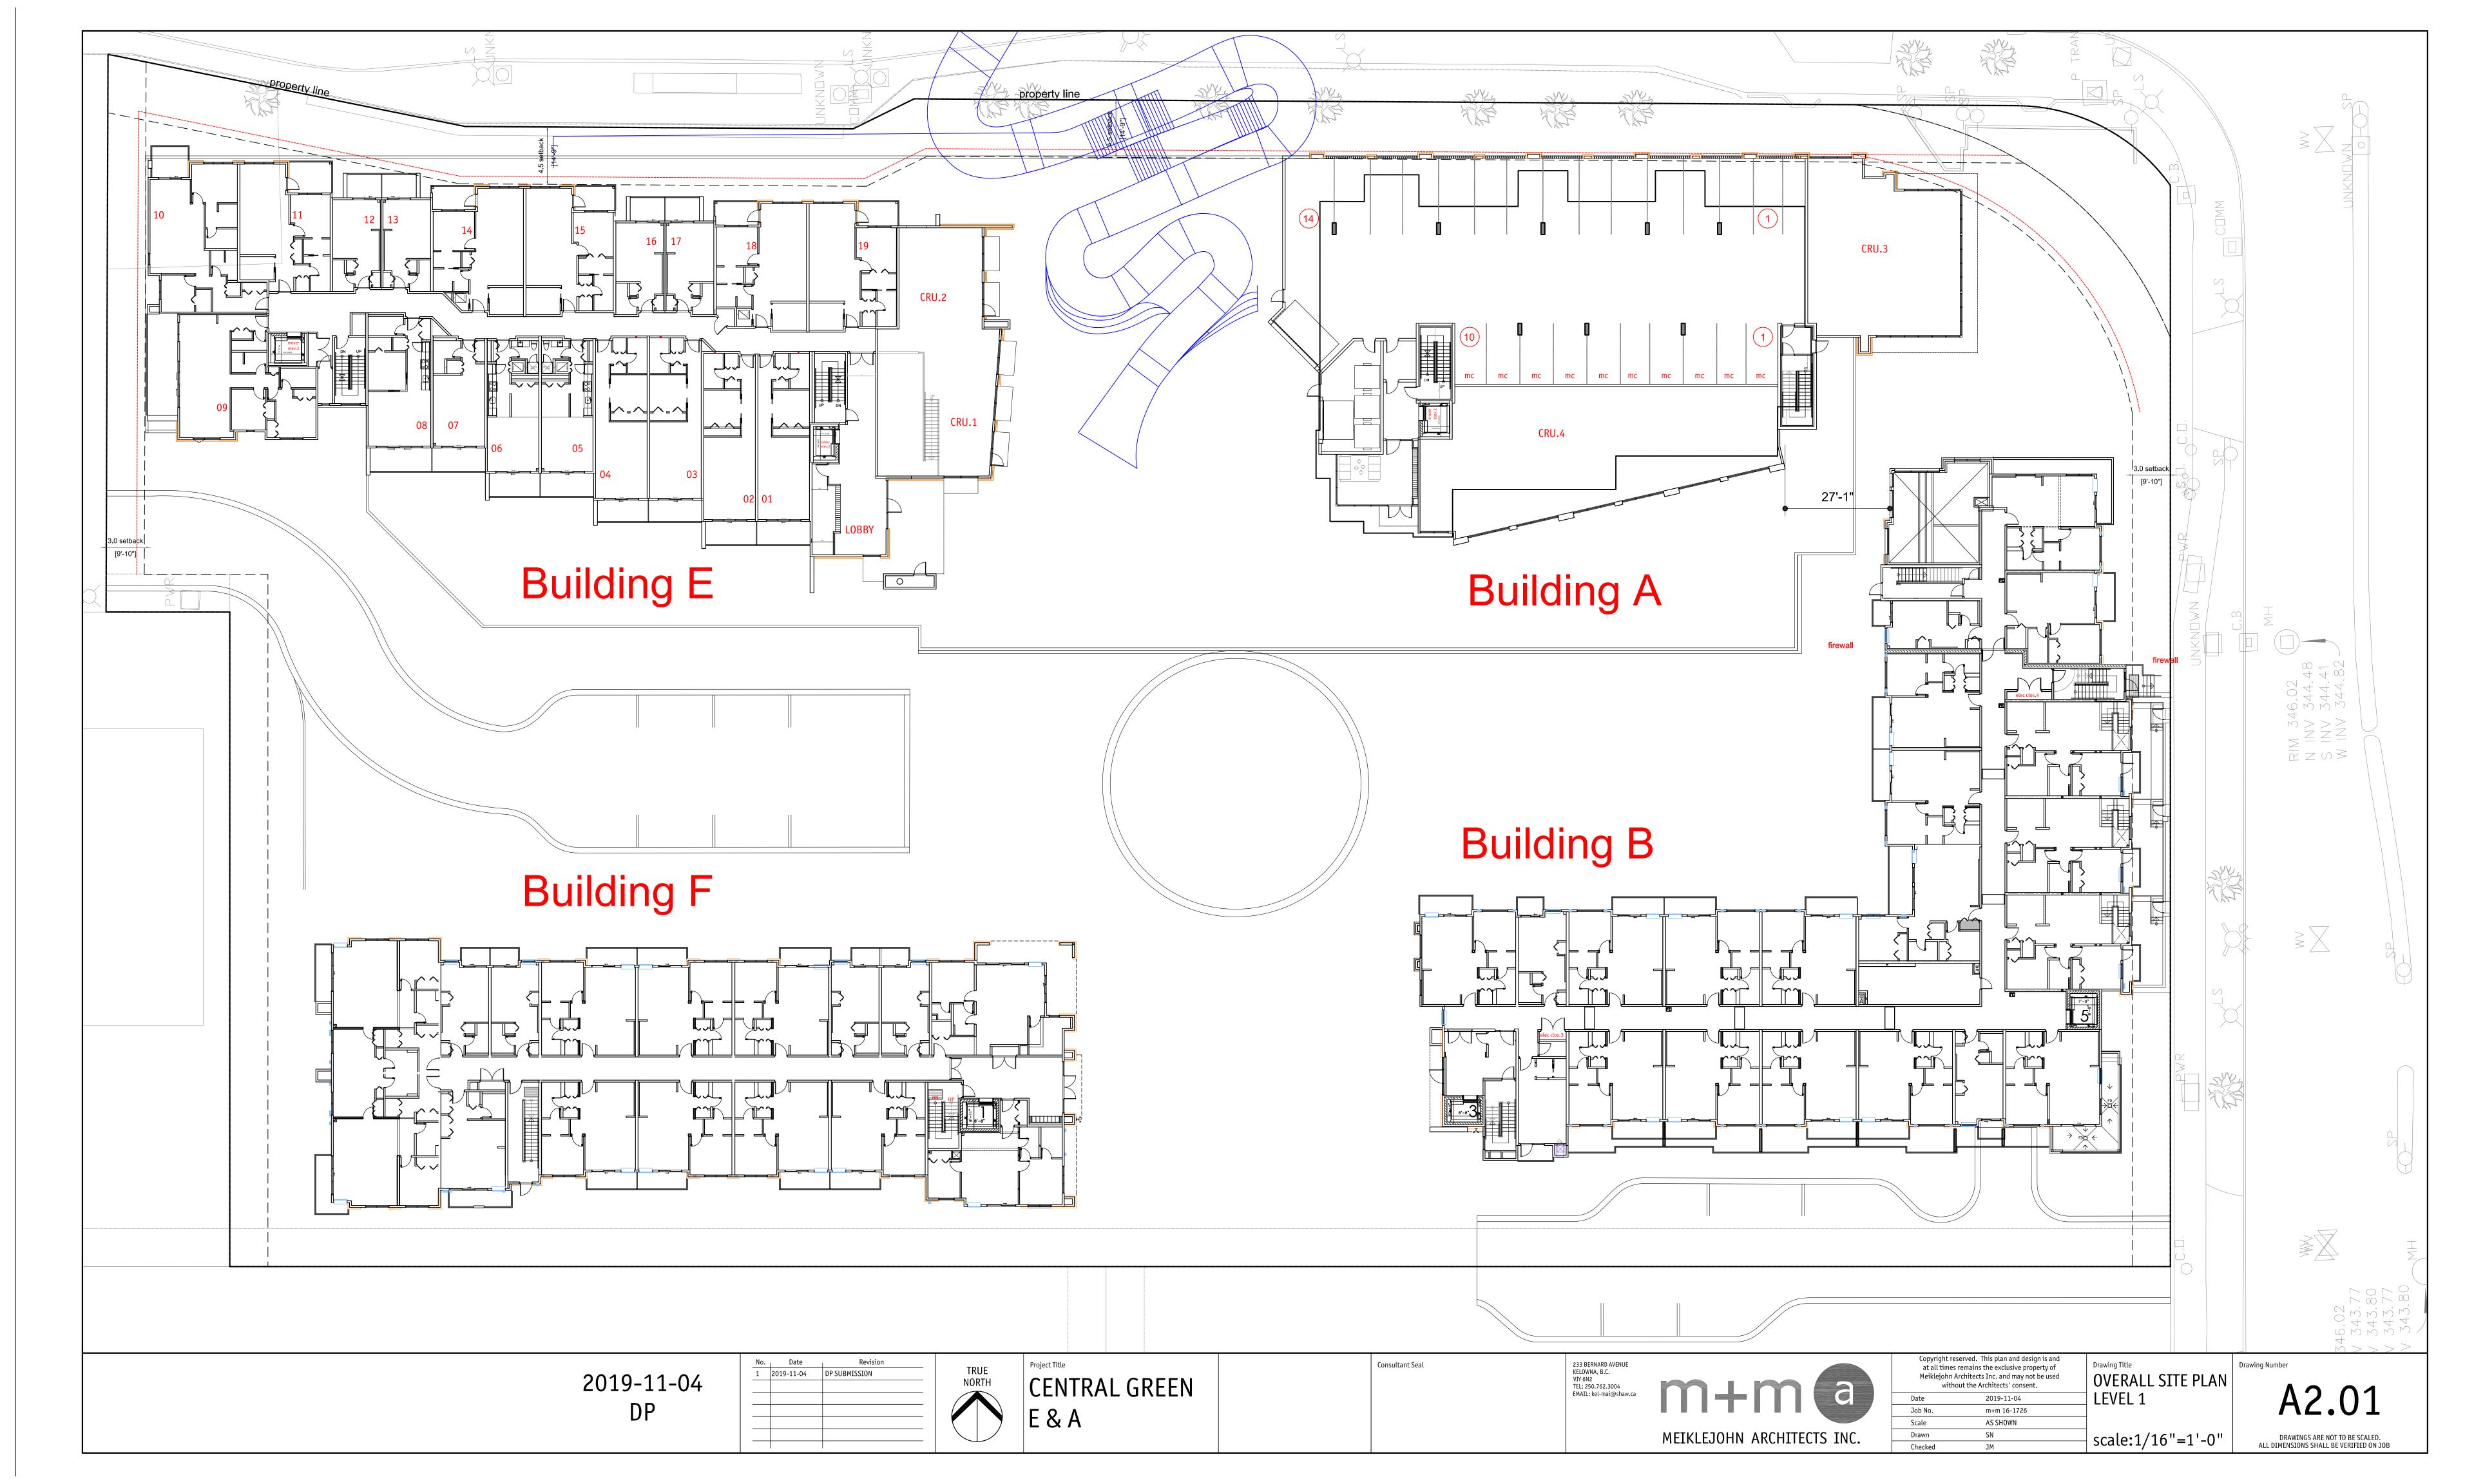
CODE SUMMARY


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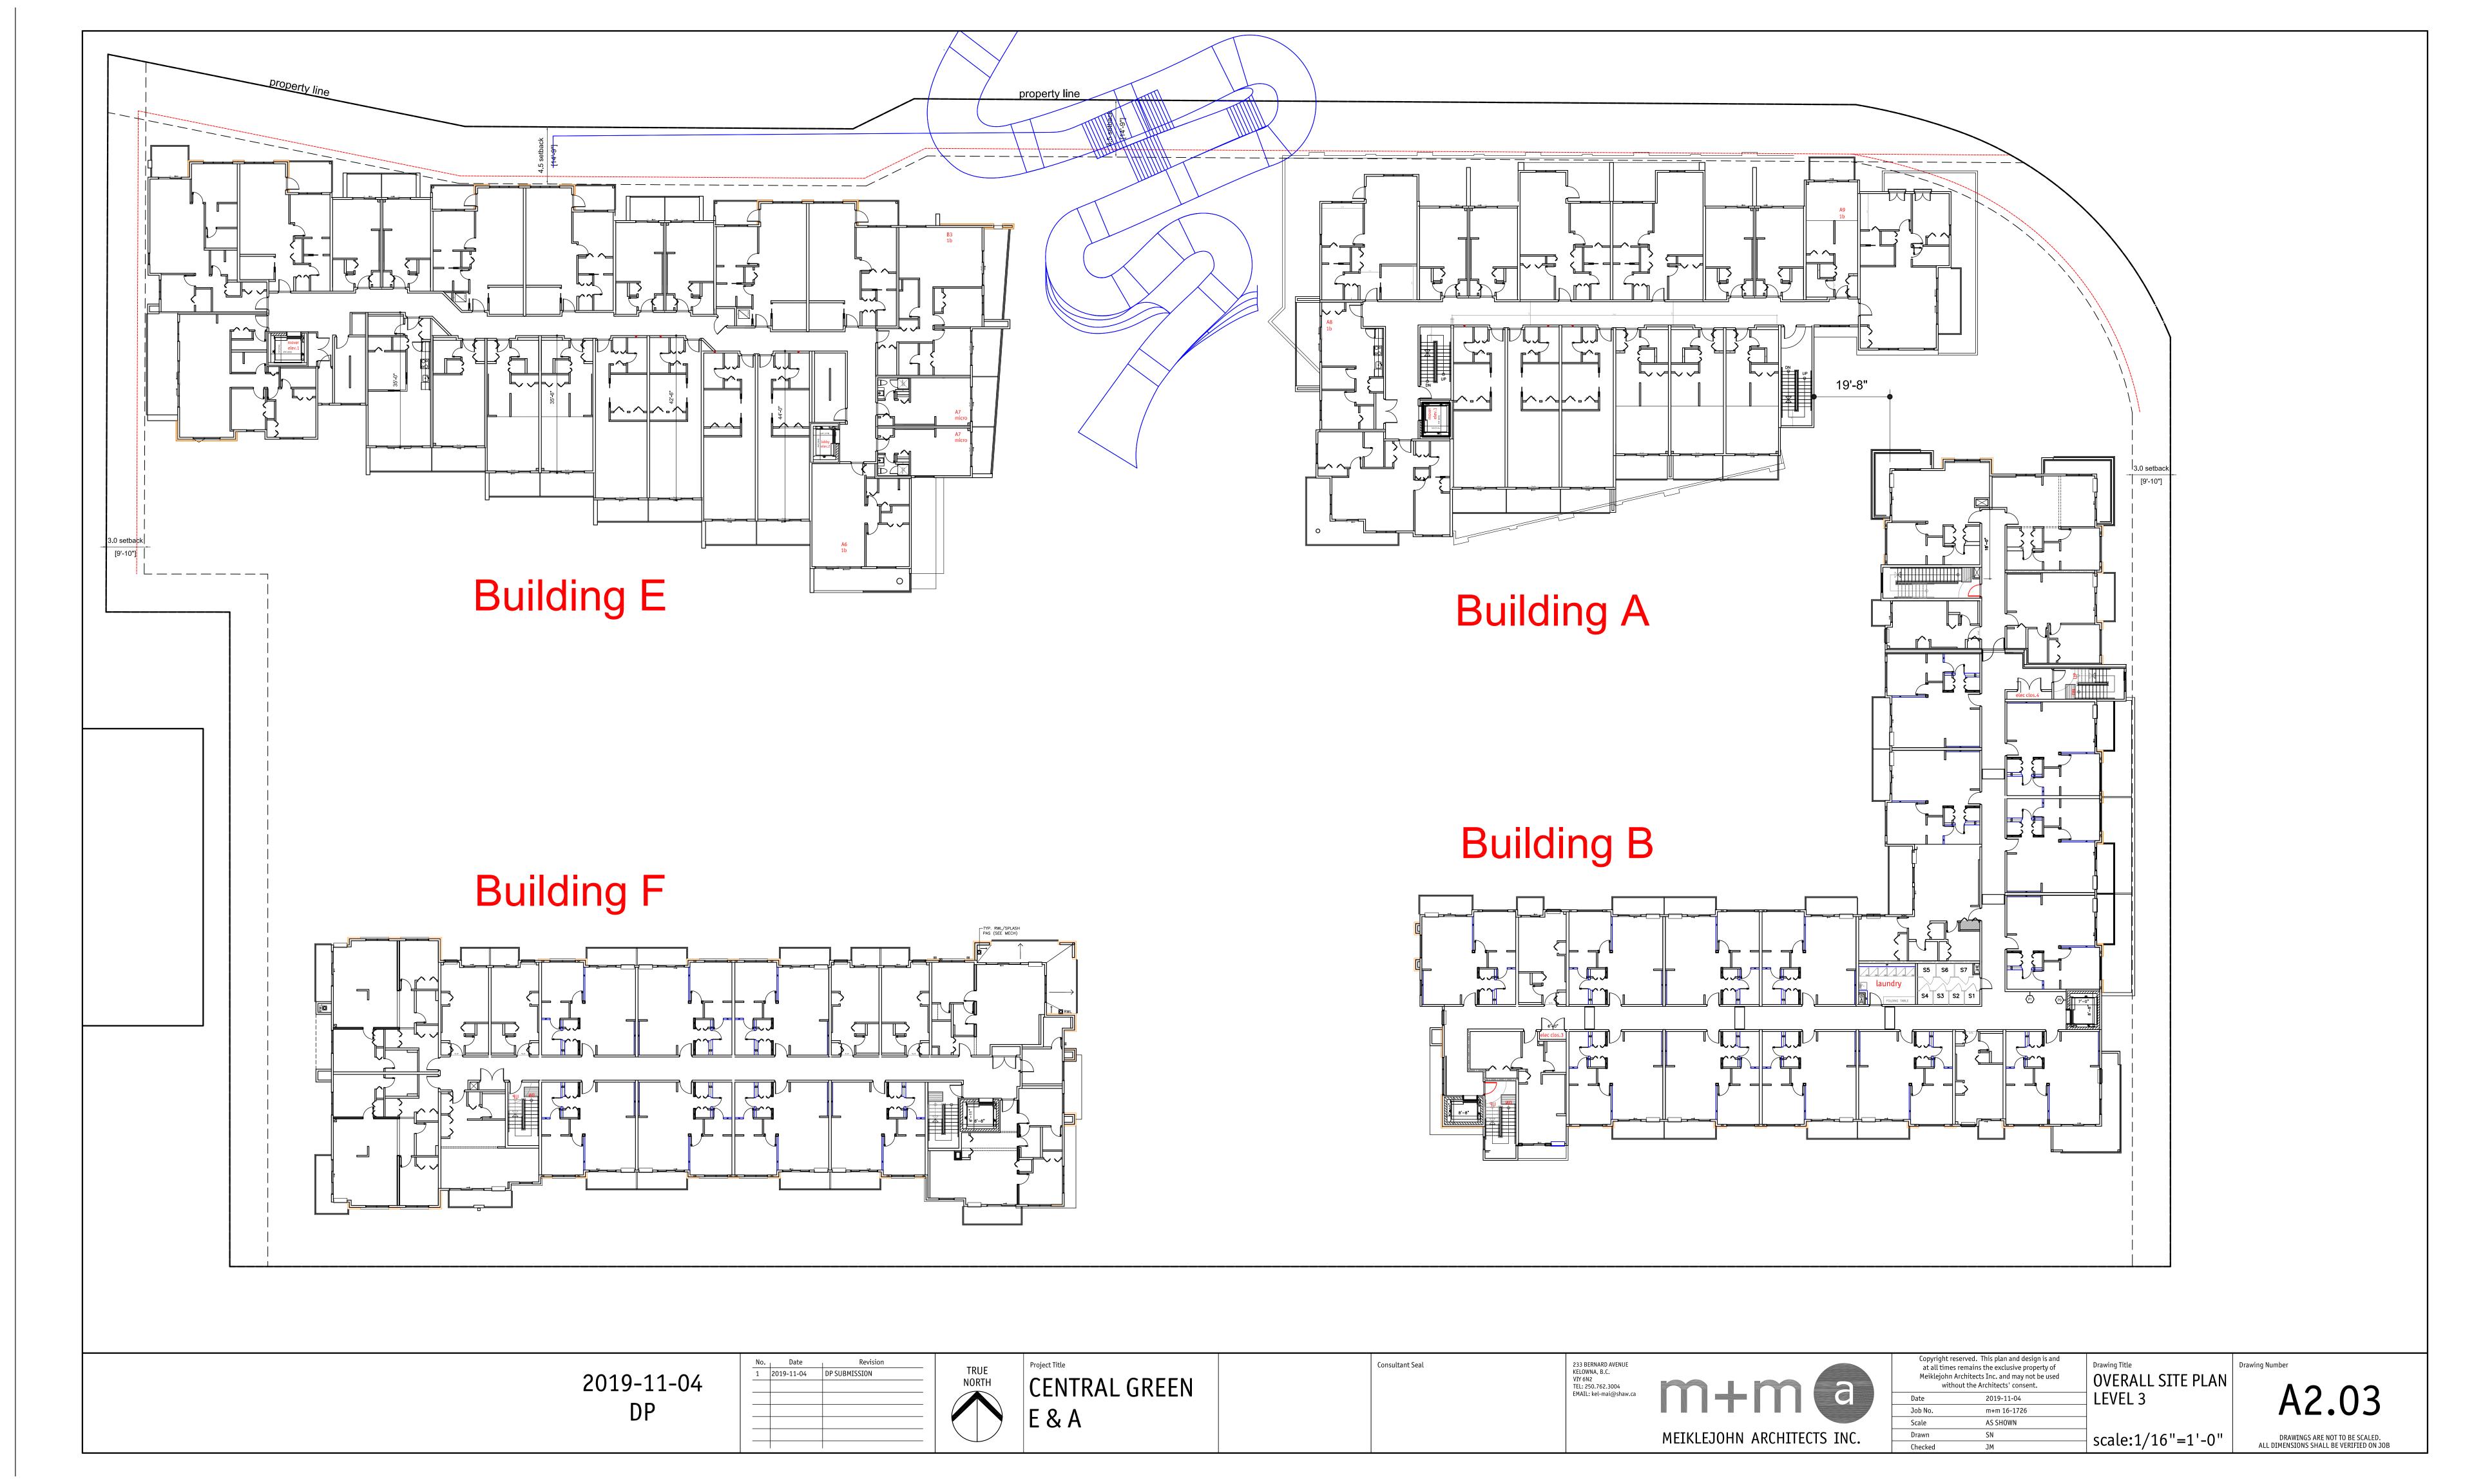











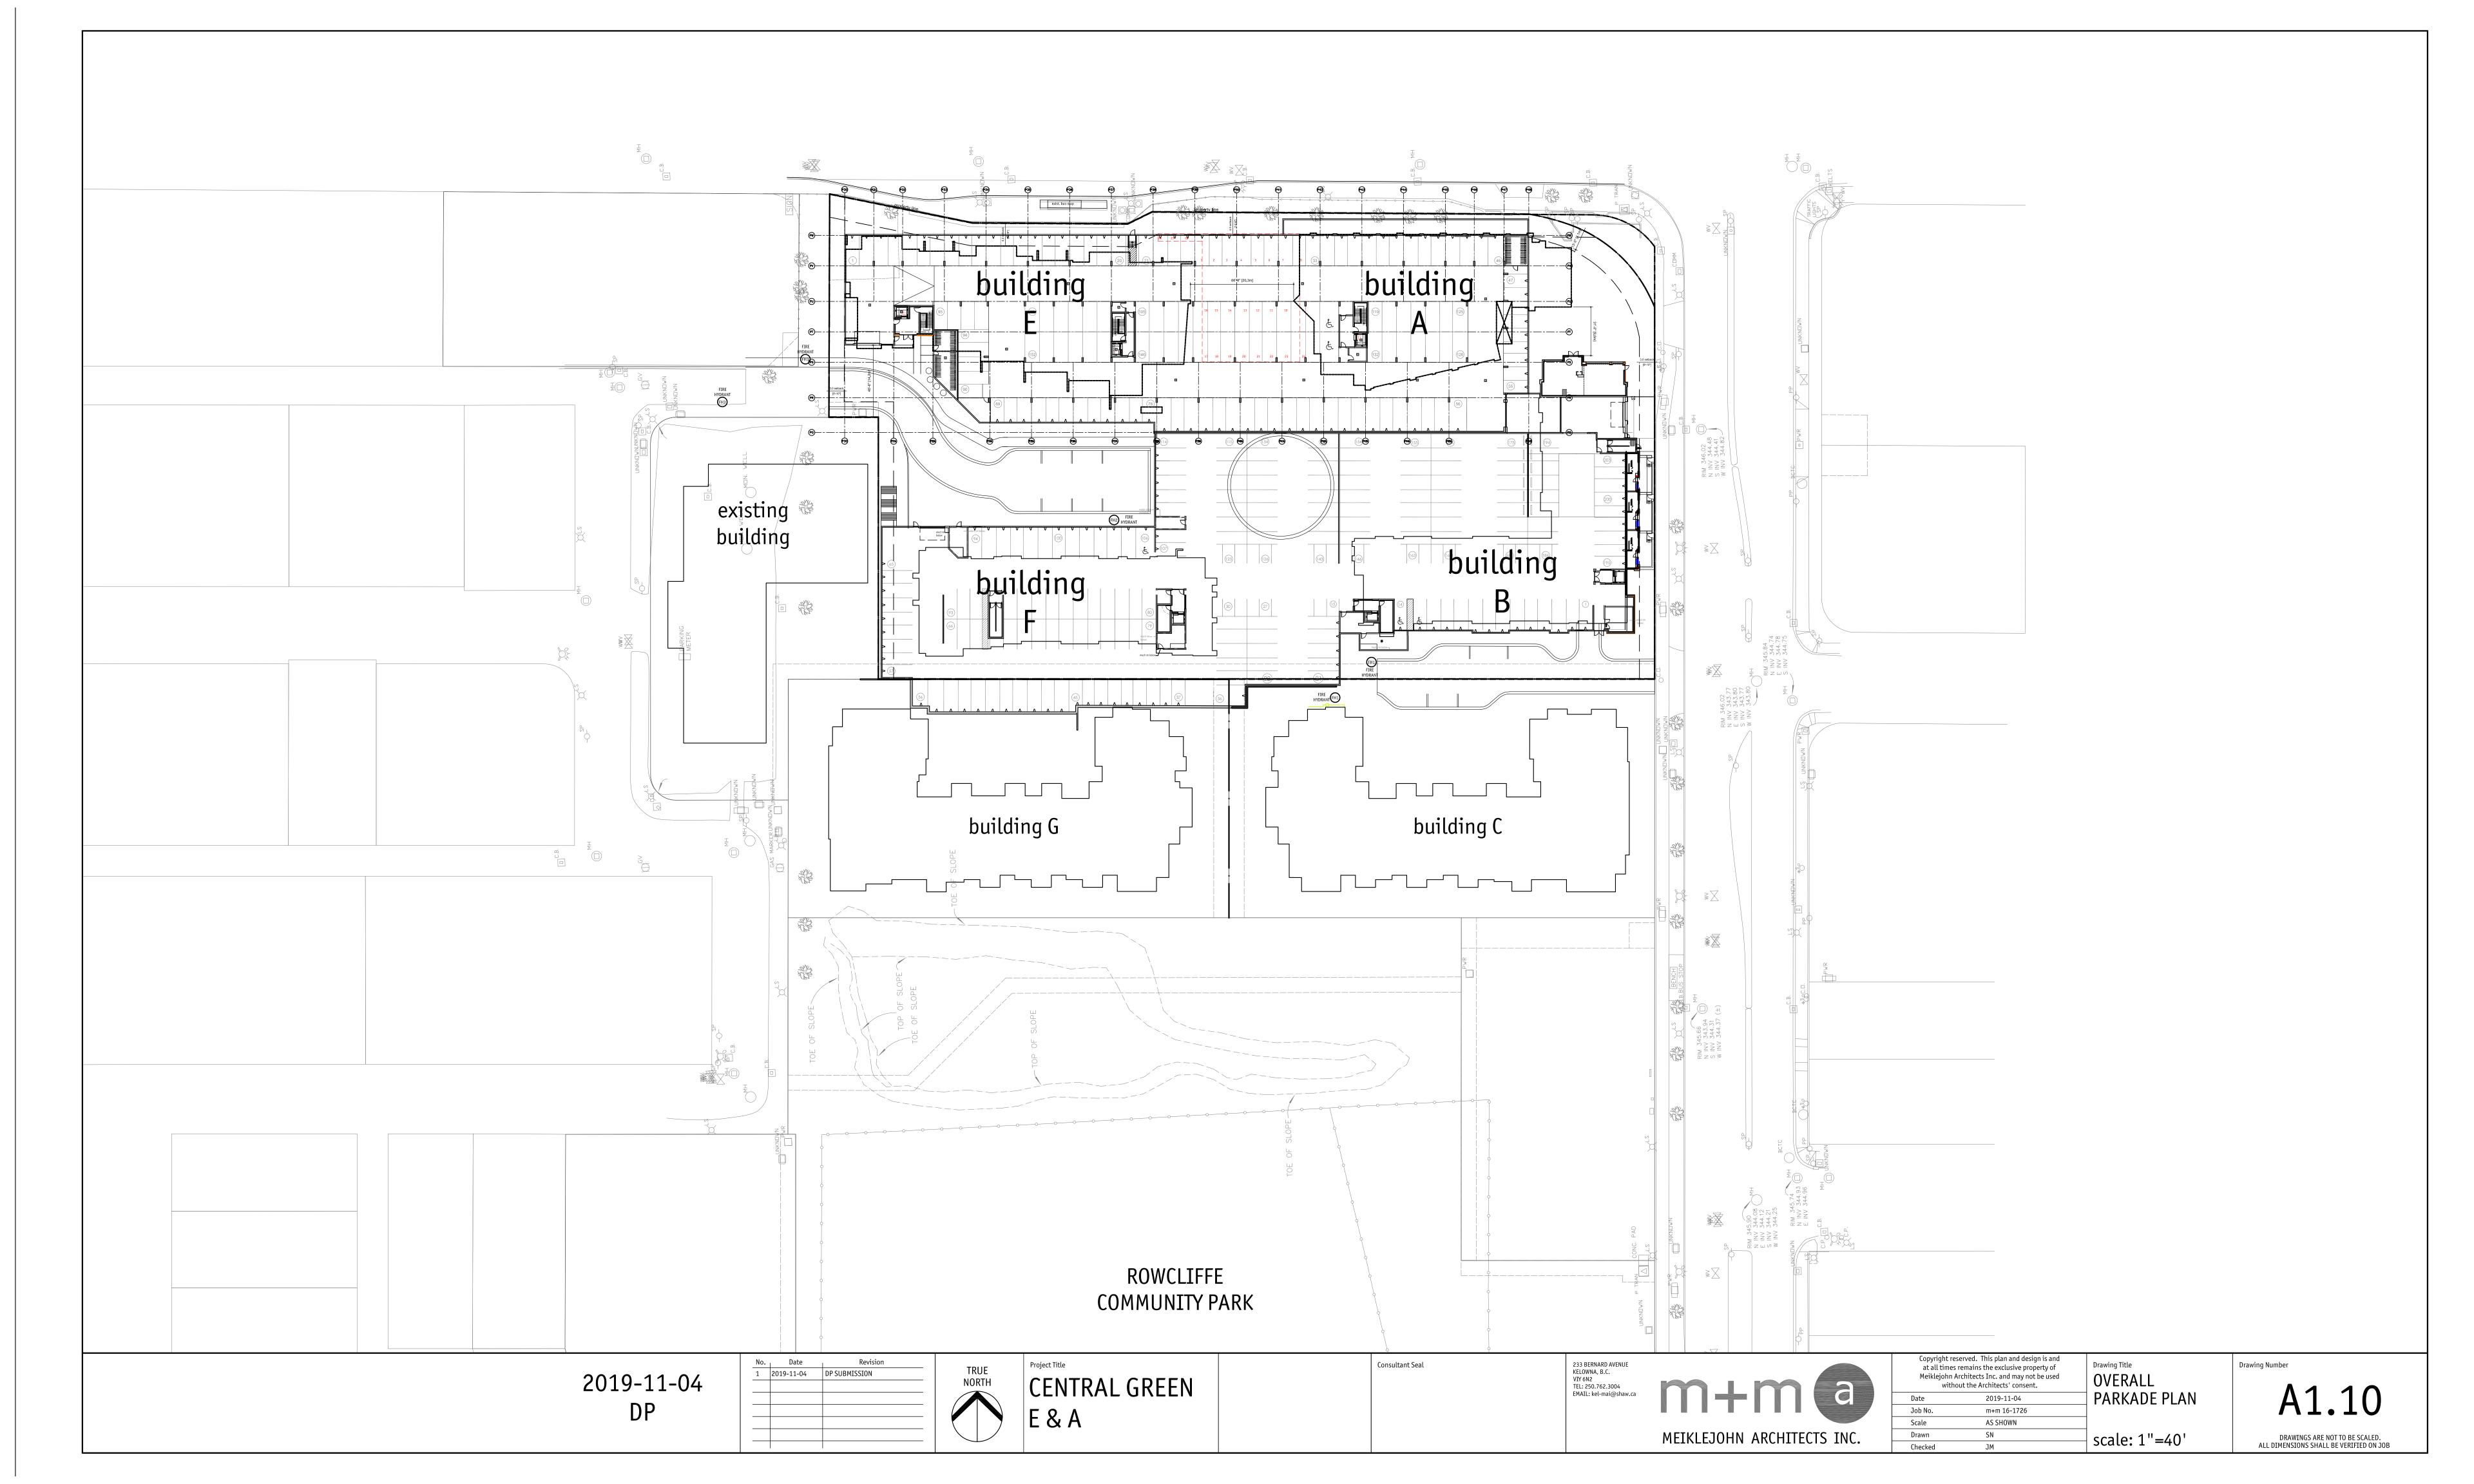


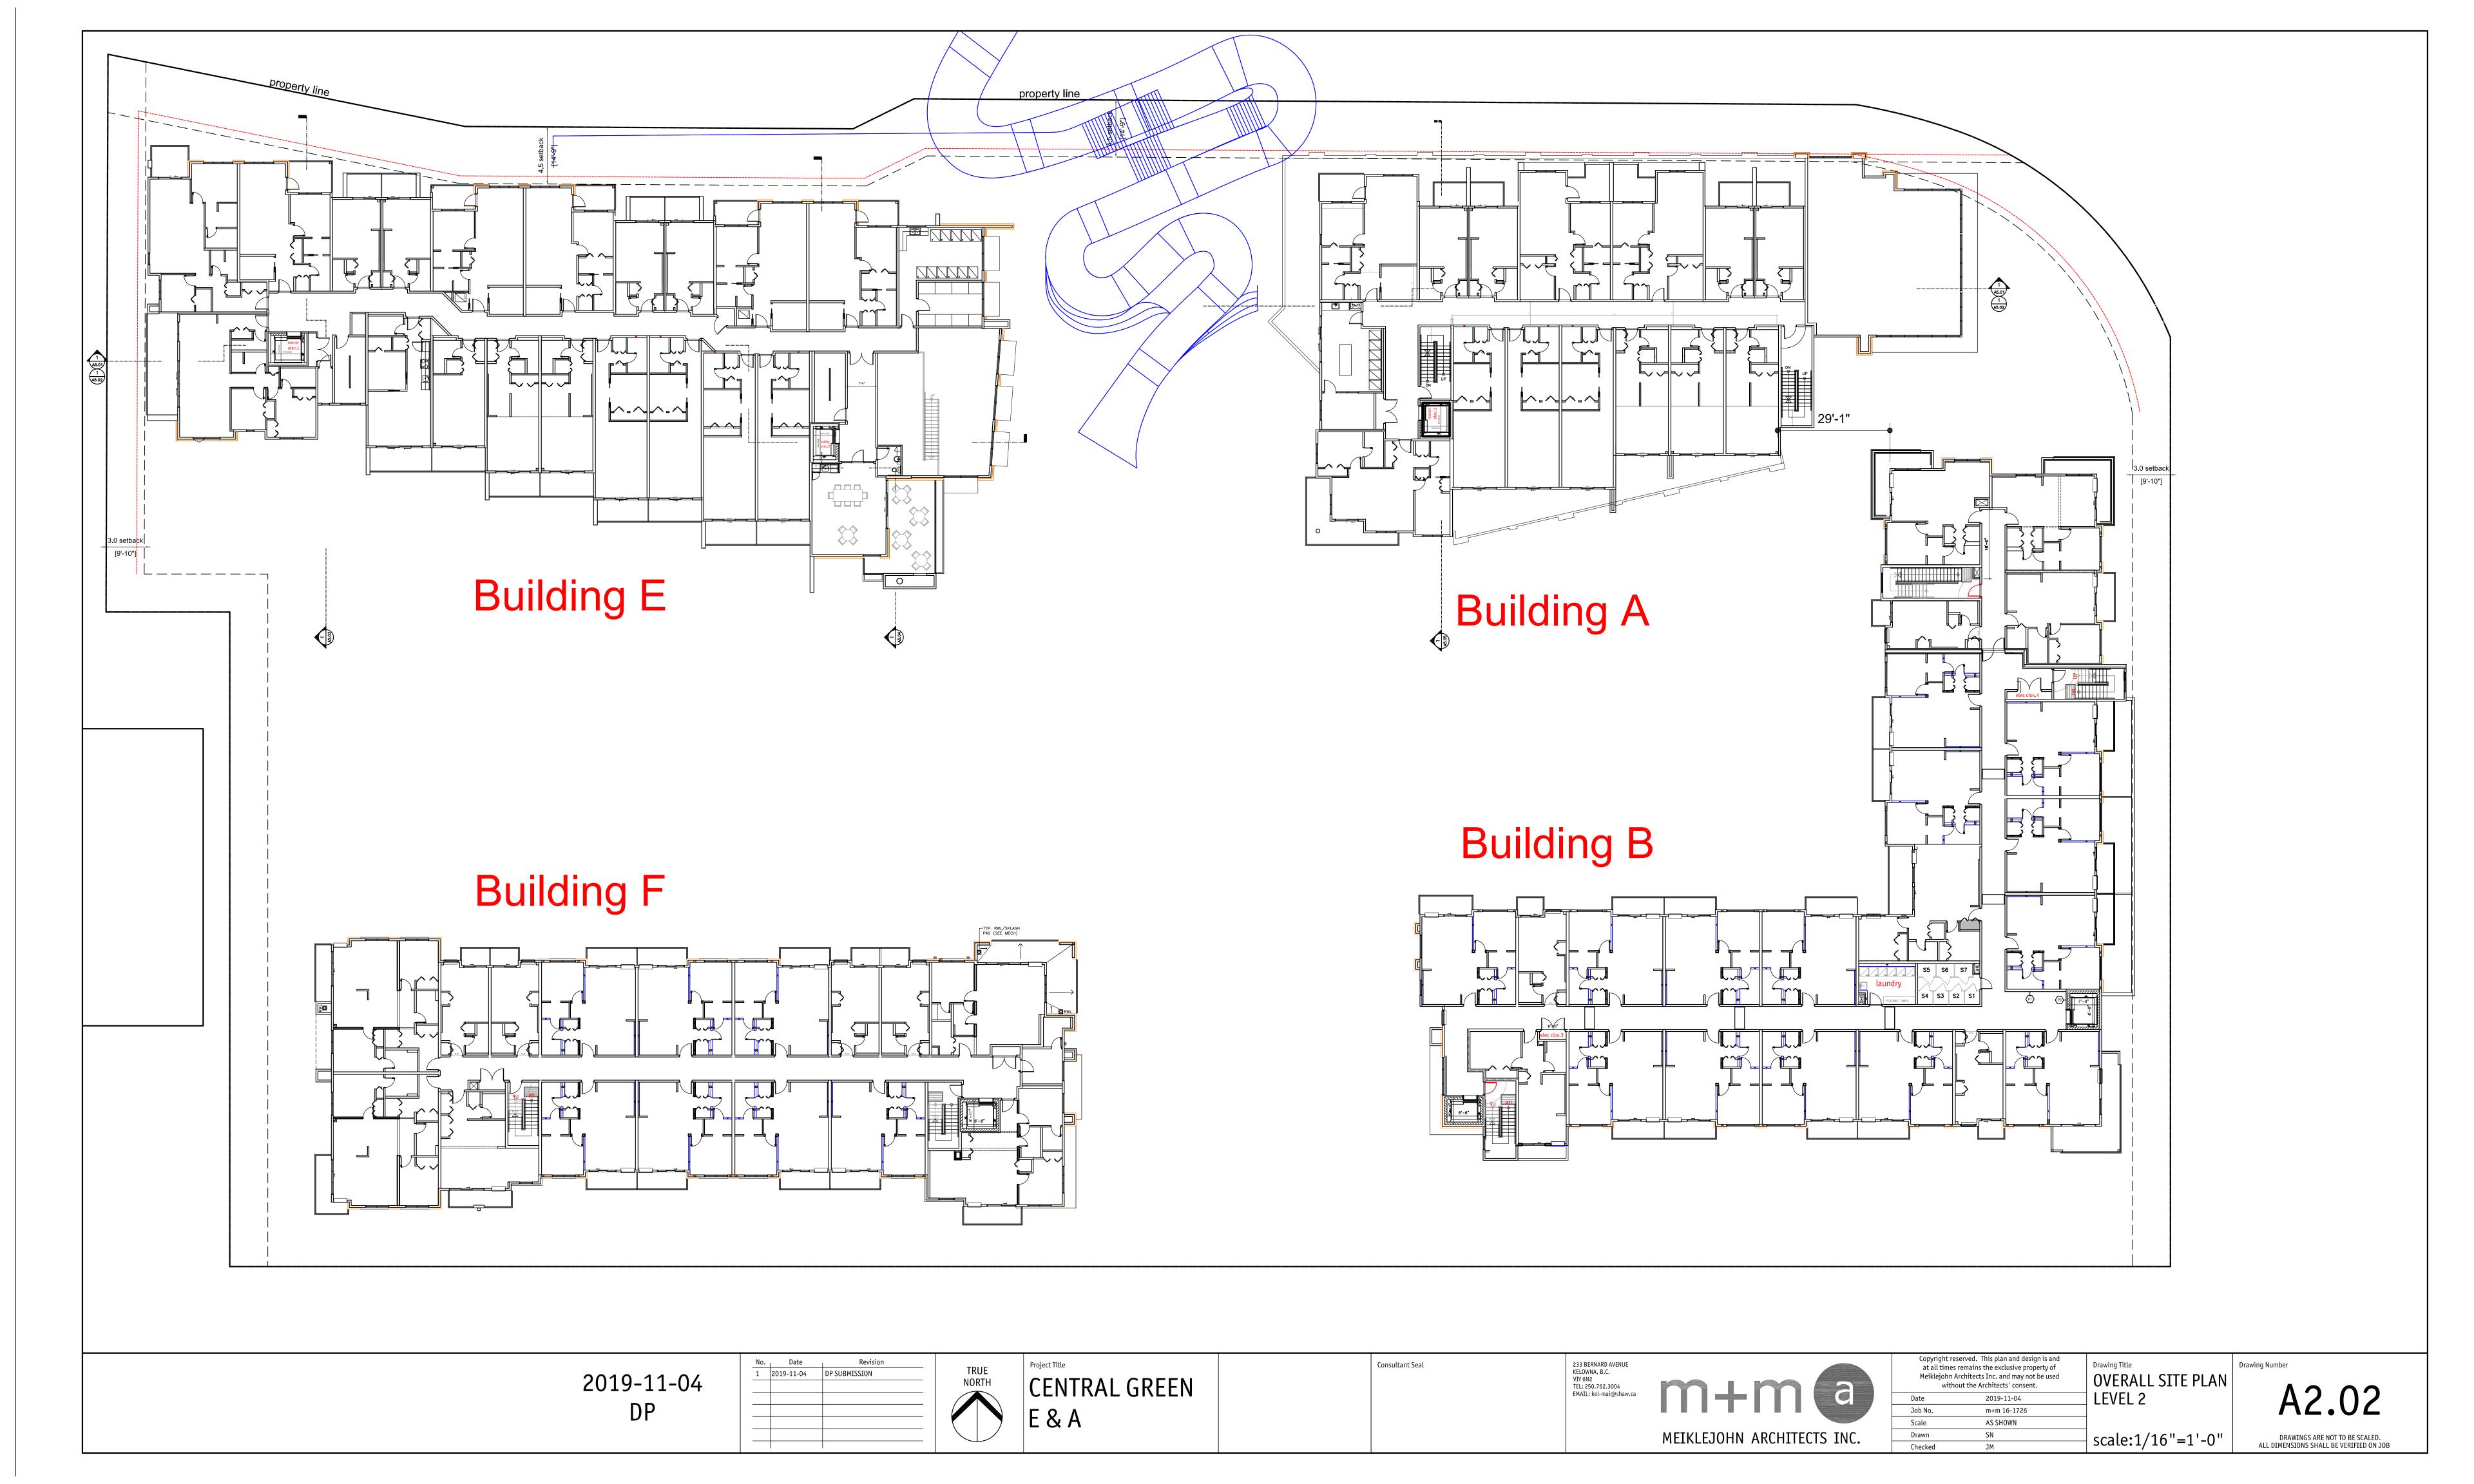


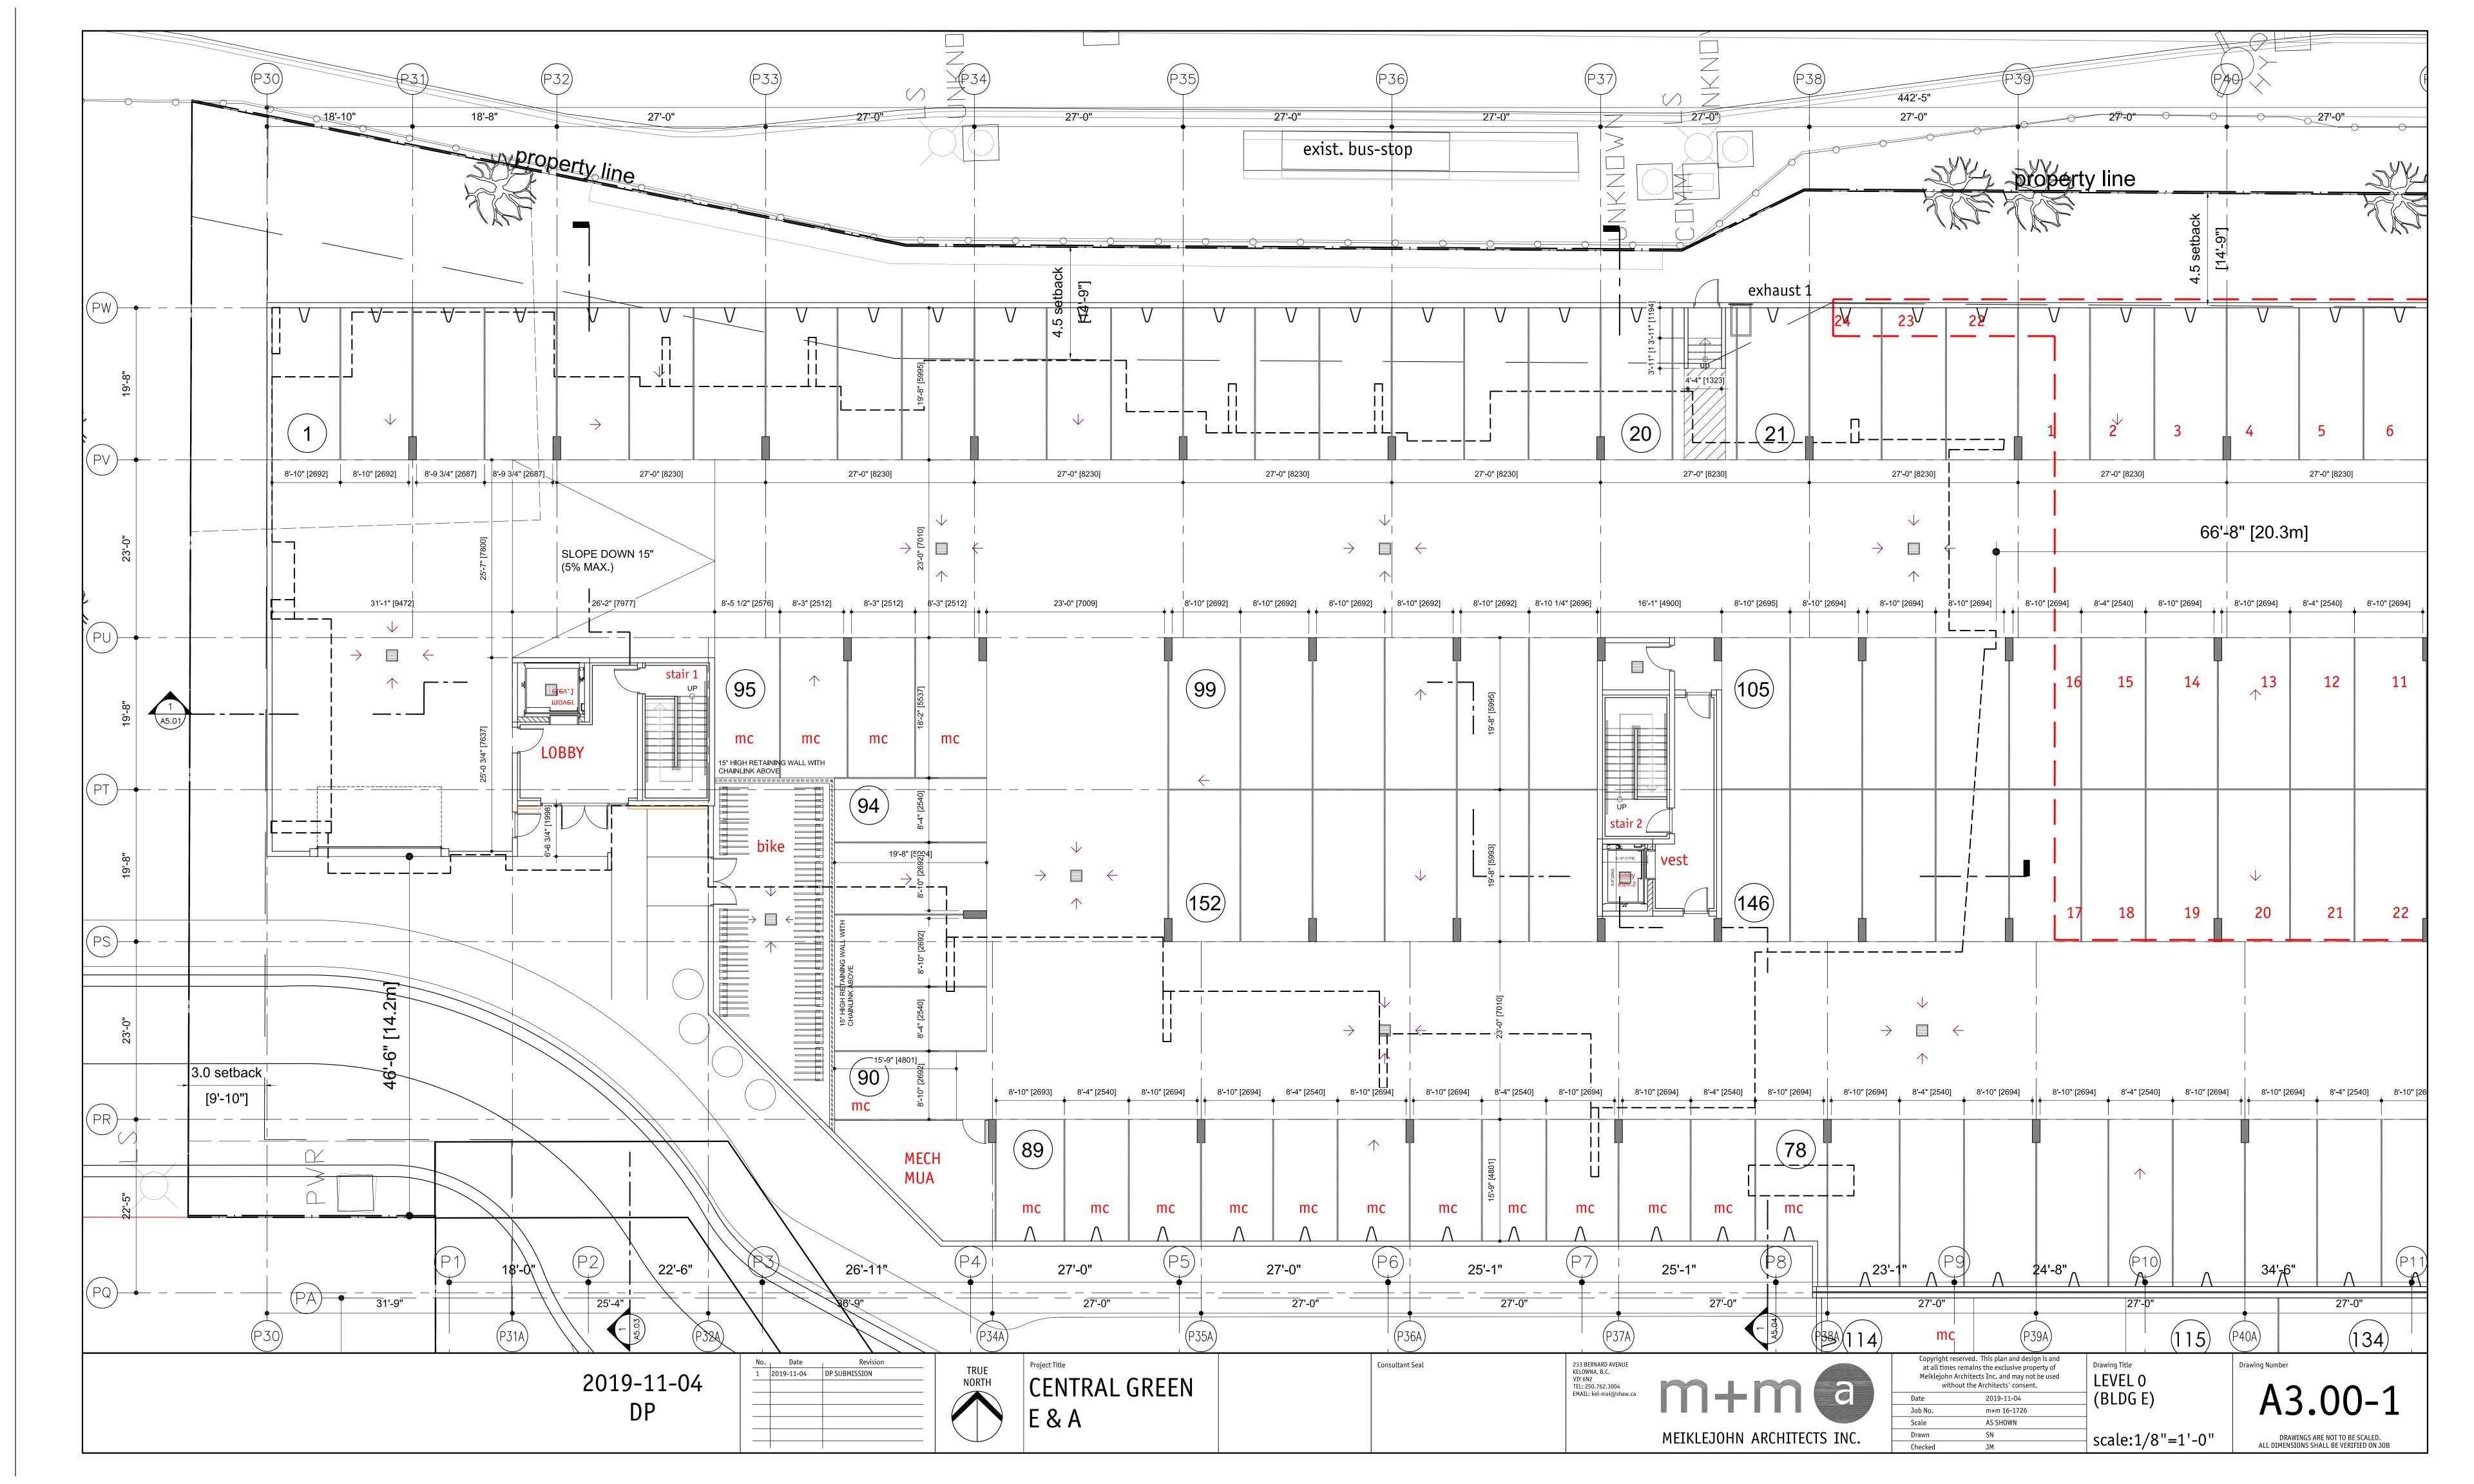


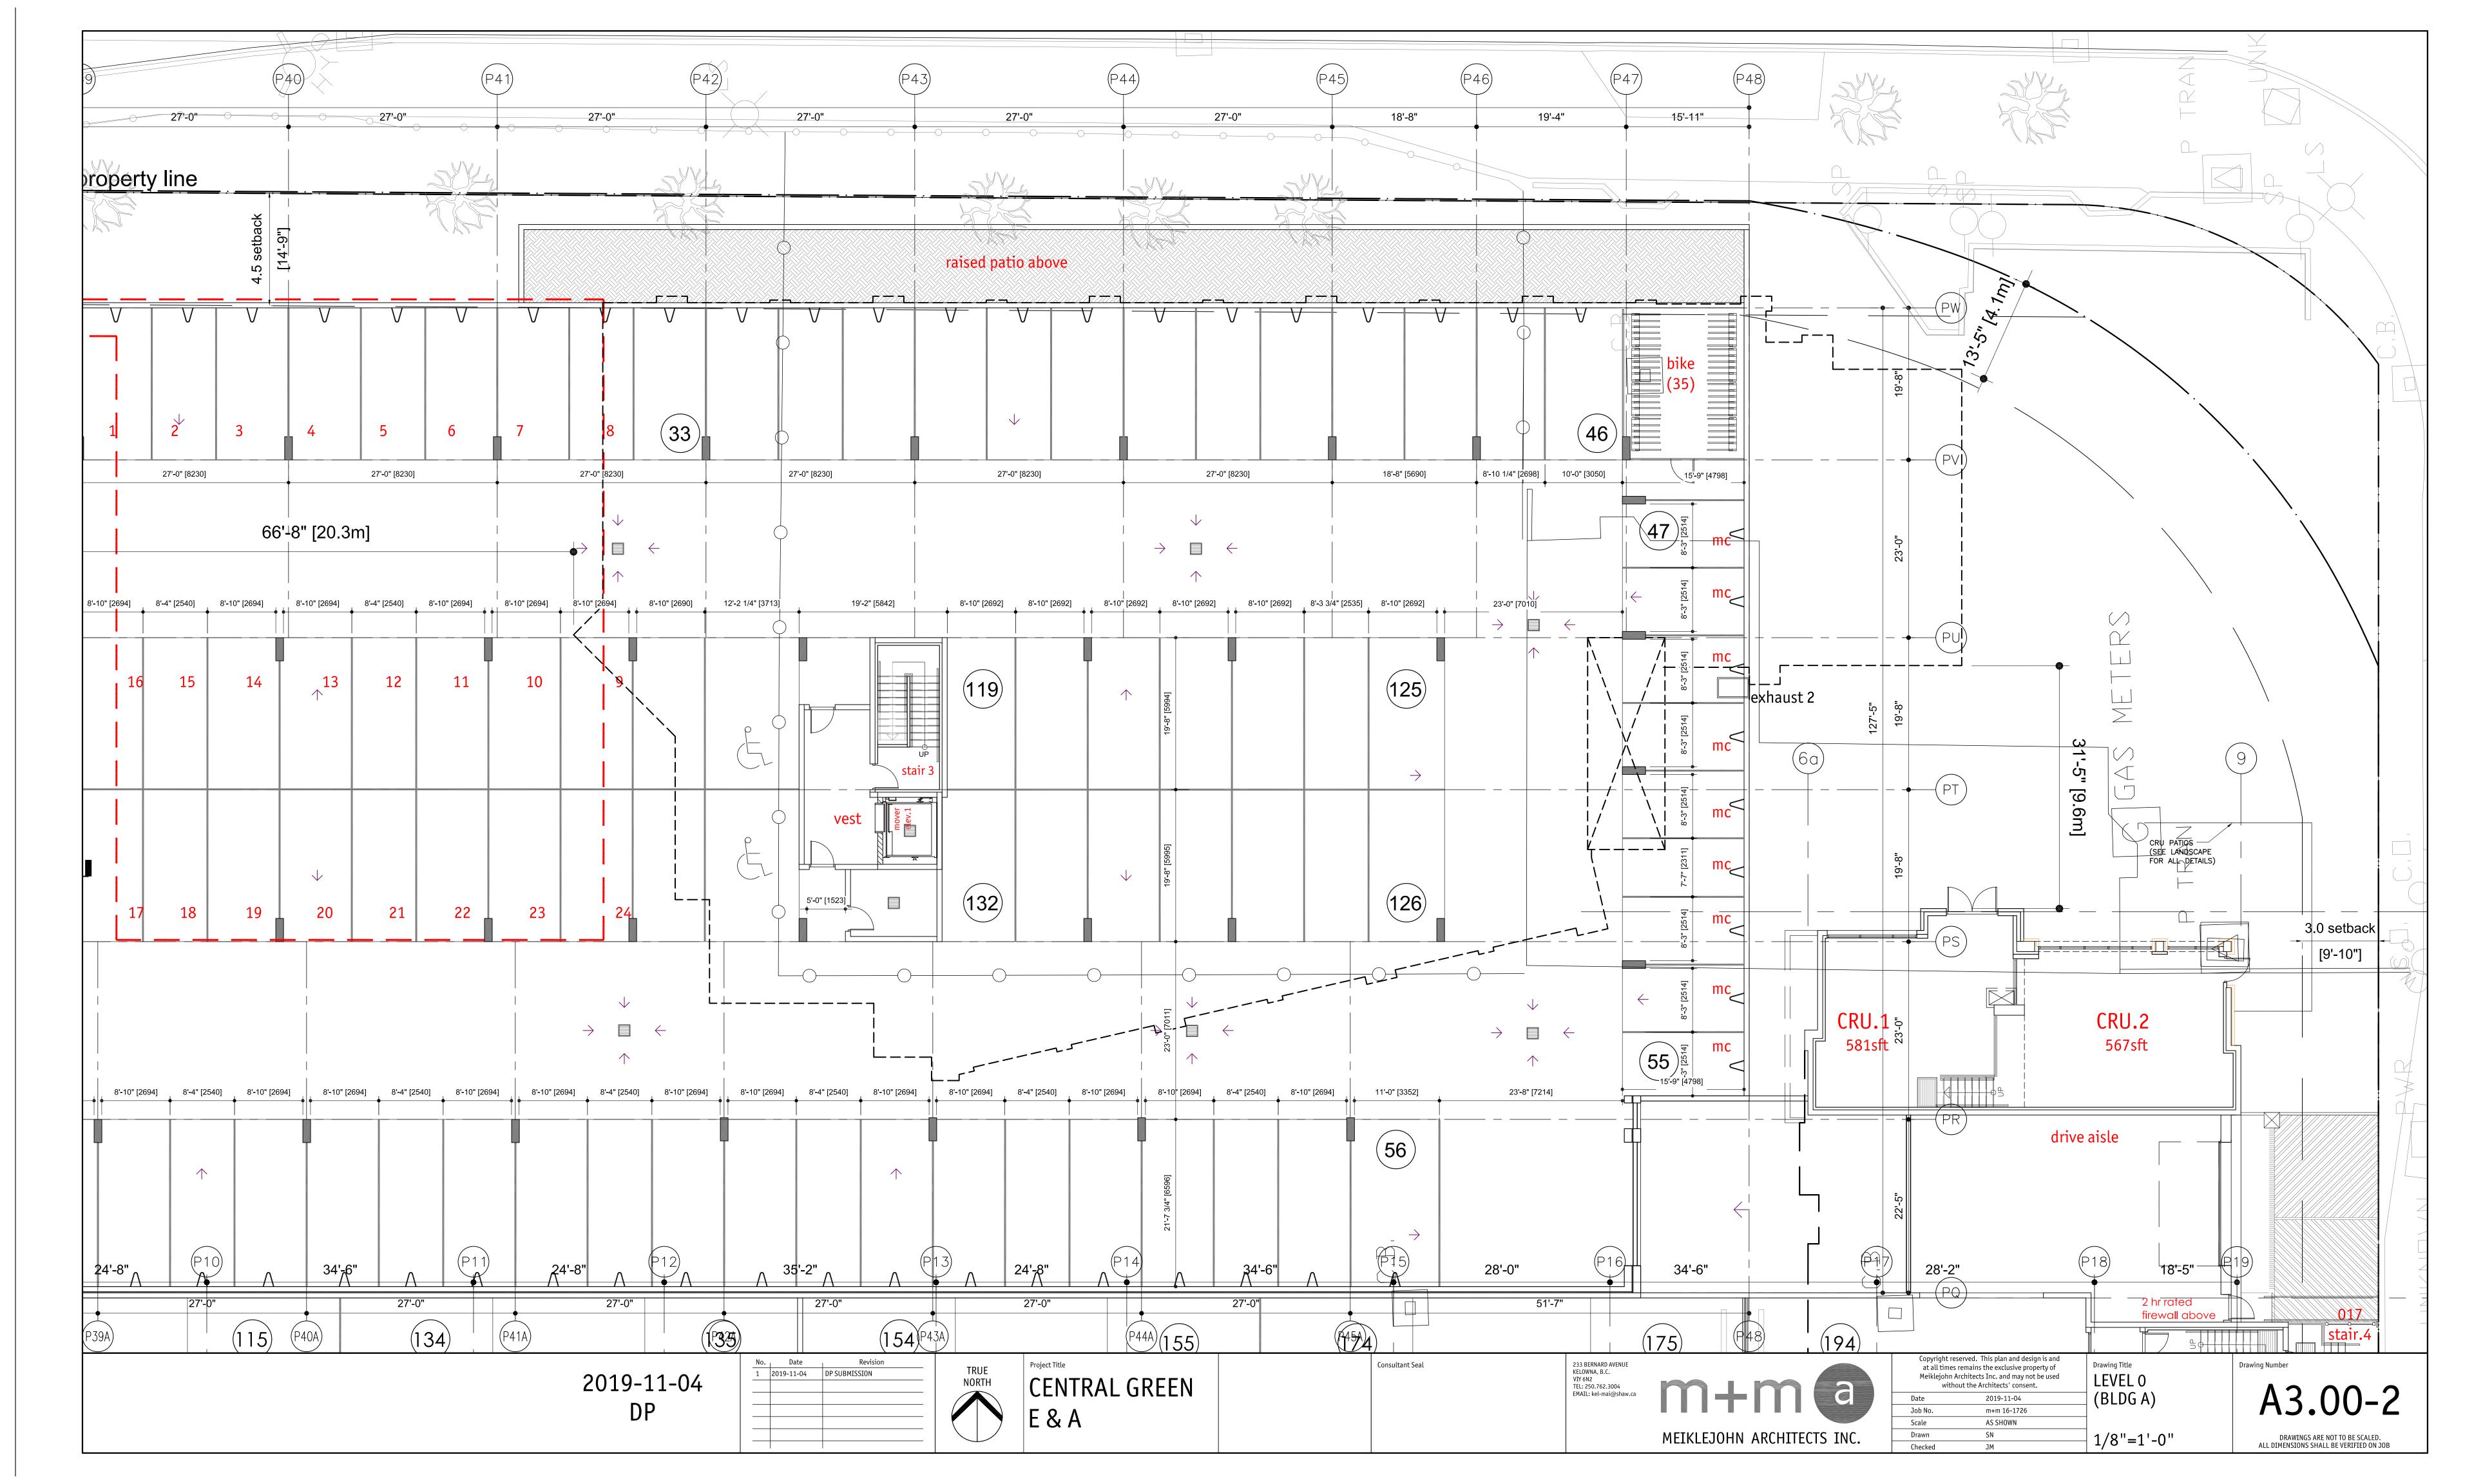


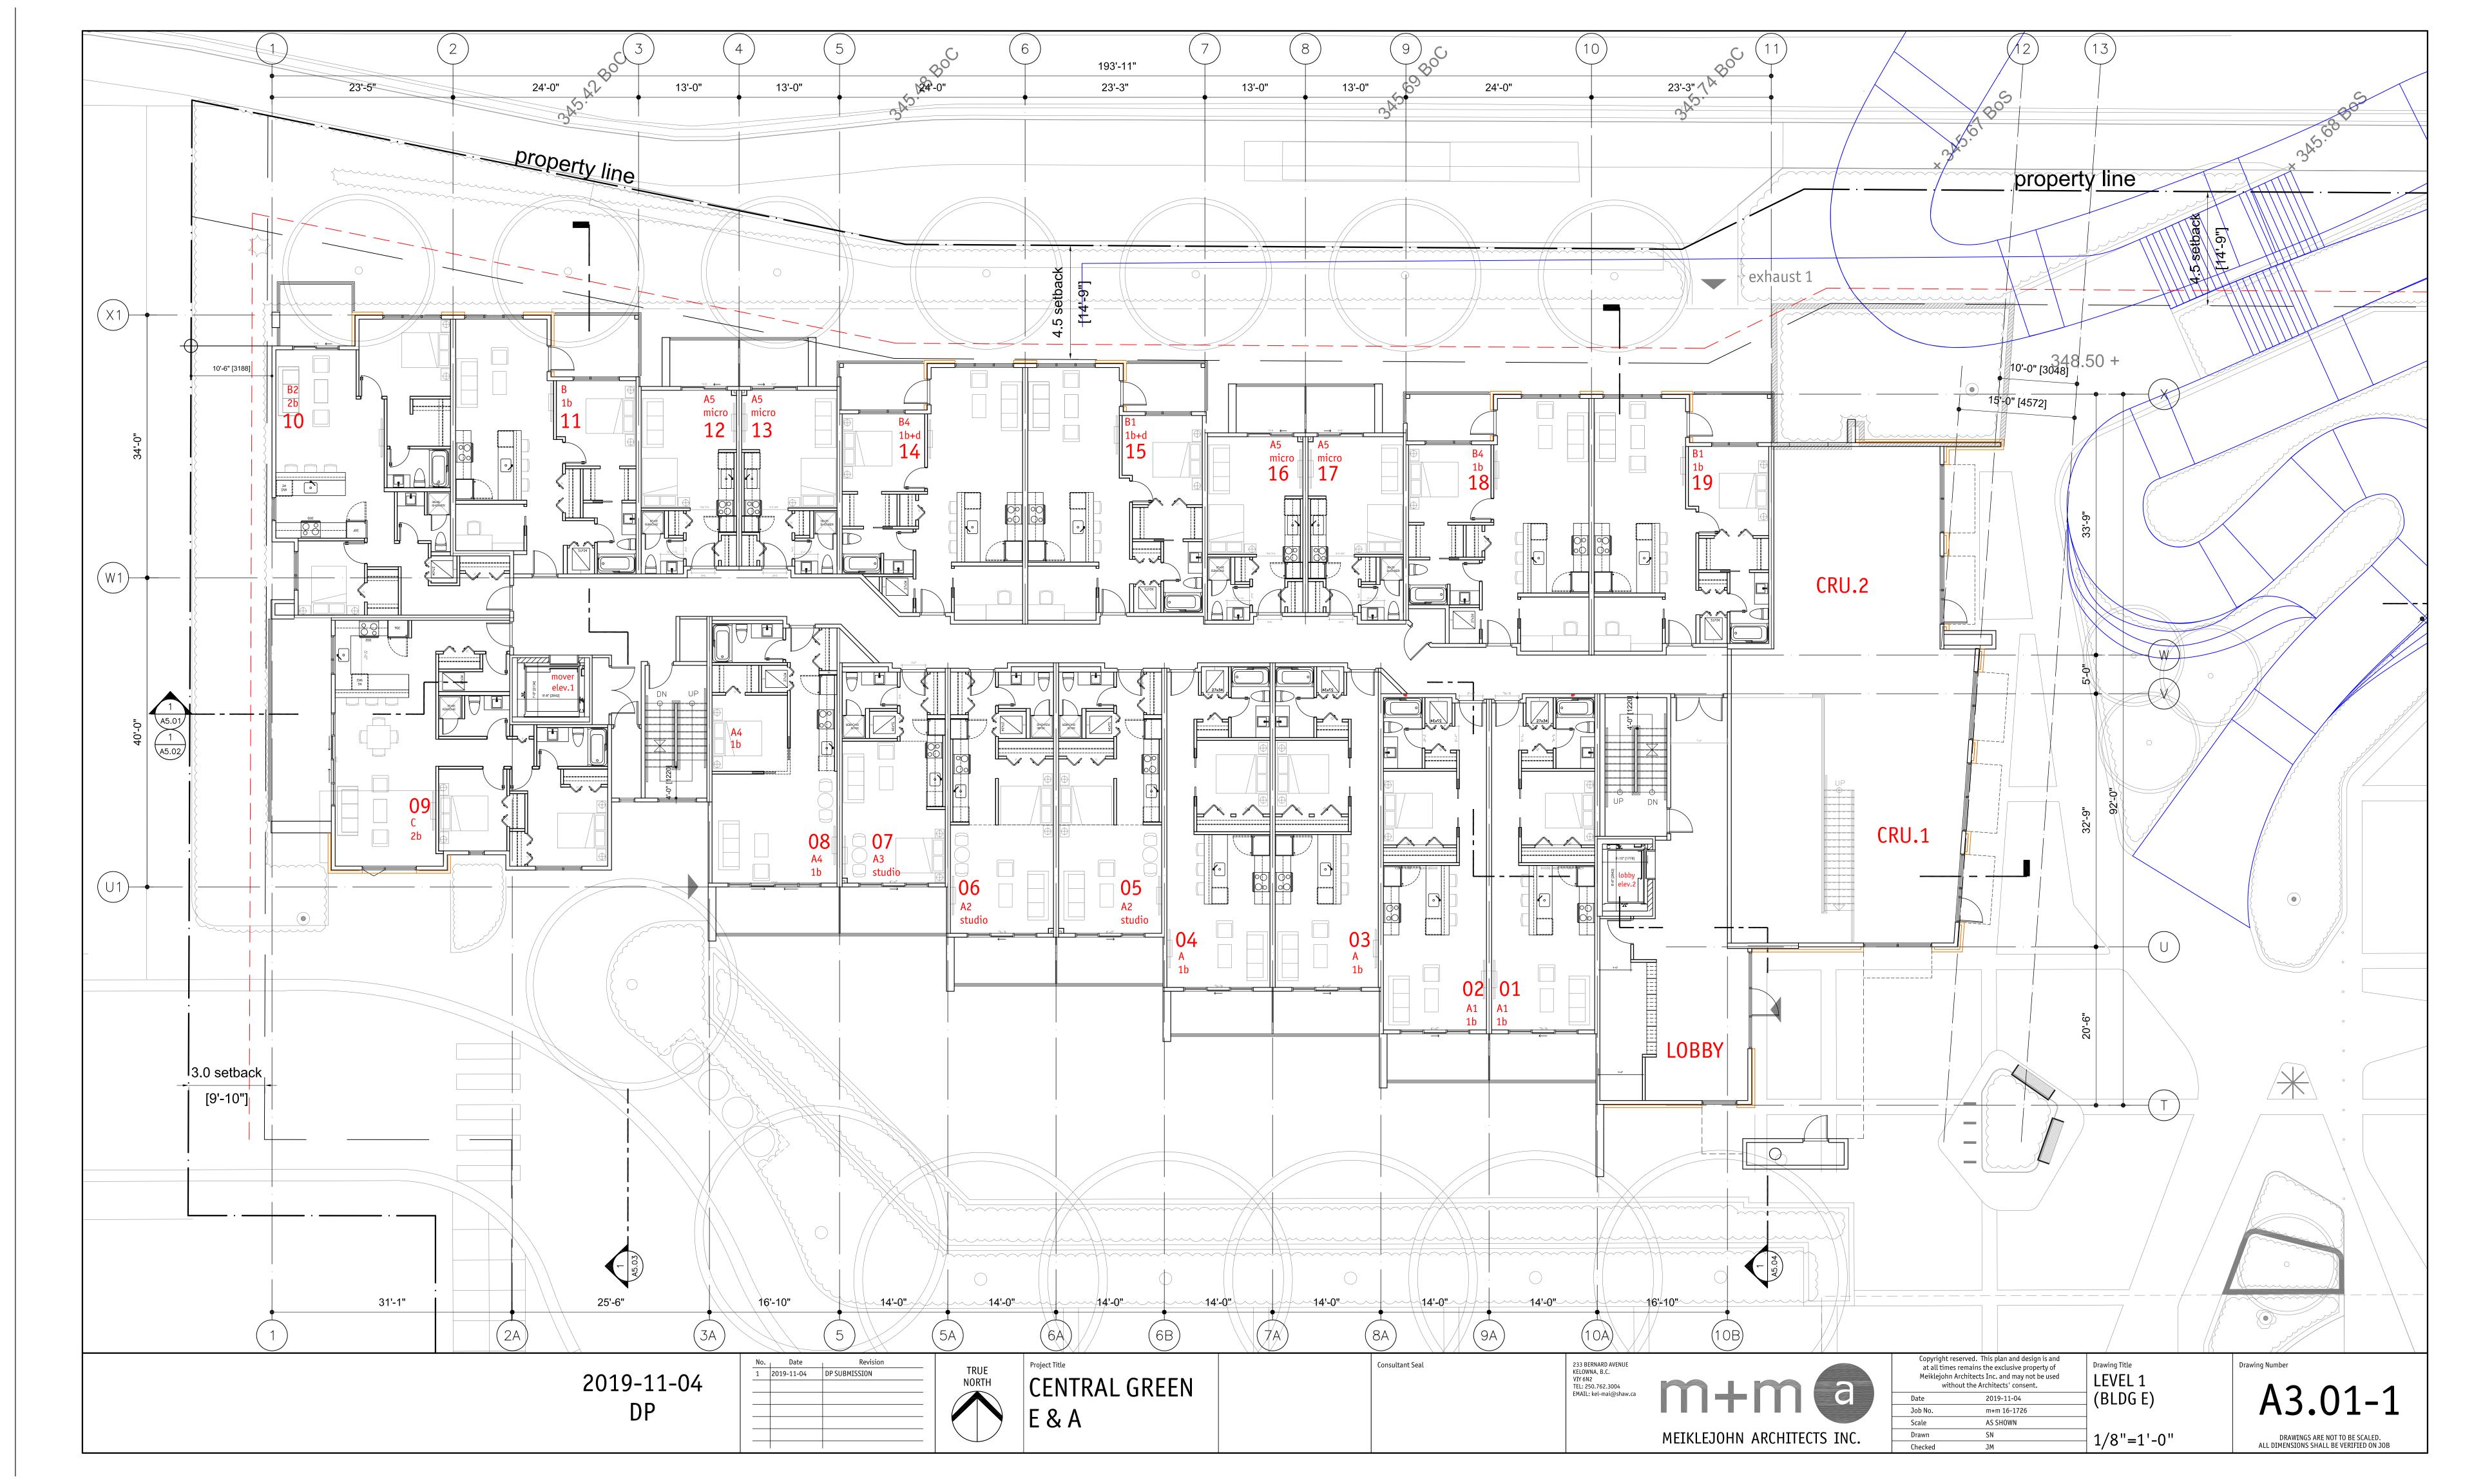

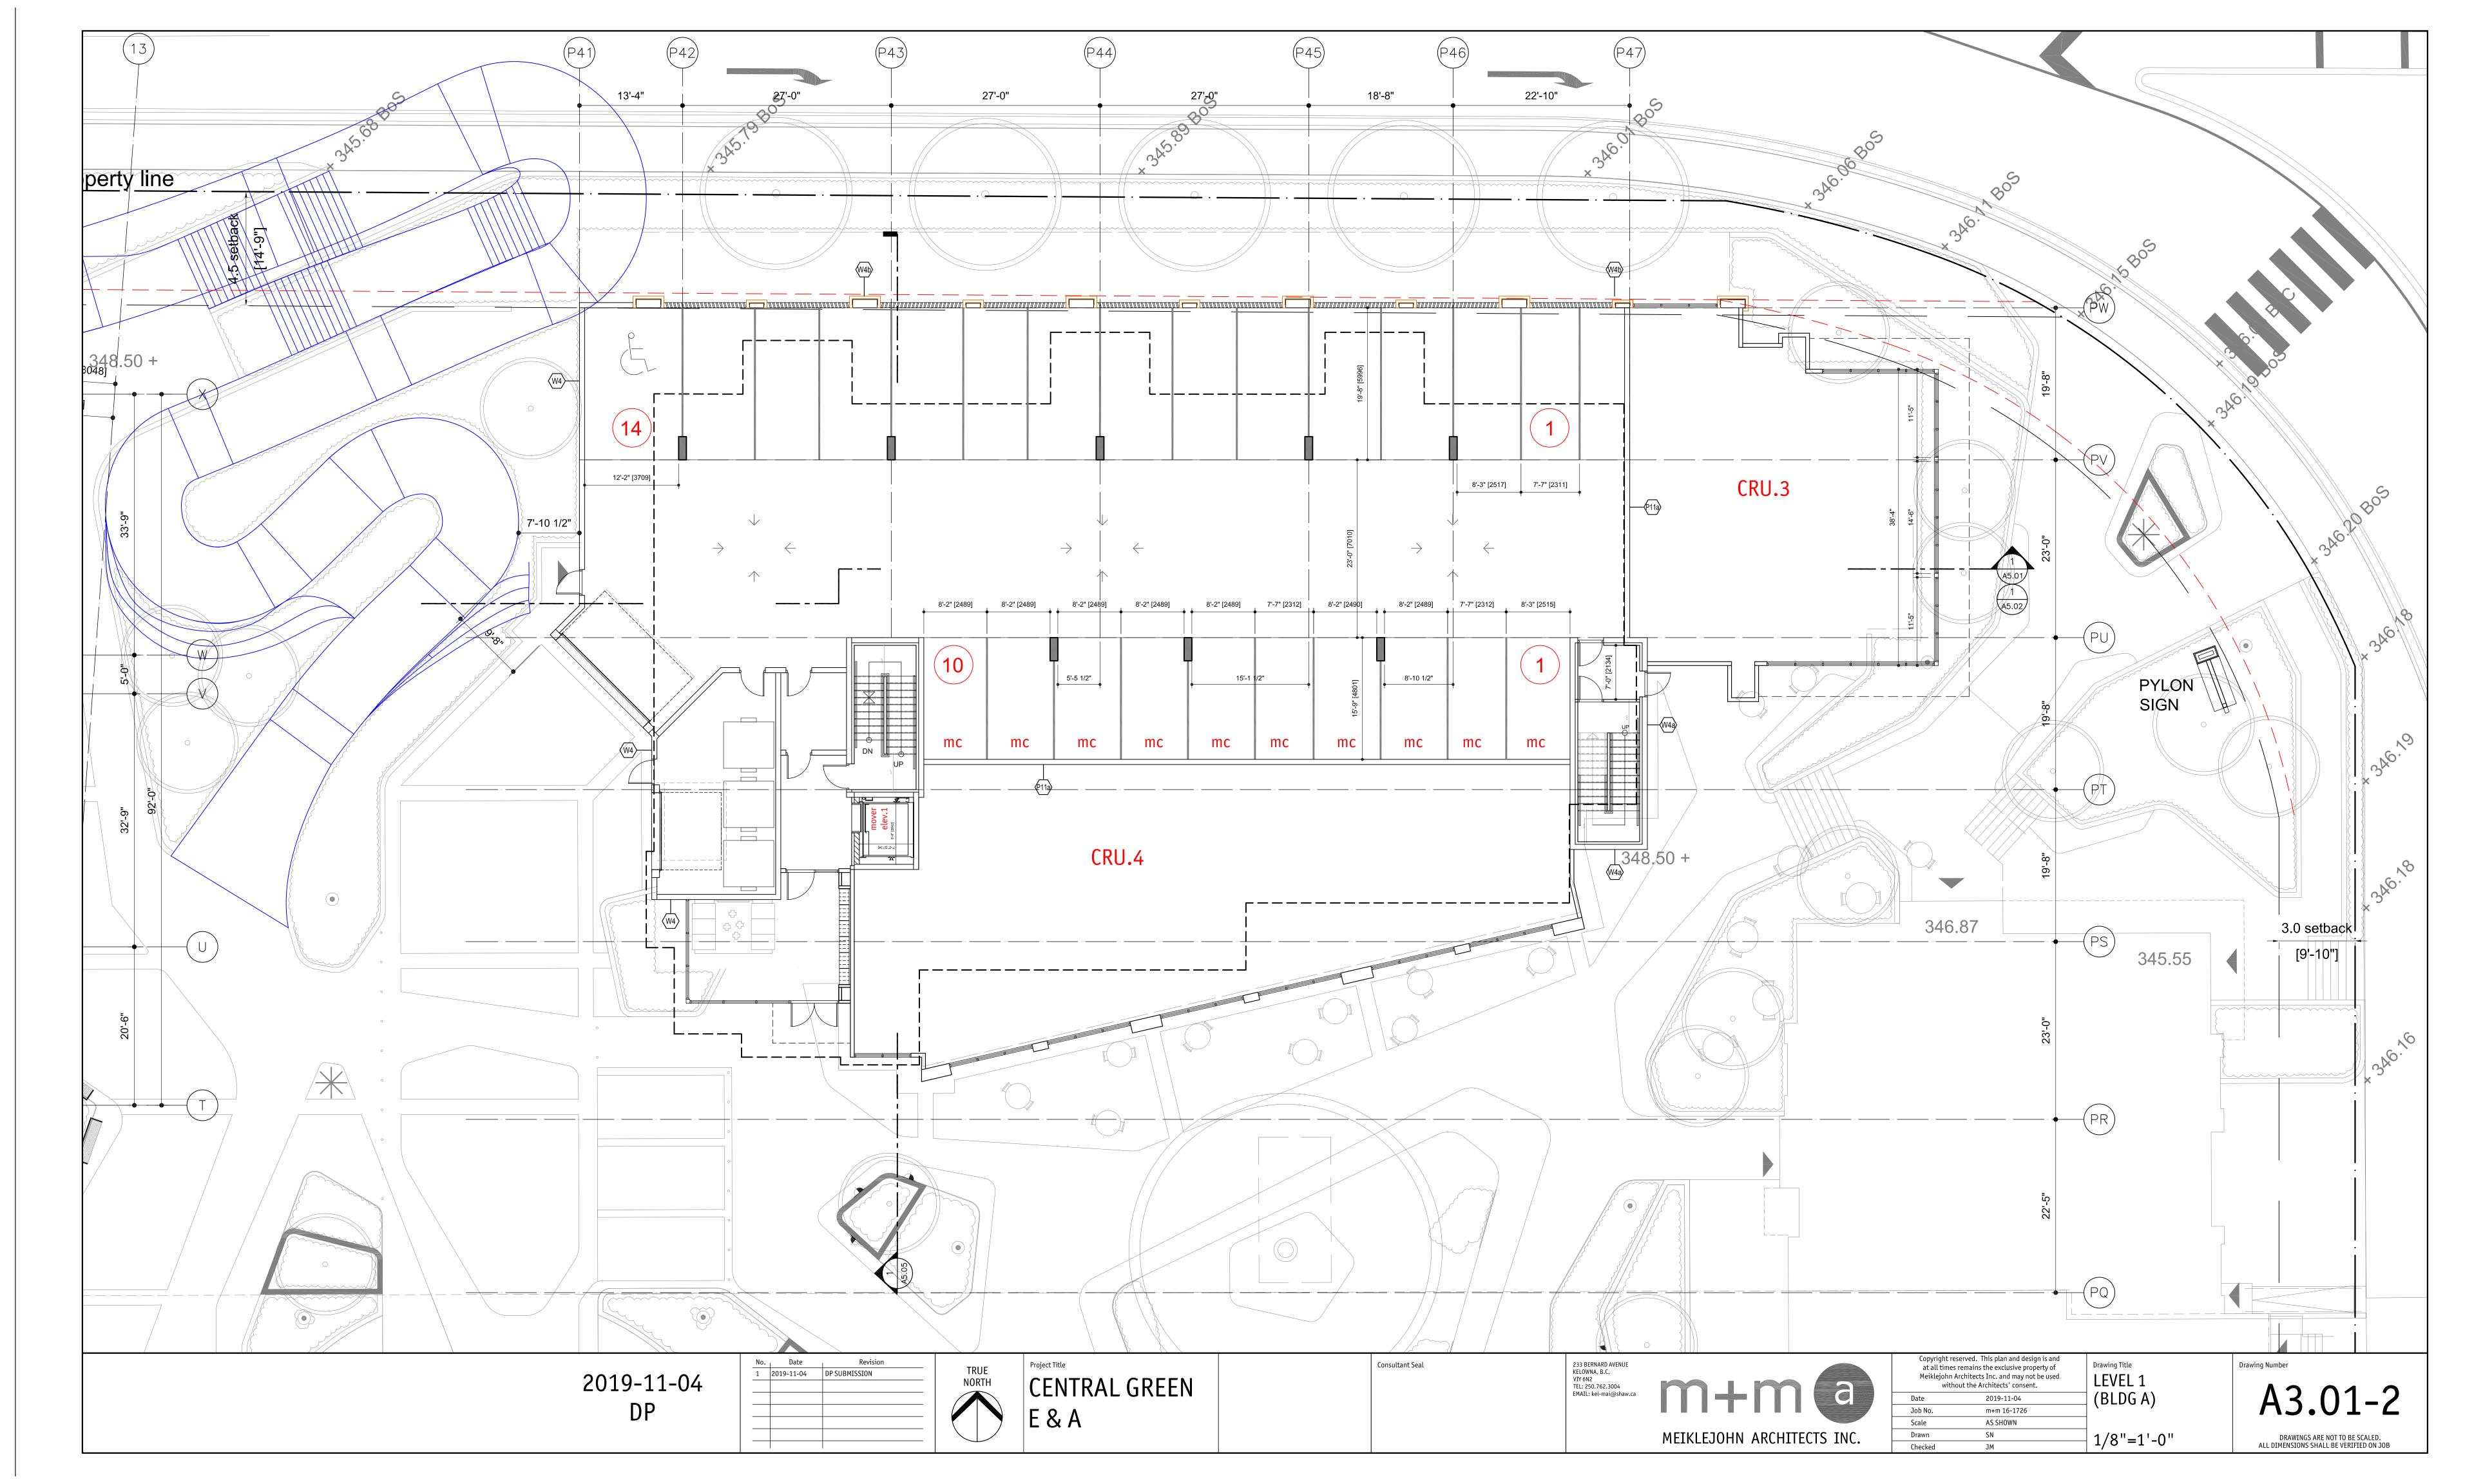


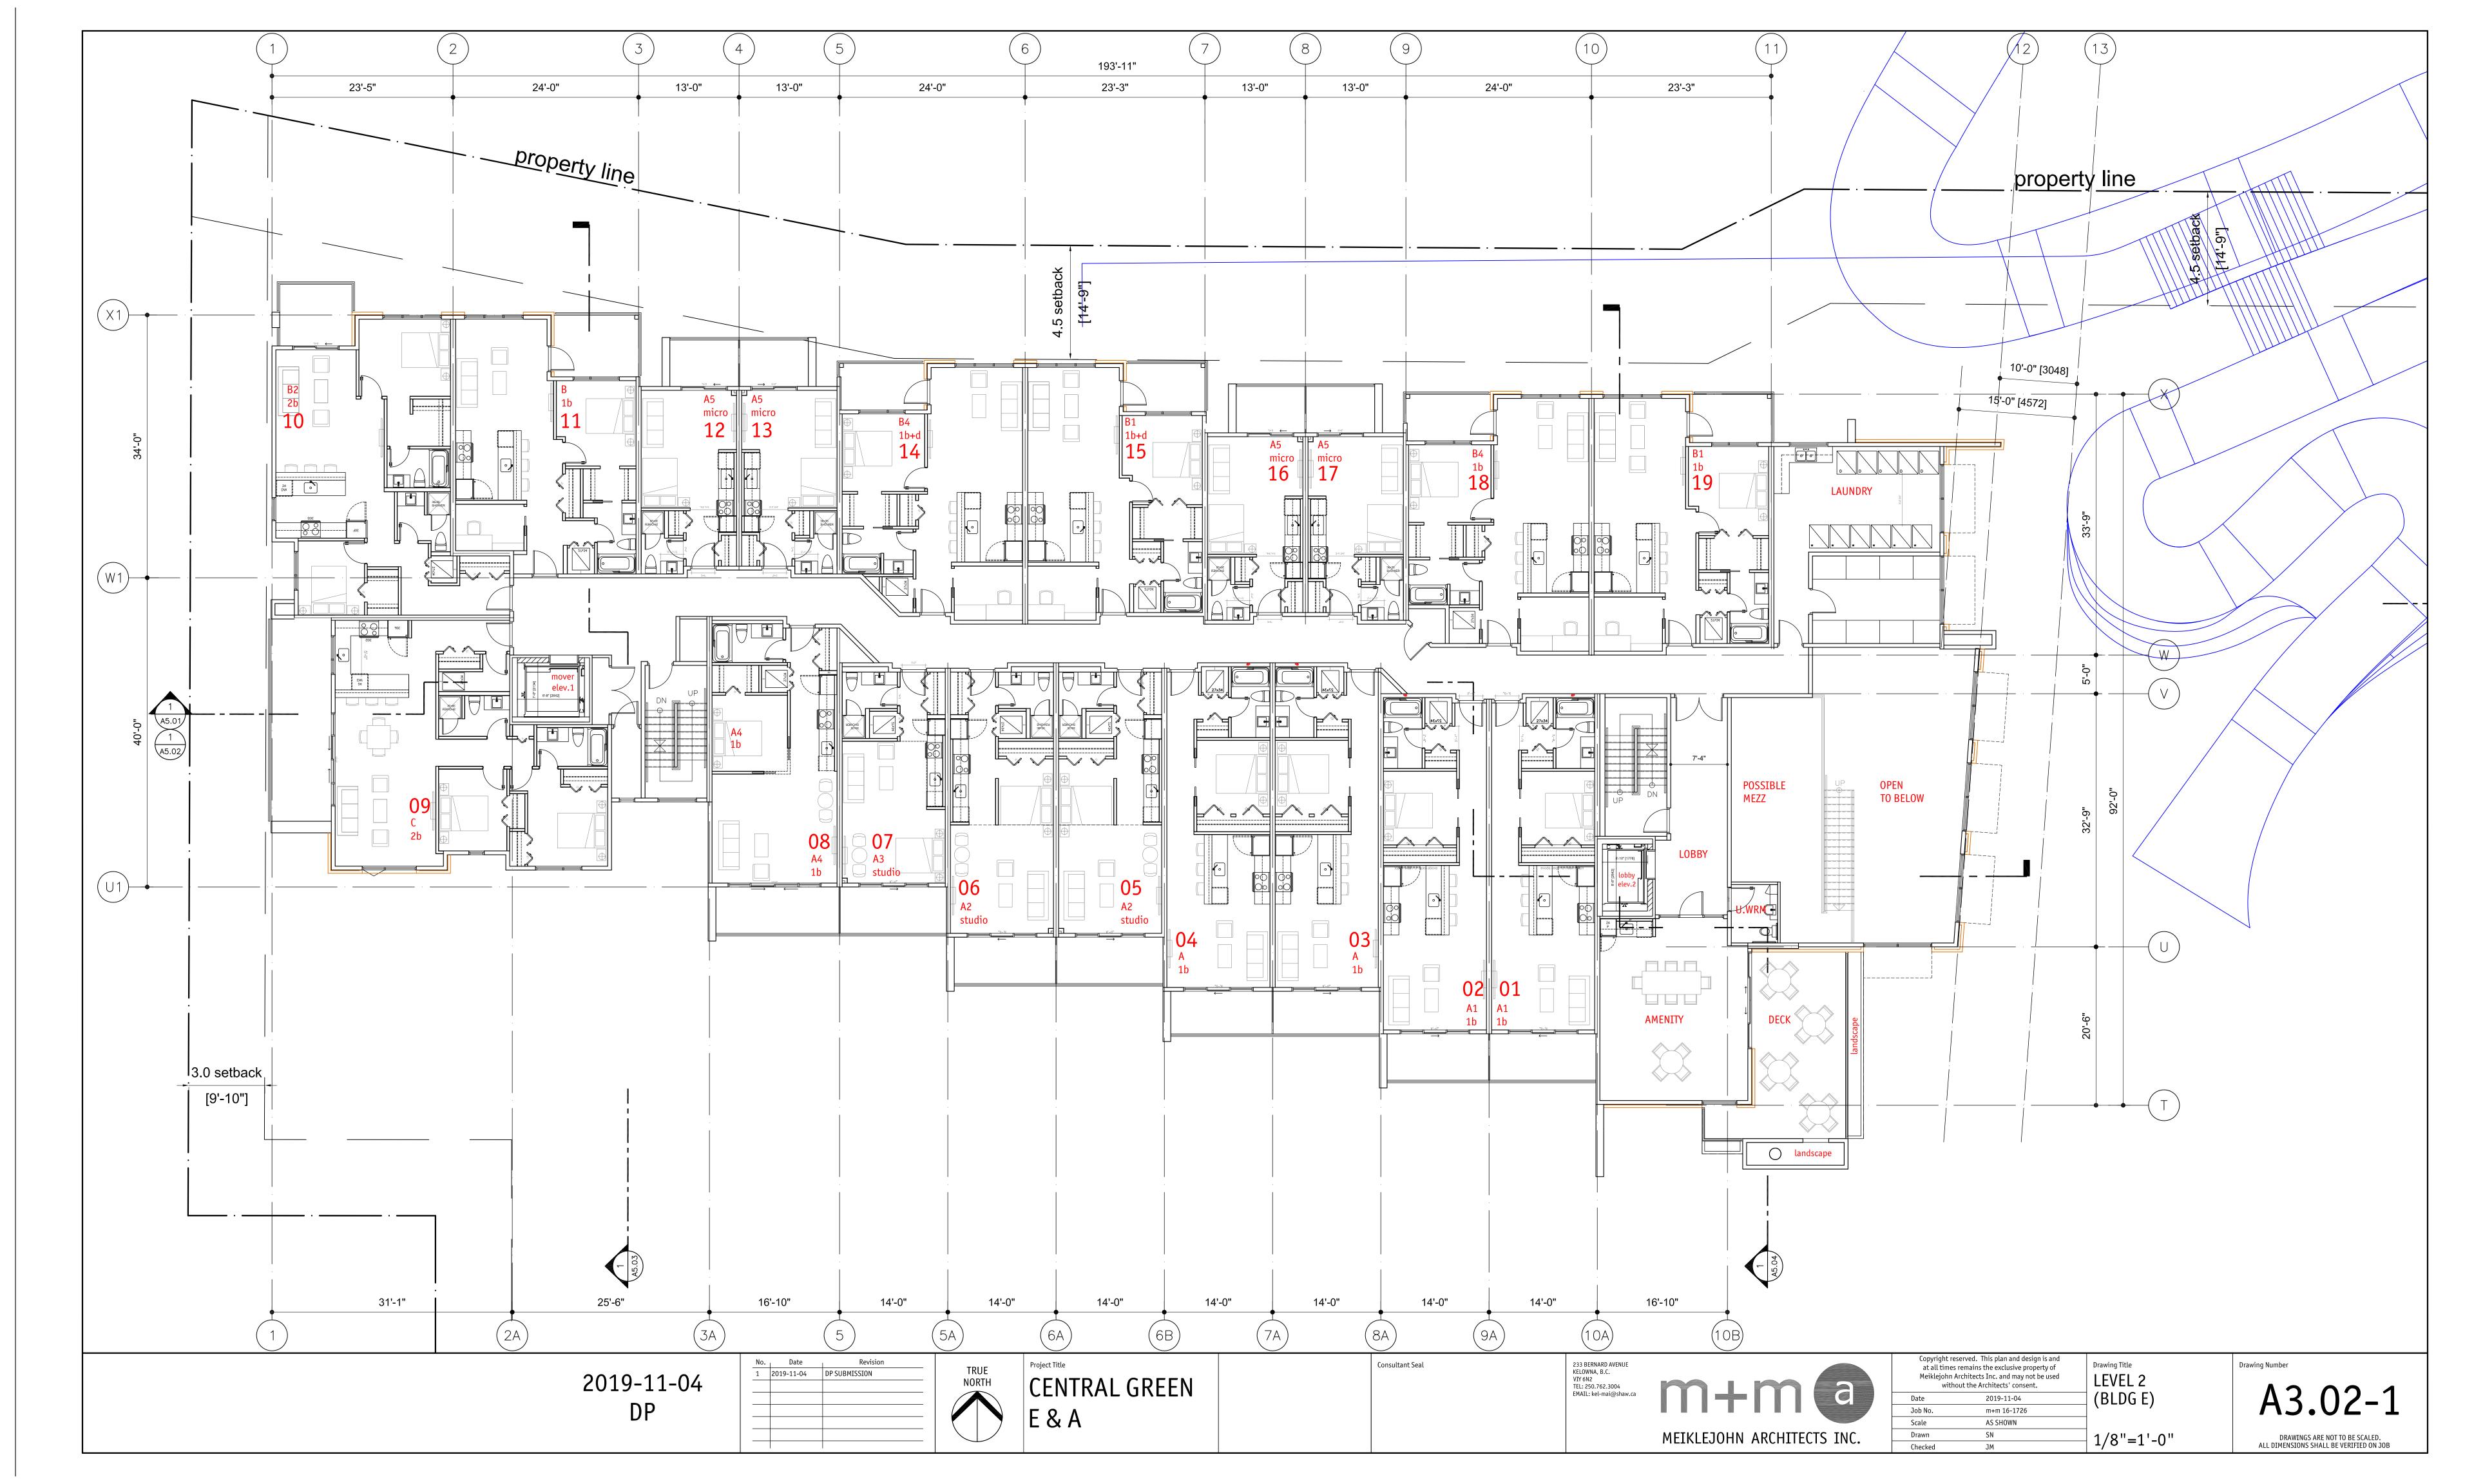

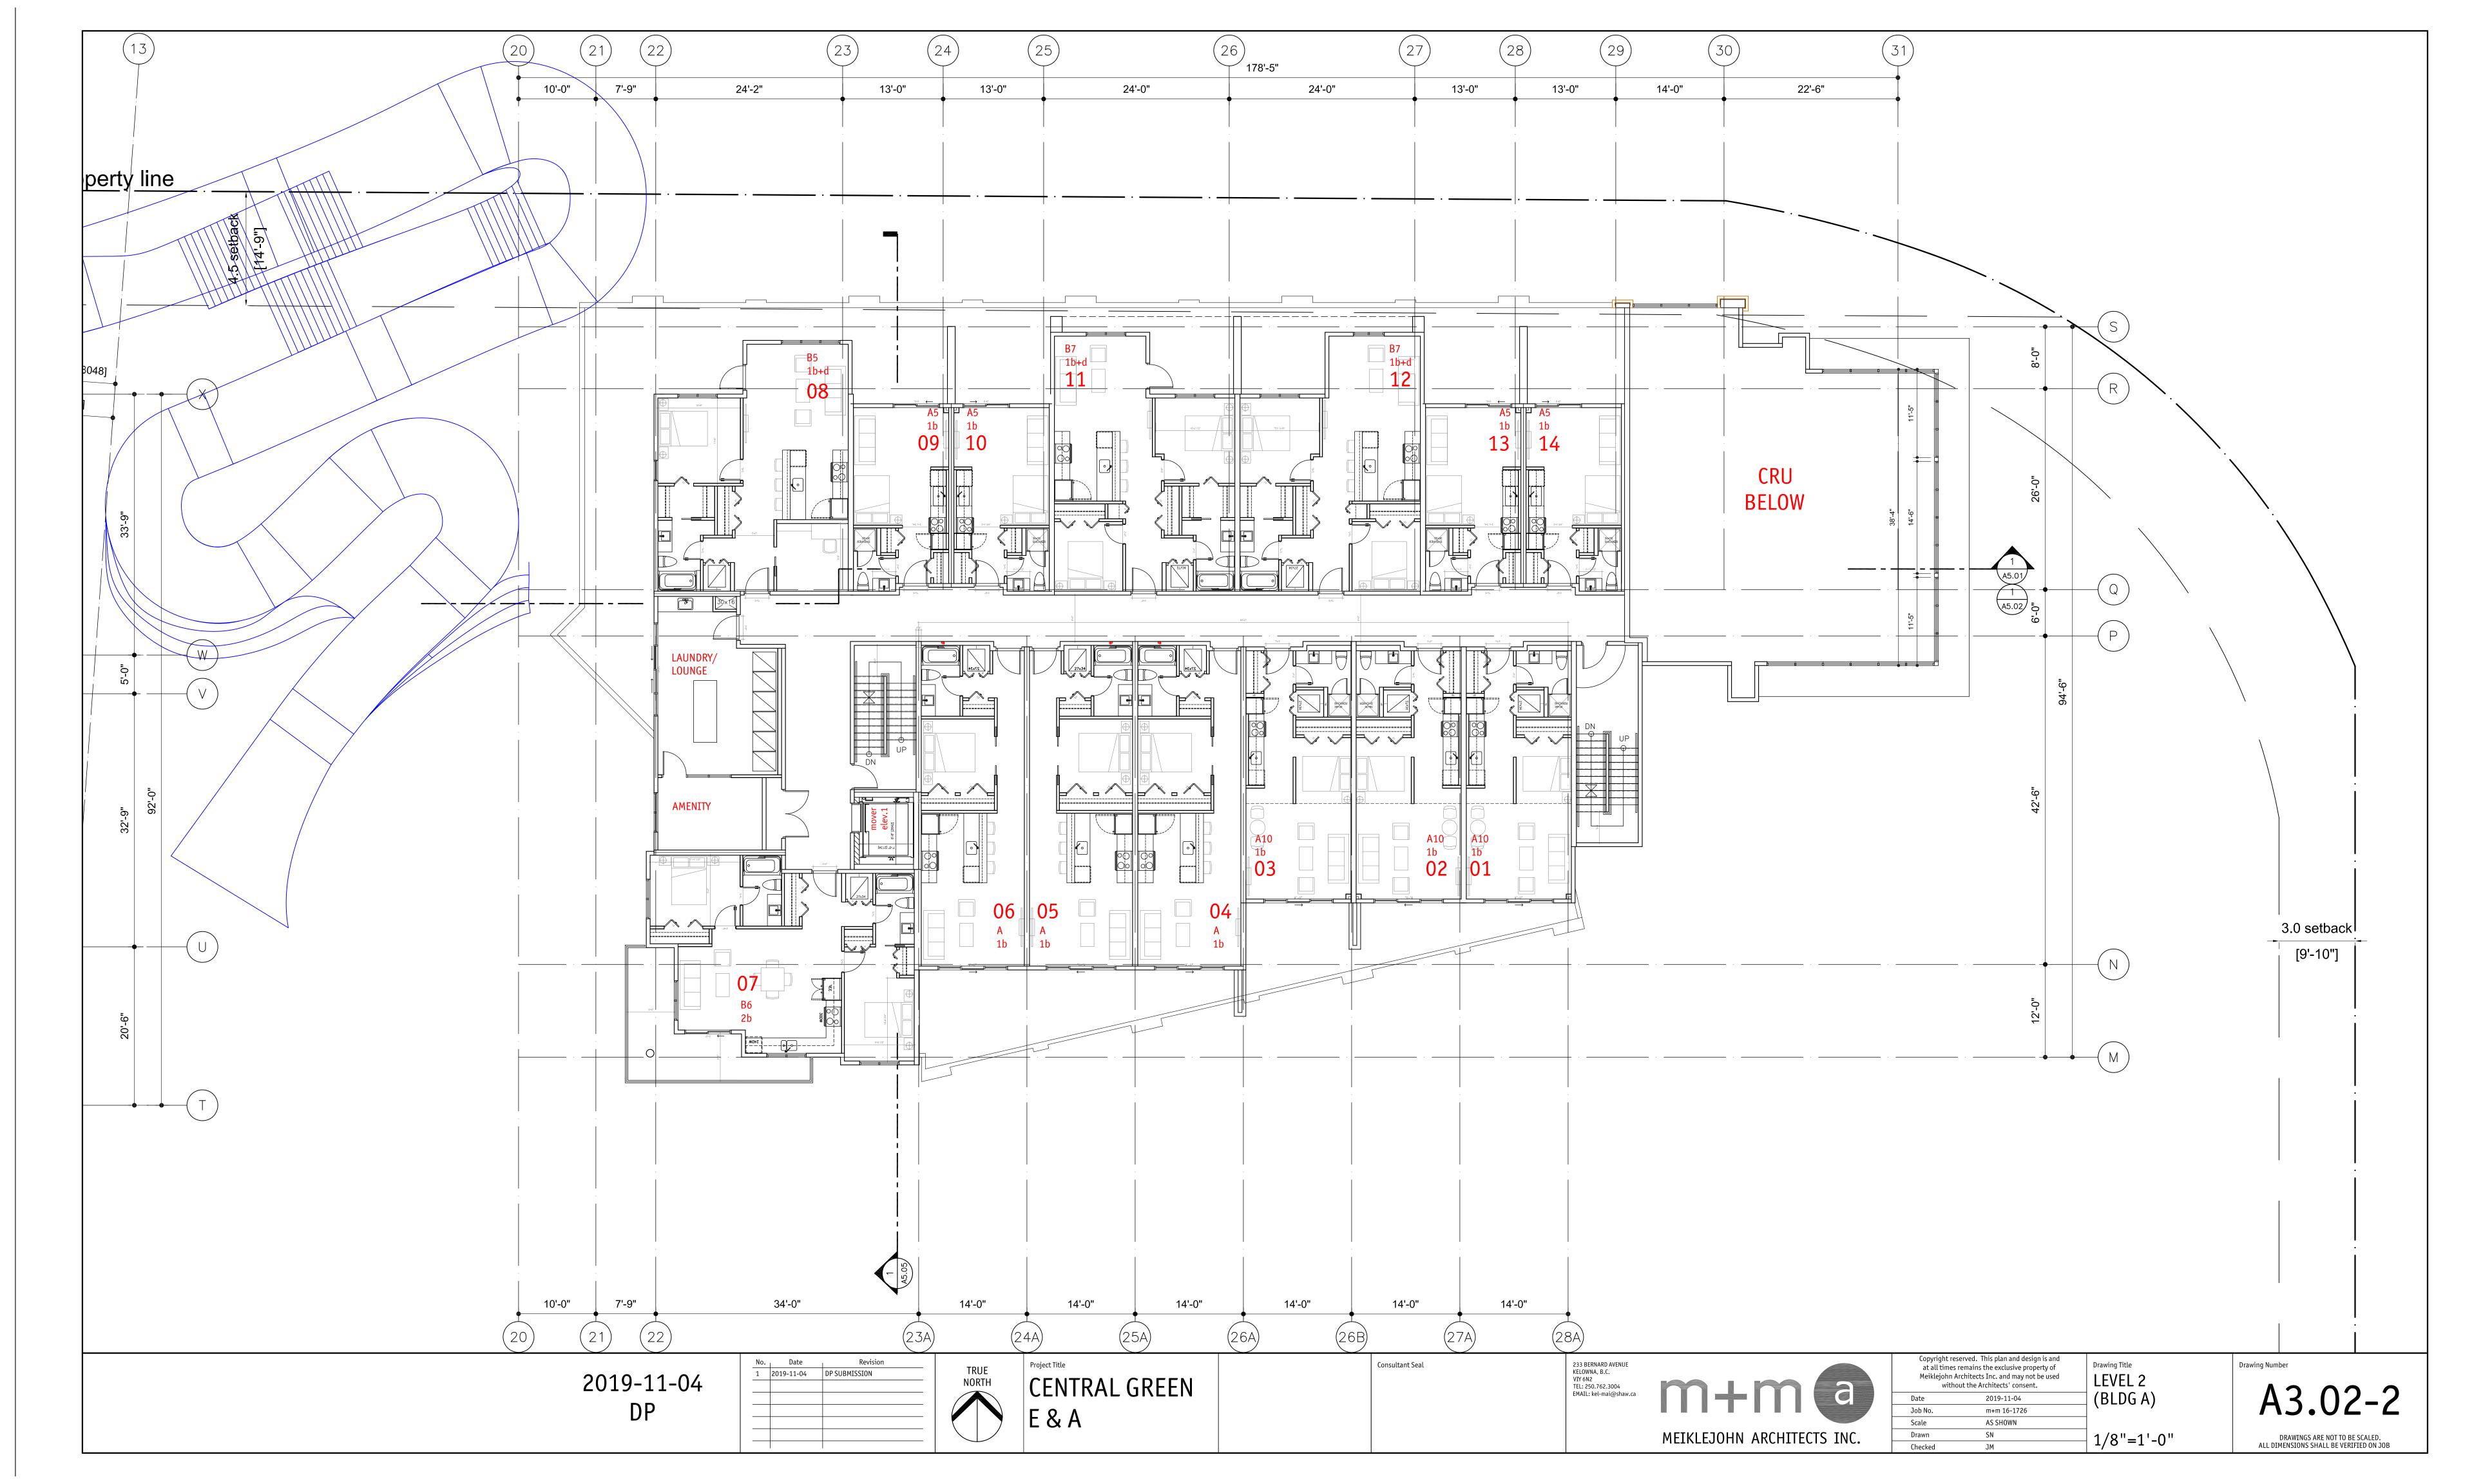


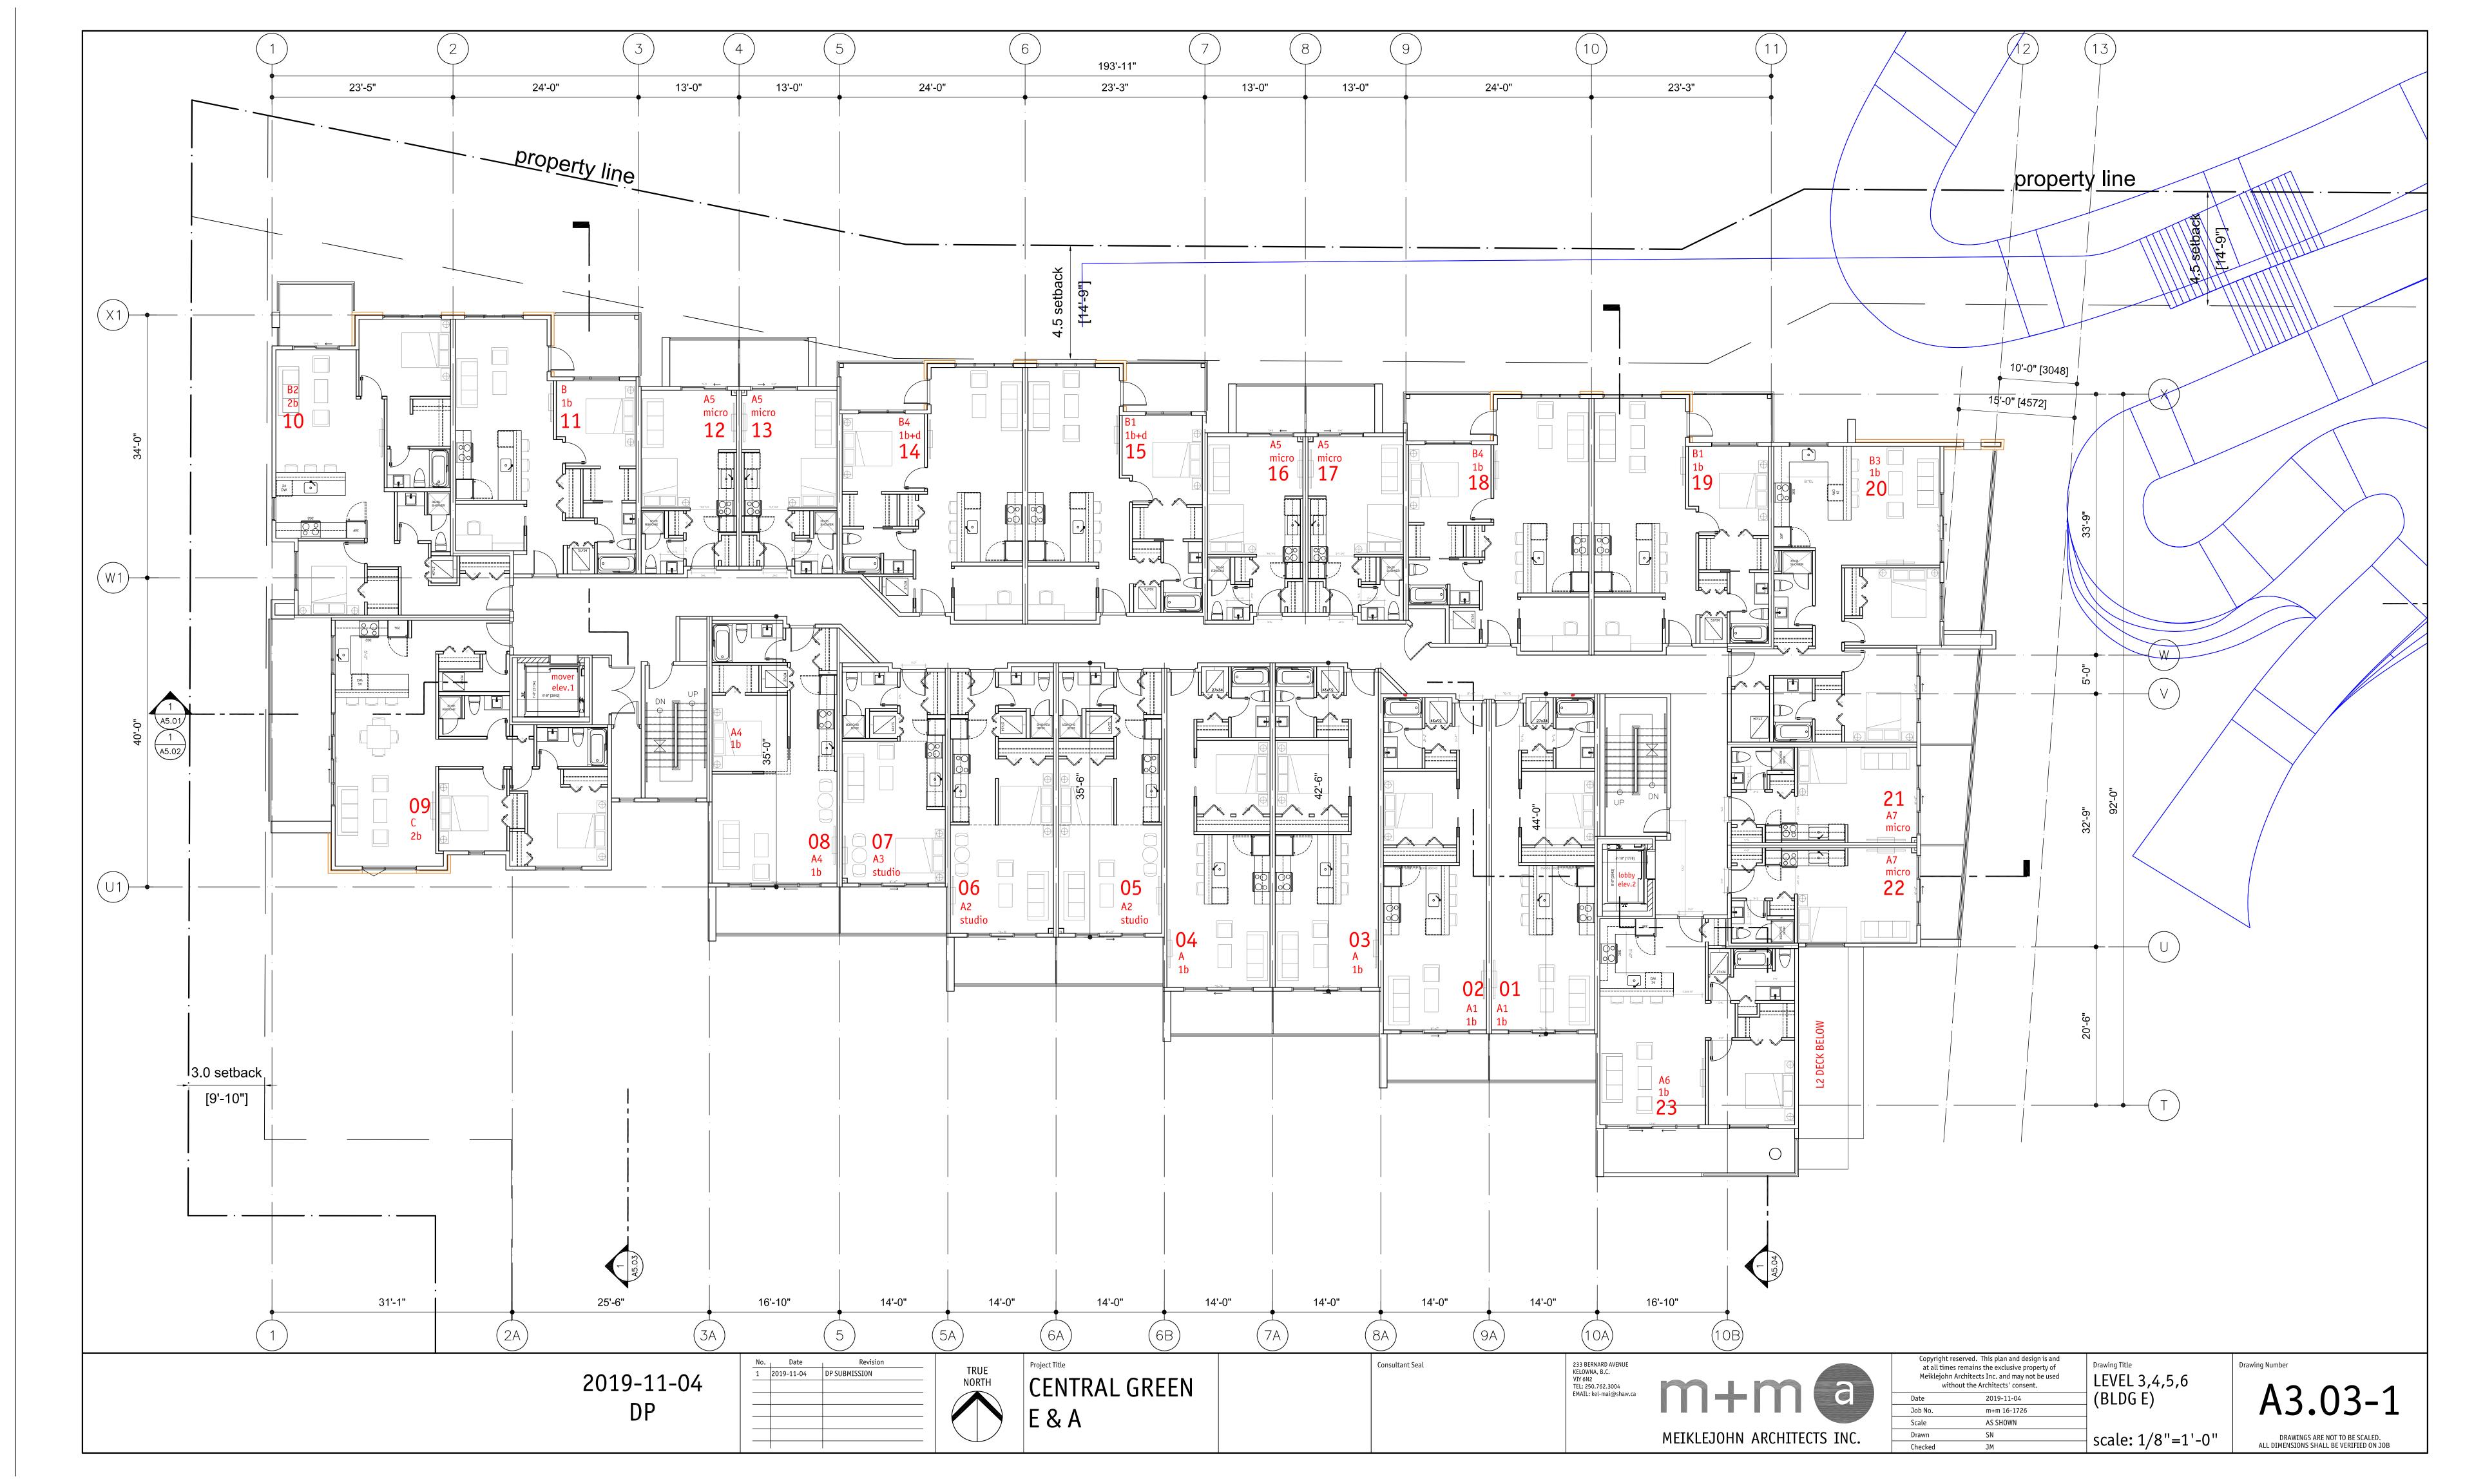





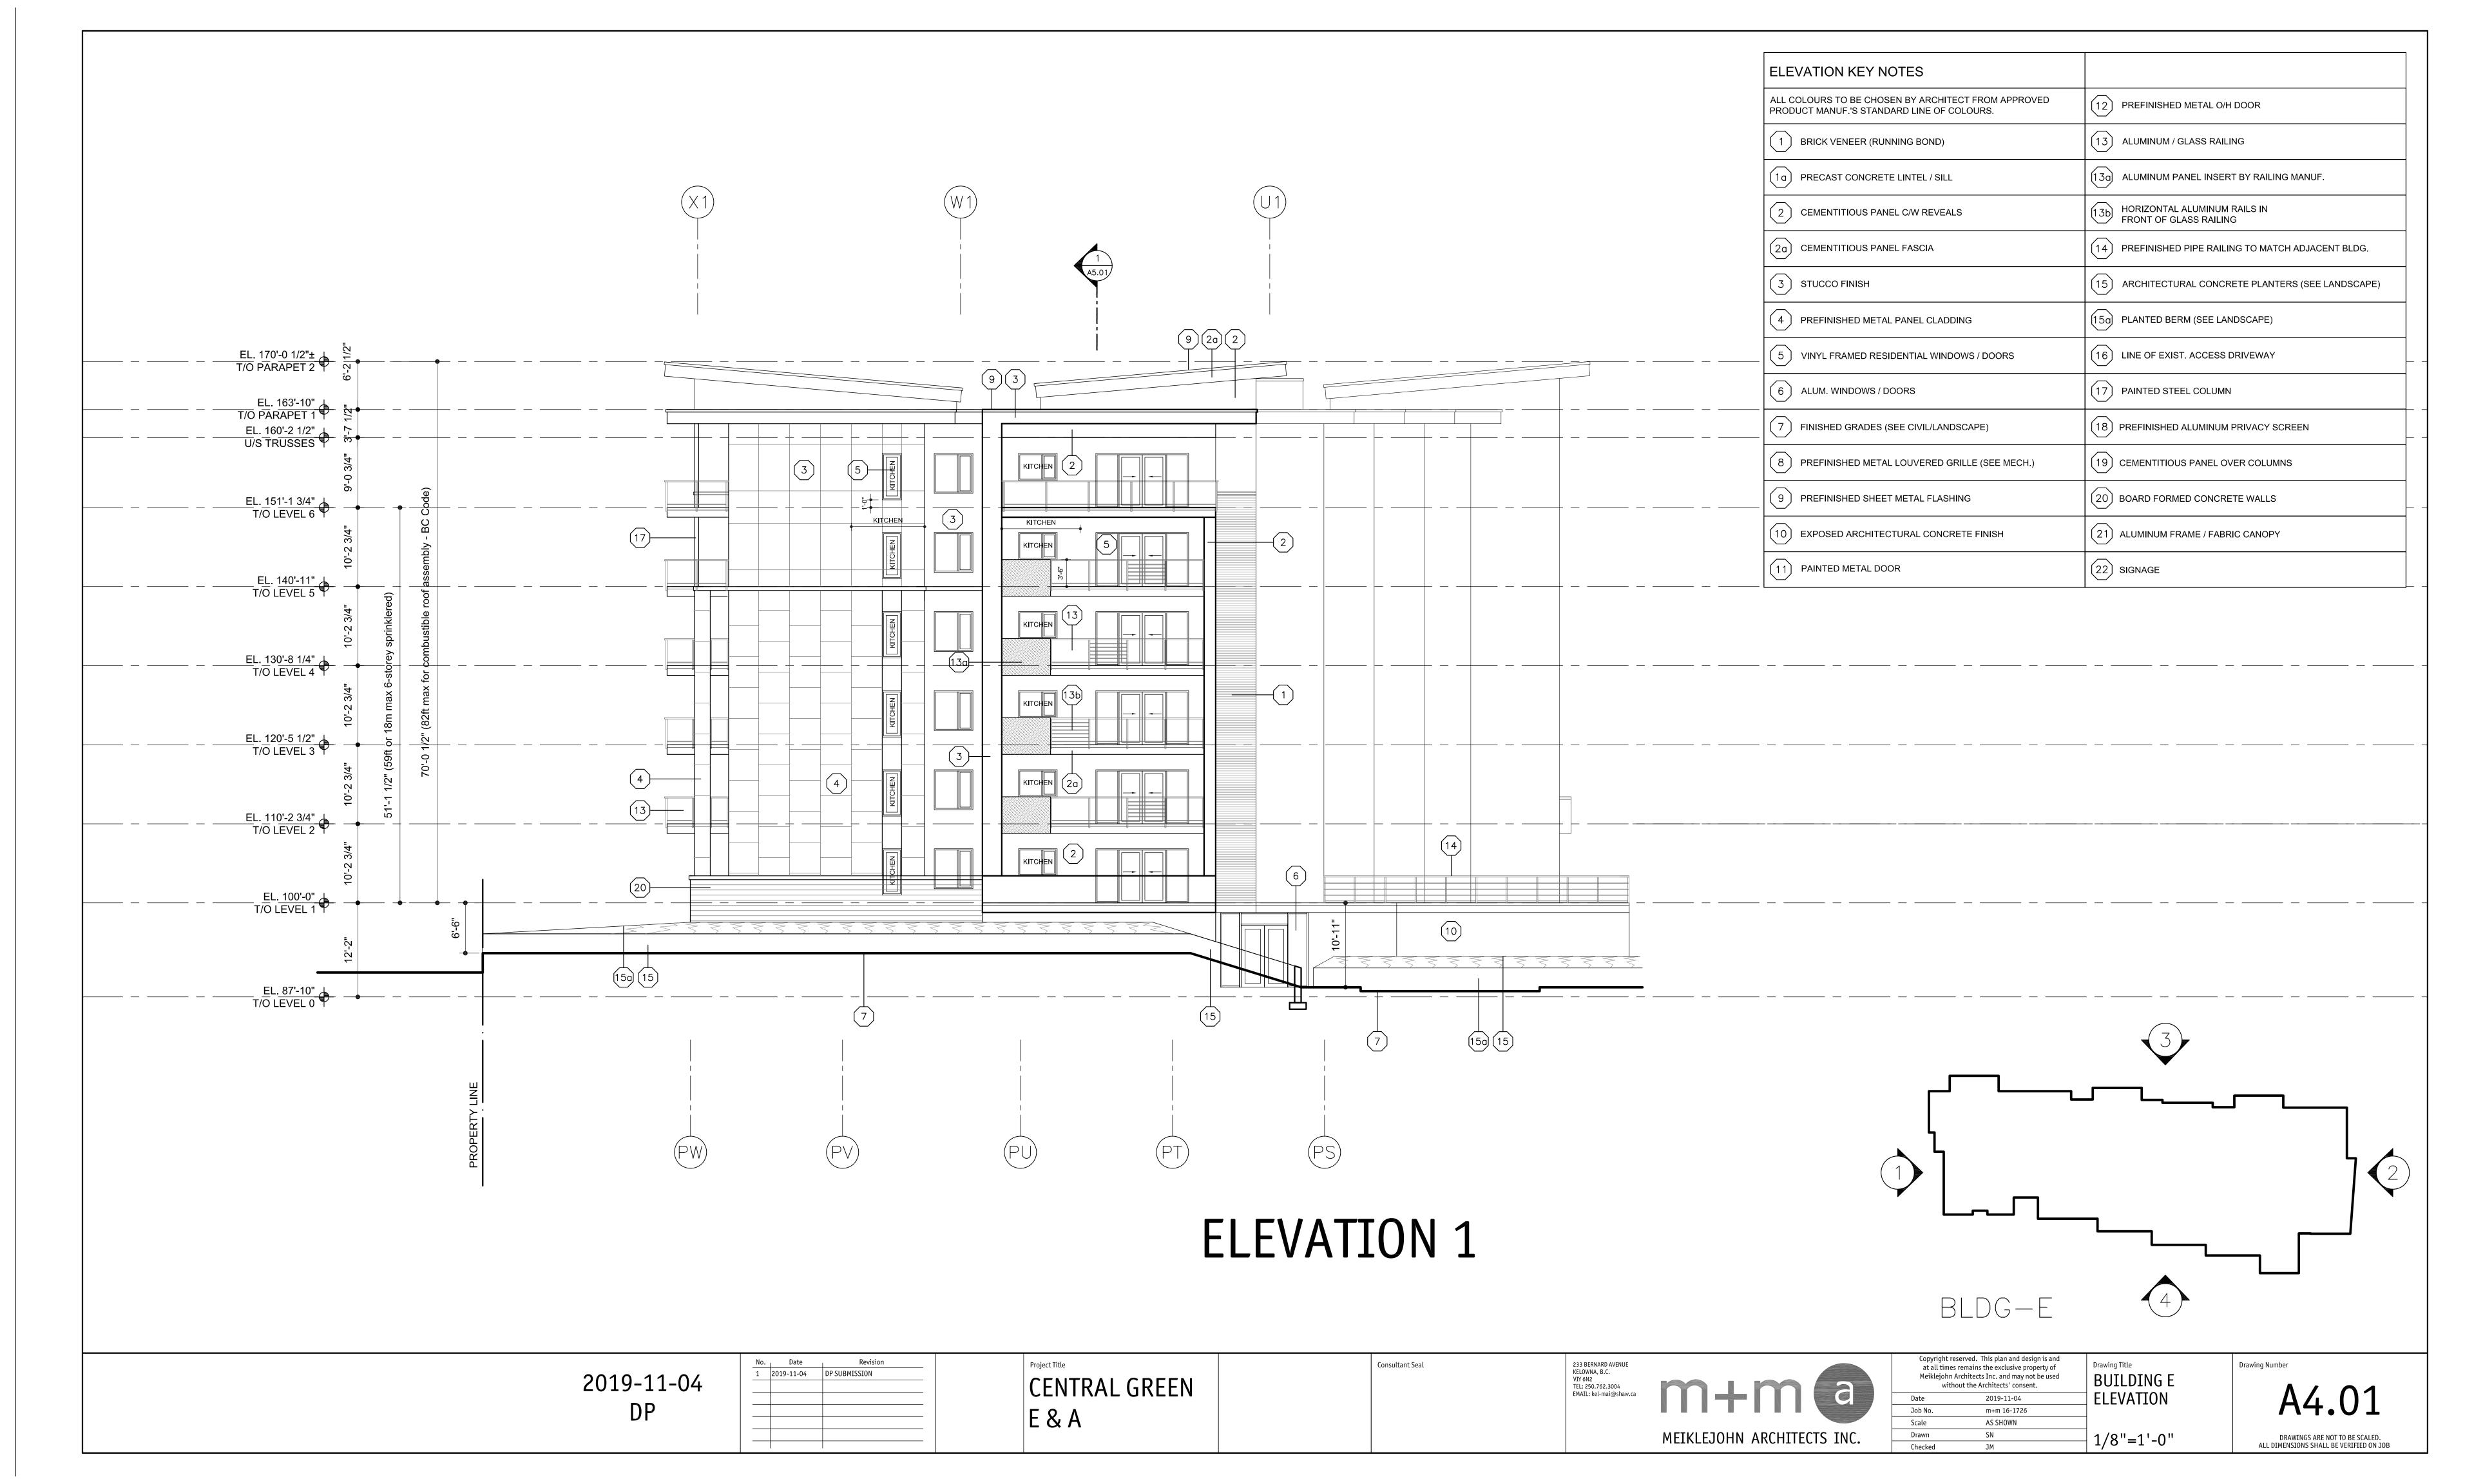



NOTE: SEE A4.01 FOR ELEVATION KEY NOTE LEGEND & KEY PLAN EL. 170'-0 1/2"± T/O PARAPET 2 EL. 163'-10" T/O PARAPET 1 EL. 160'-2 1/2" U/S TRUSSES EL. 151'-1 3/4" T/O LEVEL 6 EL. 140'-11"
T/O LEVEL 5 EL. 130'-8 1/4" T/O LEVEL 4 EL. 120'-5 1/2" T/O LEVEL 3 EL. 110'-2 3/4" T/O LEVEL 2 SIGNAGE SIGNAGE EL. 100'-0" T/O LEVEL 1 exist. city 7 side walk parkade ELEVATION 2 Copyright reserved. This plan and design is and at all times remains the exclusive property of No. | Date | Revision Drawing Title
BUILDING E Drawing Number Consultant Seal 2019-11-04 DP SUBMISSION 2019-11-04 Meiklejohn Architects Inc. and may not be used without the Architects' consent. CENTRAL GREEN A4.02 **ELEVATION** 2019-11-04 E & A m+m 16-1726 AS SHOWN MEIKLEJOHN ARCHITECTS INC. 1/8"=1'-0"

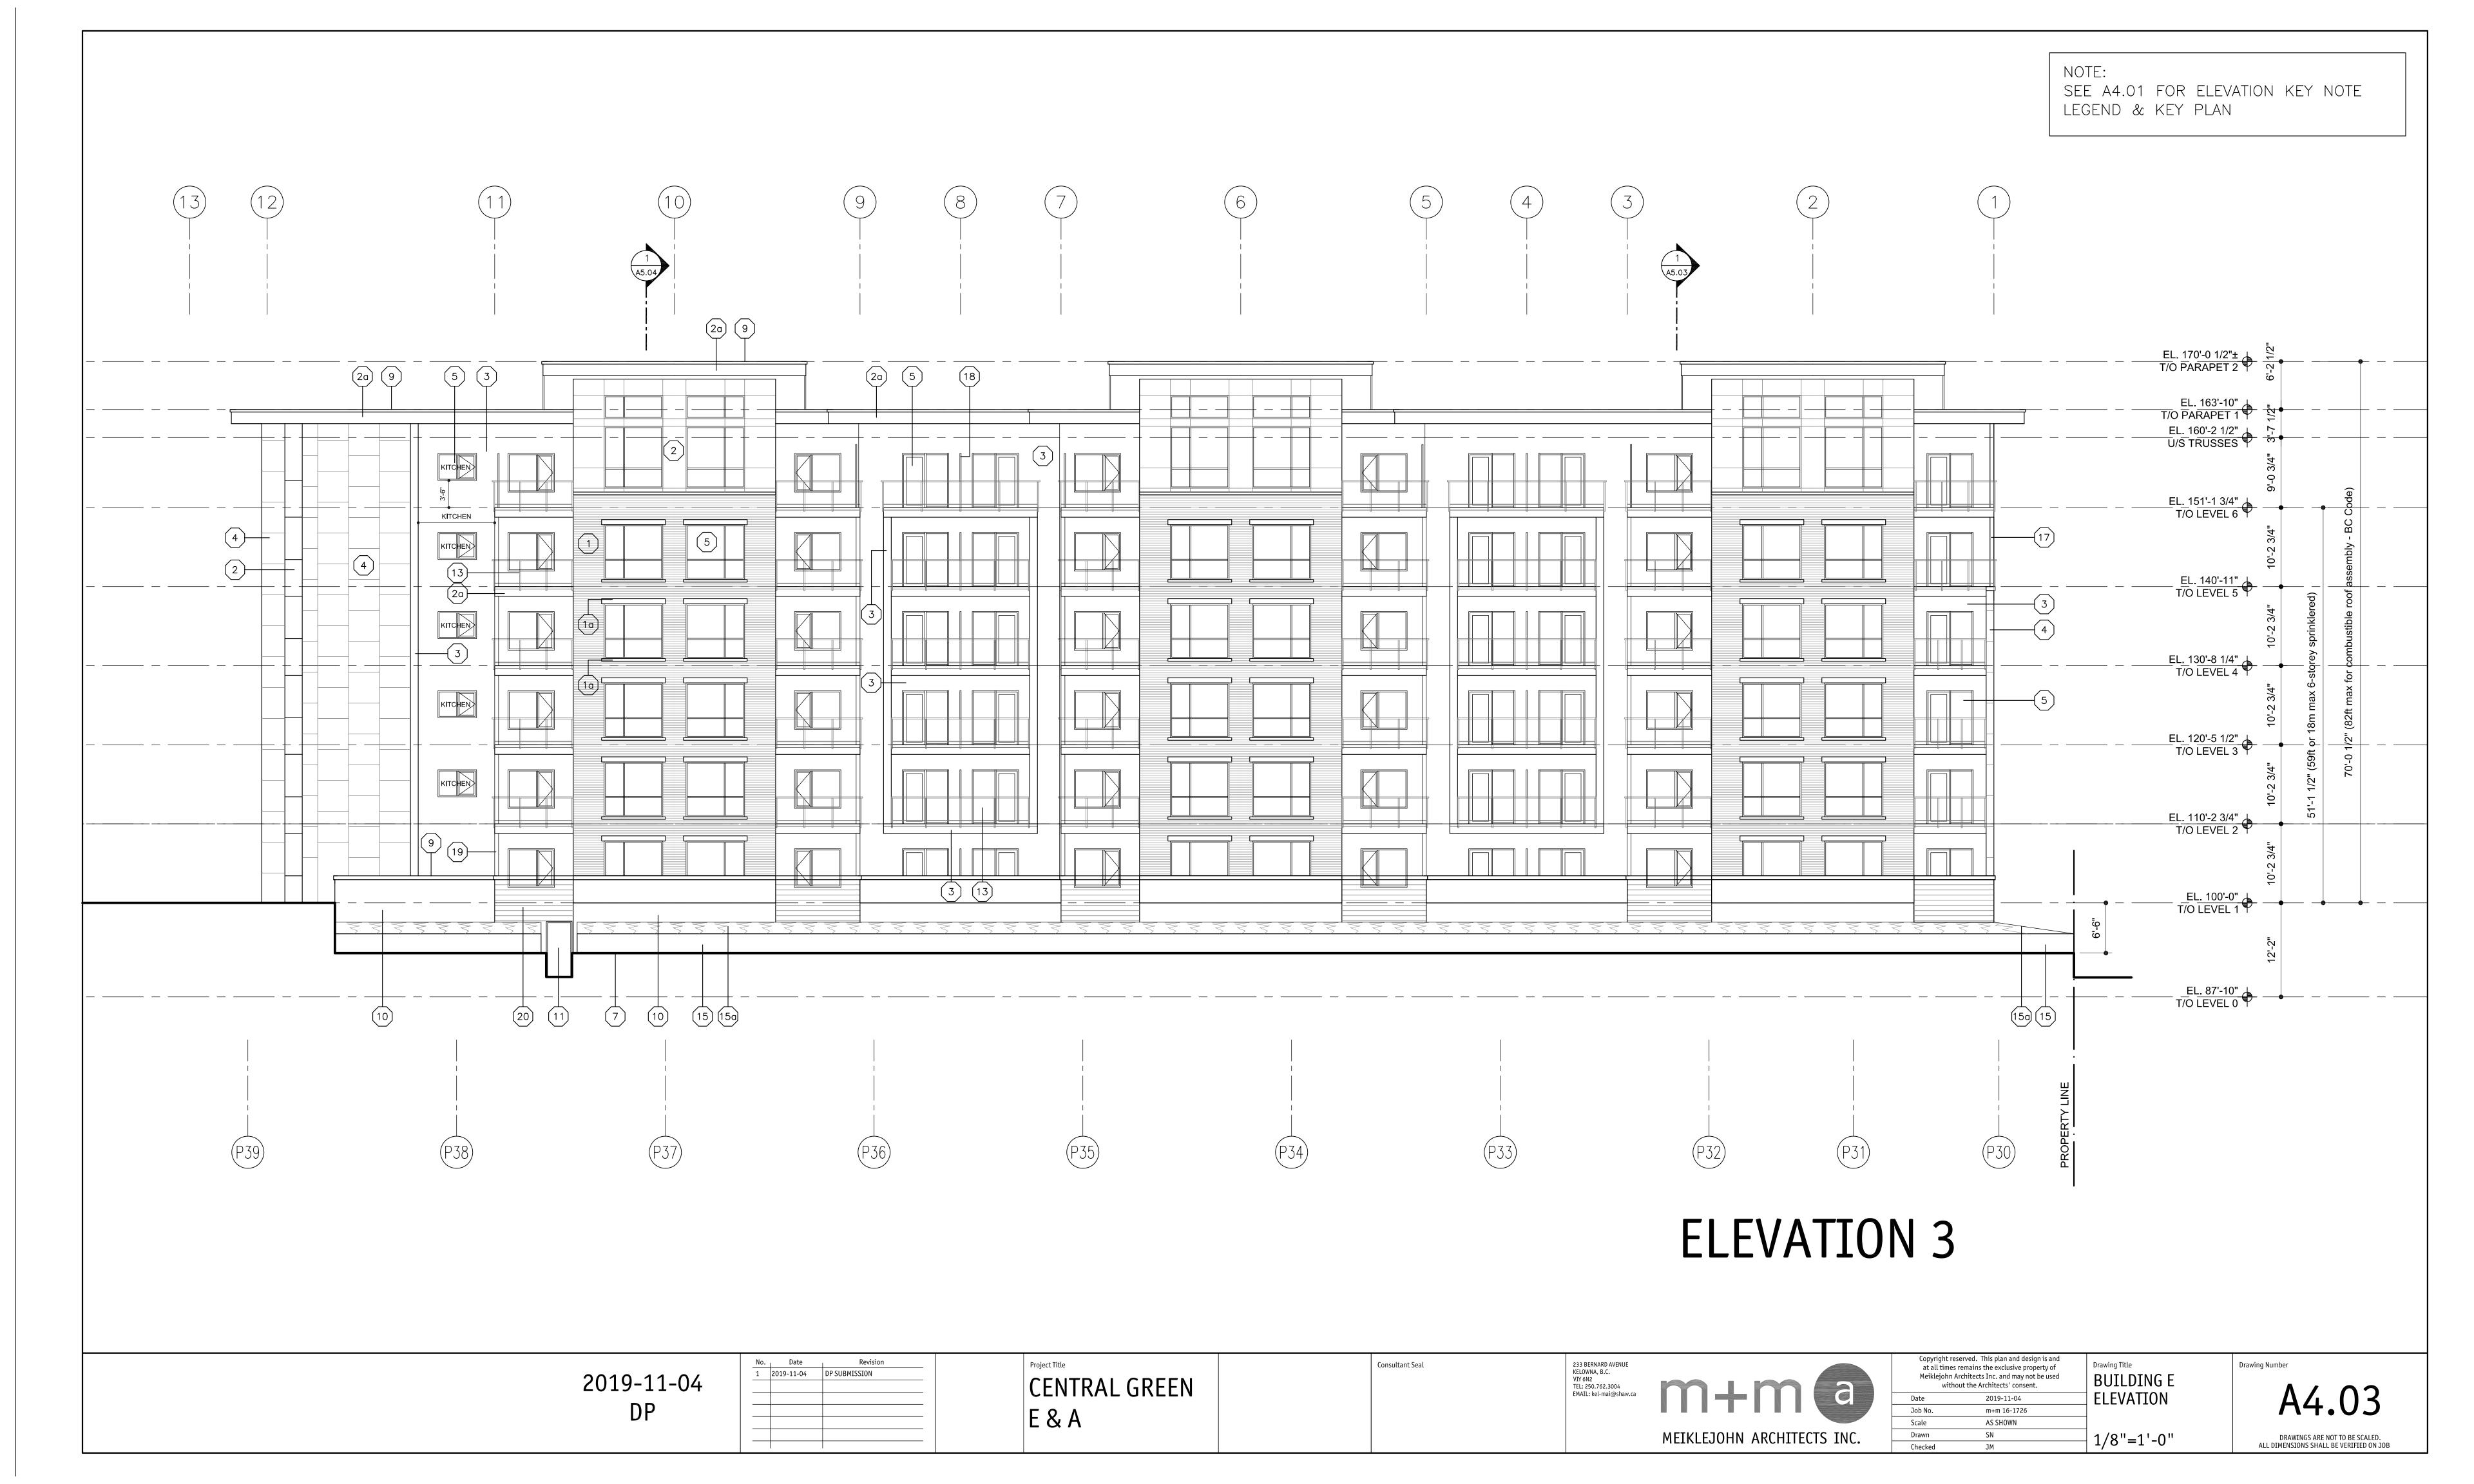


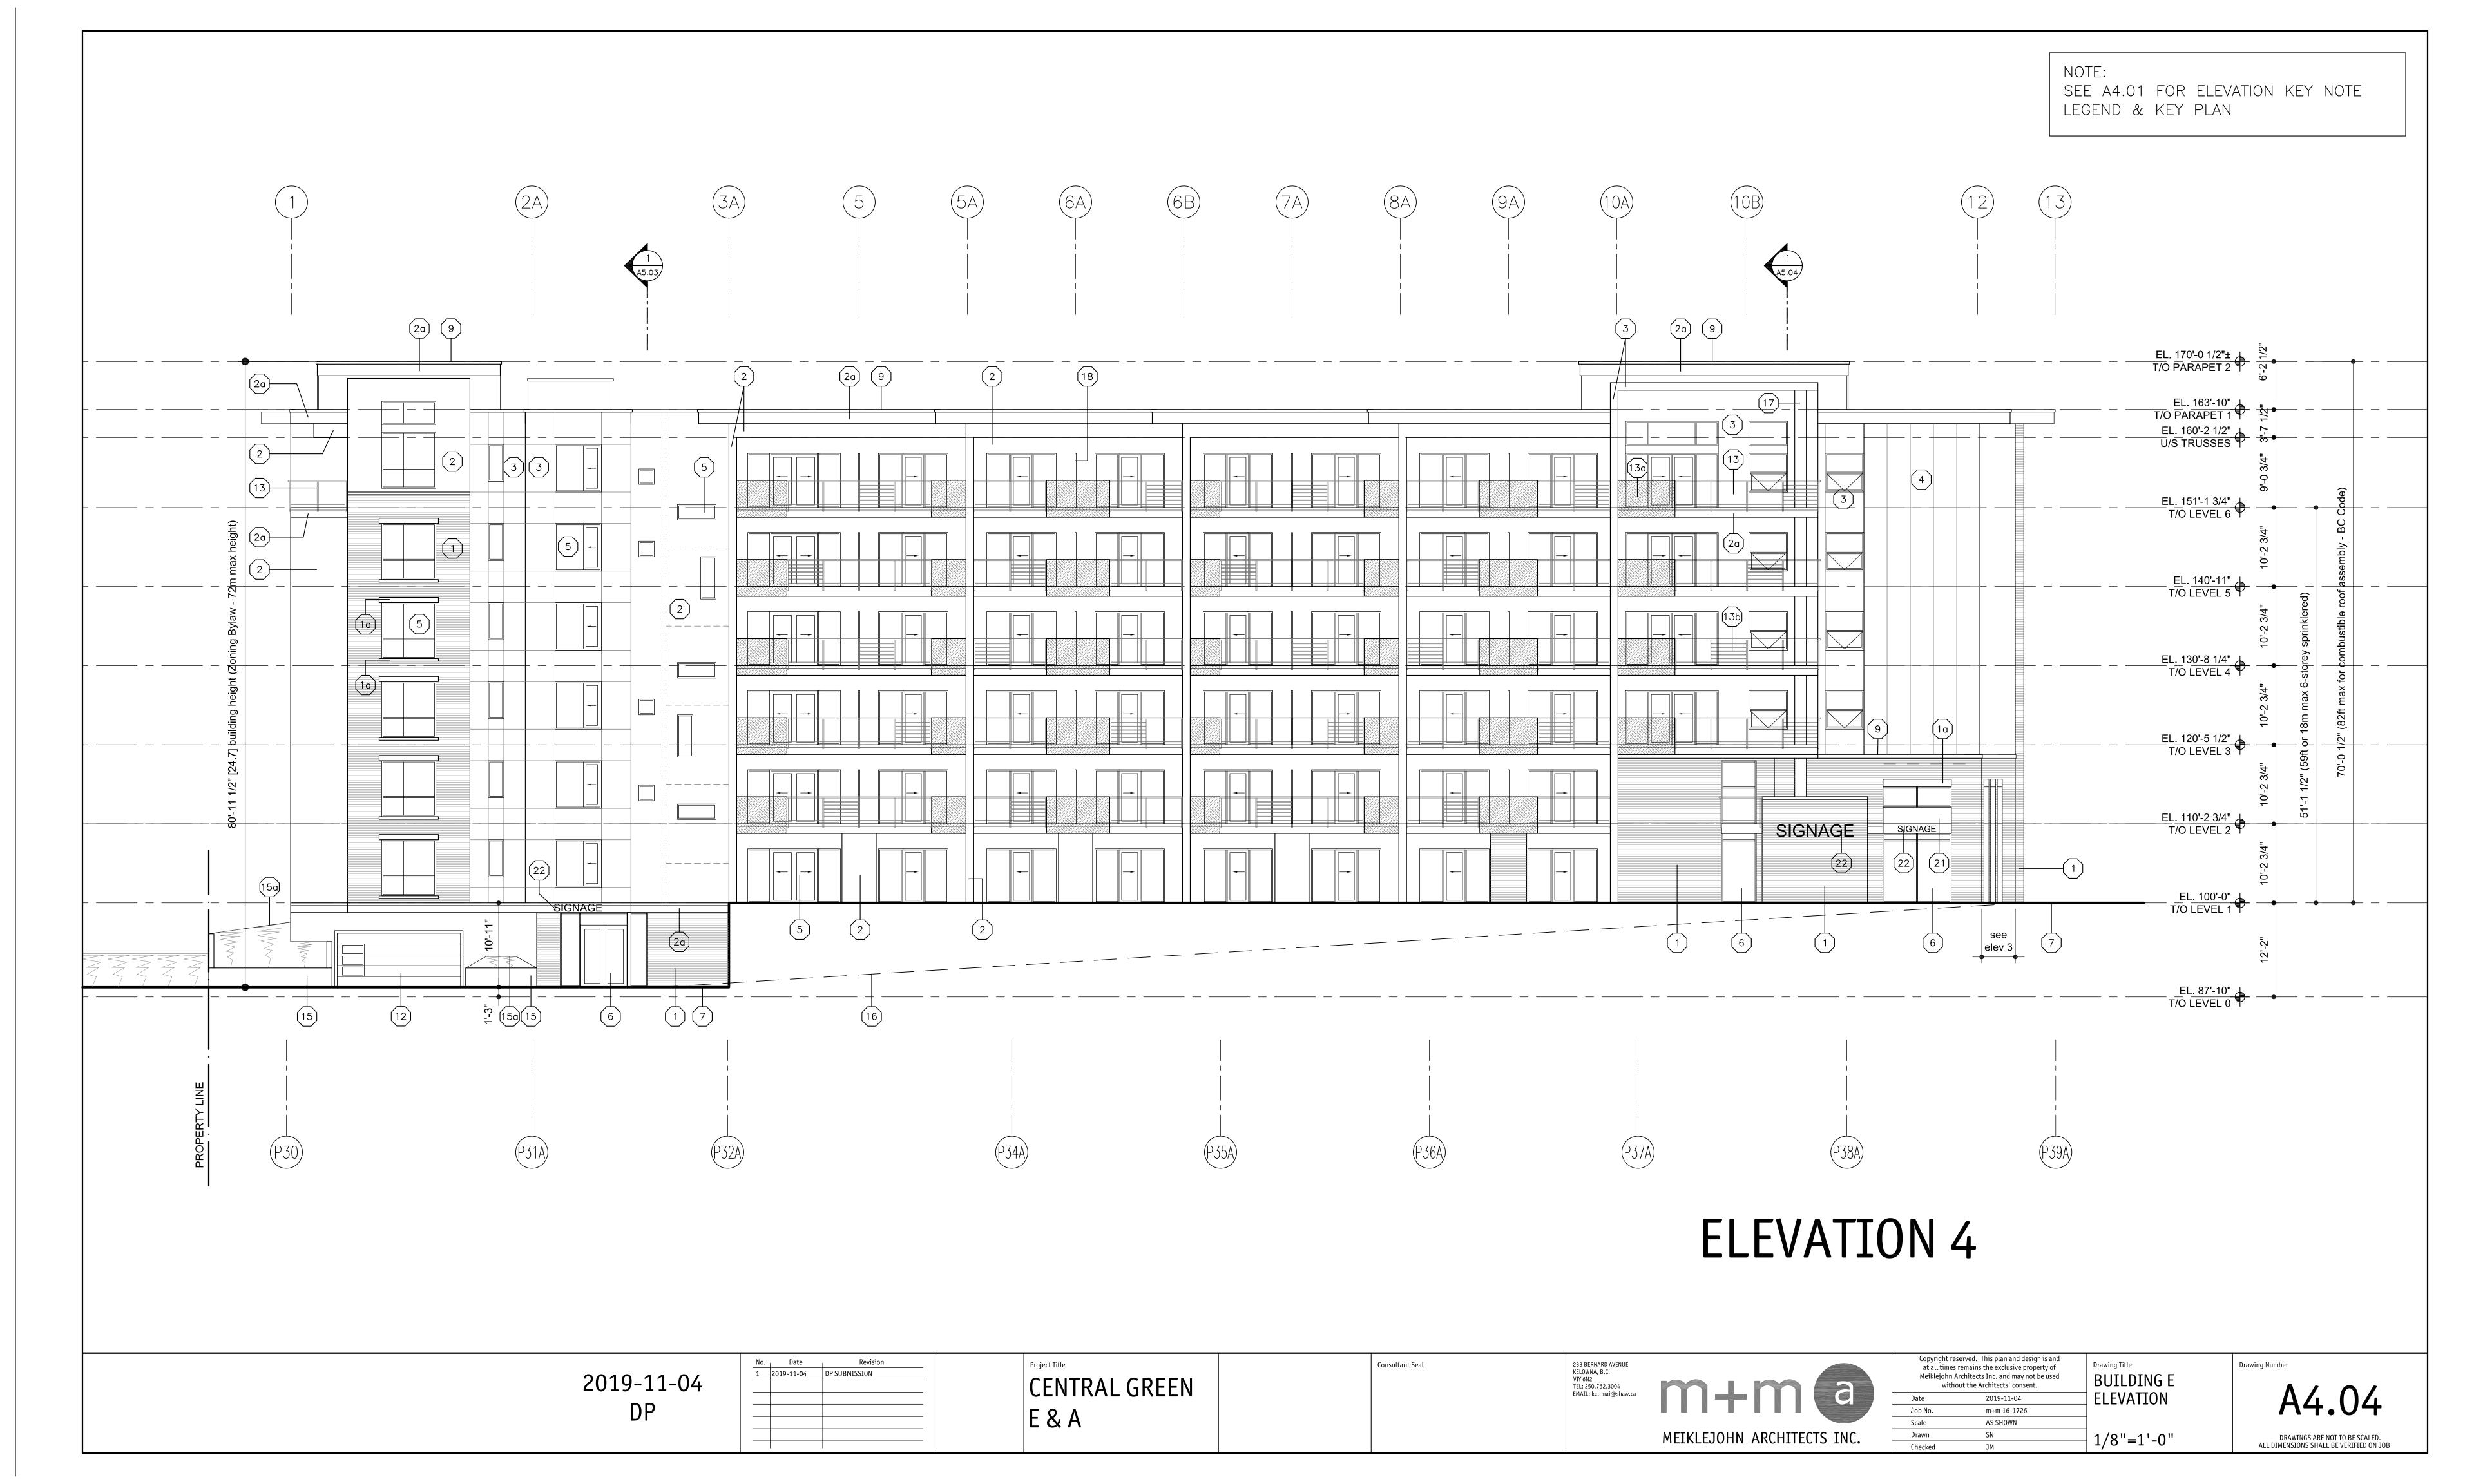


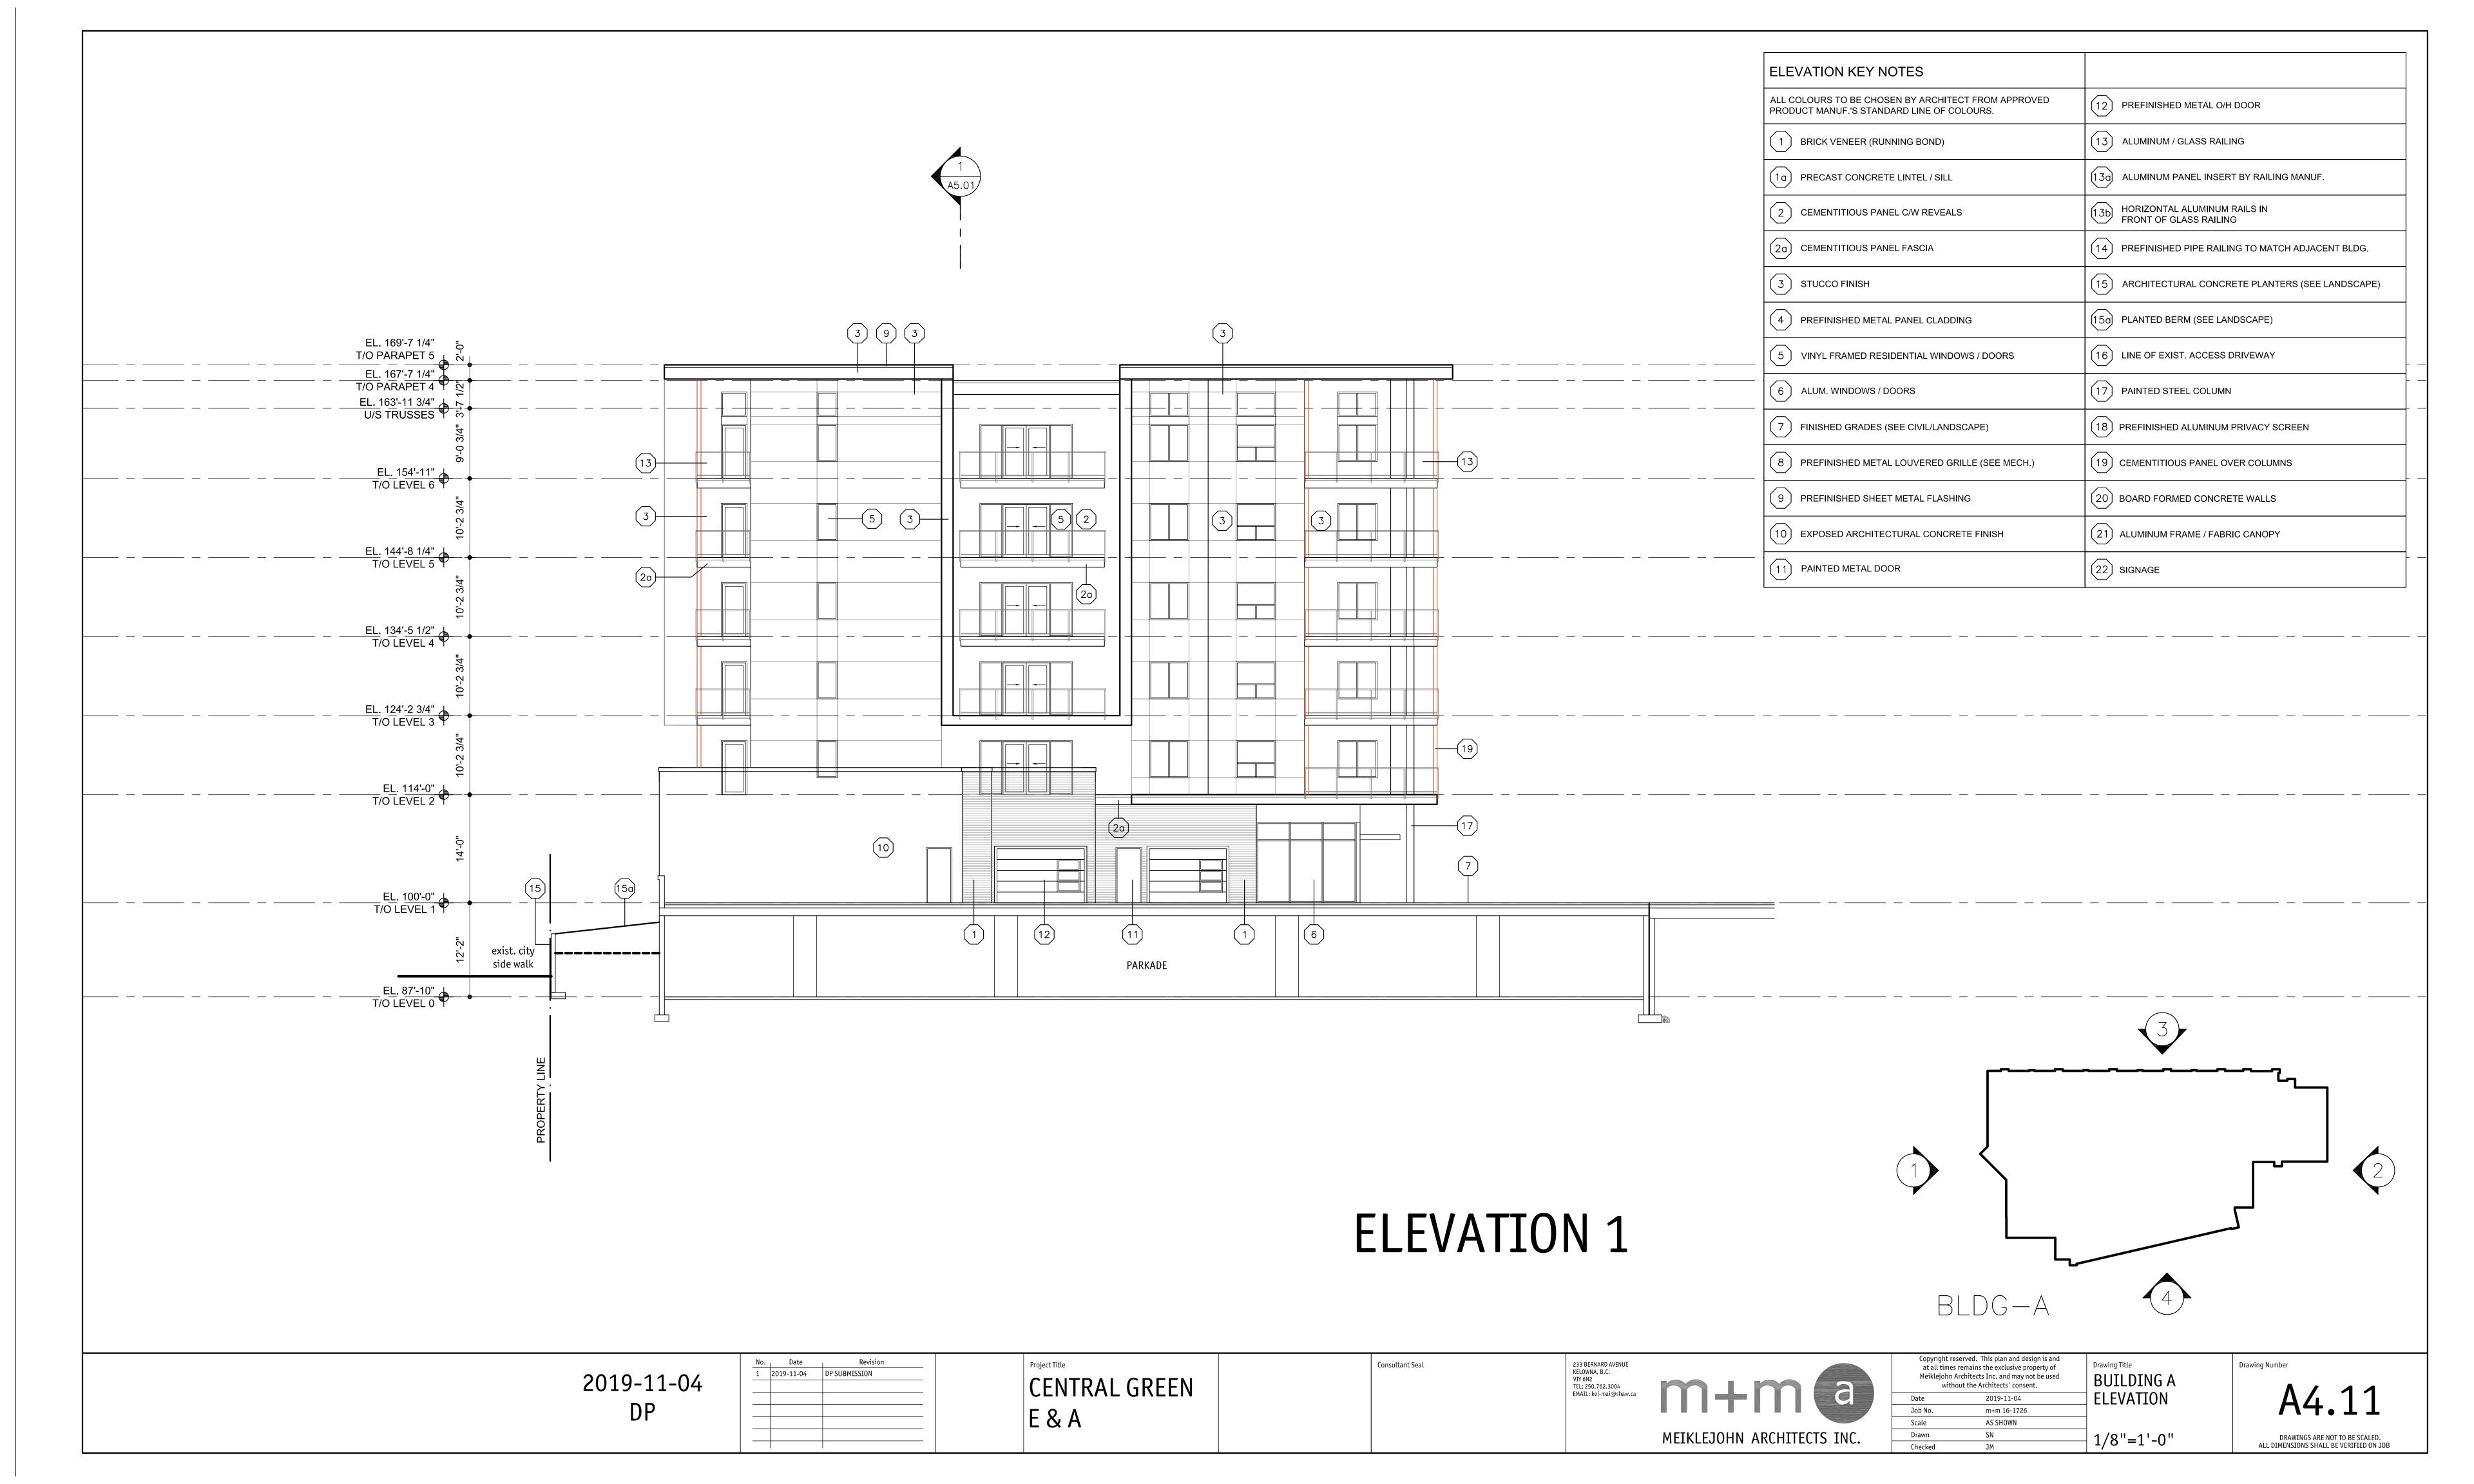


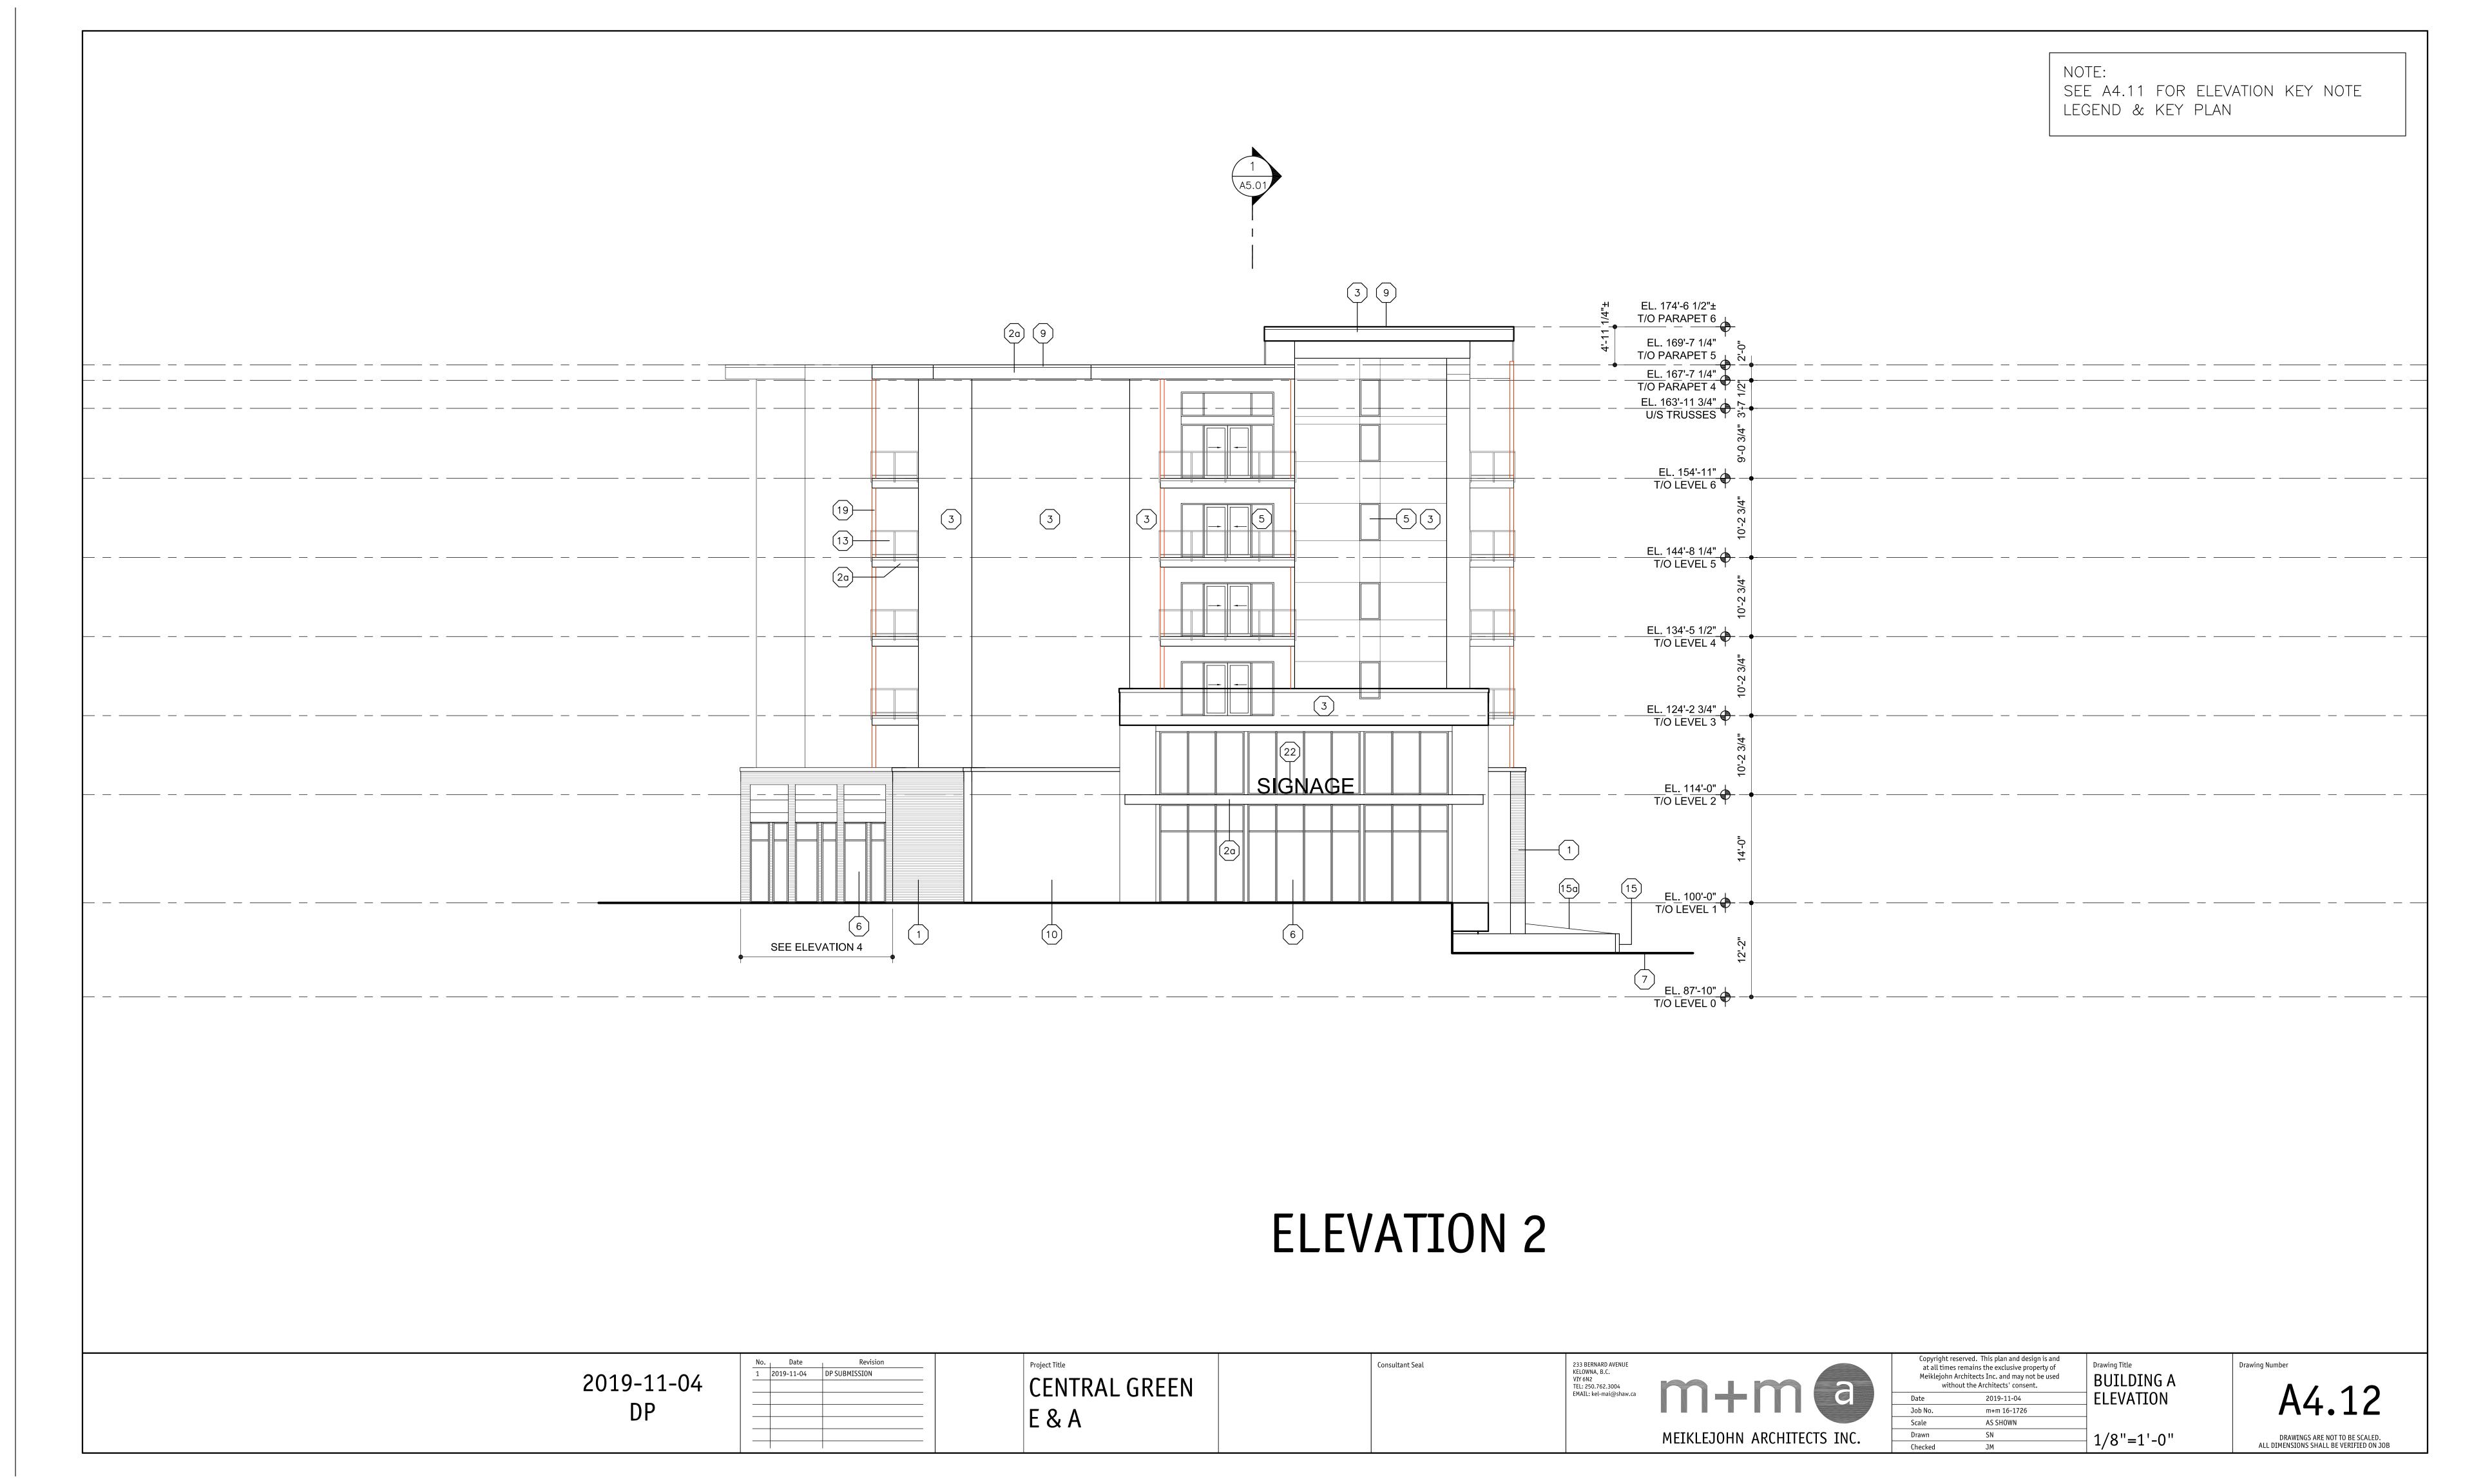


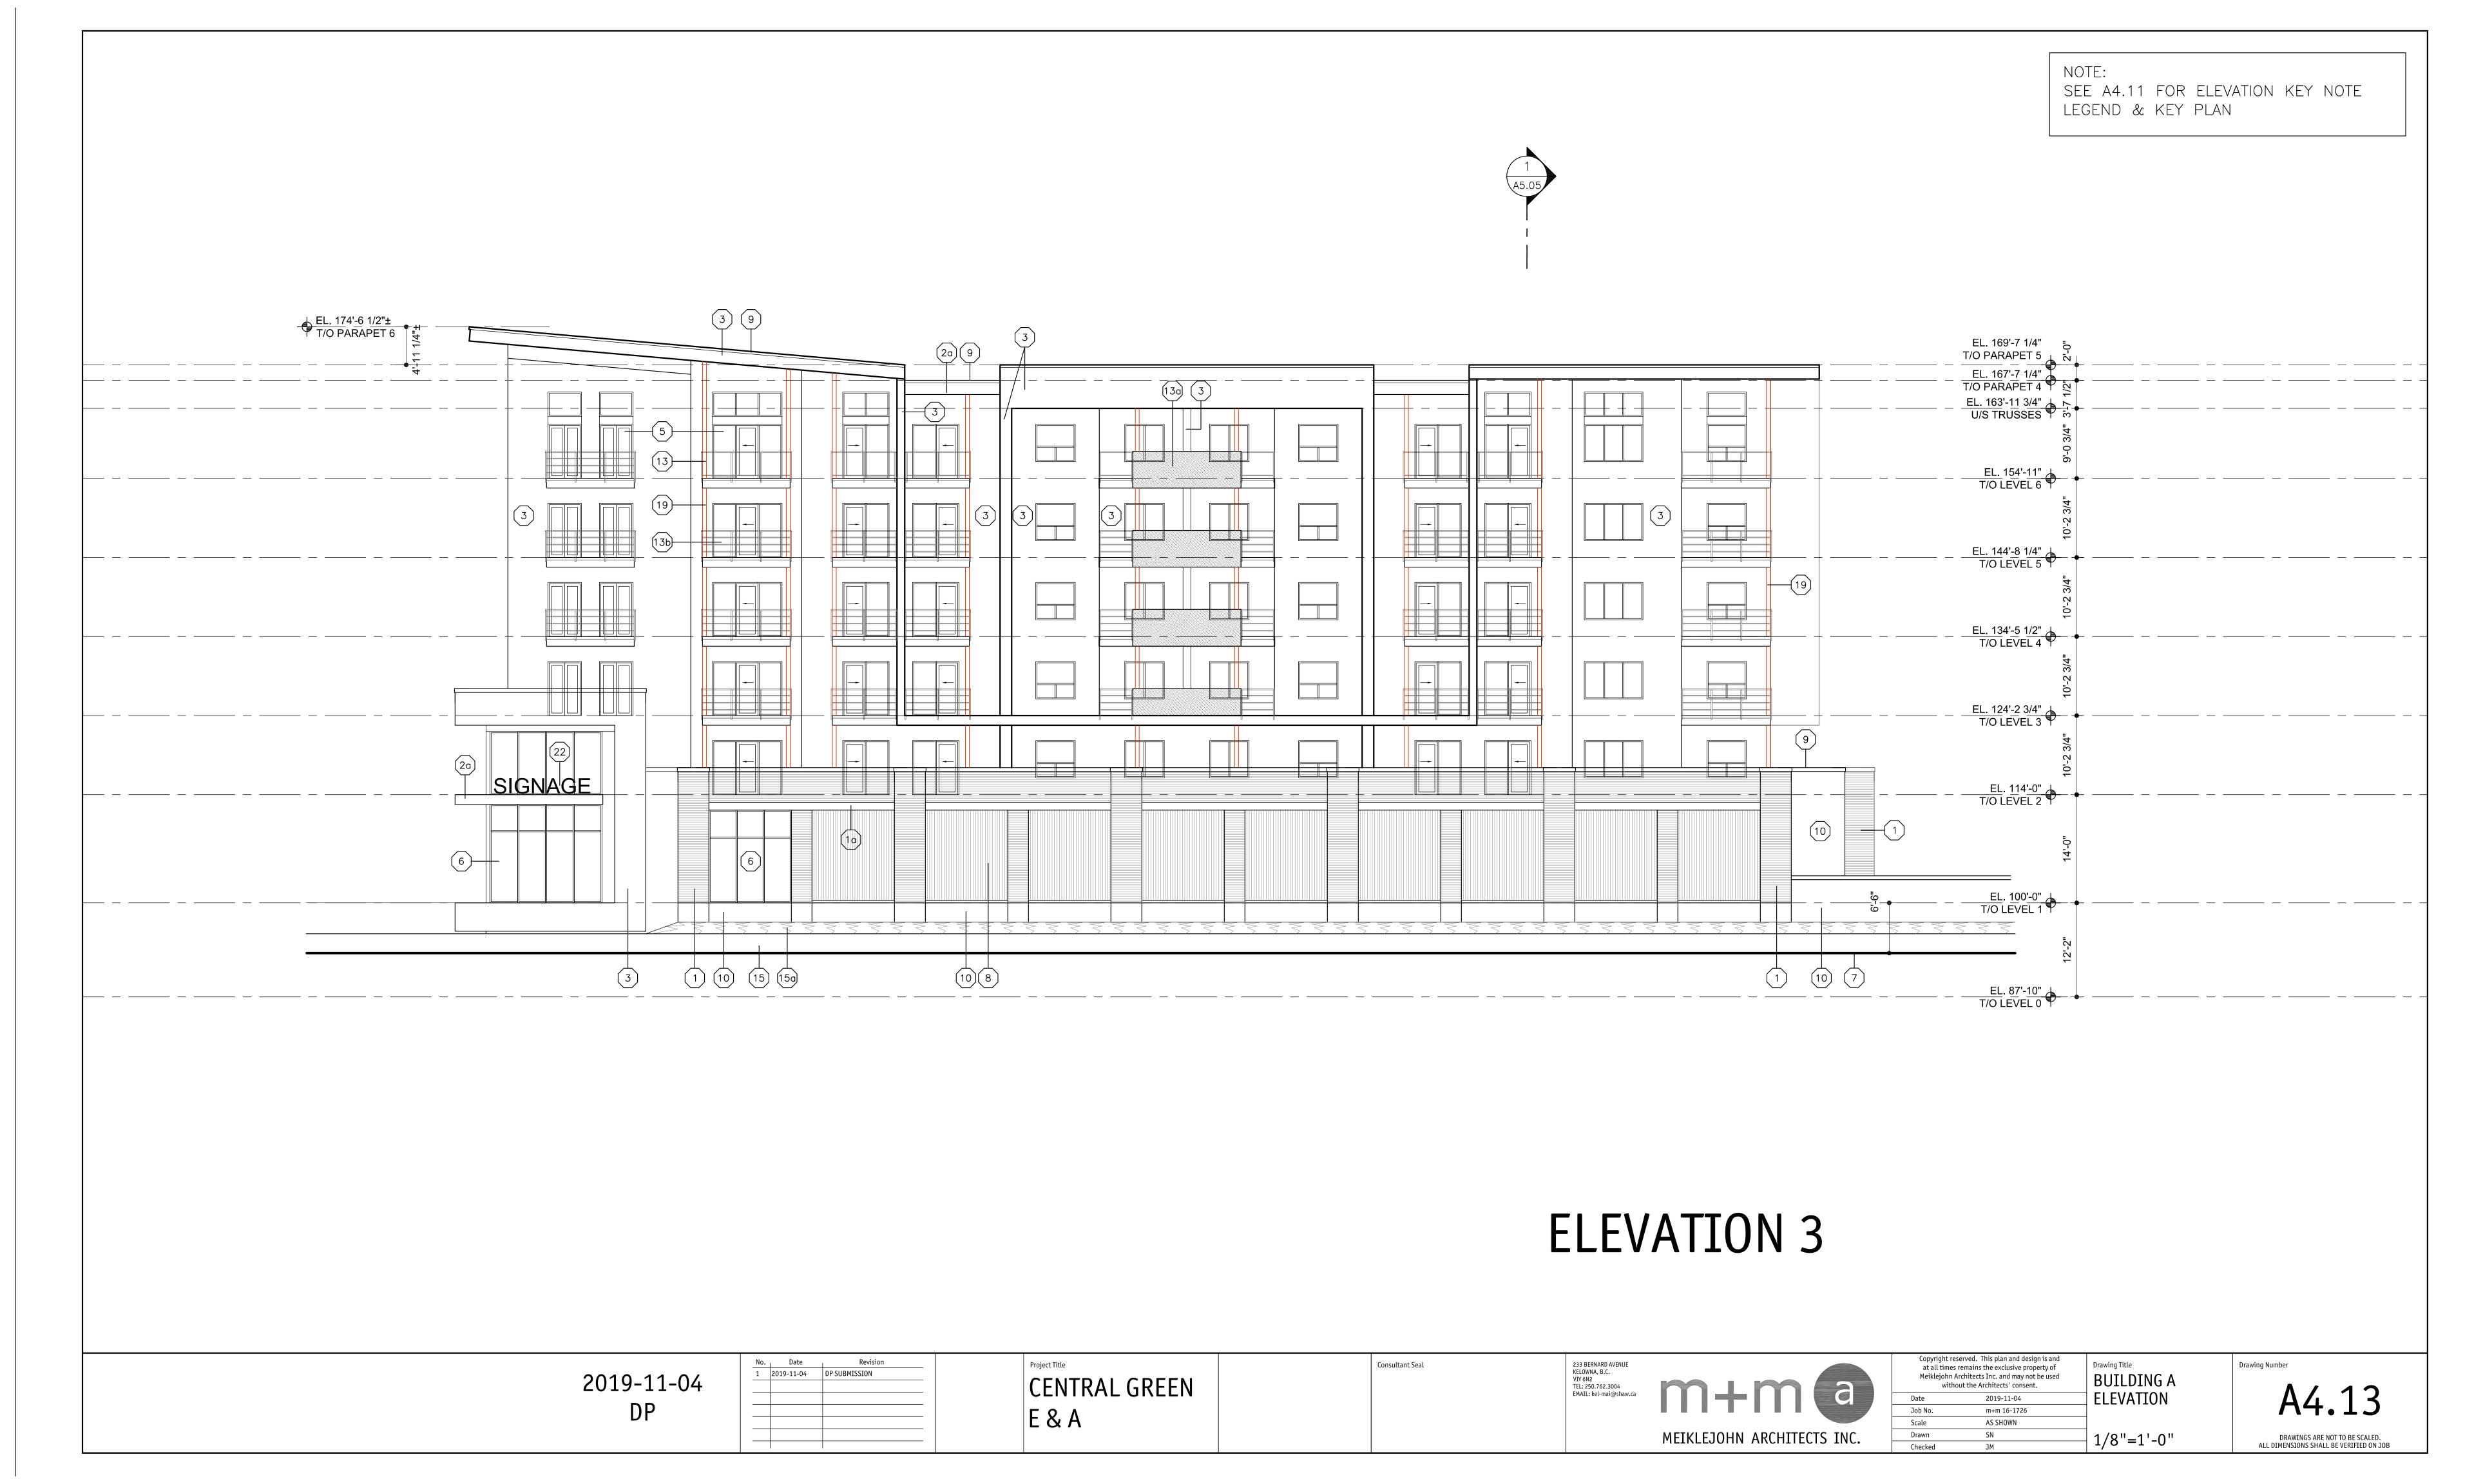


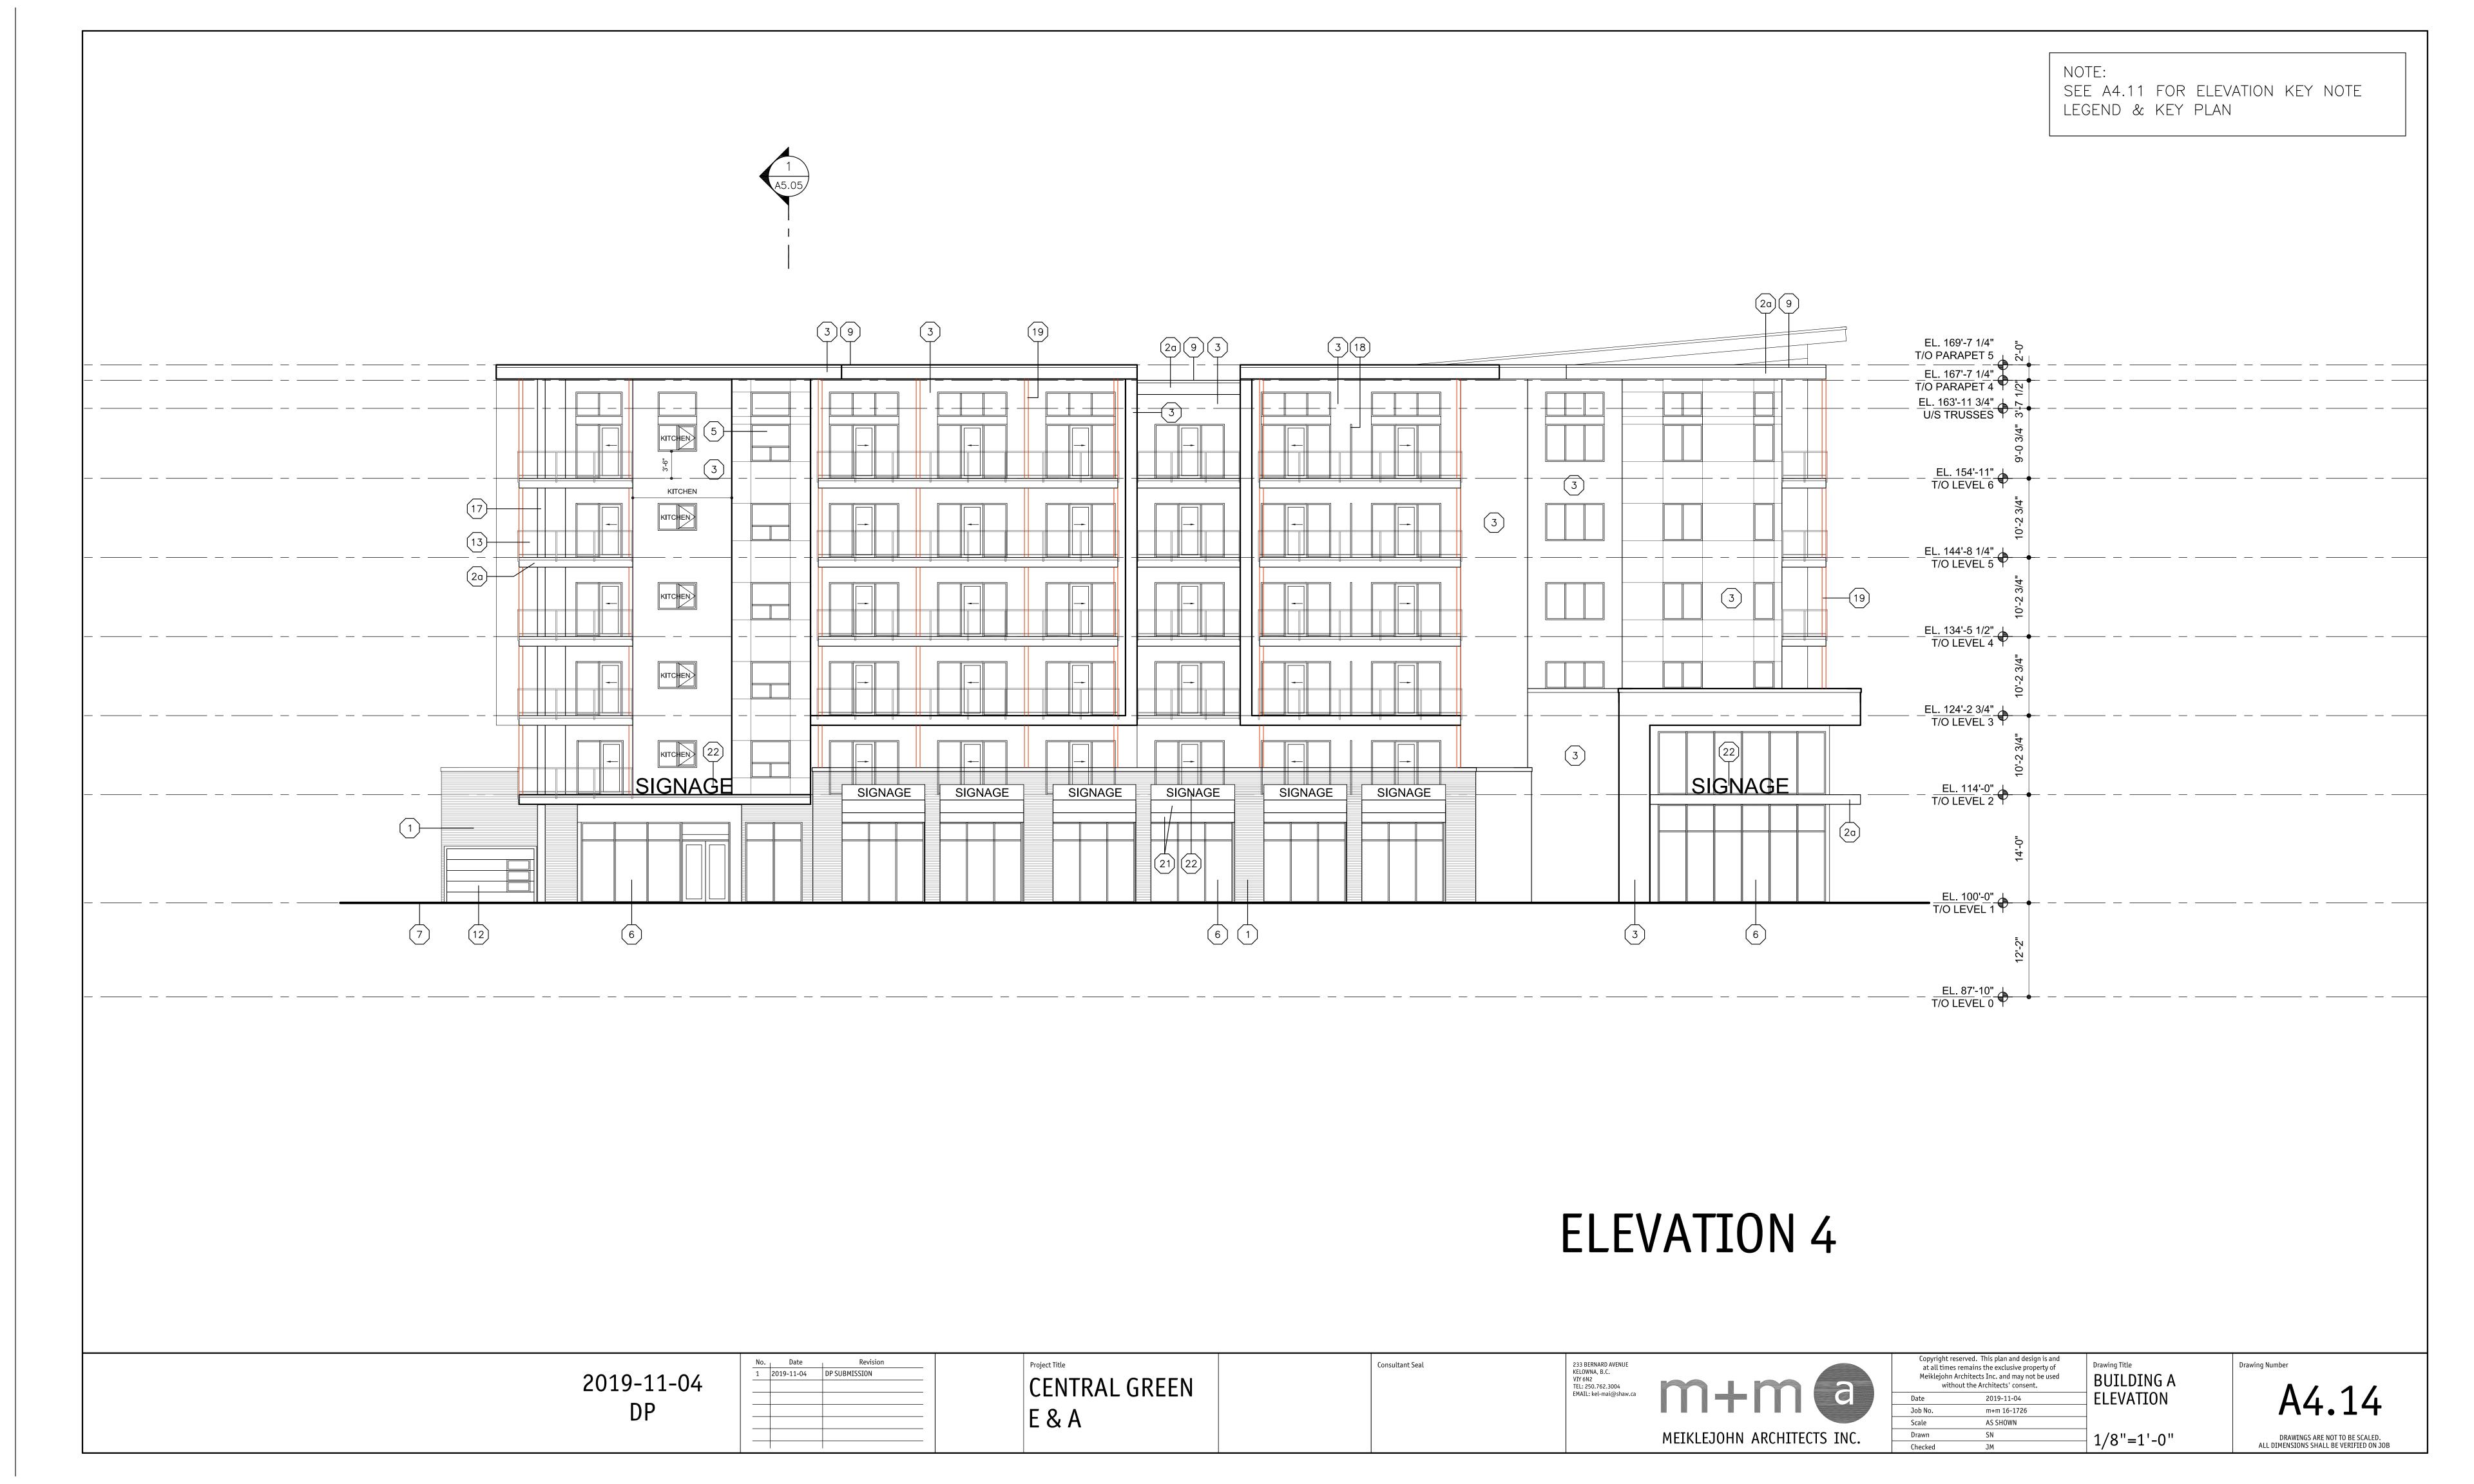


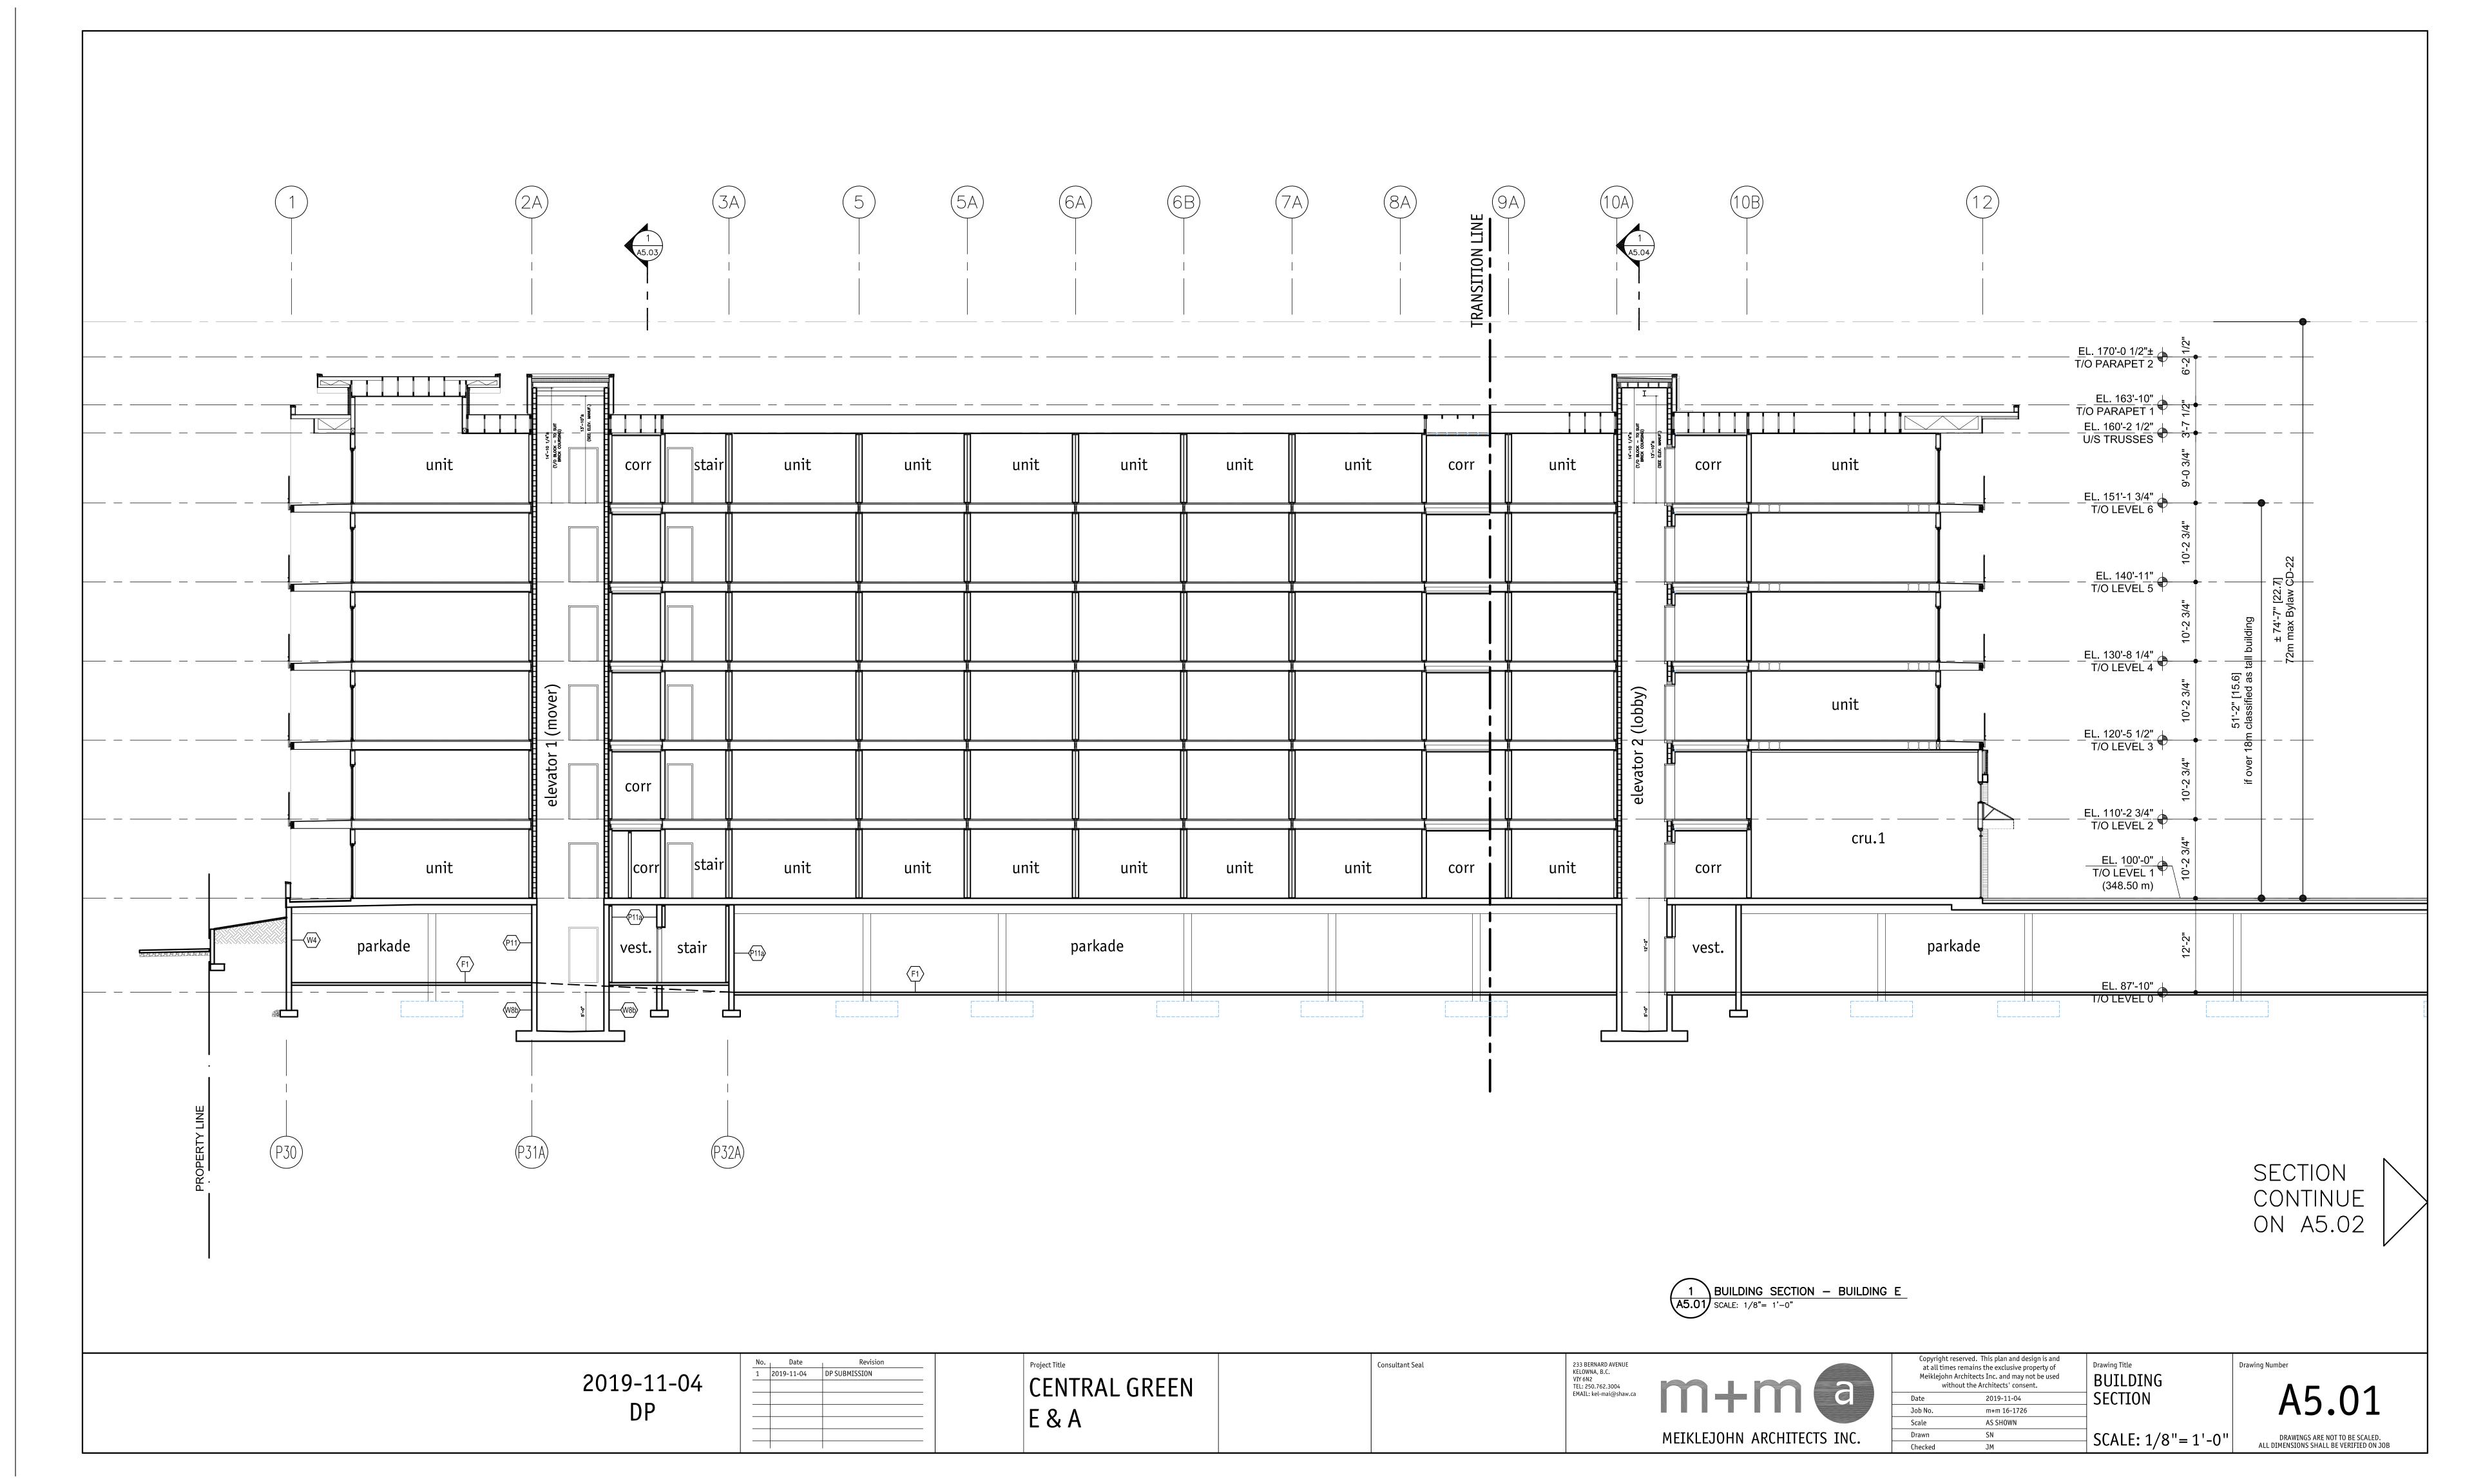


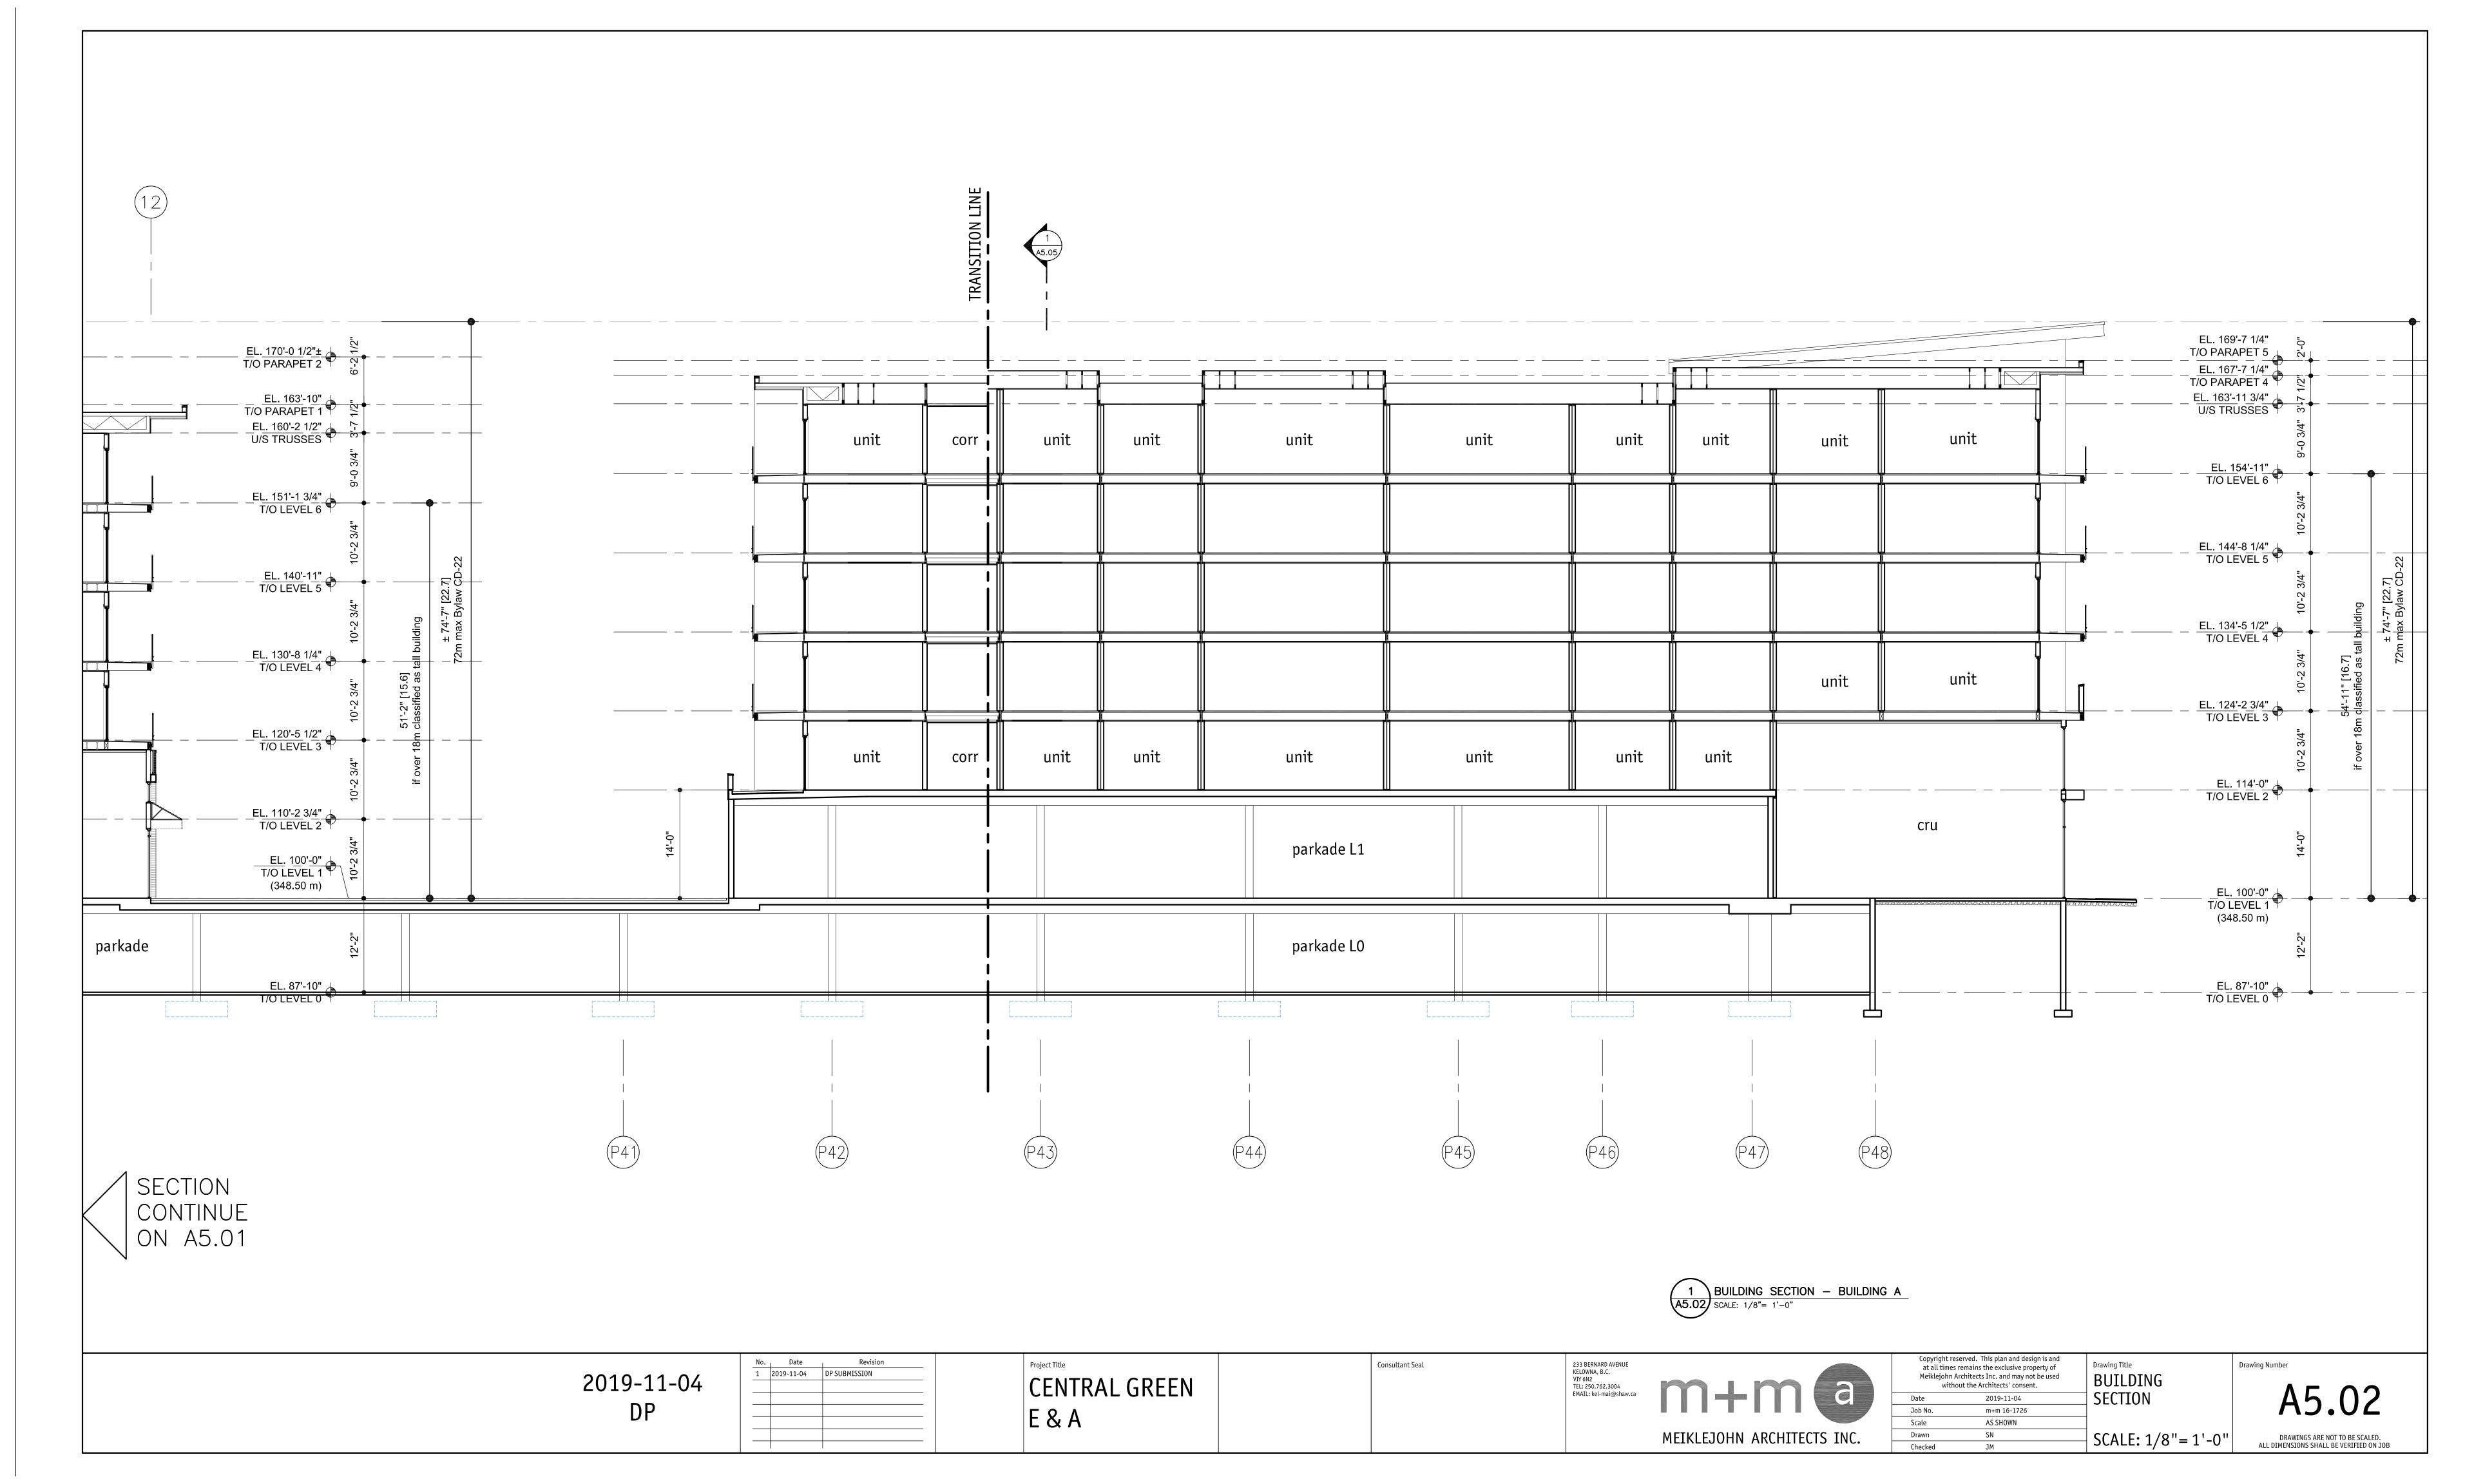

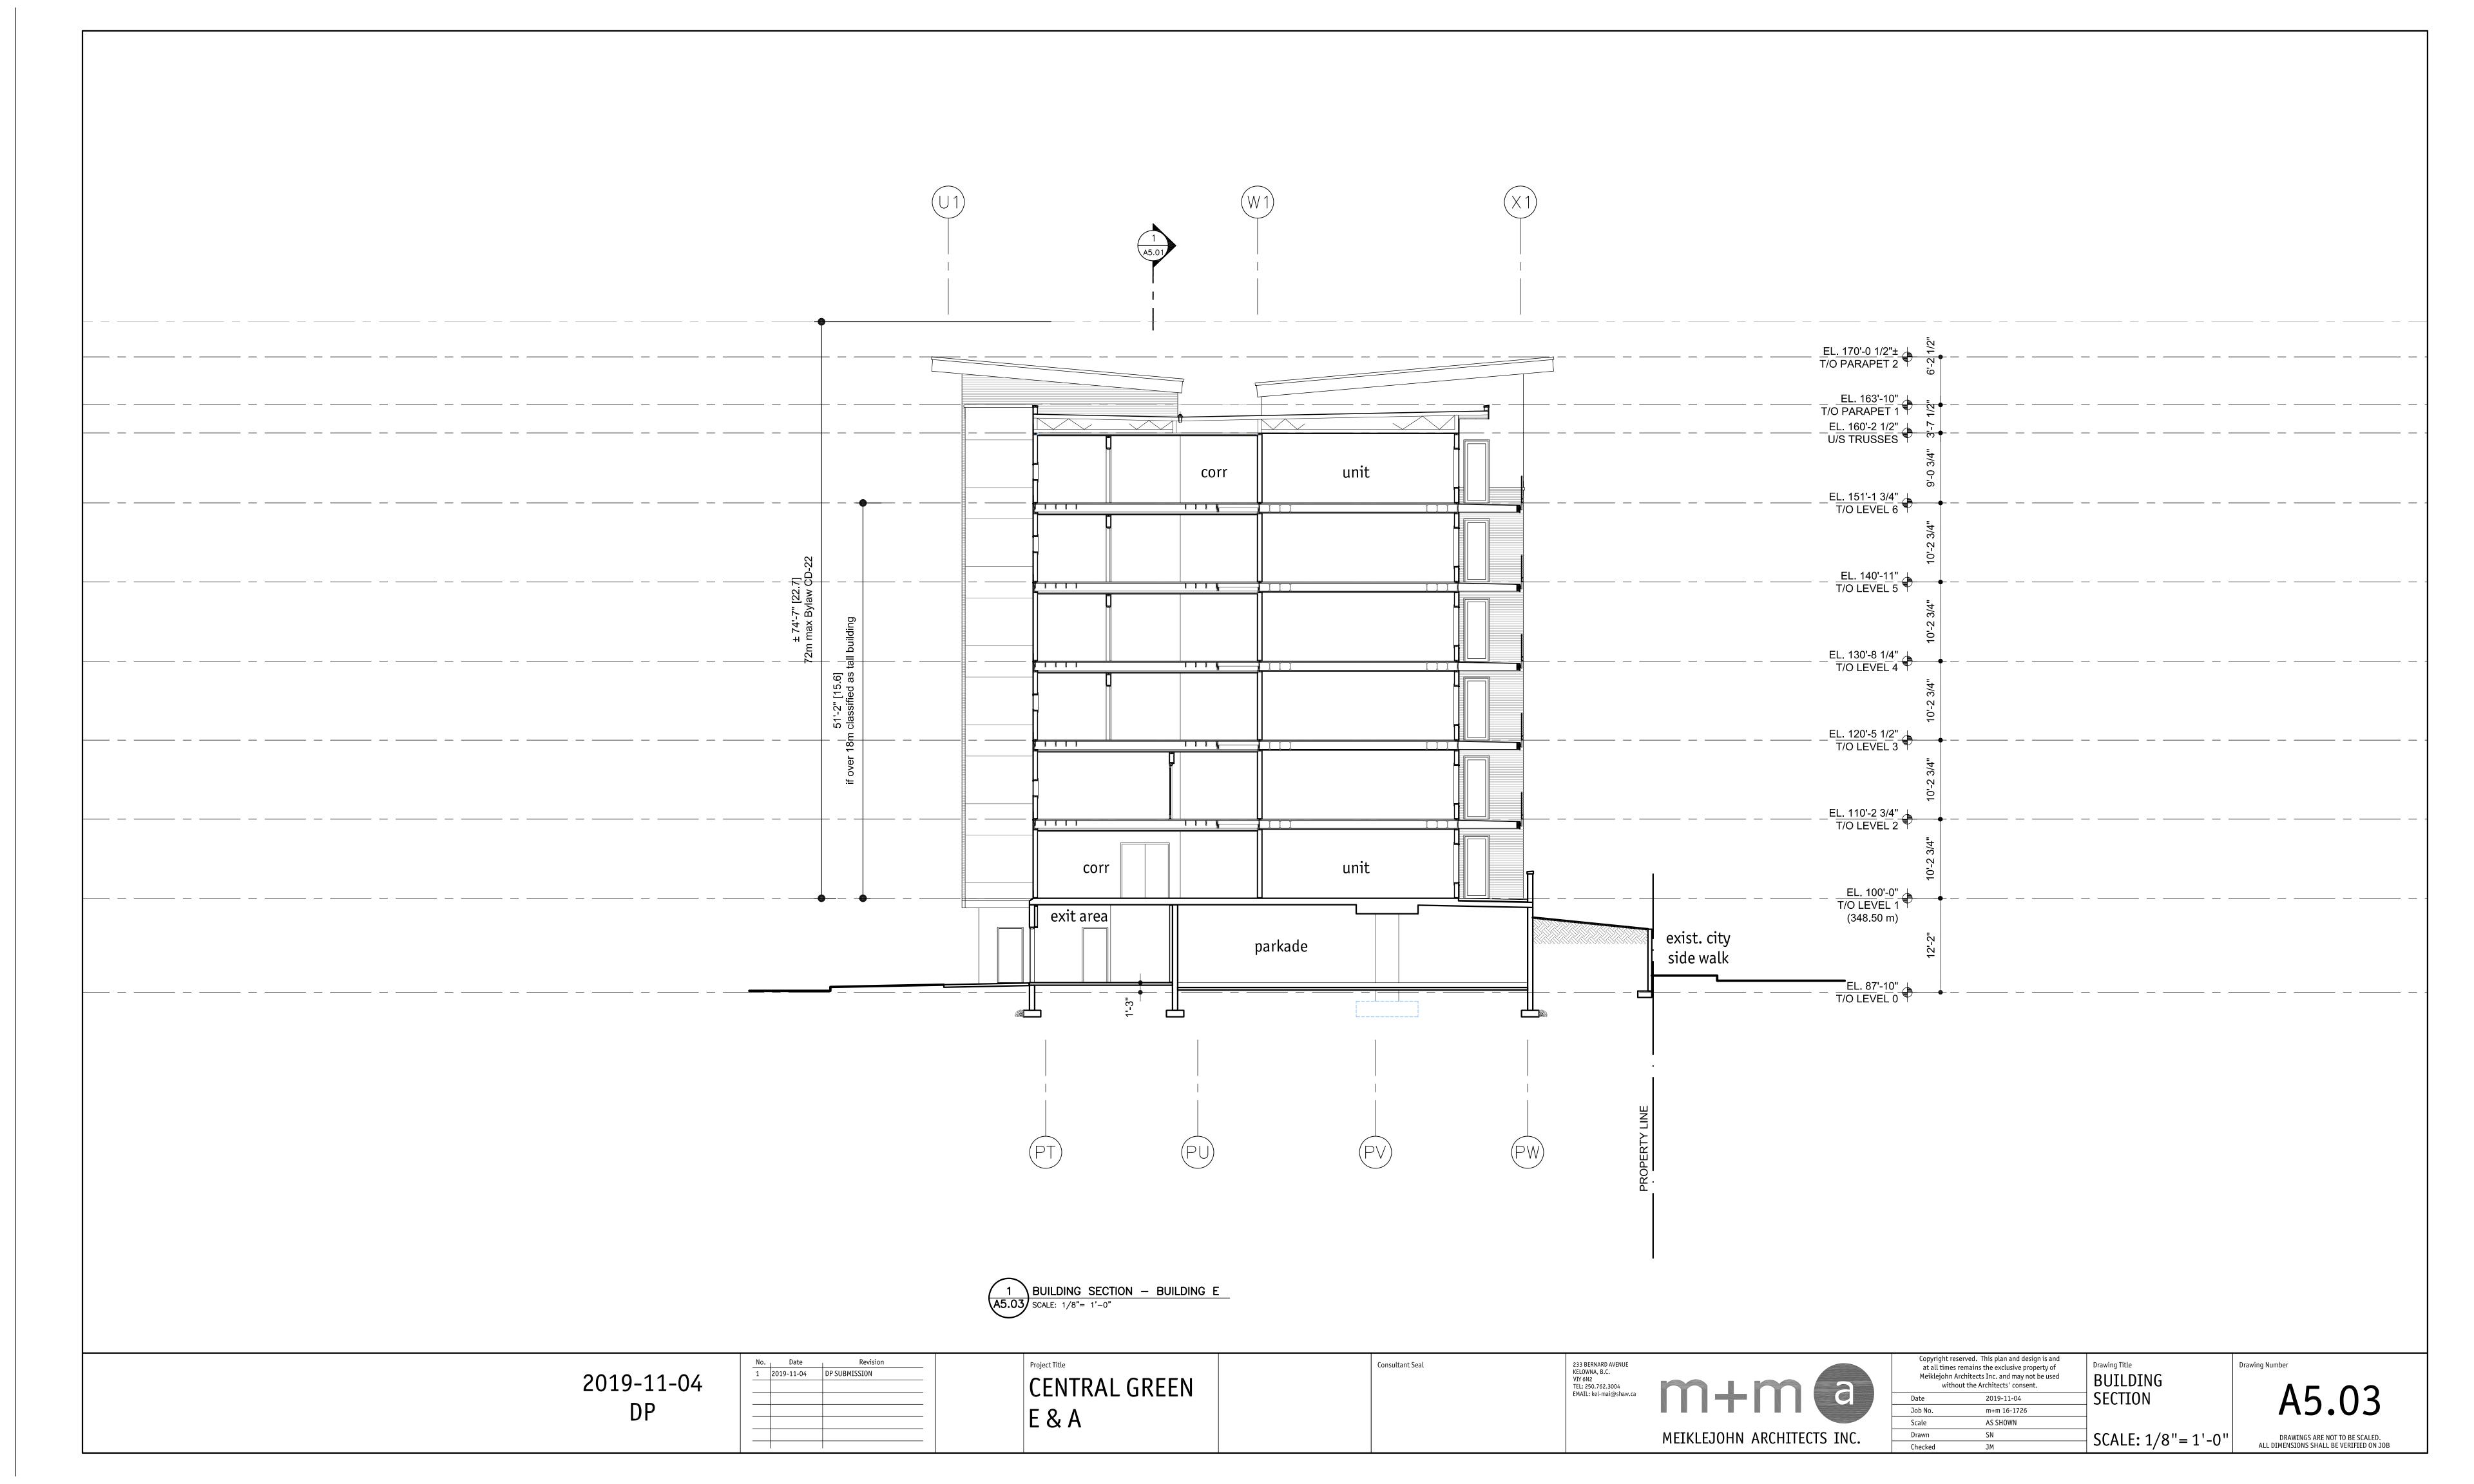

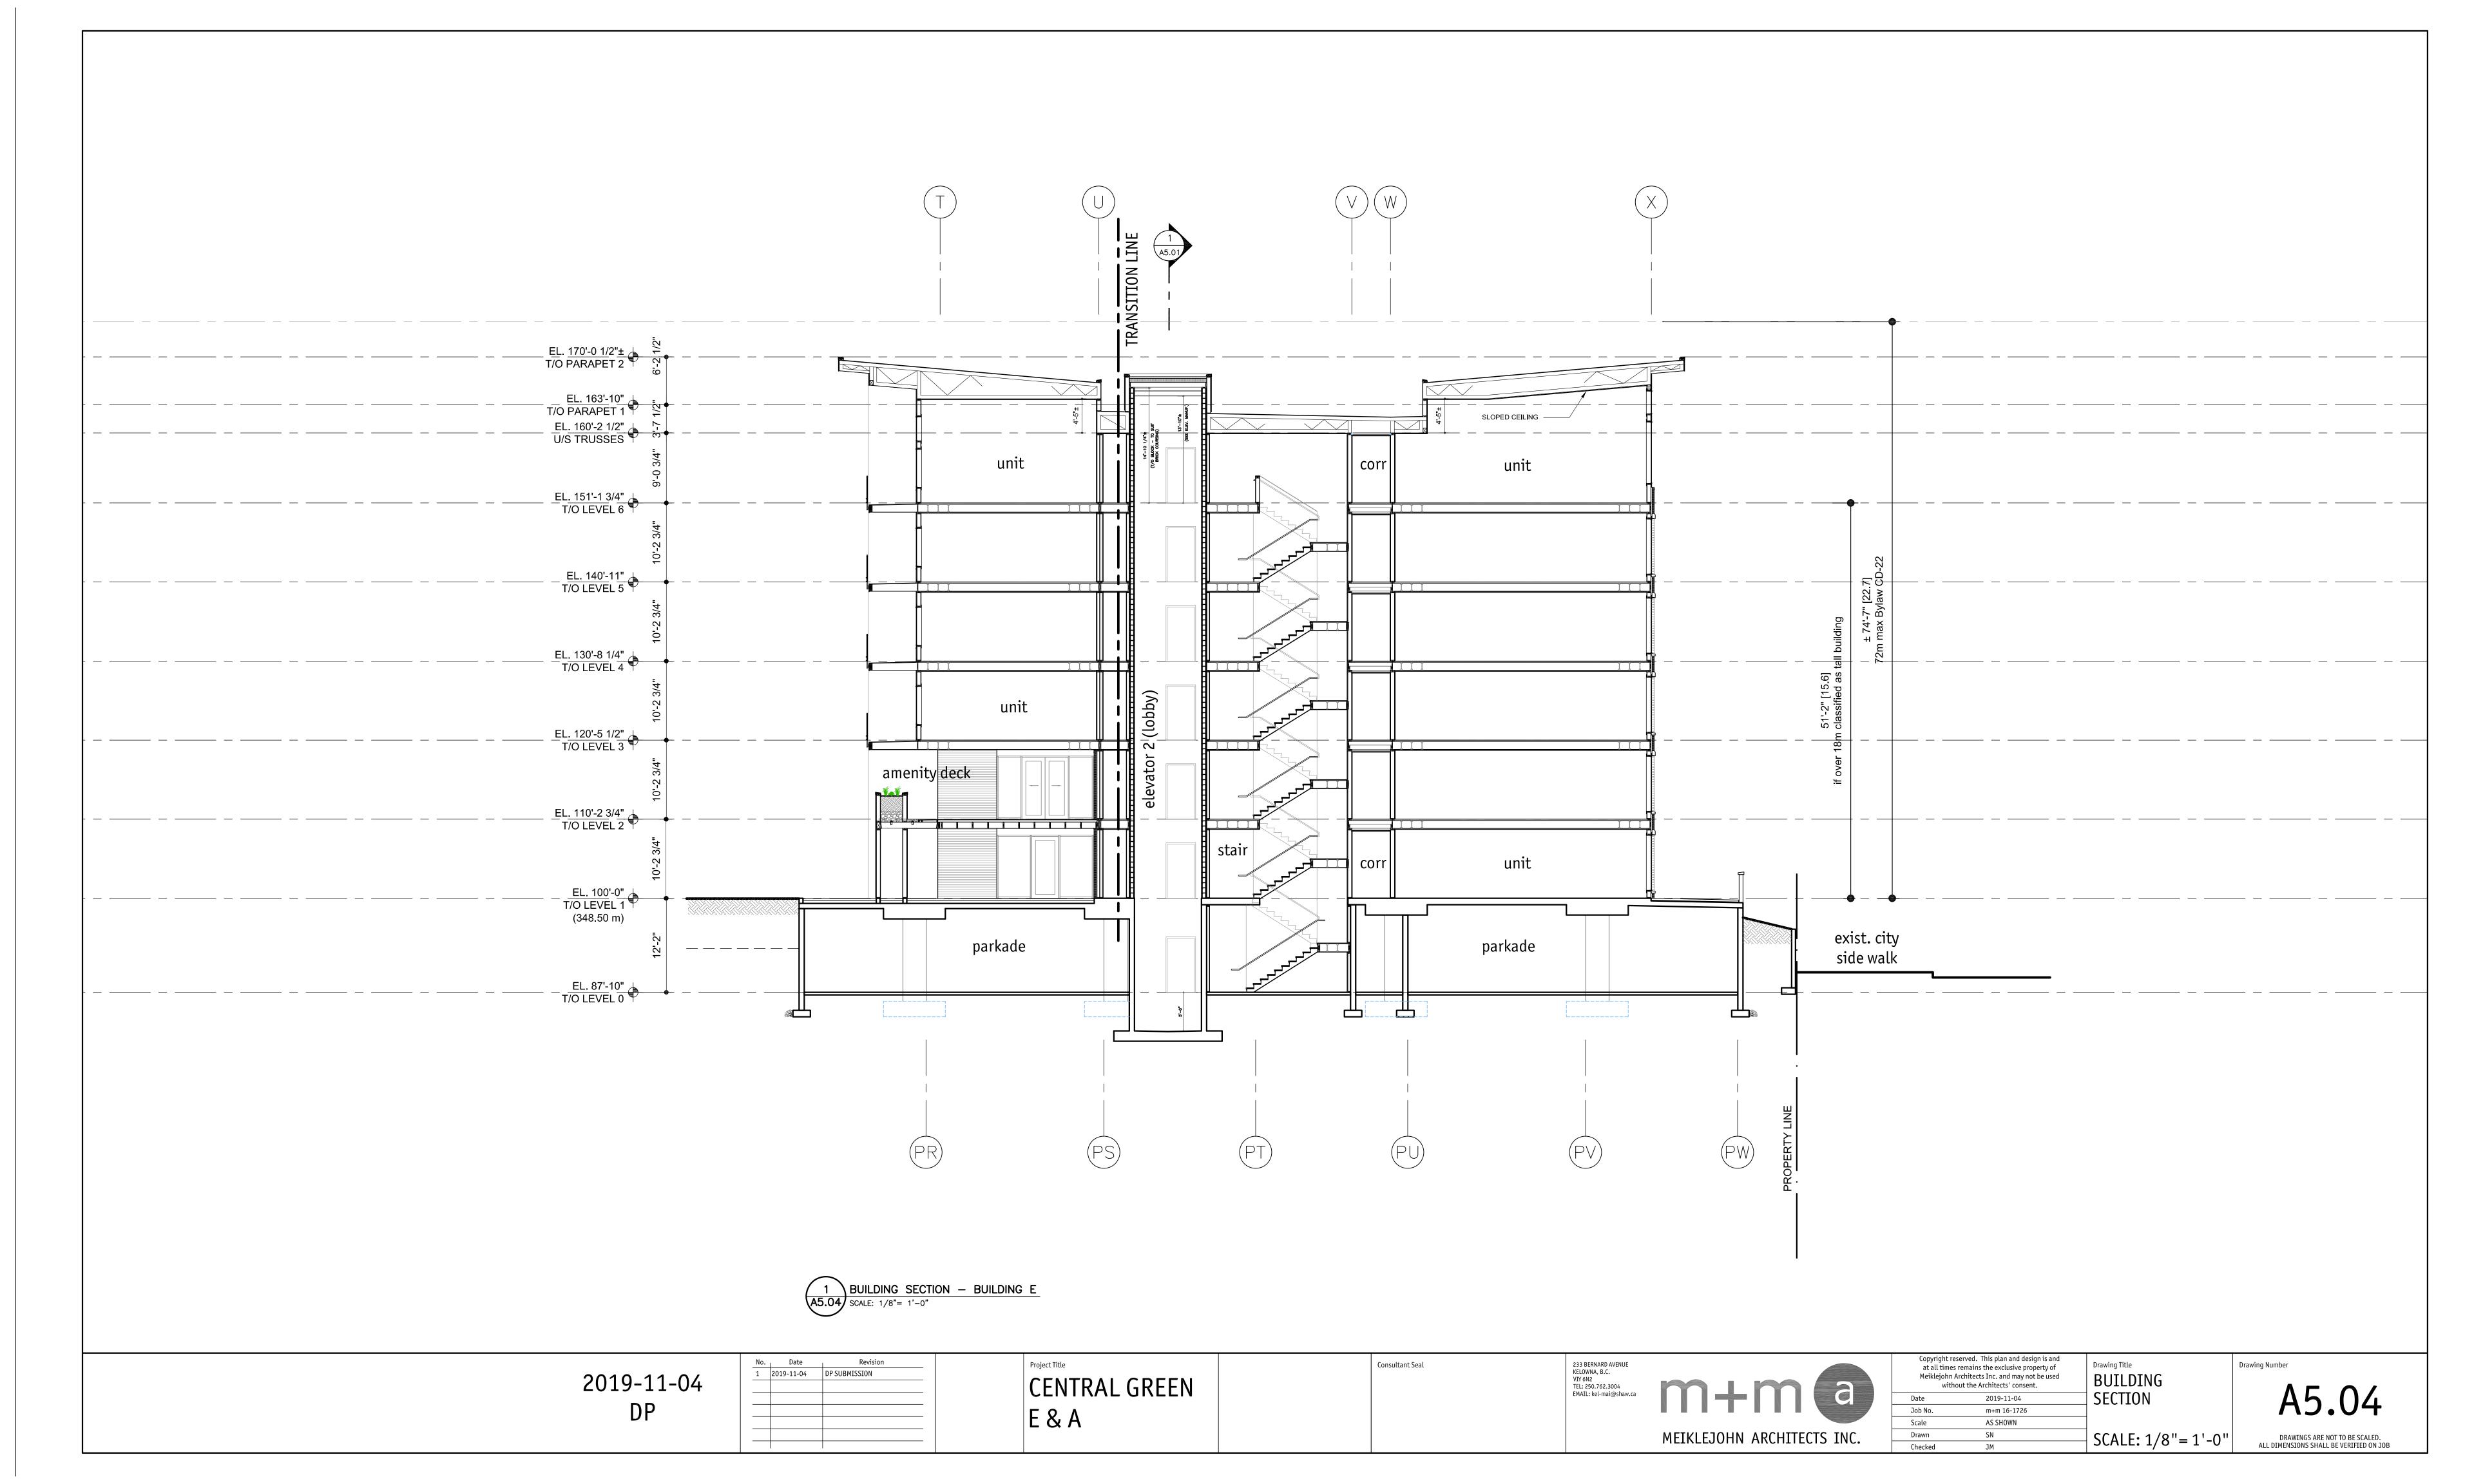

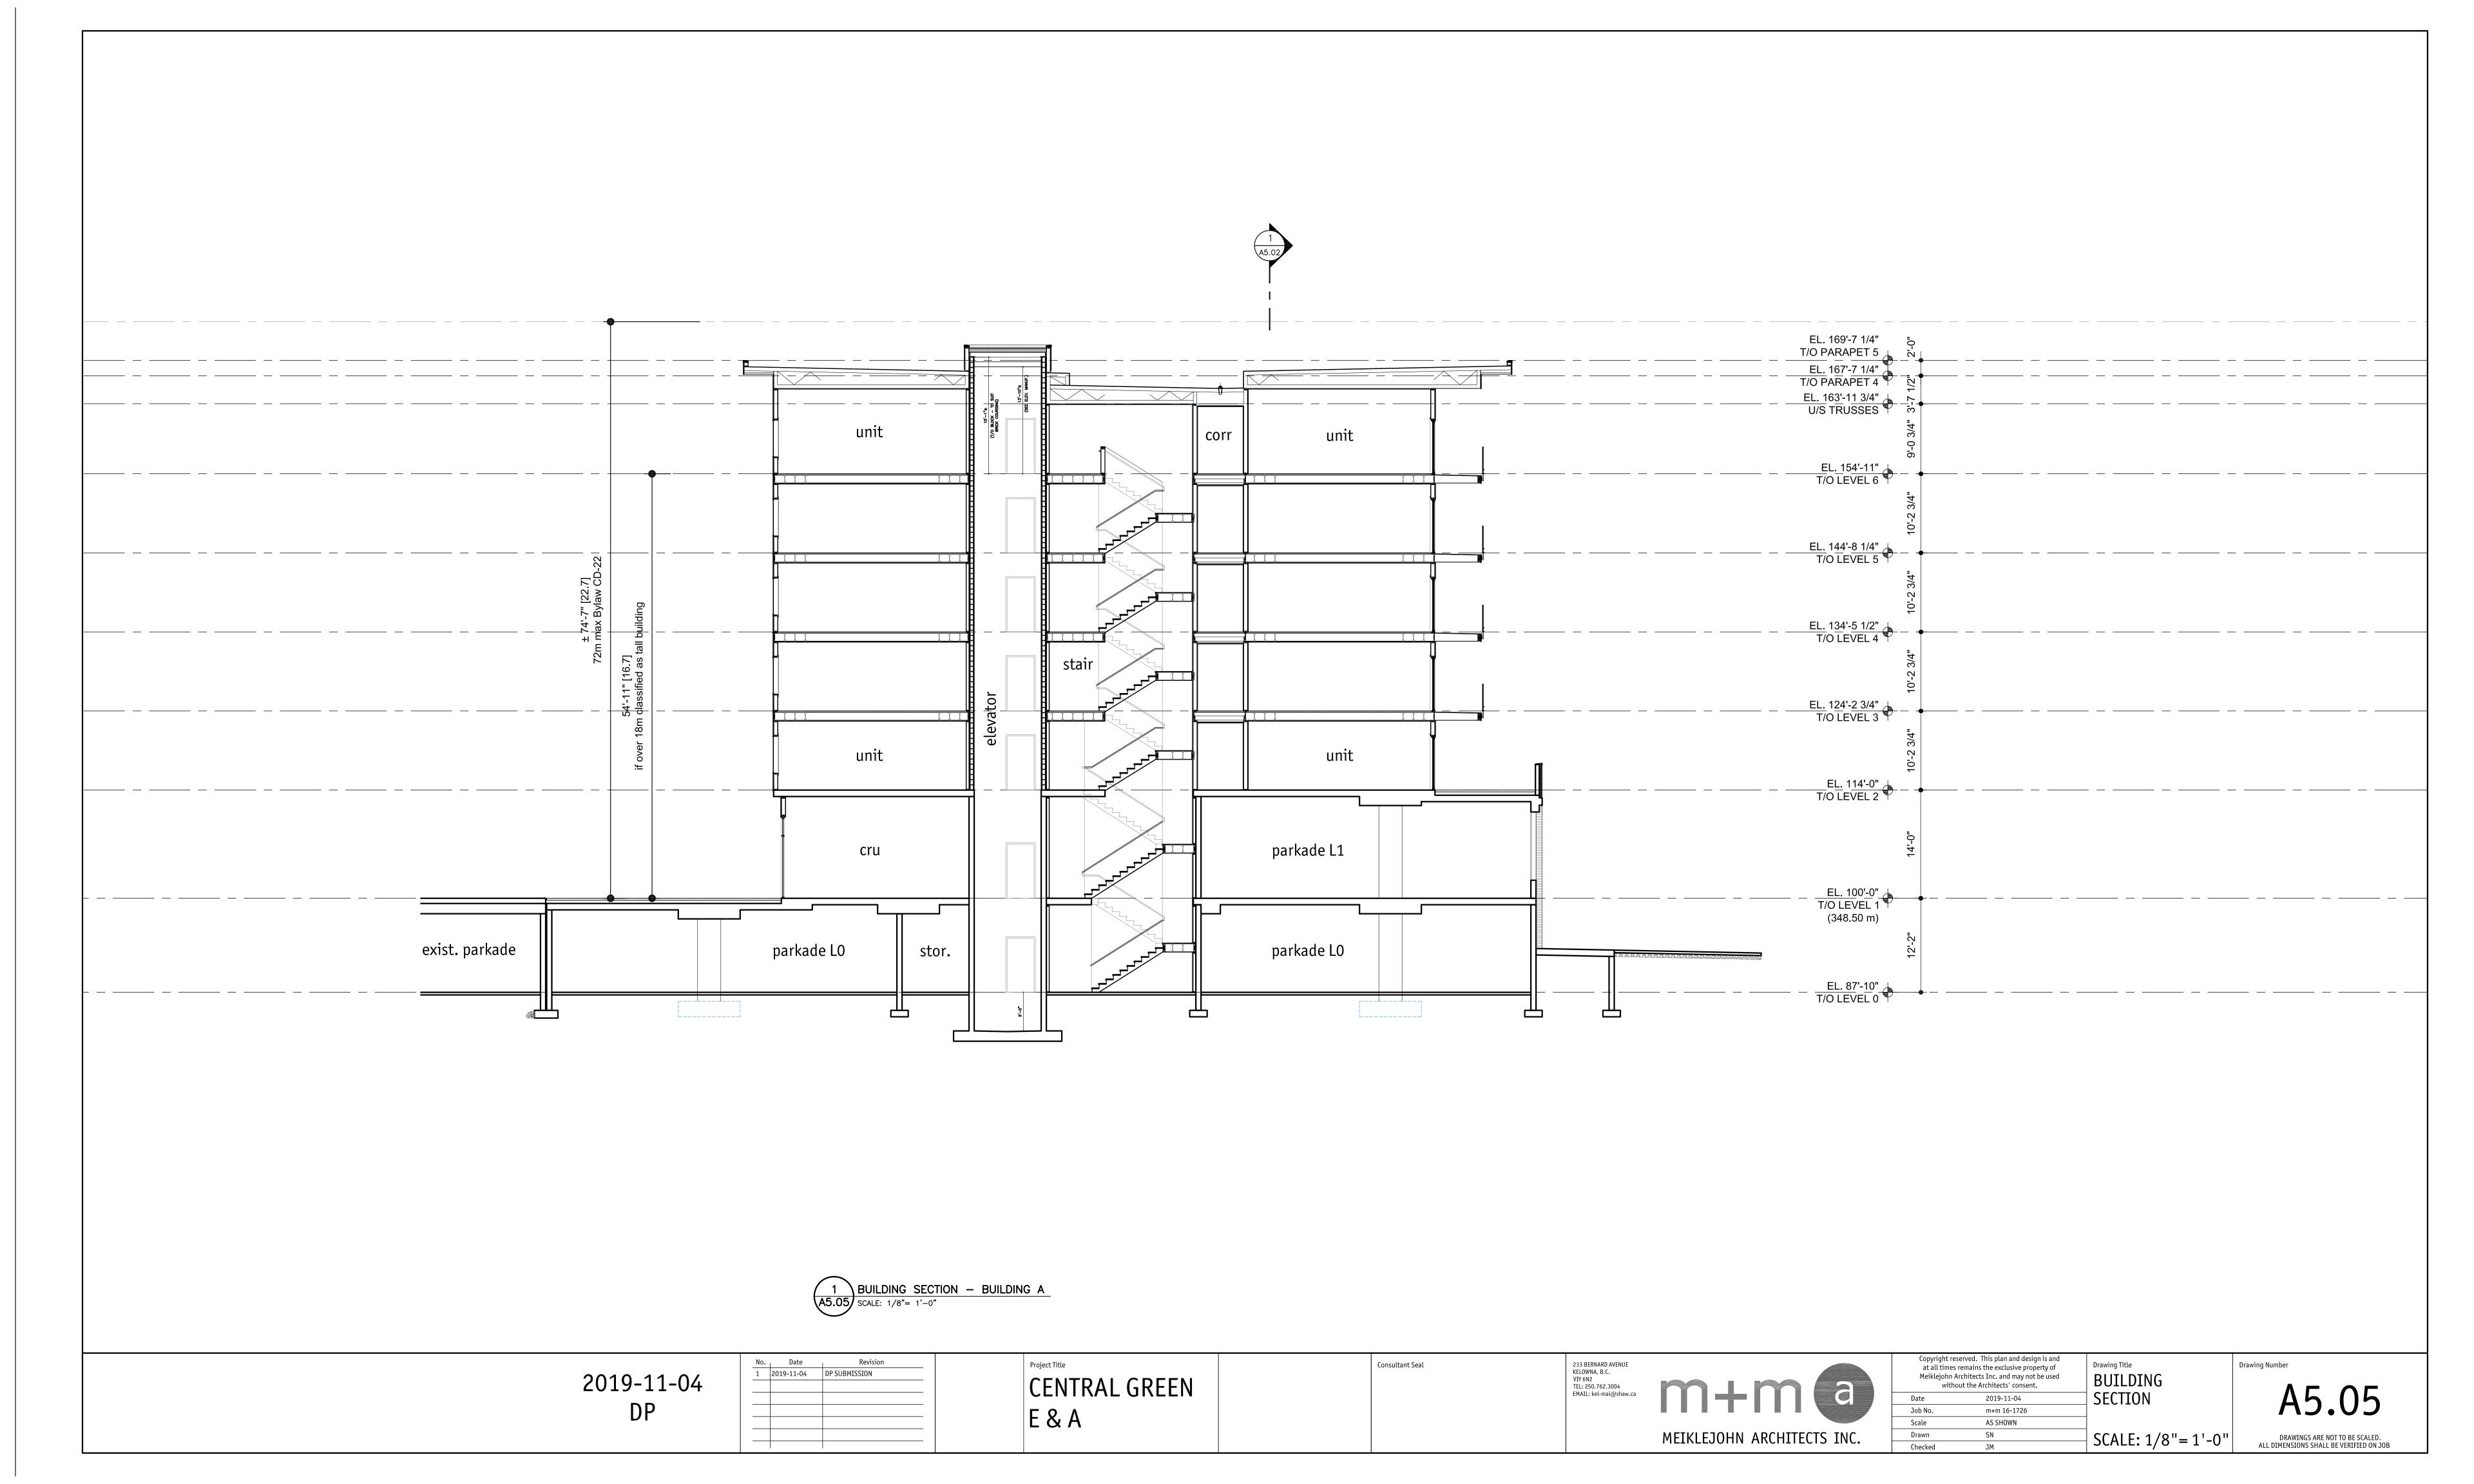

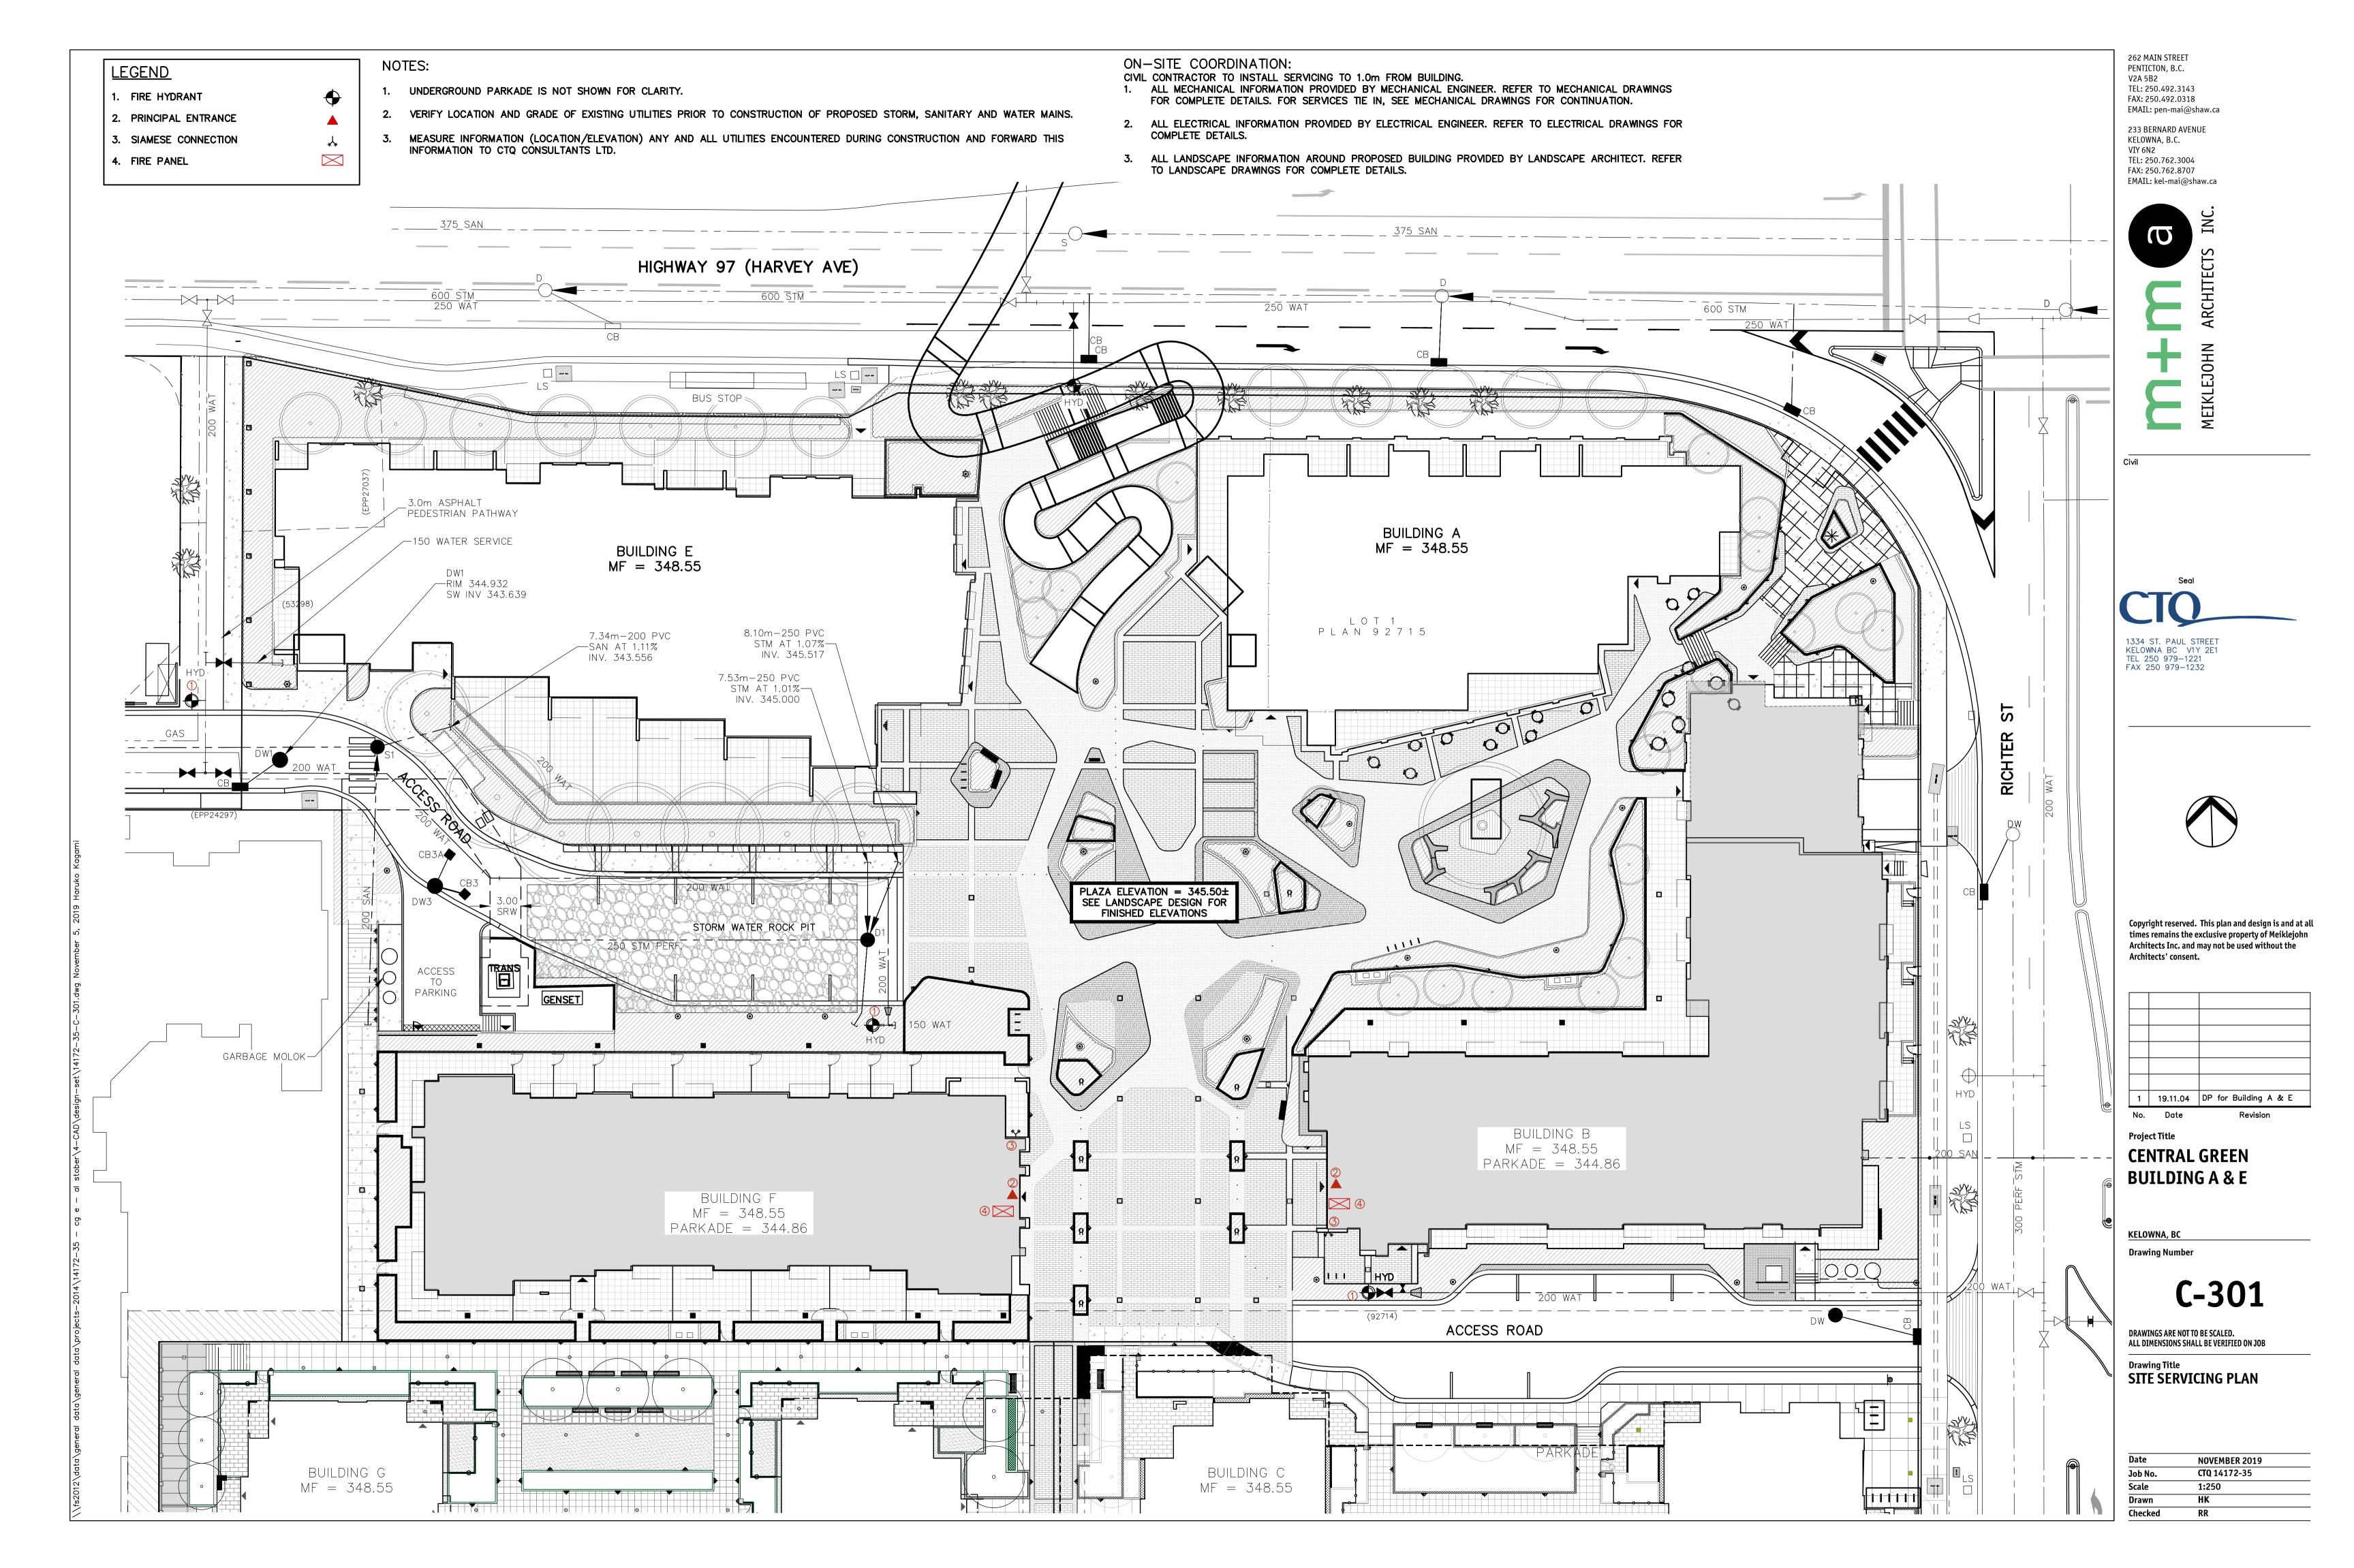



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	CHECKED BY	RF
	PROJECT#	16M-02138
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CONTEXT PLAN SHEET NO.



REV	REVISIONS / ISSUED		
3	NOV 07/19	REISSUED FOR DP	
2	NOV 04/19	REISSUED FOR DP	
1	OCT 22/19	ISSUED FOR DP	
NO.	DATE	DESCRIPTION	

CENTRAL GREEN - BUILDING E, A AND PLAZA

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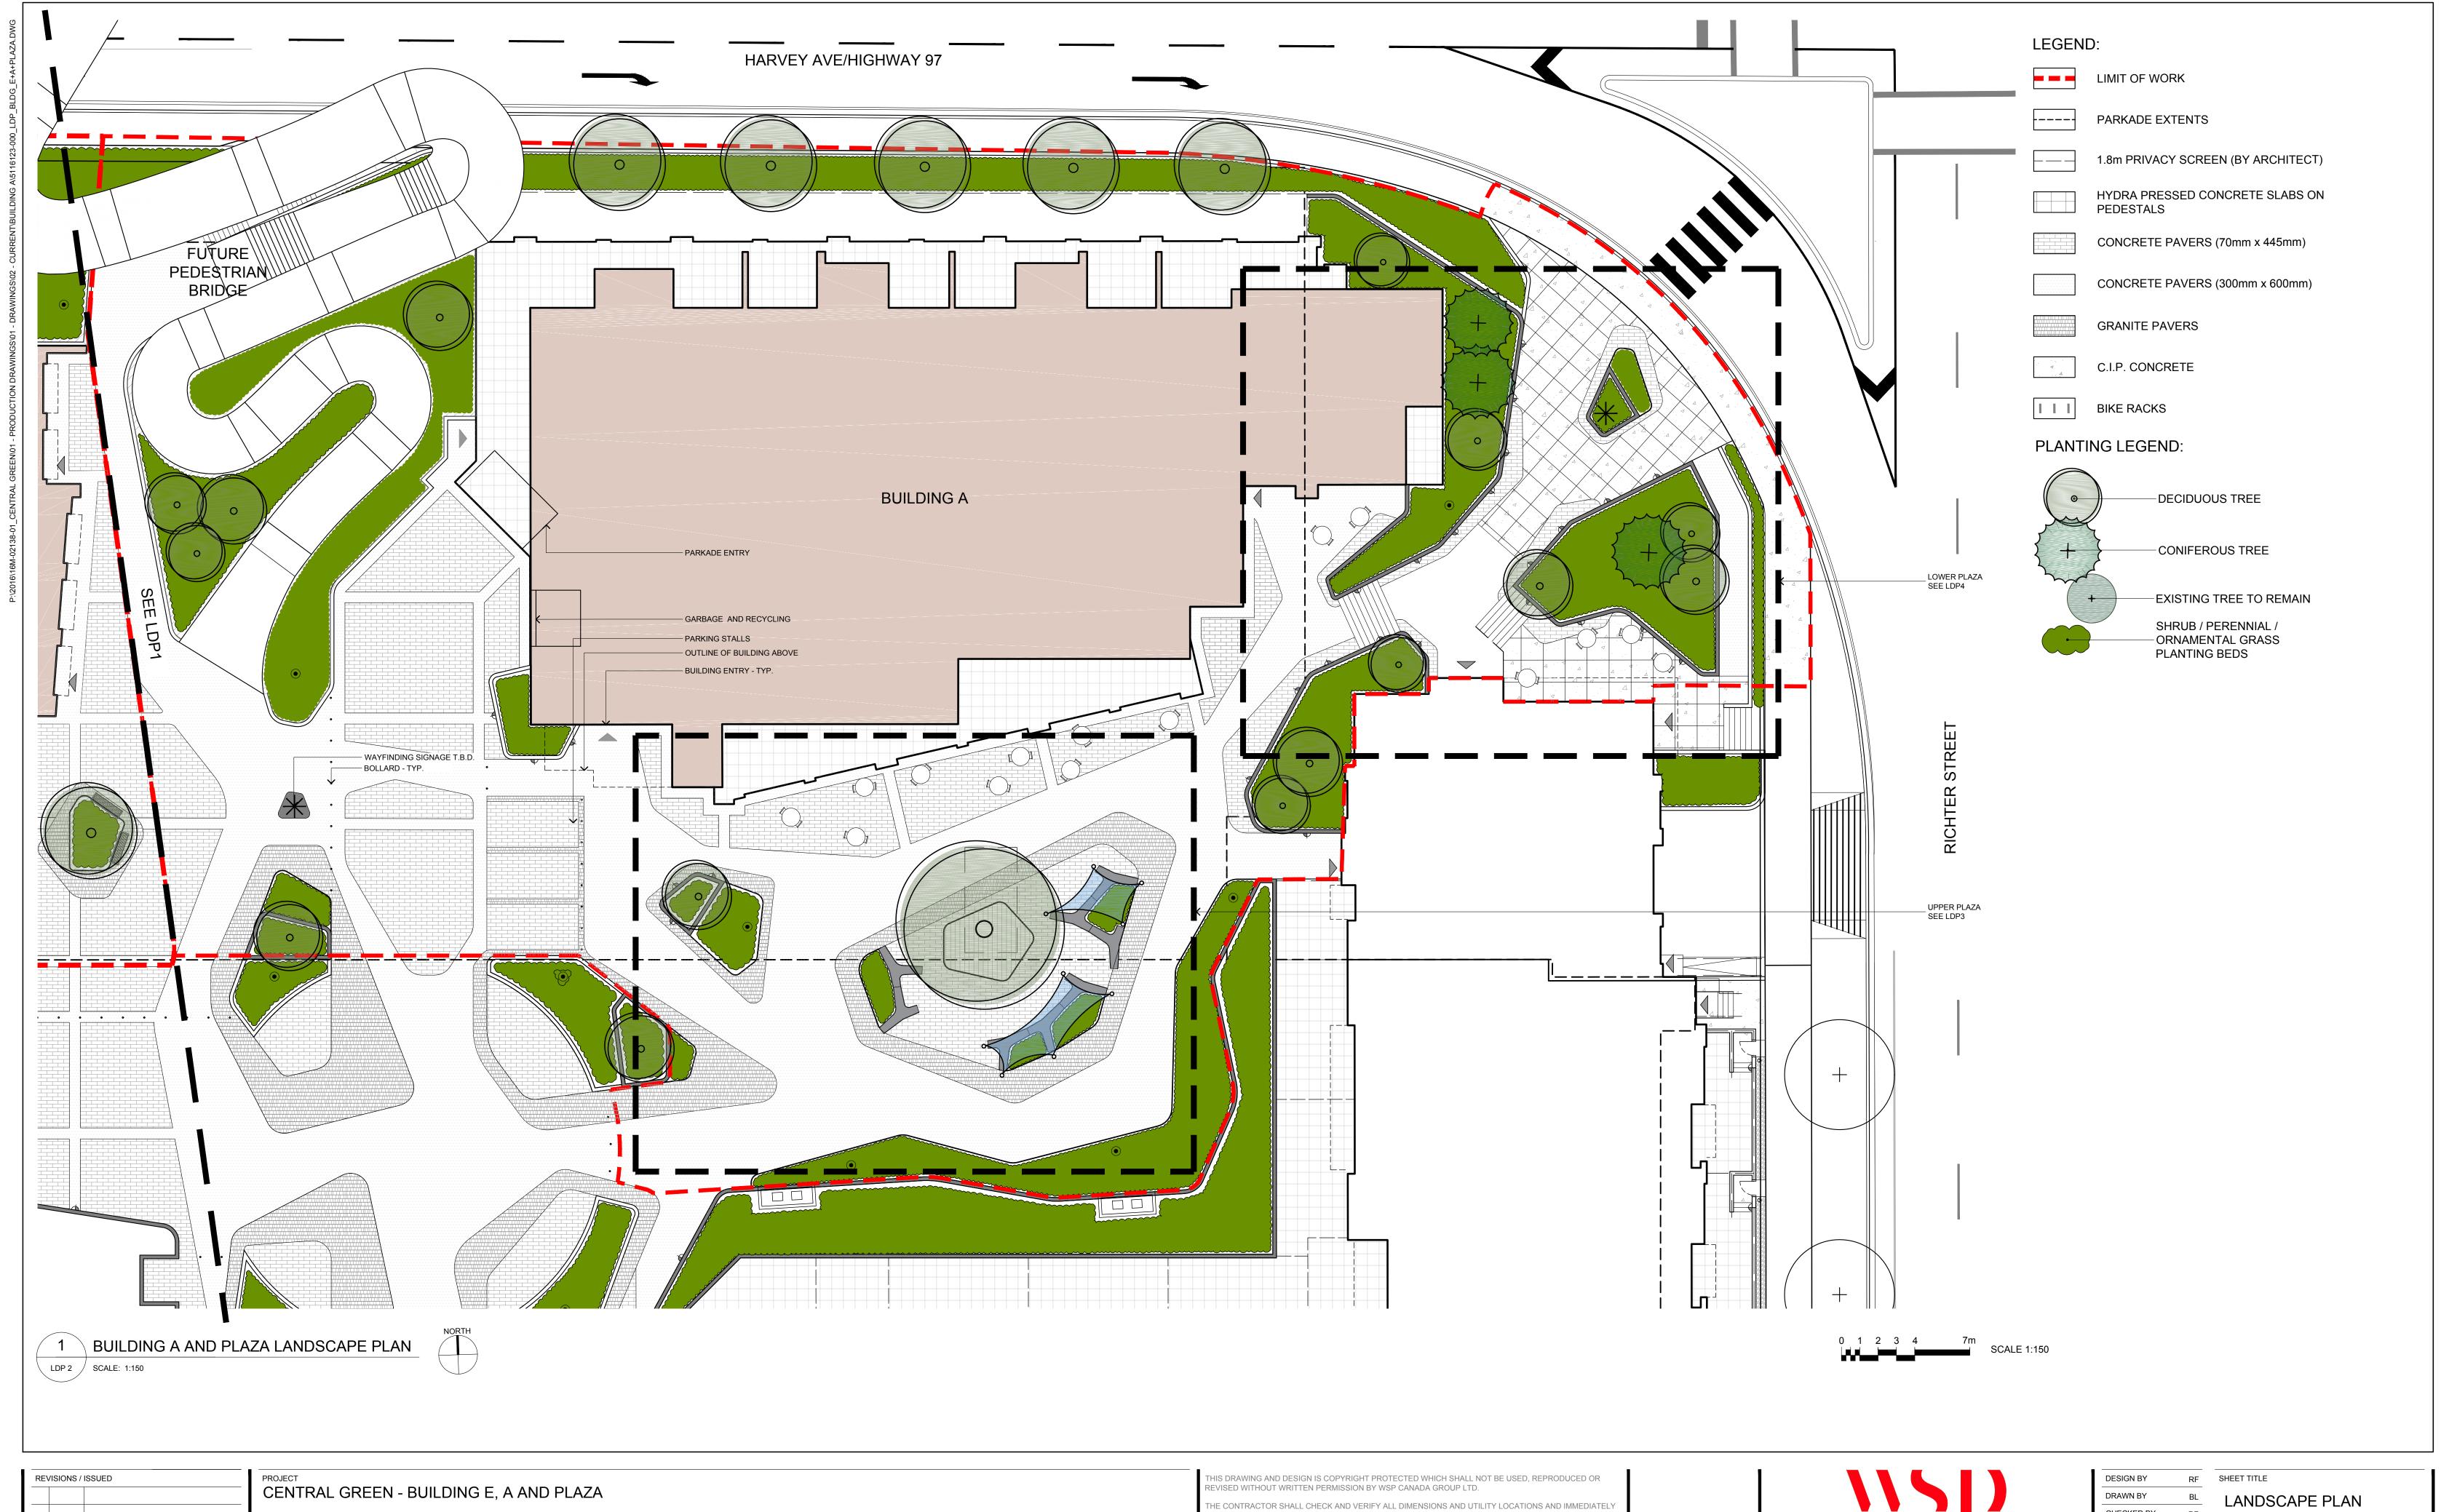
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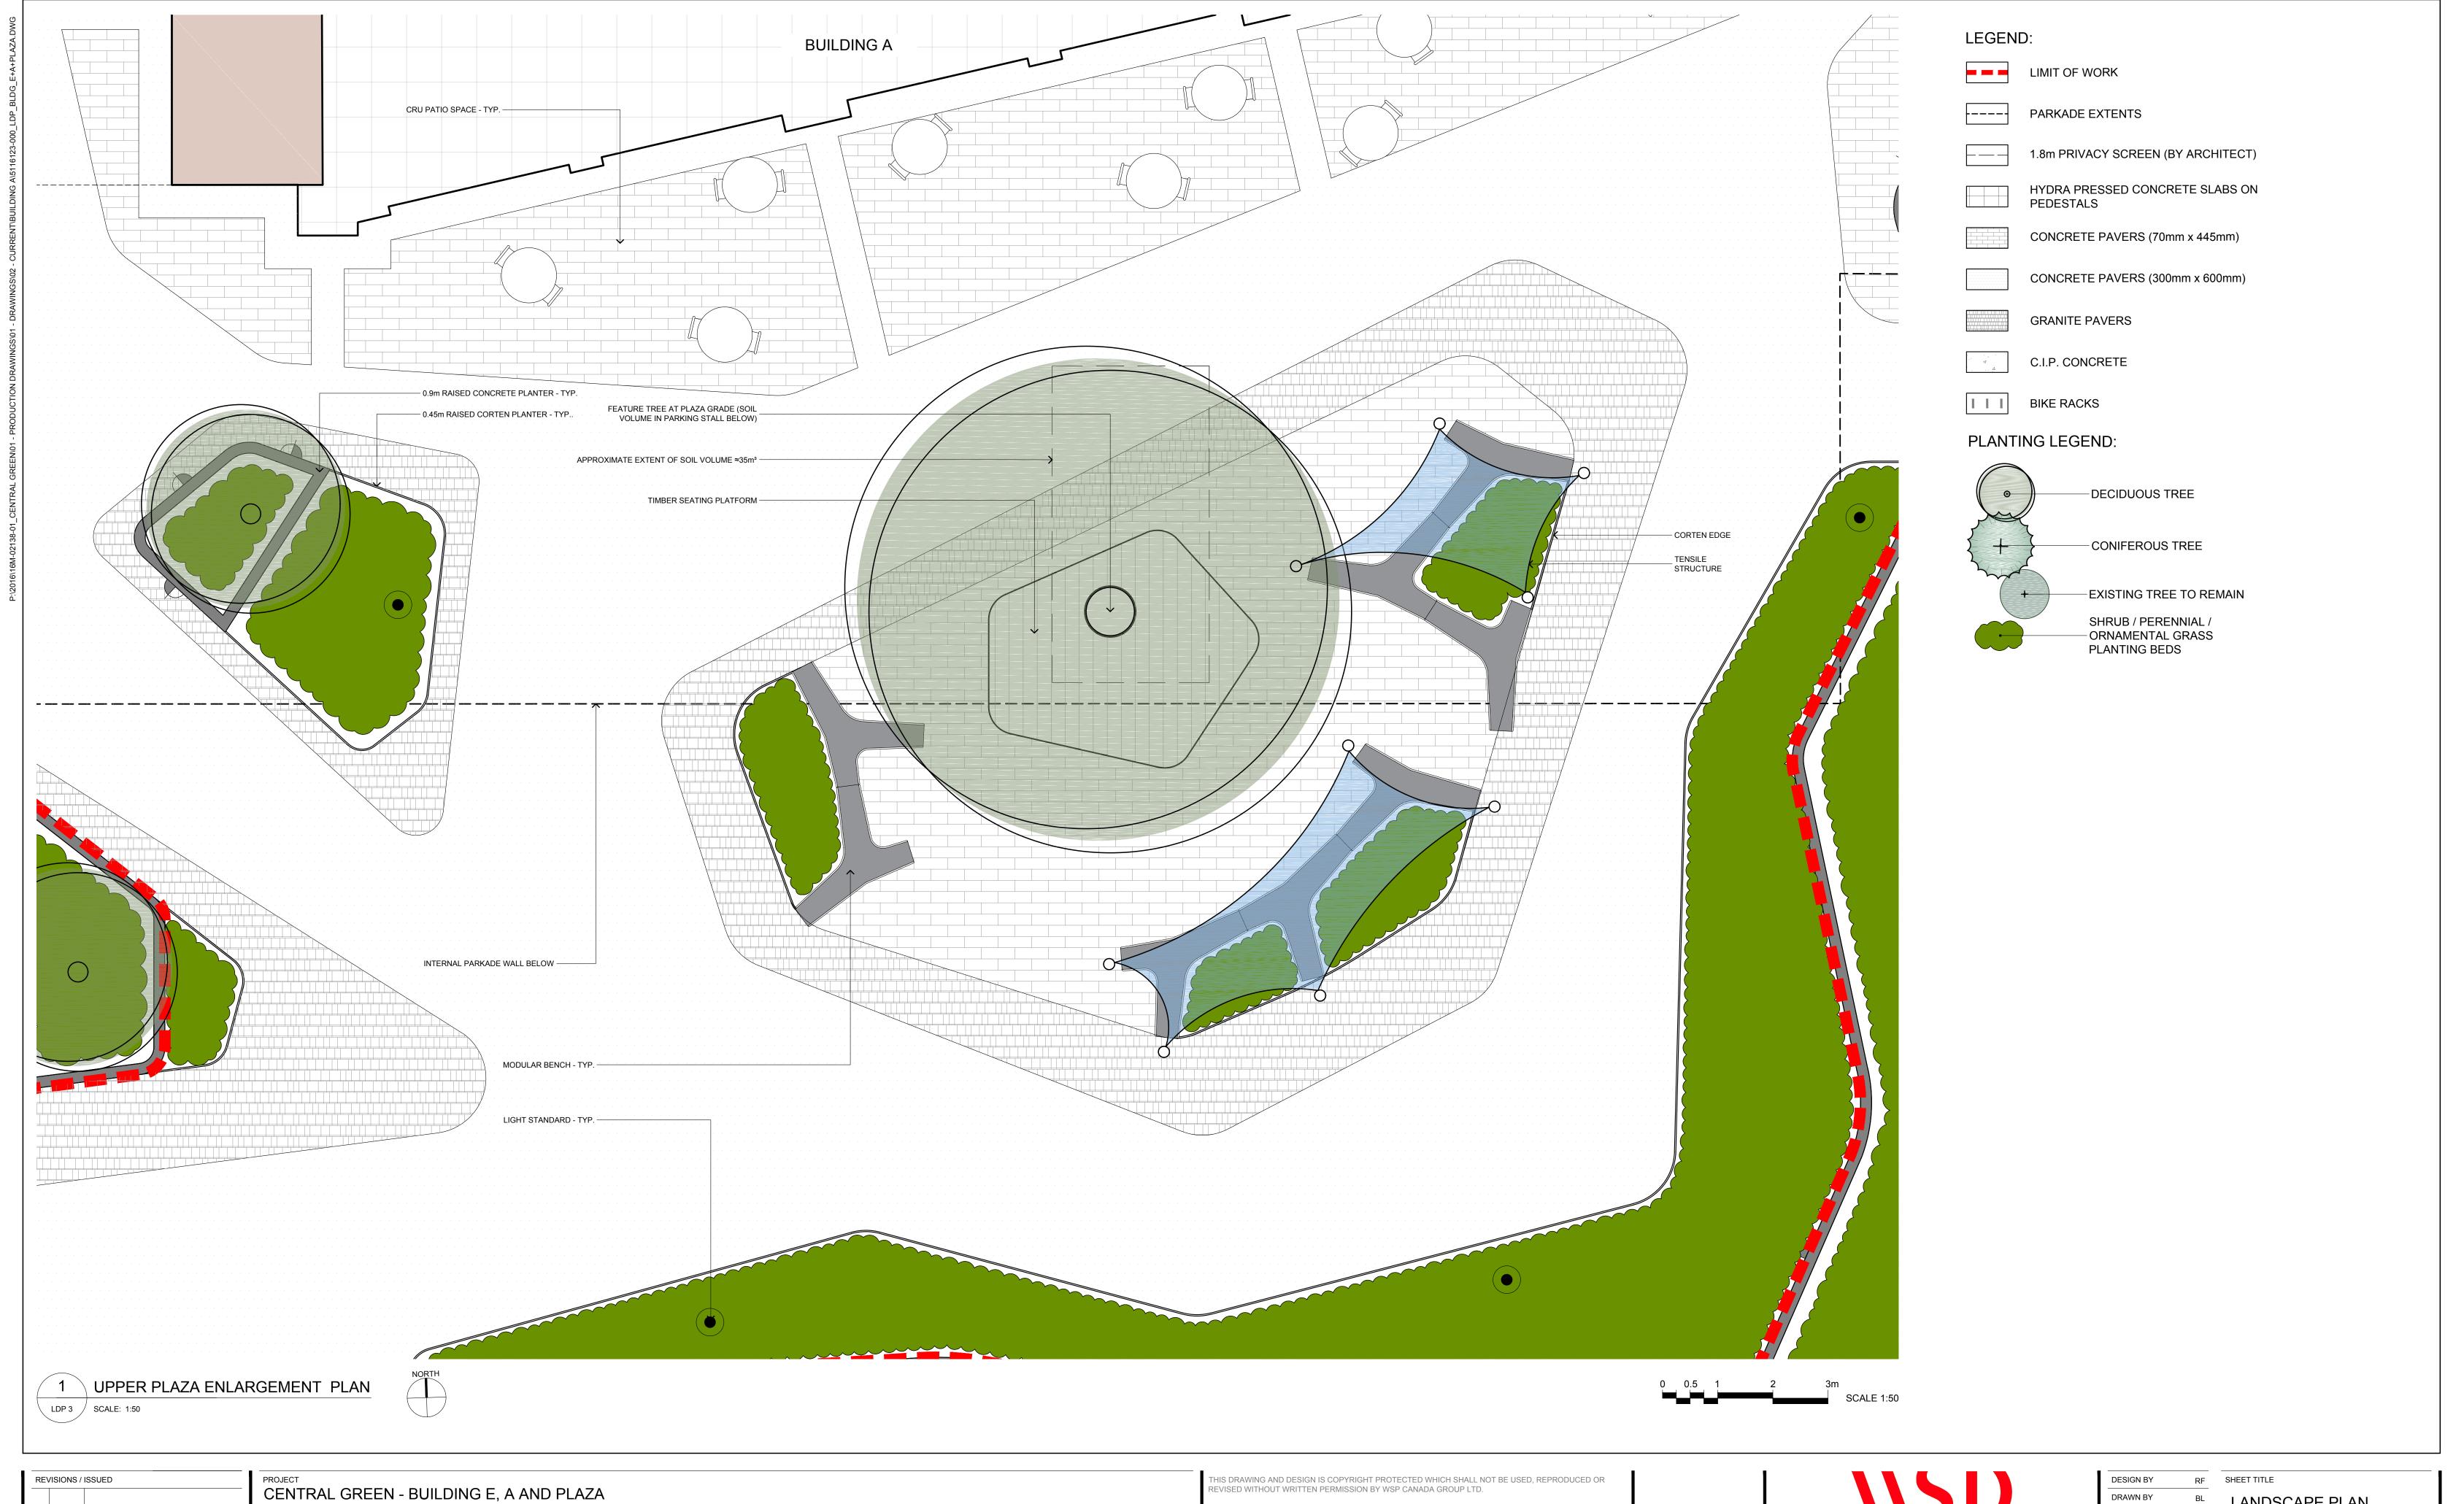
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LDP 2



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2	OCT 16/19	ISSUED FOR DP	AL STOBER CO
1	SEPT 12/19	ISSUED FOR DP	CONSULTANT
NO	DATE	DESCRIPTION	

CENTRAL GREEN - BUILDING E, A AND PLAZA

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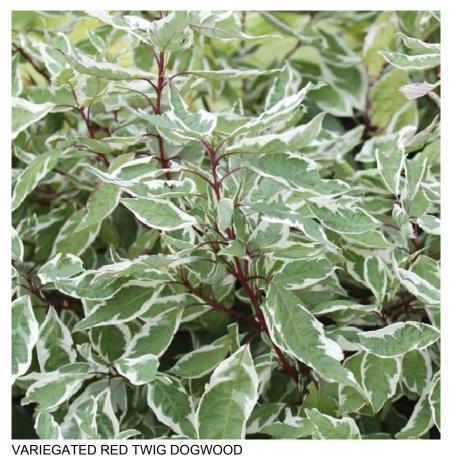
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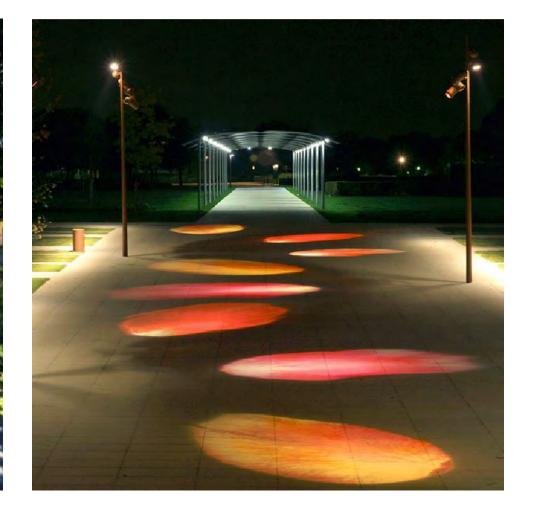


PLANTING












LIGHTING - POLE AND WALL MOUNT

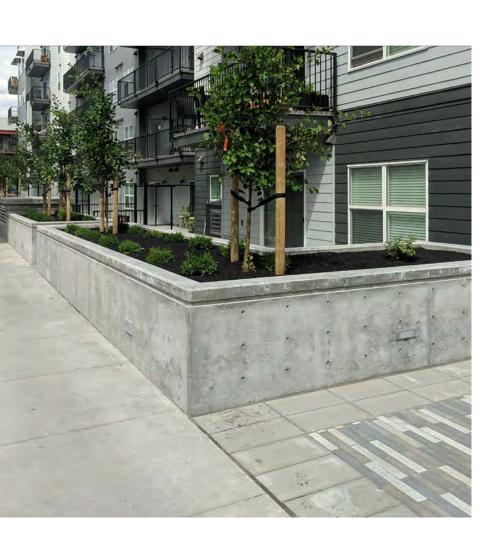



FEATURE LIGHTING - PROJECTION AND UPLIGHTING

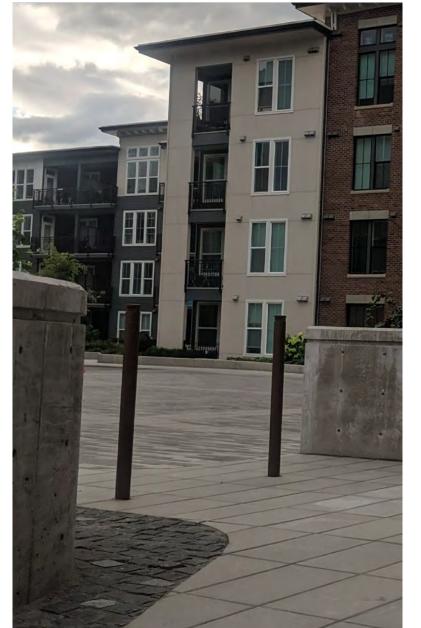



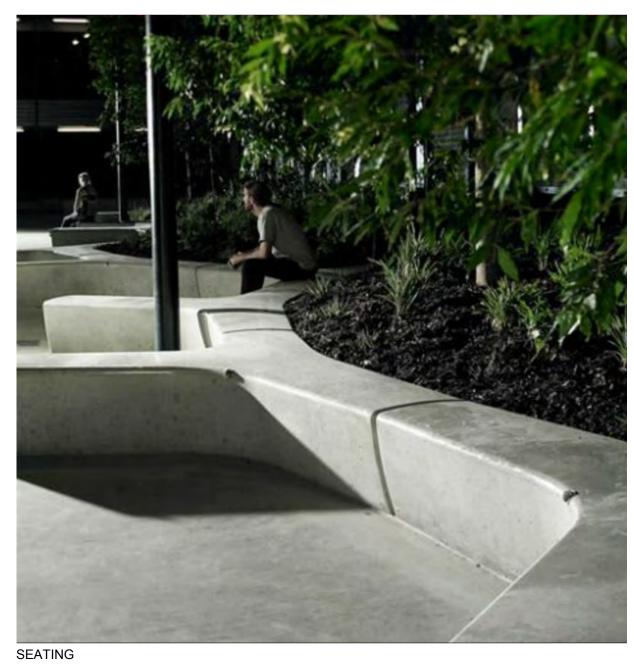

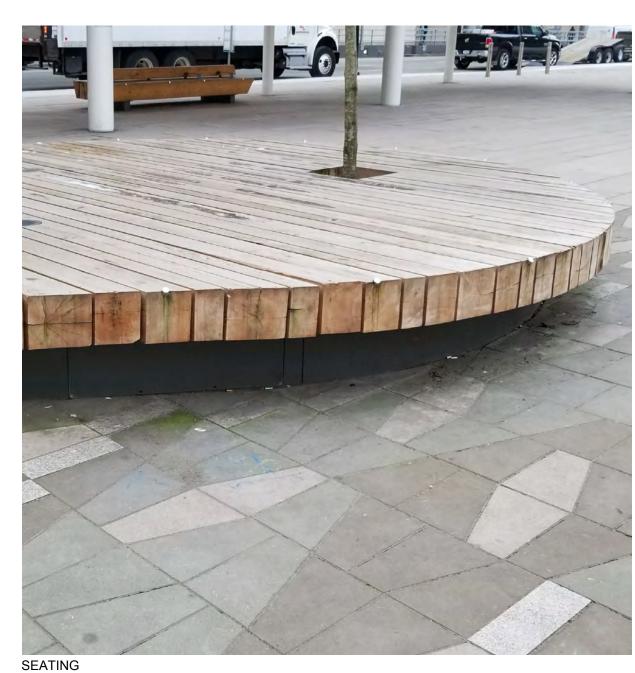

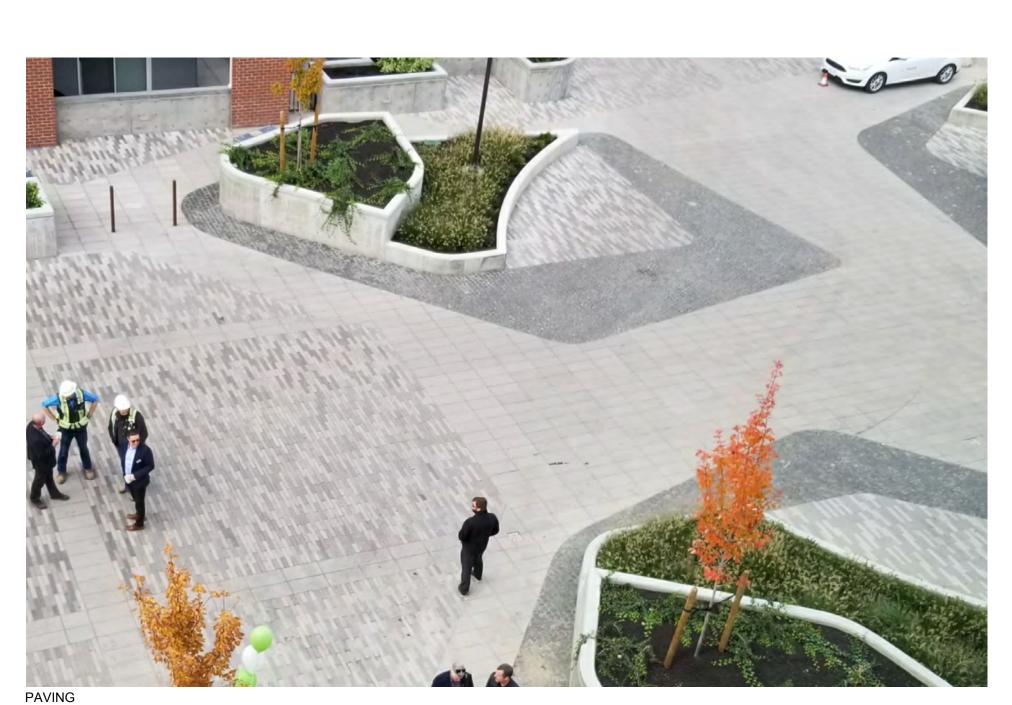

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CENTRAL GREEN - BUILDING E, A AND PLAZA

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CHARACTER IMAGES

SHEET NO.

LDP 5



RENDERING 1

RENDERING 3 RENDERING 4 RENDERING 5

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RENDERING 2

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PROJECT # 16M-02138

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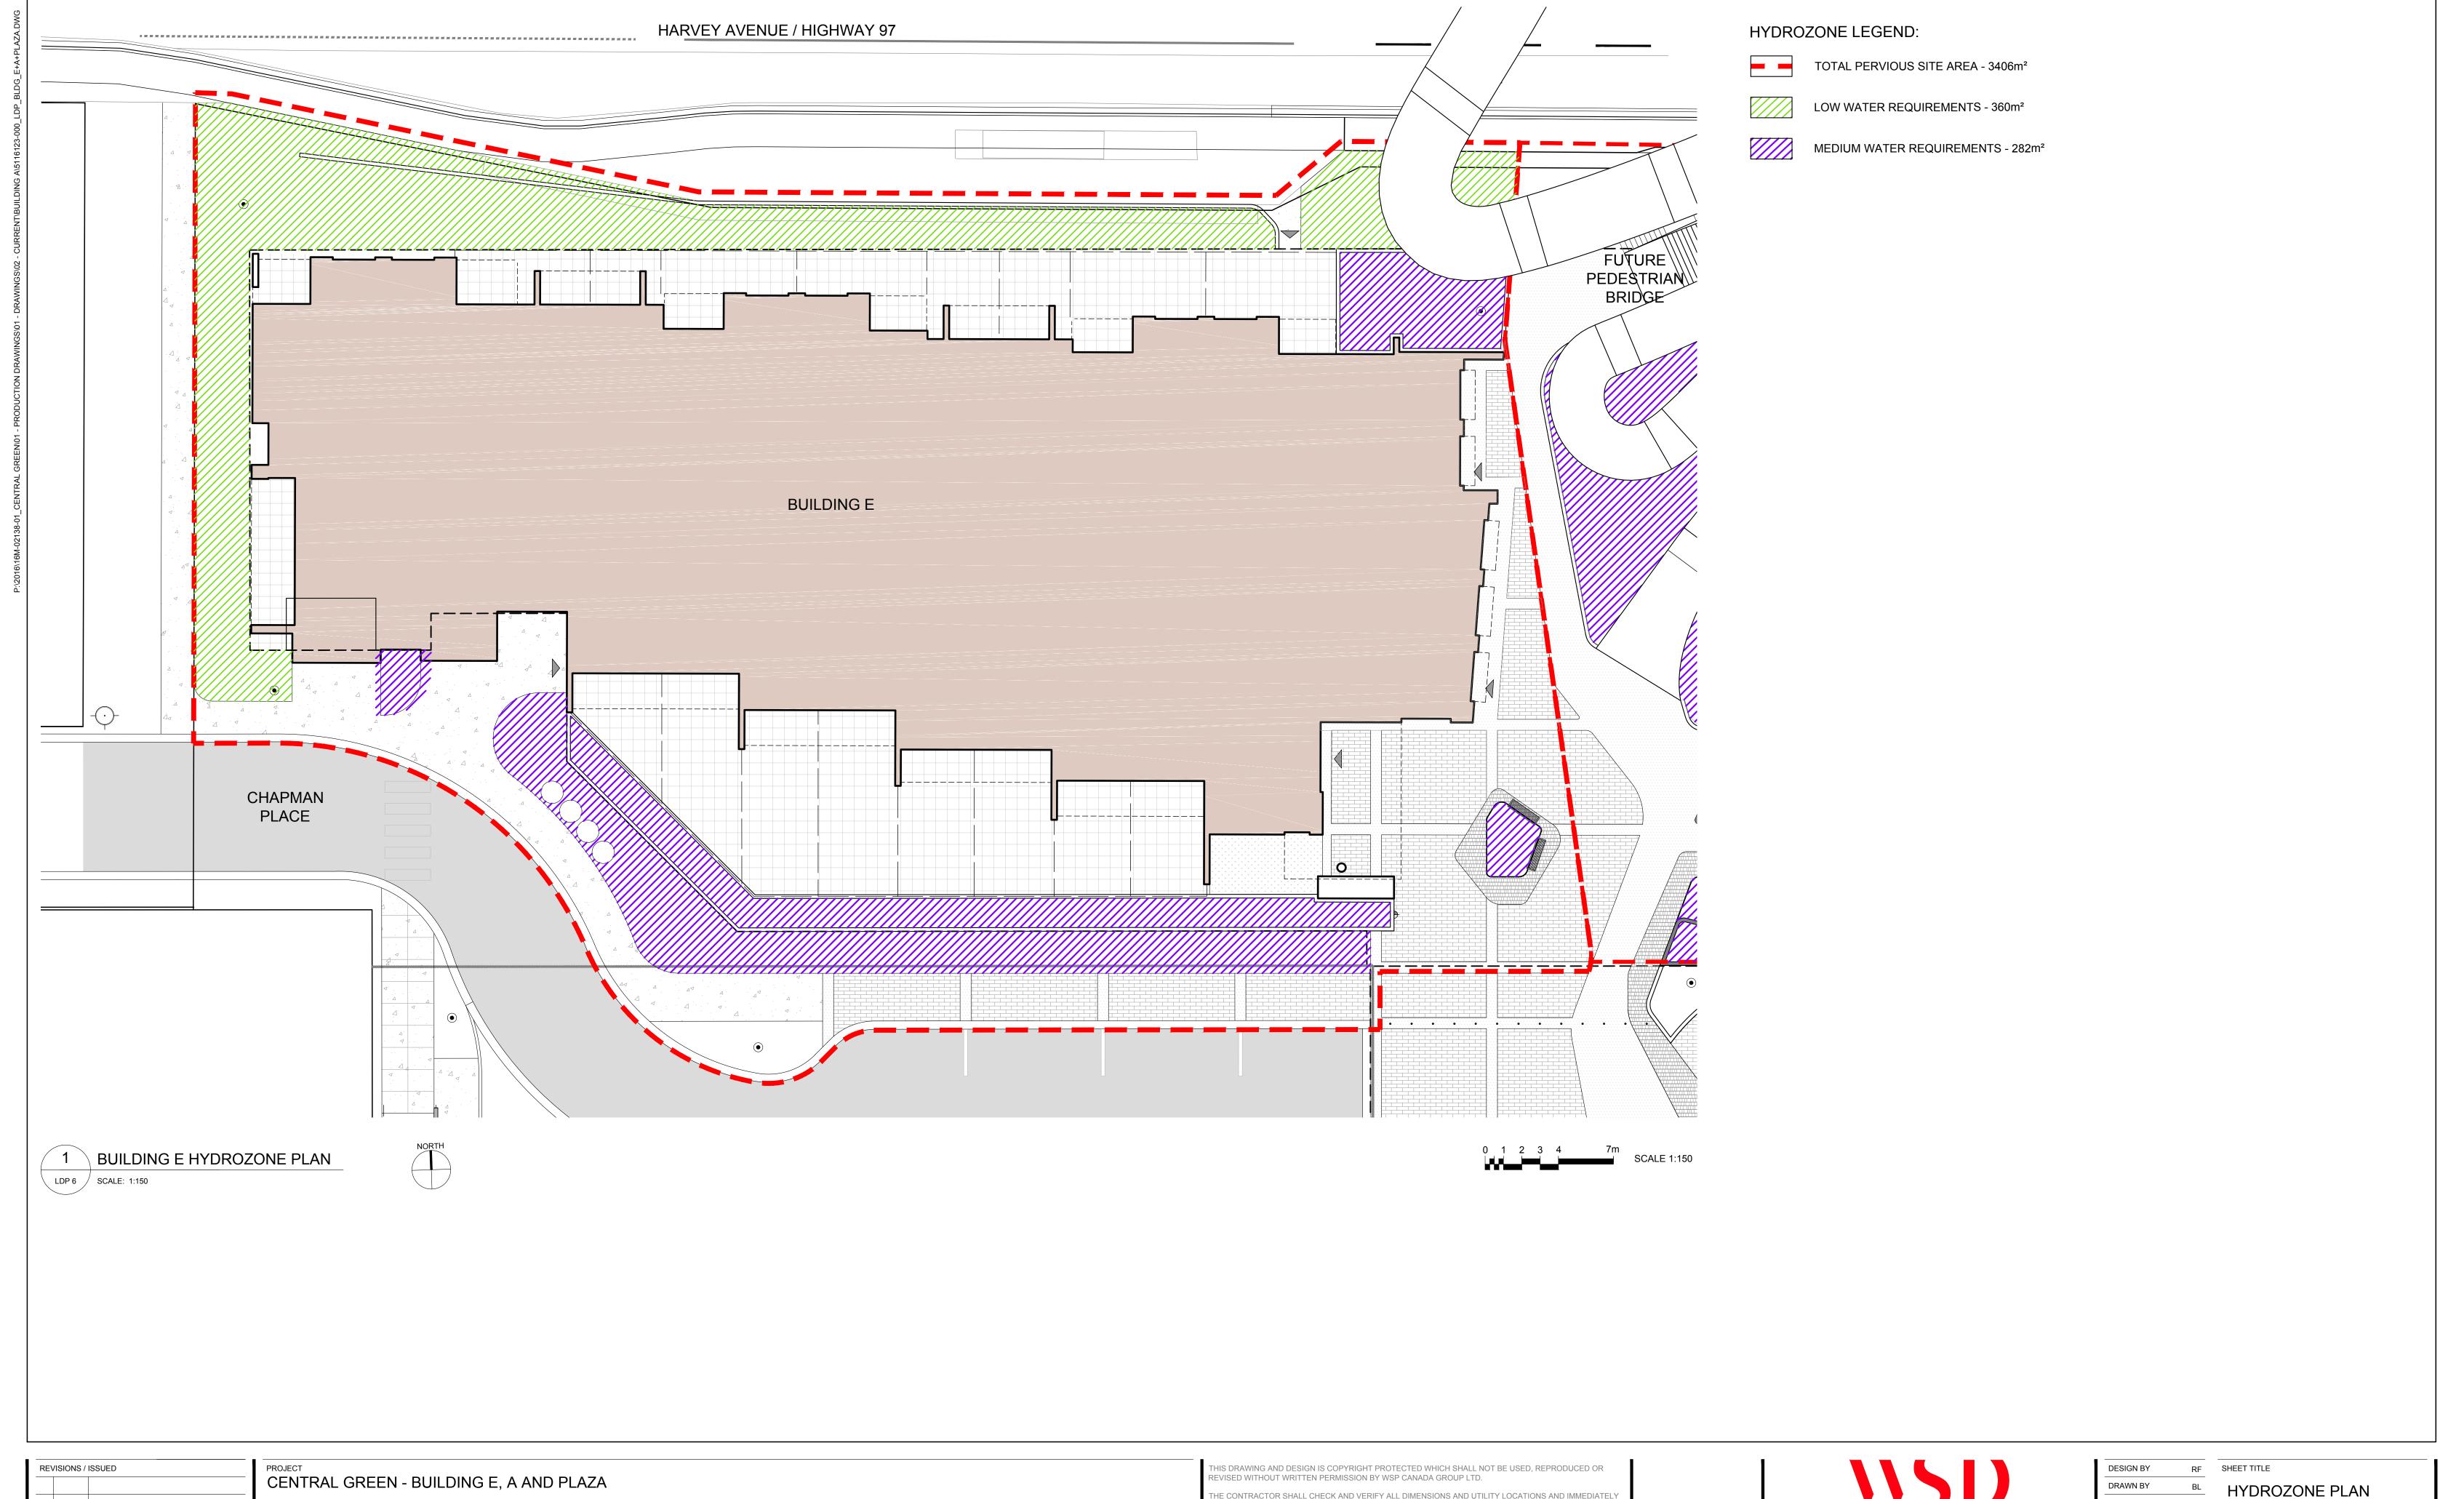
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RENDERINGS

12138 SHEET NO.

LDP 6

OF 8



PROJECT
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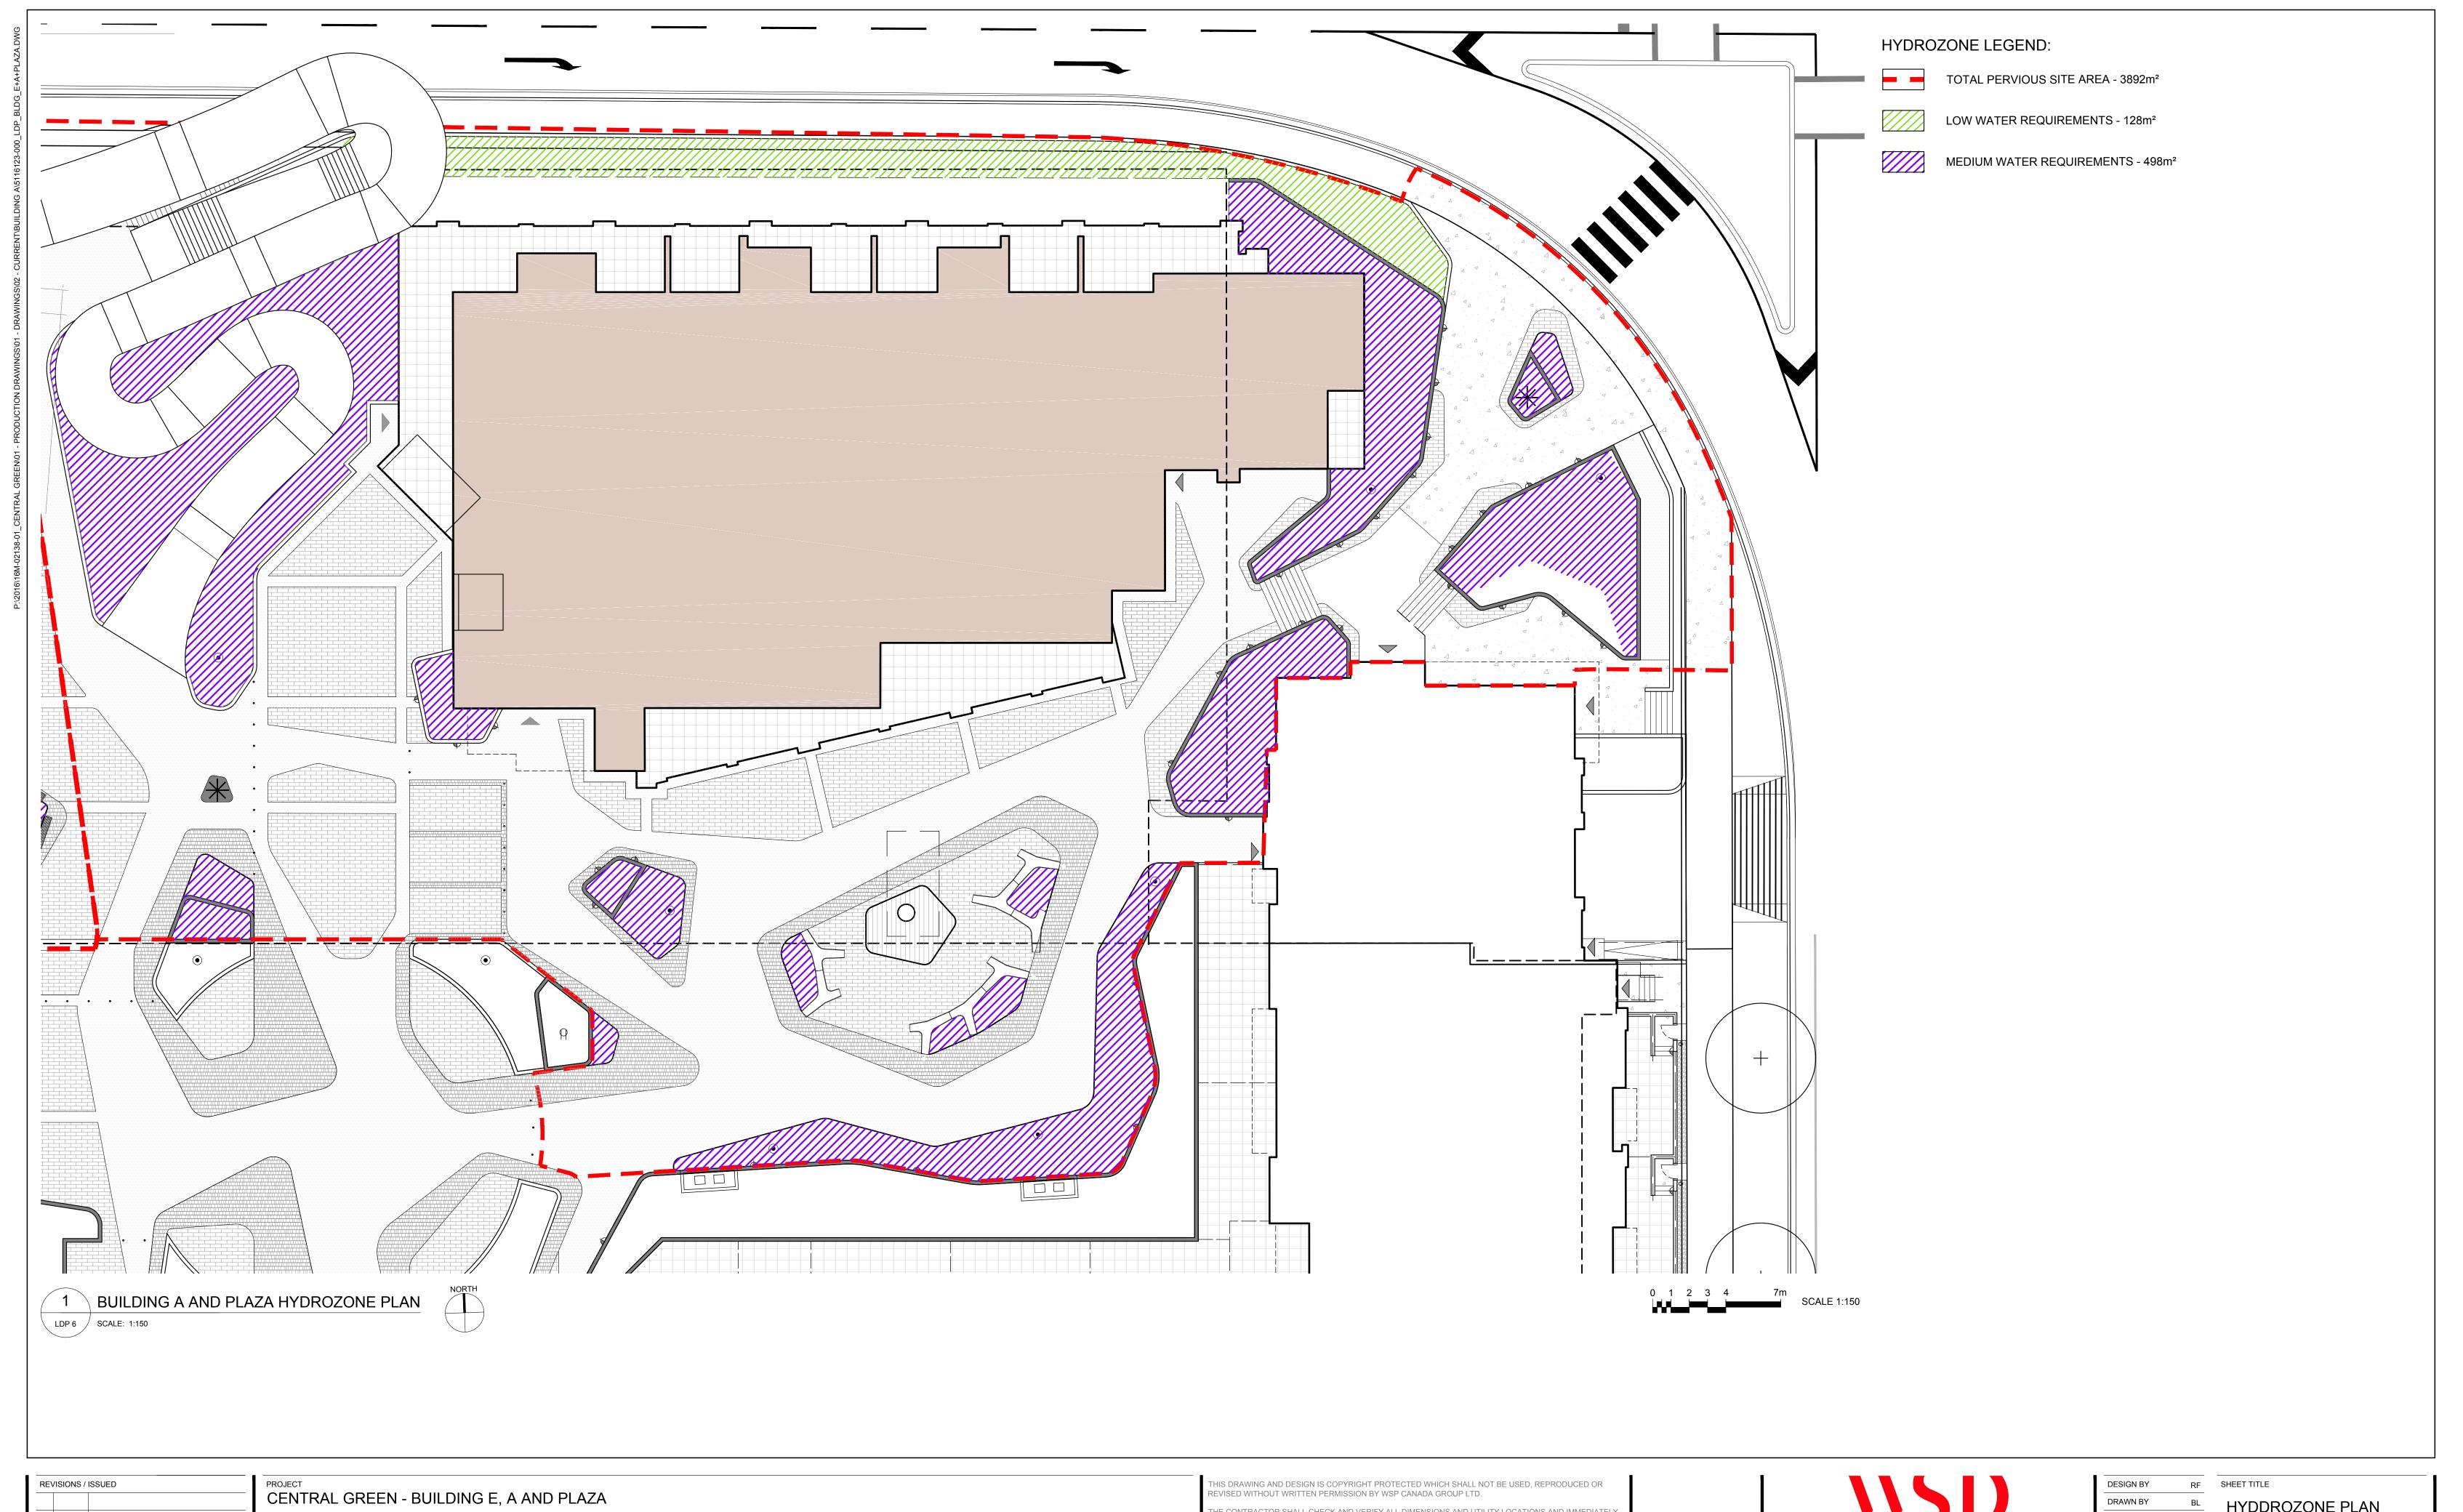
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SHEET TITLE
HYDROZONE PLAN
SHEET NO.
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