

September 26, 2017

Mr. Adam Cseke, Planner City of Kelowna Planning Department 1435 Water Street Kelowna, BC V1Y 1J4

#### RE: OCP Amendment, Rezoning, and Development Application Development Rationale

ADDRESS: 726 & 816 Clement Avenue, Kelowna, BC

Dear Adam:

Further to our prior meetings and correspondence, we are hereby submitting this rationale letter in support of development proposal and subdivision applications for a purpose built mixed-used rental development at 726 & 816 Clement Avenue. Under PC Urban's direction, the proposal reflects consultation with neighbours and businesses, as well as involvement with City of Kelowna stakeholders and official representatives.

#### Introduction

The subject property is located at the northeast corner of Clement Avenue and Richter Street in Kelowna, BC (the "Property"). The Property is comprised of three legal lots that are approximately 5.34 acres (2.16 ha) in area combined and is currently zoned I2 (General Industrial) and I4 (Central Industrial).

PC Urban is applying to consolidate and subdivide the Property into two legal lots including a road dedication to the City: Lot A (1.21 ha) and Lot B (0.675 ha), and 0.277 ha of road – a 10-meter dedication along the south side of the property to allow for widening of Clement Ave. In addition, we will be seeking to rezone the Property to C4 – Urban Center Commercial to allow for two 6-storey purpose built residential buildings with retail at grade on Lot A. A future development application is anticipated for development on Lot B. While existing Official Community Plan (OCP) designates the site as Industrial (IND), based on pre-application

discussions and meetings with the Planning and Engineering Departments, we understand the proposed form of development is strongly aligned with the City's objectives. This development proposal application reflects these previous discussions with Staff.

The development site is fairly flat with all former improvements on the Property removed. The Property has been remediated with three commercial Certificates of Compliance ("CoC") issued from the Ministry of Environment.

This Property is bounded by industrial users to the north (BC Tree Fruits, Sun Ripe, Sandhill Wines), a vacant lot to the east, single family residential to the south, and a new regional RCMP station to the west. In the larger context, the Property is a few blocks northeast of the downtown core, Bernard Street commercial corridor, and several large scale residential and mixed-use developments. Our proposed plan takes into consideration the strong support for rezoning the Property into a higher density urban zone and gateway into the downtown core. PC Urban has developed a similar project at 972 Marine Drive in North Vancouver which has been well received by the community and provides a medium density residential option located in a highly walkable and vibrant area.

#### **Development Rationale**

The proposed plan is to construct two purpose built mixed-use rental buildings on the southwest corner of the site fronting Clement and Richter. The western building façade faces Richter Street and the eastern building façade faces Clement Avenue. A ground level public open space plaza connects the two buildings and provides unobstructed access across the site from Clement Avenue.

The two buildings will resemble each other in design and consist of commercial retail space on the first level and residential rental units above. The size of two buildings combined is approximately 145,063 square feet, with +/- 149 residential units and +/- 16,541 square feet of commercial retail space. All residential units will include outdoor deck space with the 2<sup>nd</sup> level units enjoying larger walkout decks that serve dual purpose as canopies for retail space below. This brings sense of human scale to retail space and distinguishes it from the residential space above. Recessed balconies on levels 2 through 6 reduce the bulkiness of the buildings as well as provide shading for the hot sunny days in Kelowna. Columns of residential balconies have been banded together vertically to allow for more building mass articulation, and to introduce different materials and colours on the façade. Street level commercial units bring an active attraction to this site and make a strong link between public street and buildings. The two buildings share common surface parking with entrances from Vaughan Avenue and Clement Avenue. Majority of the parking surface will be located on the interior of the site and shielded from street view by the two buildings. On the remaining south-east corner of the parking lot, a gable roof canopy identifying the "PACKING DISTRICT" will screen the remainder of the parking as well as speak to the area's past. A breezeway cutting through the first floor of each building connects the parking to the sidewalk, and allows for public pedestrian access.

The proposed uses were carefully developed following detailed market analysis and responds to a severe lack of purpose built, long-term, residential rental supply as well as the desire to transform the downtown north industrial area into a part of the vibrant downtown core.

The development proposal is based on our extensive urban experience and we believe it achieves a balance of uses, site coverage, massing, parking, and overall design as the basis of this application. Some of the fundamentals we ask that be taken into consideration in your assessment are summarized below and in the attached drawing submission.

#### Site Uses, Layout & Density

- The proposed uses for the site are consistent with those outlined in the C4 Urban Center Commercial bylaw.
- Proposed FSR after City dedication is 1.16 which is permitted under C4 zoning.
- 231 at-grade parking spaces (176 spaces required), and 2 loading bays are provided.
- A generous open space plaza has been designed between building 1 and 2 to allow a social gathering area for building residents and commercial customers.

#### **Building Design & Massing**

- Setbacks:
  - All setbacks adhere to the requirements set under zoning bylaws.
- Height:
  - The development will require a variance to the maximum height under the C4 zoning bylaw. The proposed buildings are 6-storeys and approximately 20.5 meters (67'-3") in height which allows the necessary density to provide the City of Kelowna with a purpose-built rental building. We see the location of Property being ideal for renters seeking vibrant urban lifestyle as it is within a 15-minute walk to the downtown business district, Knox Mountain Park and Okanagan Lake.

- Sustainability:
  - Sustainable design elements have been incorporated during the schematic design of this proposal and will continue to be the focal point in design development phase. The urban location and mixed-uses on the site is anticipated to reduce car travel. Additionally, the added density reinforces a pedestrian-centered community with easy access to shopping, beaches, parks, and bike paths. From oversized balconies in every unit to the public plaza at grade, the Property's planning strategy maximizes access to open space as much as possible. The building's exterior has been designed for low maintenance and has a durable timeless aesthetic.
  - Energy efficiency will be achieved through passive building design principles.
     Windows are operable for ample ventilation, and window sizes and glazing types will be optimized for natural light energy performance.
  - Large easily accessible bike rooms have been located at grade to encourage the use of bikes in daily commuting.
  - The site has been designed with a third building in mind on the eastern end of the property line, adding an additional 70-80 units in the future. This will be further developed as the two proposed buildings become fully tenanted and the urban potential of the area is fully realized, thereby increasing demand for walkable downtown rental apartments.
- Landscape:
  - Landscape elements will help to establish and reinforce the historic Packing District by featuring paving with wood pattern, along with chunky timber elements and weathered steel, to express and reflect the historic patterns and materials of the area.
  - Plantings will also help the project fit in with the context and the local ecology. Drought tolerant, local, and native plant choices will be expressive of a Kelowna feeling, while being durable and attractive in all seasons. Mixed with natural stone and wood elements, plantings will feel very expressive of the area.
  - Plant materials are in addition selected based on low-maintenance and highly attractive characteristics, with low water requirements to maximize the yearround visual interest and function of the landscape designs.

- Civil & Storm Water Management
  - A schematic design report and draft civil drawings have been included in the submission.
  - Stormwater servicing is proposed to be in compliance with the City of Kelowna by-law 7900.

We believe the proposed form of development is consistent with and strengthens the existing neighborhood; provides employment generating opportunities to the City; maintains continuity of the urban environment; and based on the successful completion of other urban mixed-use projects, we are confident that the form of development is balanced and will function well for land use, parking, and tenant livability.

Thank you for your consideration. We can expand further upon our findings and answer any questions that have not been addressed in the application. We look forward to moving through the process with you and will provide quick turnaround time to expedite the process.


Respectfully submitted, PC URBAN CLEMENT HOLDINGS LTD.

Routsp

Robert Spencer Sr. Development Manager

Copies: G. Fawley PCU Tom Staniszkis NSDA Architects David Stoyko Connect Landscape Architecture

#### /attachments

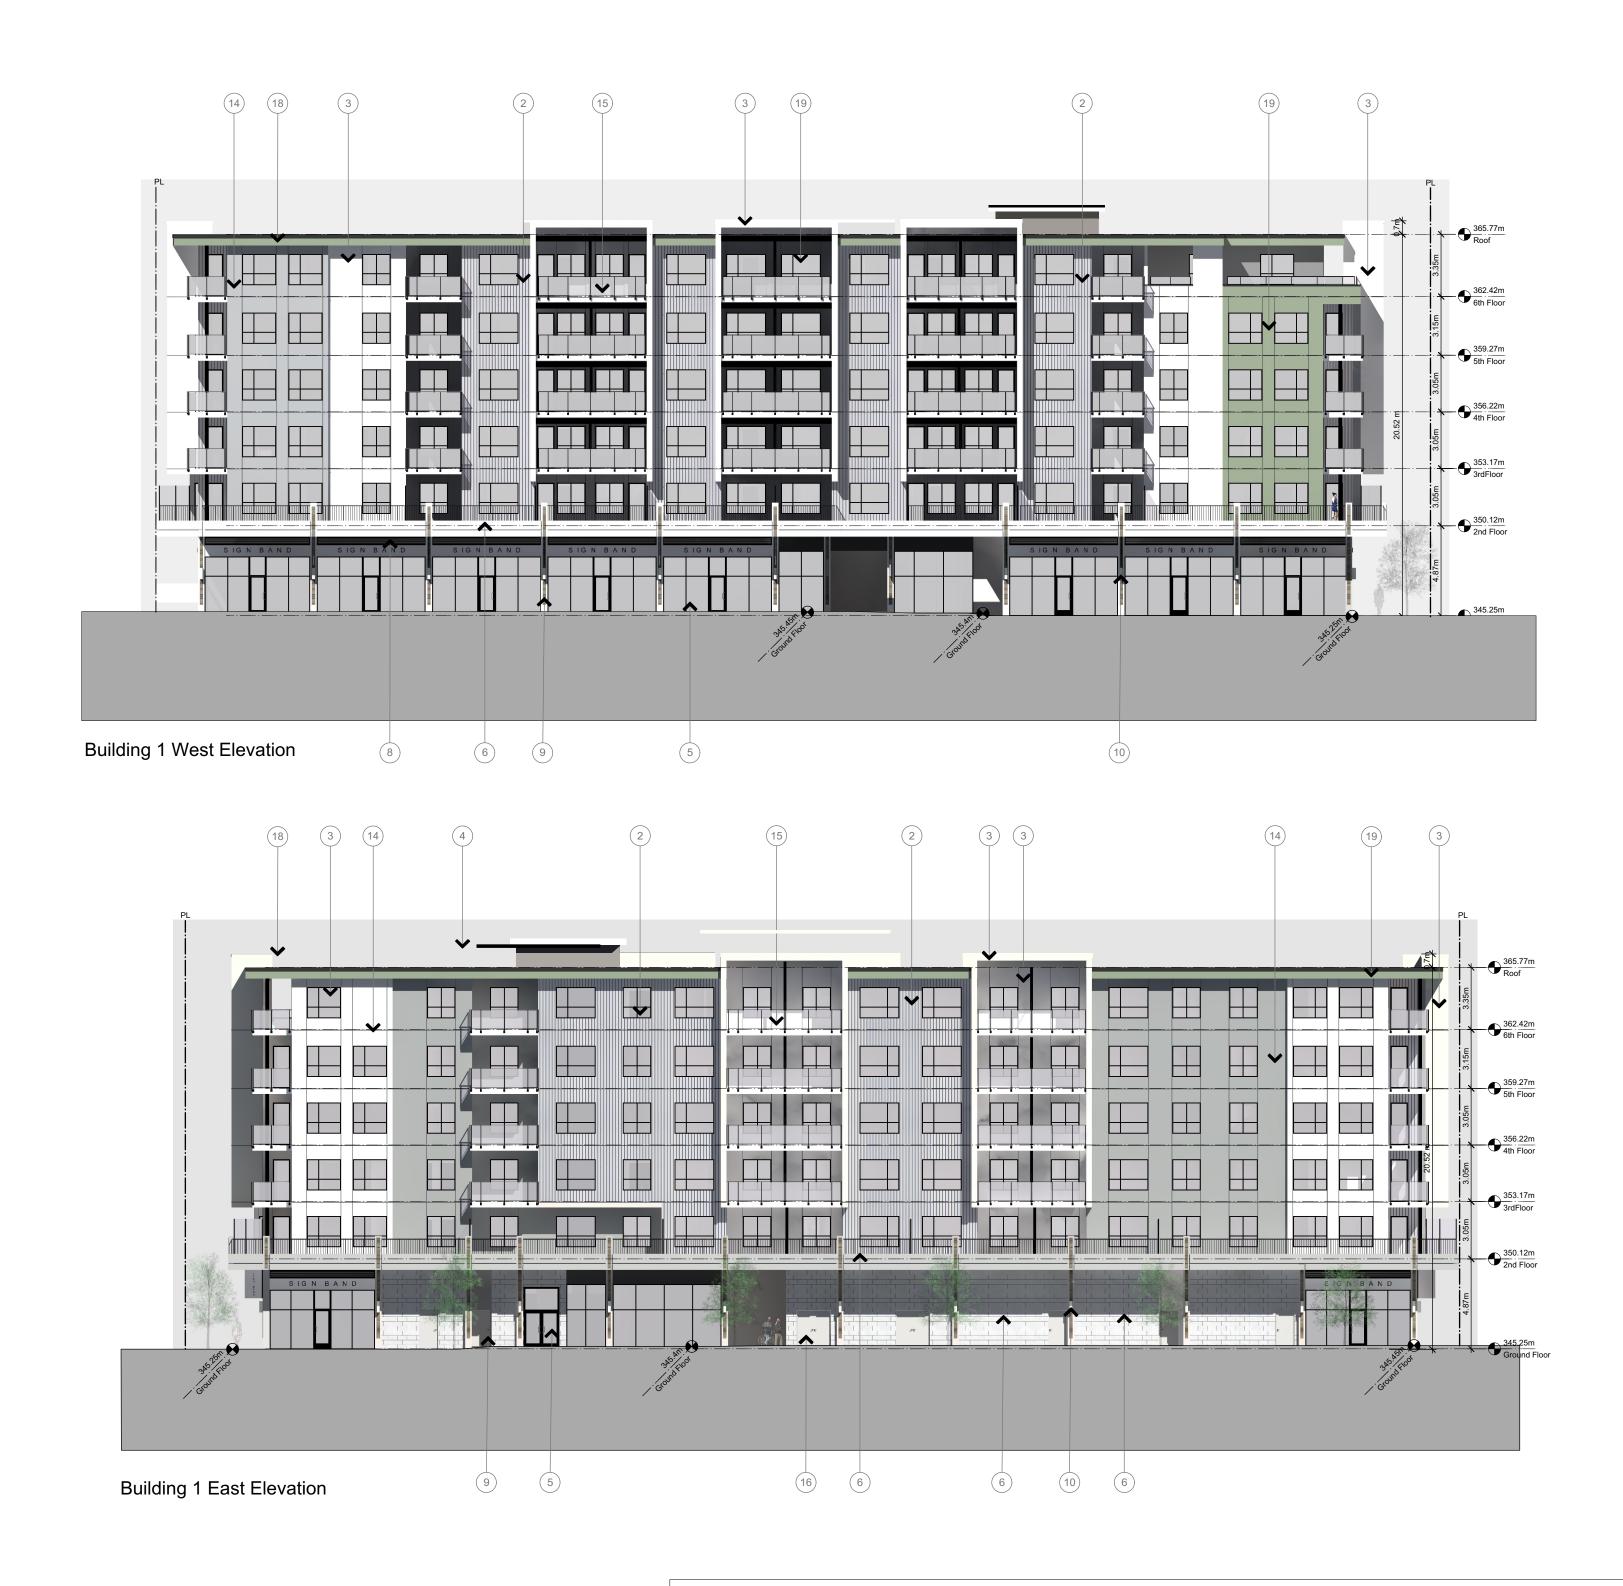

#### Material List:

1- Hardie Panel A + Hardie Fascia A

- 2- Corrugated Metal Panel
- 3- Hardie Panel B 4- Alum. Flashing
- 5- Shop Front Windows
- 6- Exposed Concrete/Concrete Block painted Off-White
- 7- Sign Band
- 8- Alum.Louver

9- Concrete Post W/wood texture strip inlay

10- Exterior Light Fixture

- 11- Standing Sim Metal Roof
- 12- Stained Wood Post on Concrete Base
- 13- "Packing District Sign"
- 14- Hardie Panel C
- 15- Glass Guardrail W/Alum. Frame
- 16- Metal Door
- 17- Alum. Guardrail
- 18- Hardie Panel D
- 19- Vinyl Window/Patio Door(Black)








	Material Palette
•	
Hardie Panel	



	•
•	Corrugated metal panel

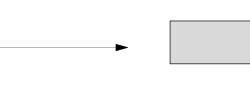



Hardie Panel A - Colour:Red









•

Painted concrete block wall

Colour: Off-White

Wood Texture Alum. (Concrete Post Inlay)

Charcoal black Alum.( Flashing, Guardrails & Window Frames)

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Seal

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Project Clement Ave Mixed Use Development

Sheet Title **Elevations Building1** 


Project Number 16049 Scale



	(19) (2)	(15)	2	3	4		
Building 2 South Elevation	n <sup>(5)</sup>	6		8 7	)	6 (17)	
	3) (2)	(15)	(14)	3		3)	
							_
Building 2 North Elevation	(17) (16)	9	6			10	
Material List:					Material F	Palette	
1- Hardie Panel A + Hardie Fascia A 2- Corrugated Metal Panel 3- Hardie Panel B				• Hardie Panel			
<ul> <li>4- Alum. Flashing</li> <li>5- Shop Front Windows</li> <li>6- Exposed Concrete/Concrete Block painte</li> <li>7- Sign Band</li> </ul>	ed Off-White						
8- Alum.Louver 9- Concrete Post W/wood texture strip inlay 10- Exterior Light Fixture 11- Standing Sim Metal Roof 12- Stained Wood Post on Concrete Base			· · · · · ·	• Corrugated metal p	anel		
<ul> <li>13- "Packing District Sign"</li> <li>14- Hardie Panel C</li> <li>15- Glass Guardrail W/Alum. Frame</li> <li>16- Metal Door</li> <li>17- Alum. Guardrail</li> <li>18- Hardie Panel D</li> </ul>				-			

Painted concrete block wall


19- Vinyl Window/Patio Door(Black)

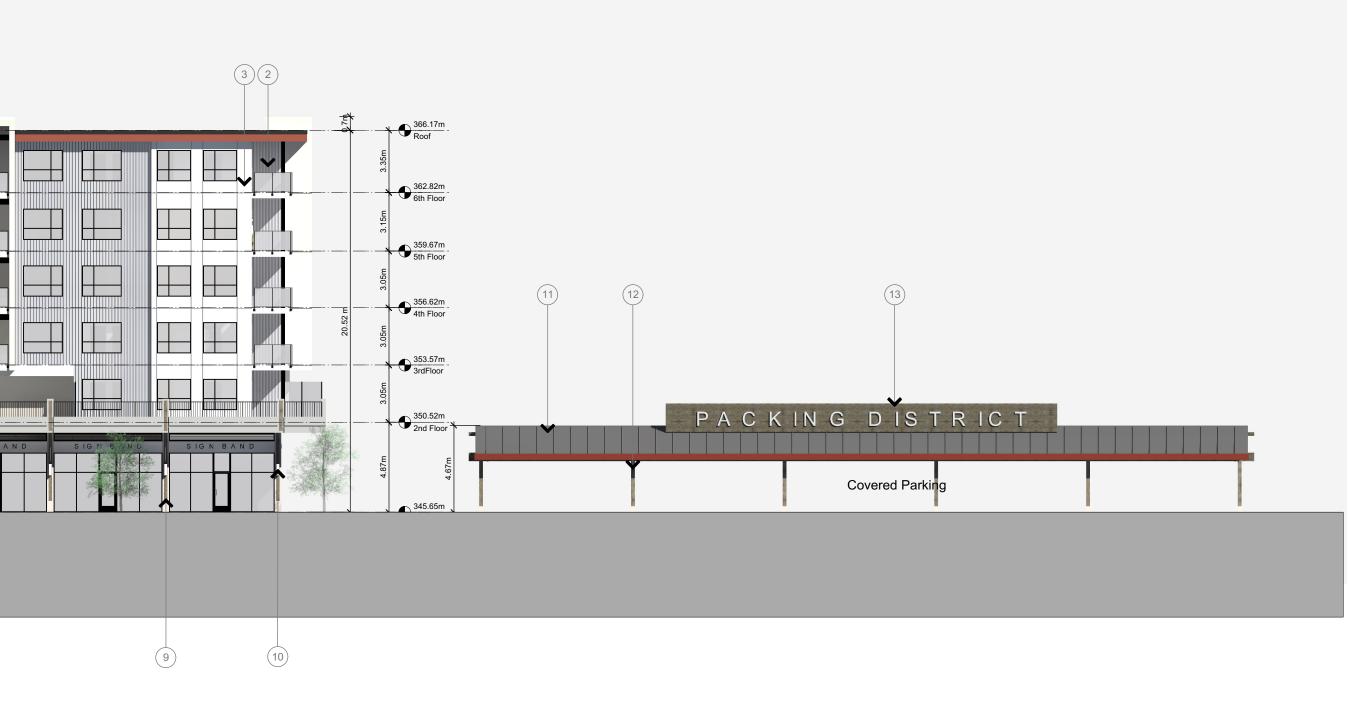





1

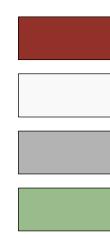

# Hardie Panel A - Colour:Red Hardie Panel B - Colour: Off-White

Hardie Panel C - Colour: Light Gray

Hardie Panel D - Colour: Green



Colour: Silver Gray

Colour: Off-White

Wood Texture Alum. (Concrete Post Inlay) Charcoal black Alum.( Flashing, Guardrails & Window Frames)

Building 2 East Elevation



Sep/15/2017

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Project Clement Ave Mixed Use Development

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Sheet Title Elevations Building2

Project Number 16049 Scale



# CLEMENT AVE MIXED USE DEVELOPMENT/ **PACKING DISTRICT**



P3: Existing site bird's eye view looking from southwest

t: (604) 669 1926

## Project Data:

Project Address: 726 Clement Ave, Kelowna , BC

#### Legal Description:

BLOCK 29 SECTION 30 TOWNSHIP 26 ODYD PLAN 202 EXCEPT PLANS 5011 AND KAP55948; LOT A SECTION 30 TOWNSHIP 26 ODYS PLAN KAP55948 LOT 1 AND LOT 2 SECTION 30 TOWNSHIP 26 OSOYOOS DIVISION YALE DISTRICT PLAN EPP34493

## Project Team:

Developed by: PC Urban 880 - 1090 W.Georgia St, Vancouver , BC t: (604) 408 5687

Architecture: NSDA Architects 201- 134 Abbott St, Vancouver BC

Landscape: Connect Lanscape Archtecture 2305 Hemlock St, Vancouver, BC t: (604) 681 3303

**Civil: True Consulting** 203- 570 Raymer Ave, Kelowna, BC t: (250) 861 8783 c: (250) 470 2416

Survey: Vector Geometric Land Surveying 170-1855 Kitchner Rd, Kelowna BC

t: (250) 868 0172


P3: Existing site bird's eye view looking from southeast

Drawings List
A001
A002
A003
A101
A102
A301
A302
A303
L1.0 to L1.2
C1 to C13

- ..Cover Sheet
- ...Site Plan
- ...Roof Plan
- ...Floor Plans B1
- ...Floor Plans B2
- ...Elevations B1
- ...Elevations B2
- ...Sections B1& B2
- ...Landscape
- ...Civil



P1: Existing Site view from corner of Clement Ave and Richter St

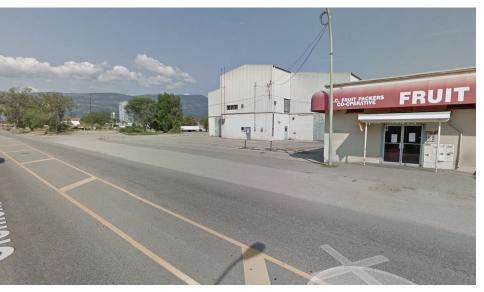

P2: Existing Site view from Clement Ave looking west



P3: Existing Site view from corner of Vaughan Ave and Richter St



P4: Existing Site view from corner of Vaughan Ave and Richter St looking northeast



P5: Existing Site view from Vaughan Ave looking west



V1: Proposed B1 & B2 view from corner of Clement Ave and Richter St





V3: Proposed Covered Parking Area view from southwest corner

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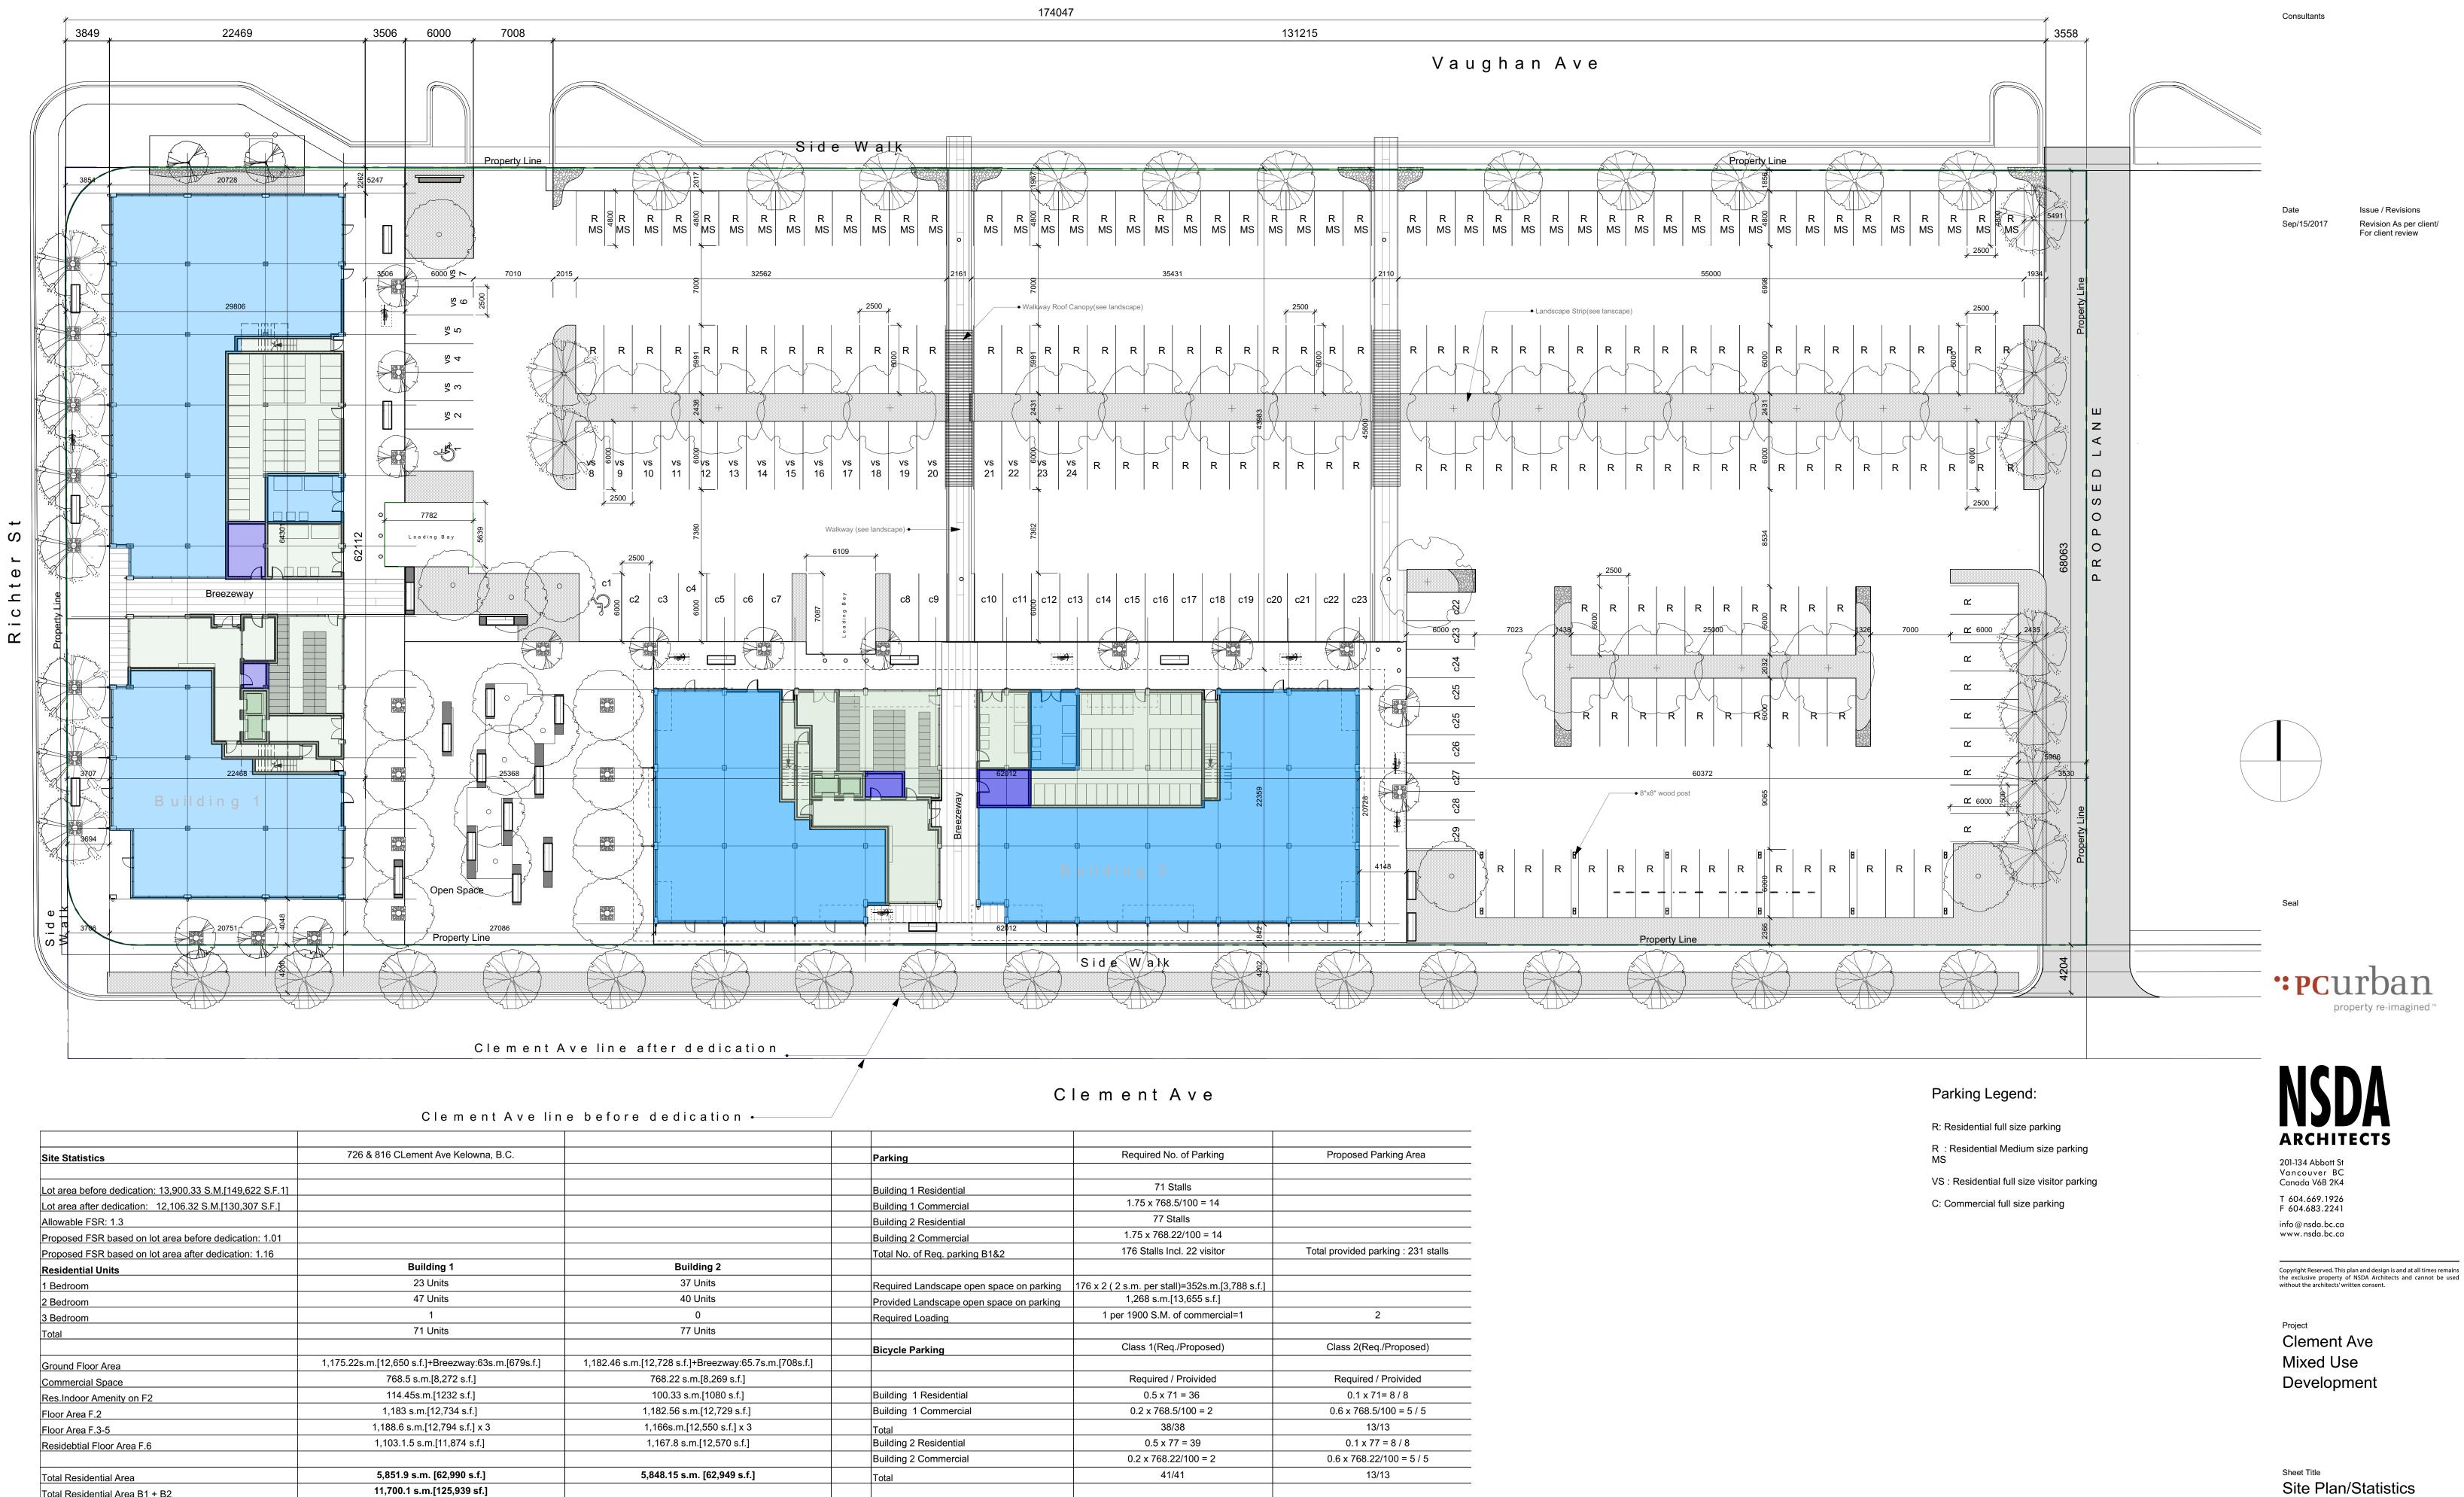
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Project Clement Ave Mixed Use Development

Sheet Title **Cover Sheet** 

Project Number 16049 Scale N.T.S Sheet Number A-001




		-
Site Statistics	726 & 816 CLement Ave Kelowna, B.C.	
Lot area before dedication: 13,900.33 S.M.[149,622 S.F.1]		
Lot area after dedication: 12,106.32 S.M.[130,307 S.F.]		
Allowable FSR: 1.3		
Proposed FSR based on lot area before dedication: 1.01		
Proposed FSR based on lot area after dedication: 1.16		
Residential Units	Building 1	Building 2
1 Bedroom	23 Units	37 Units
2 Bedroom	47 Units	40 Units
3 Bedroom	1	0
Total	71 Units	77 Units
	1,175.22s.m.[12,650 s.f.]+Breezway:63s.m.[679s.f.]	1,182.46 s.m.[12,728 s.f.]+Breezway:65.7s.m.[708s.f.]
Ground Floor Area	768.5 s.m.[8,272 s.f.]	768.22 s.m.[8,269 s.f.]
Commercial Space	114.45s.m.[1232 s.f.]	100.33 s.m.[1080 s.f.]
Res.Indoor Amenity on F2	1,183 s.m.[12,734 s.f.]	1,182.56 s.m.[12,729 s.f.]
Floor Area F.2	1,188.6 s.m.[12,794 s.f.] x 3	1,166s.m.[12,550 s.f.] x 3
Floor Area F.3-5 Residebtial Floor Area F.6	1,103.1.5 s.m.[11,874 s.f.]	1,167.8 s.m.[12,570 s.f.]
		.,
Total Residential Area	5,851.9 s.m. [62,990 s.f.]	5,848.15 s.m. [62,949 s.f.]
Total Residential Area B1 + B2	11,700.1 s.m.[125,939 sf.]	
Total Area B1+B2	14,057.8 s.m.[151,317 sf.]	
Private Open Space Area	Building 1	Building 2
Required	23(1BDR)x10+47(2BDR)x15=935 s.m.[10,064 s.f.]	37(1BDR)x10+40(2&3BDR)x15=970 s.m.[10,441 s.f.]
Provided 2nd Floor Deck	2nd F.Deck :386.2s.m.[4,157 s.f.]	2nd F.Deck :413.6 s.m.[4,452s.f.]
Provided Deck on Floor 3,4 & 5	135 s.m.[1,453 s.f.] x 3 = 405[4,359 s.f.]	126.06 s.m.[1,357 s.f.] x 3 = 378.2 s.m.[4,071 s.f.]
Floor 6	Decks:222 s.m.[2,389s.f.]	Decks:138 s.m.[1,485s.f.]
Total provided open space in building	1,013.2 s.m.[10,906 s.f.]	929.8 s.m.[10,008 s.f.]

Parking	Required No. of Parking	Proposed Parking Area
Building 1 Residential	71 Stalls	
Building 1 Commercial	1.75 x 768.5/100 = 14	
Building 2 Residential	77 Stalls	
Building 2 Commercial	1.75 x 768.22/100 = 14	
Total No. of Req. parking B1&2	176 Stalls Incl. 22 visitor	Total provided parking : 231 stalls
Required Landscape open space on parking	176 x 2 ( 2 s.m. per stall)=352s.m.[3,788 s.f.]	
Provided Landscape open space on parking	1,268 s.m.[13,655 s.f.]	
Required Loading	1 per 1900 S.M. of commercial=1	2
Bicycle Parking	Class 1(Req./Proposed)	Class 2(Req./Proposed)
	Required / Proivided	Required / Proivided
Building 1 Residential	0.5 x 71 = 36	0.1 x 71= 8 / 8
Building 1 Commercial	0.2 x 768.5/100 = 2	0.6 x 768.5/100 = 5 / 5
Total	38/38	13/13
Building 2 Residential	0.5 x 77 = 39	0.1 x 77 = 8 / 8
Building 2 Commercial	0.2 x 768.22/100 = 2	0.6 x 768.22/100 = 5 / 5
Total	41/41	13/13


Project Number

16049 Scale 1/250 Sheet Number A-002

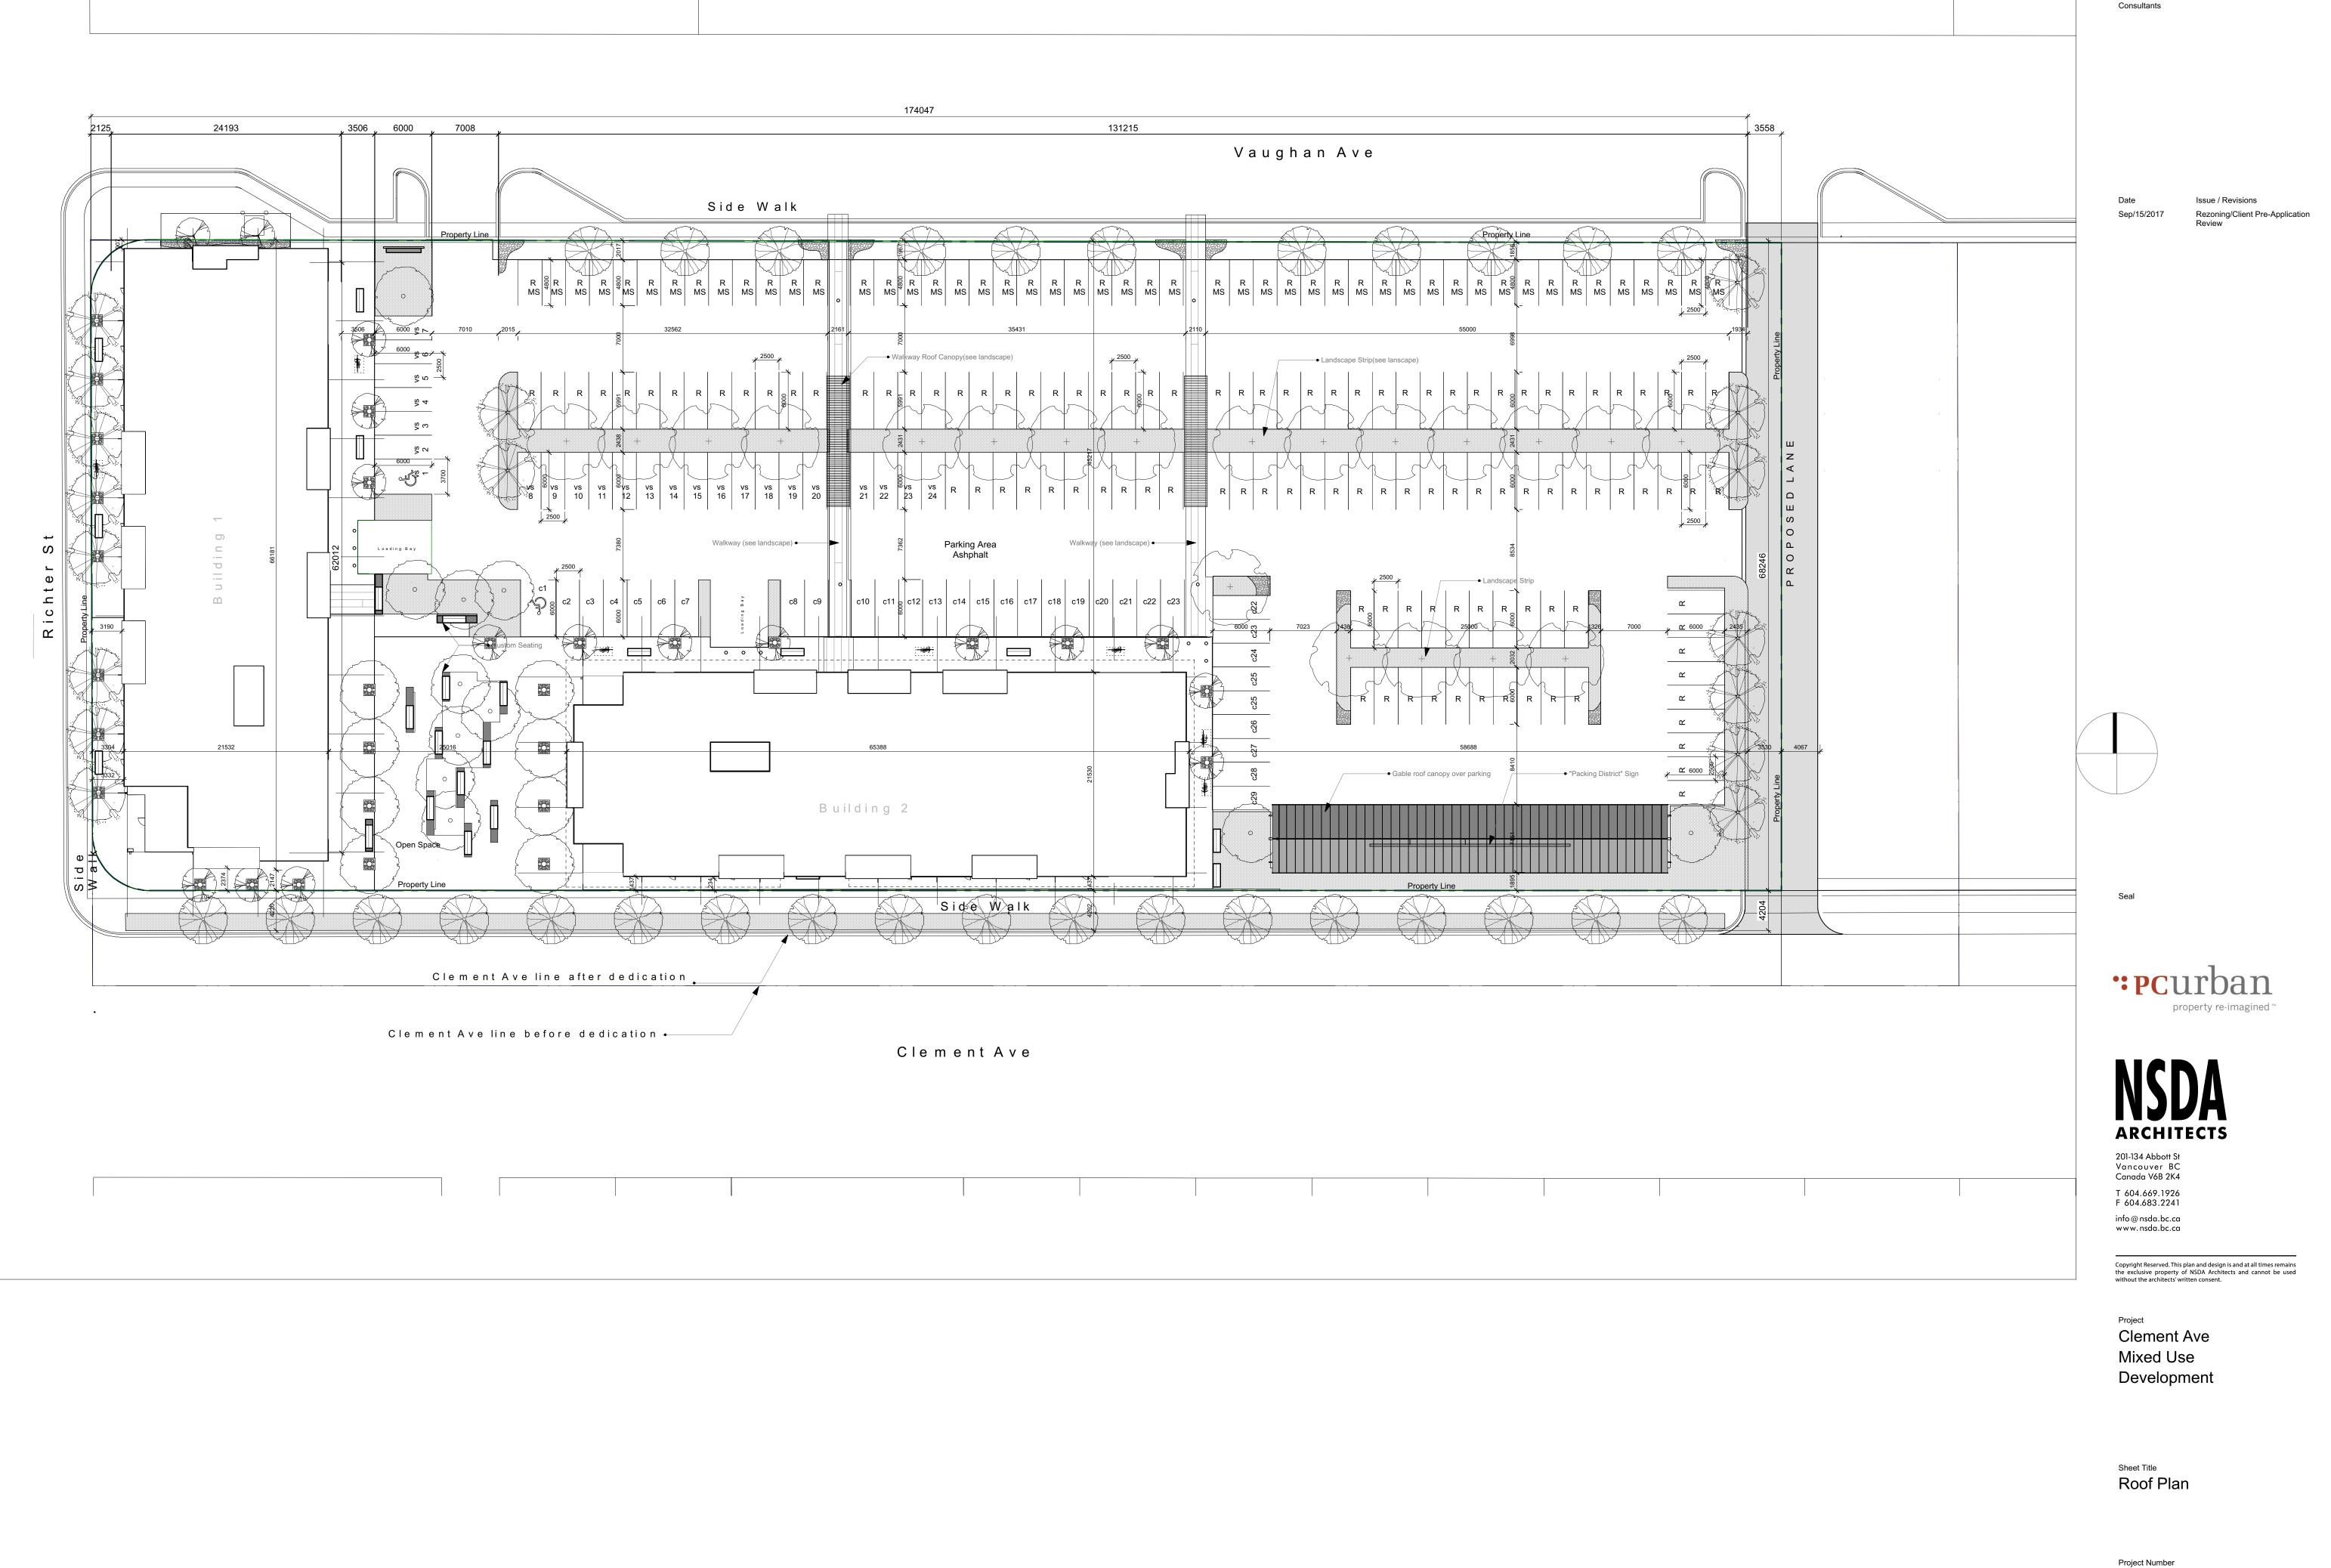


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A-003



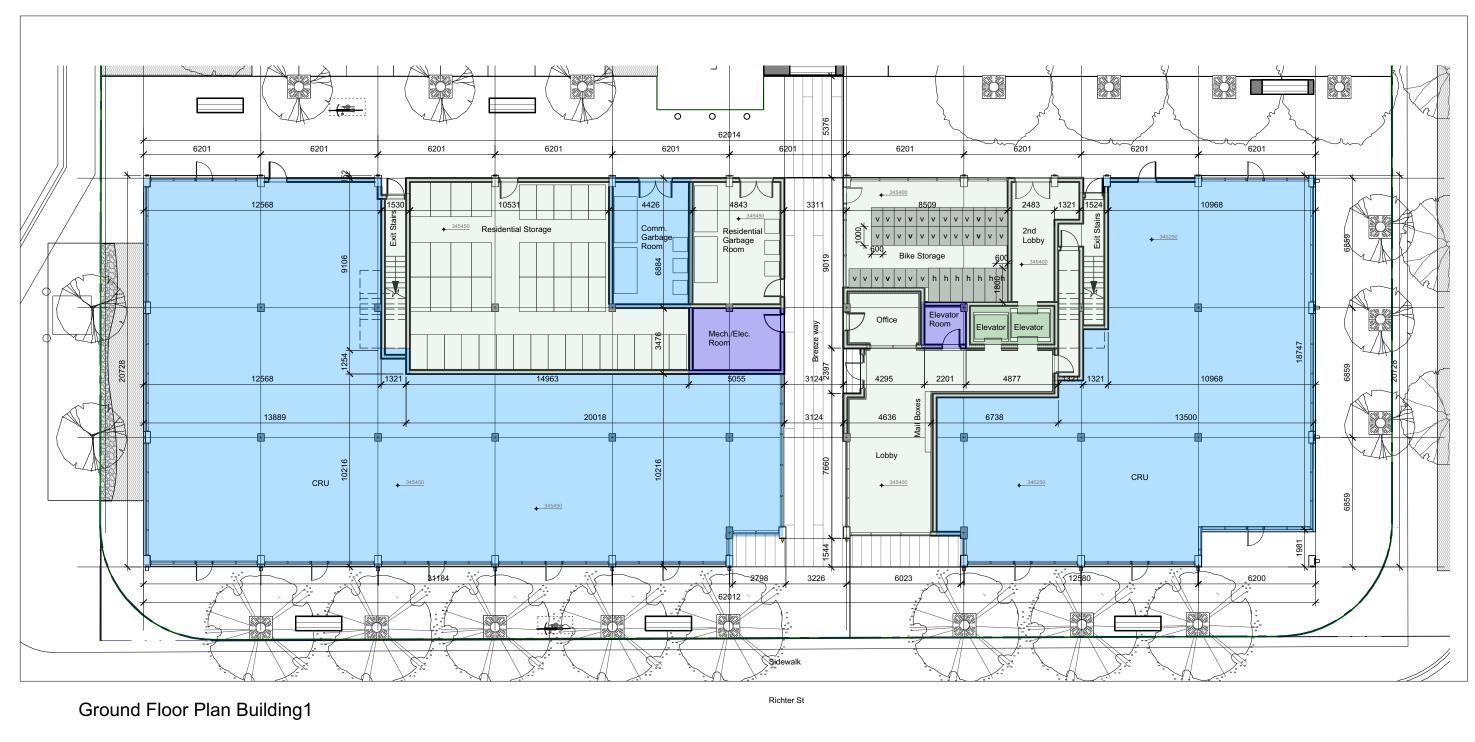





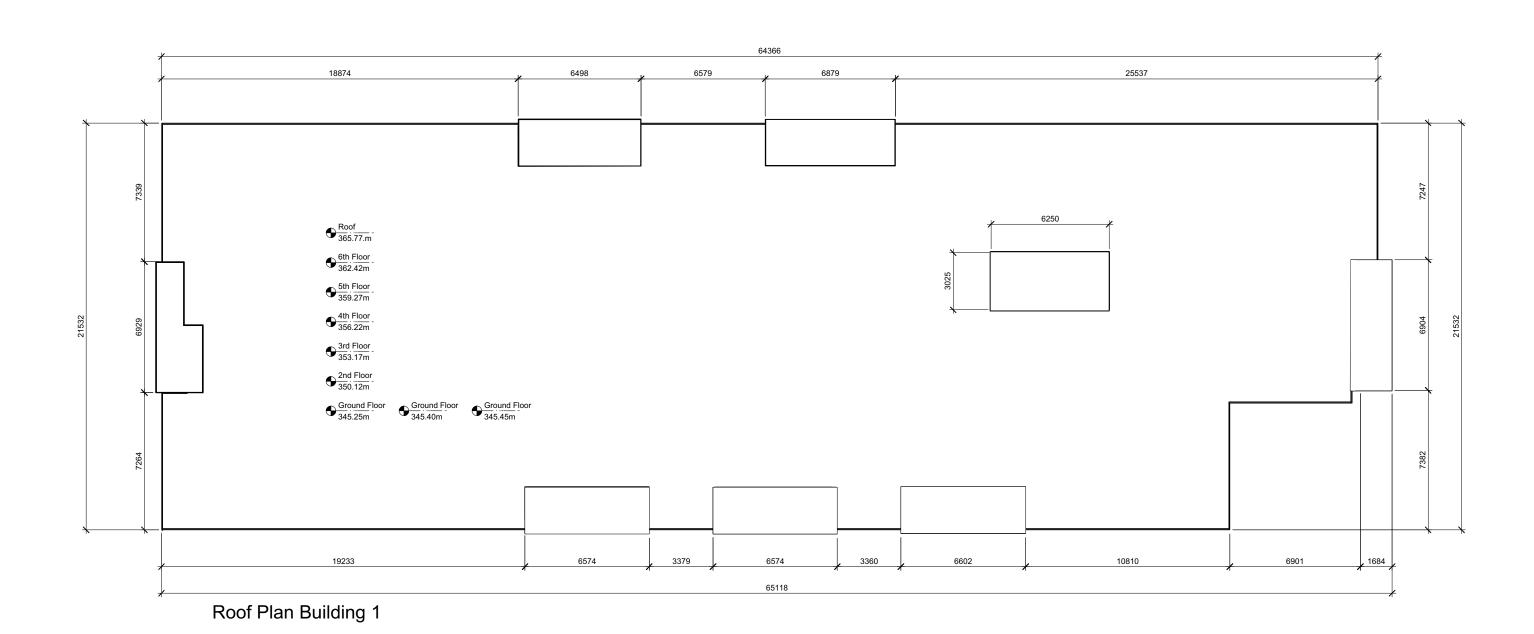







Legend:



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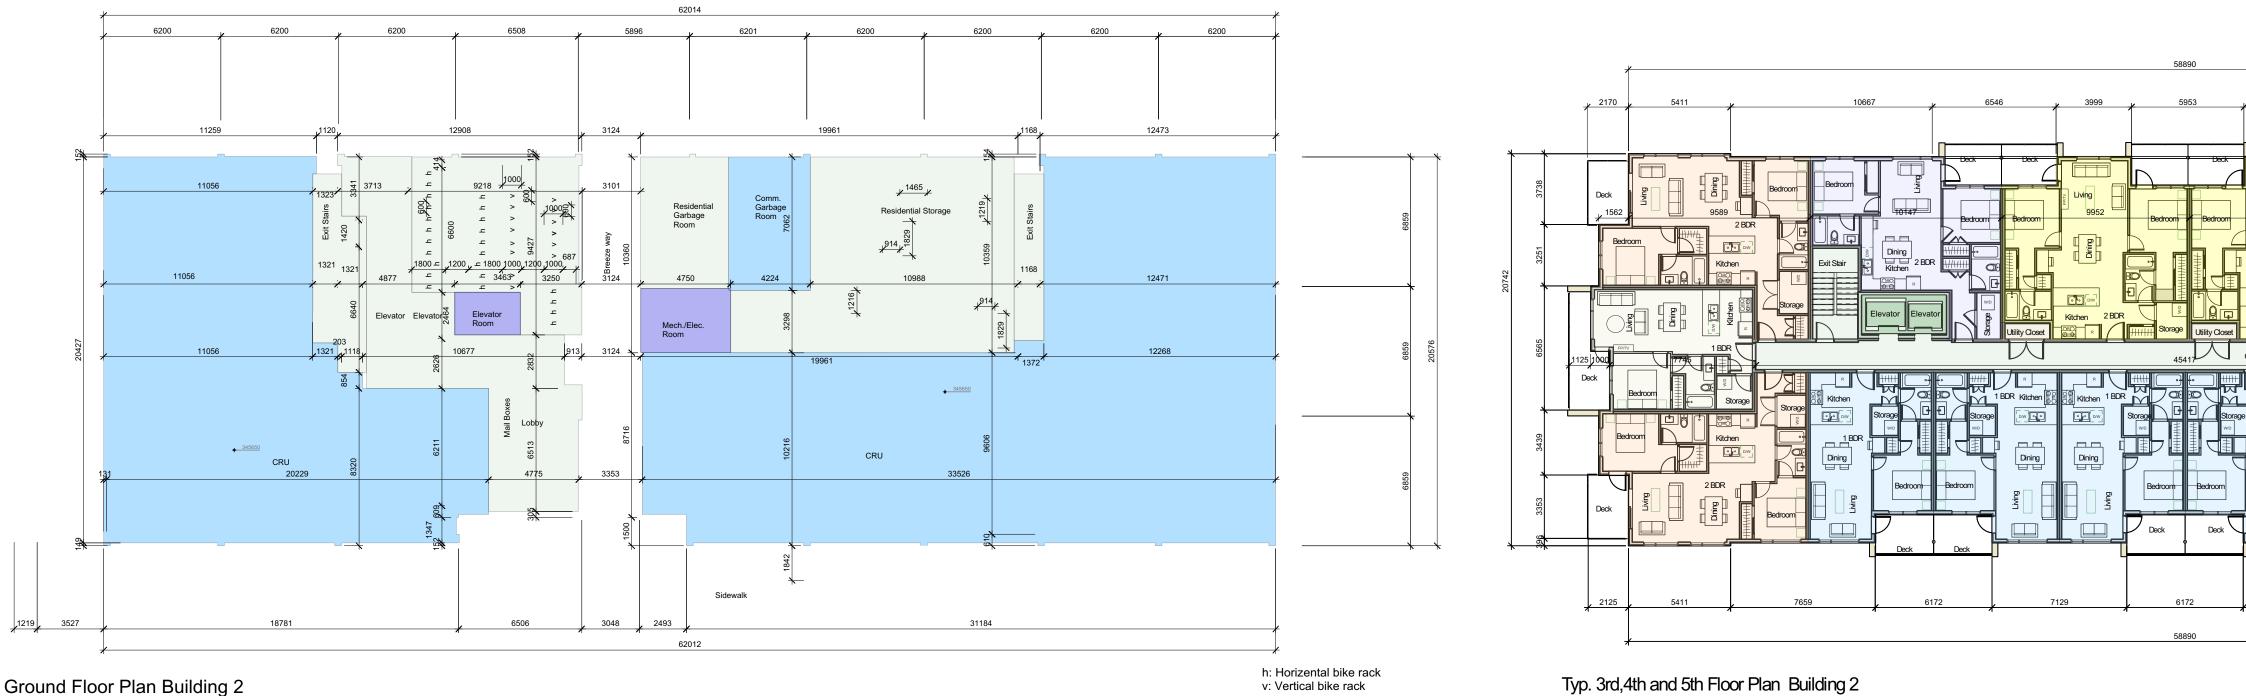


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Project Clement Ave Mixed Use Development

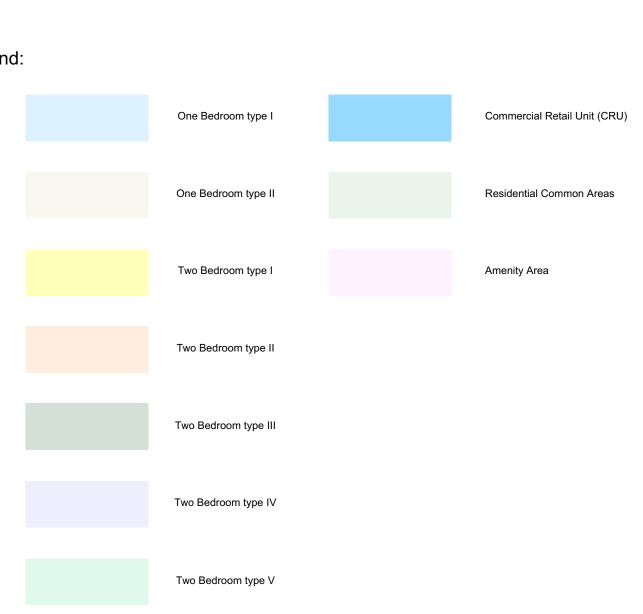Sheet Title Floor Plans Building 1

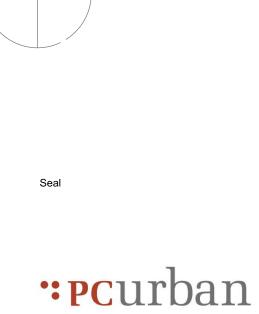
Project Number 16049 Scale 1/200 Sheet Number A-101



Ground Floor Plan Building 2




<sup>2</sup>nd Floor Plan Building 2

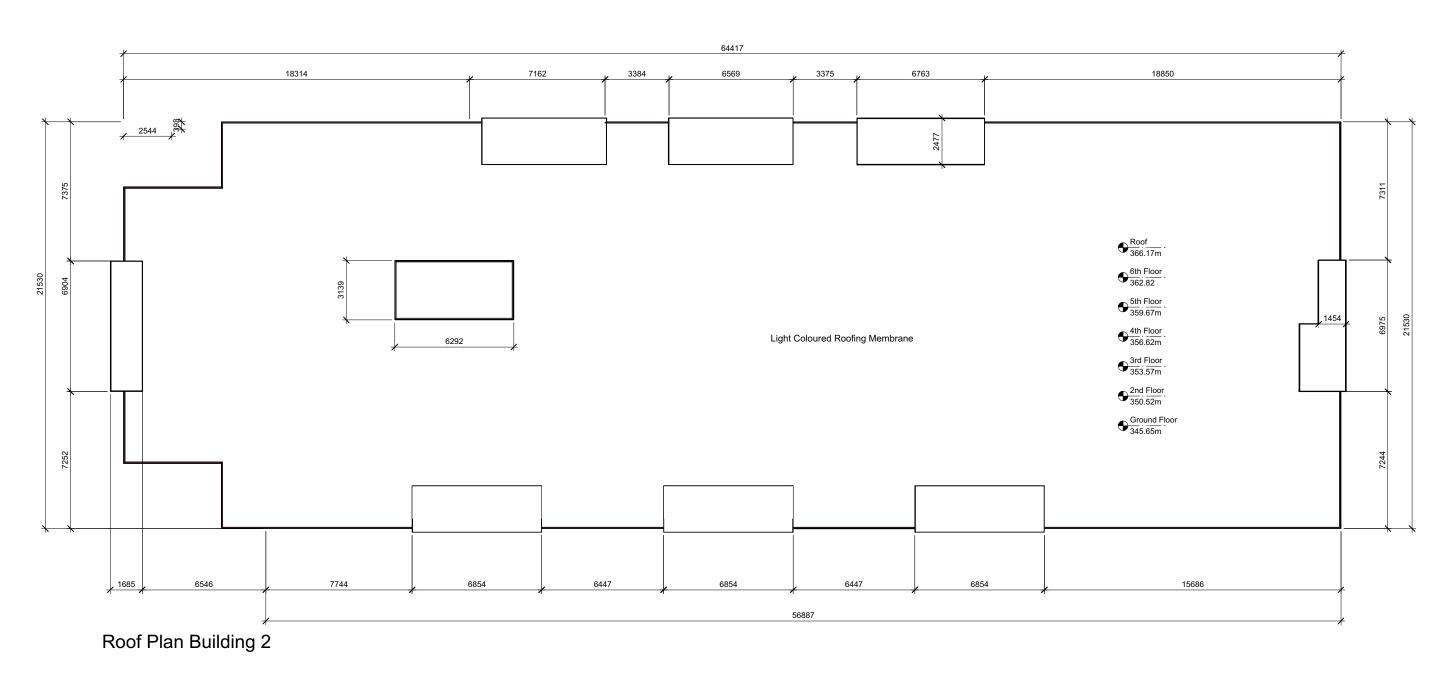



Legend:

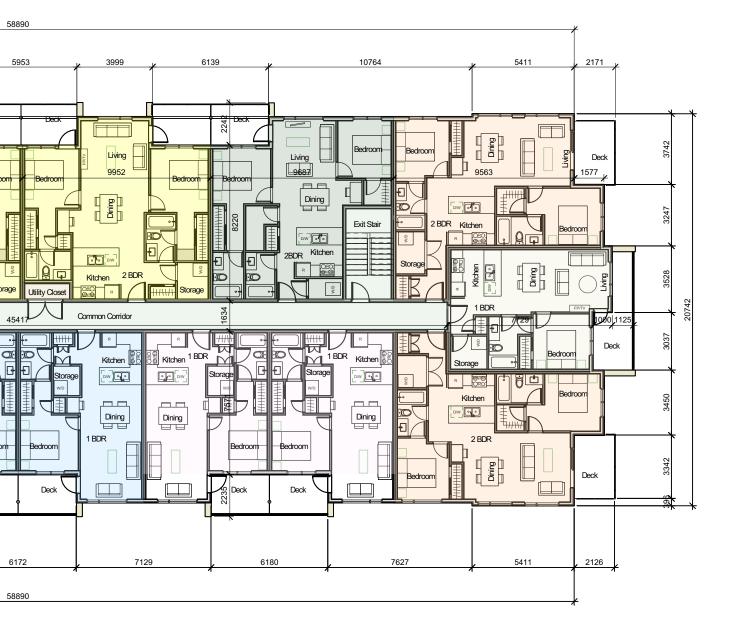

July/07/2017

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One Bedroom type I One Bedroom type II Two Bedroom type I Two Bedroom type II Two Bedroom type III Two Bedroom type IV

Two	Bedroo	om ty	/pe	v

Commercial Retail Unit (CRU)

Residential Common Areas

Amenity Area

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ARCHITECTS


Seal


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Project Clement Ave Mixed Use Development

Sheet Title Floor Plans Building 2

Project Number 16049 Scale 1/200 Sheet Number A-102



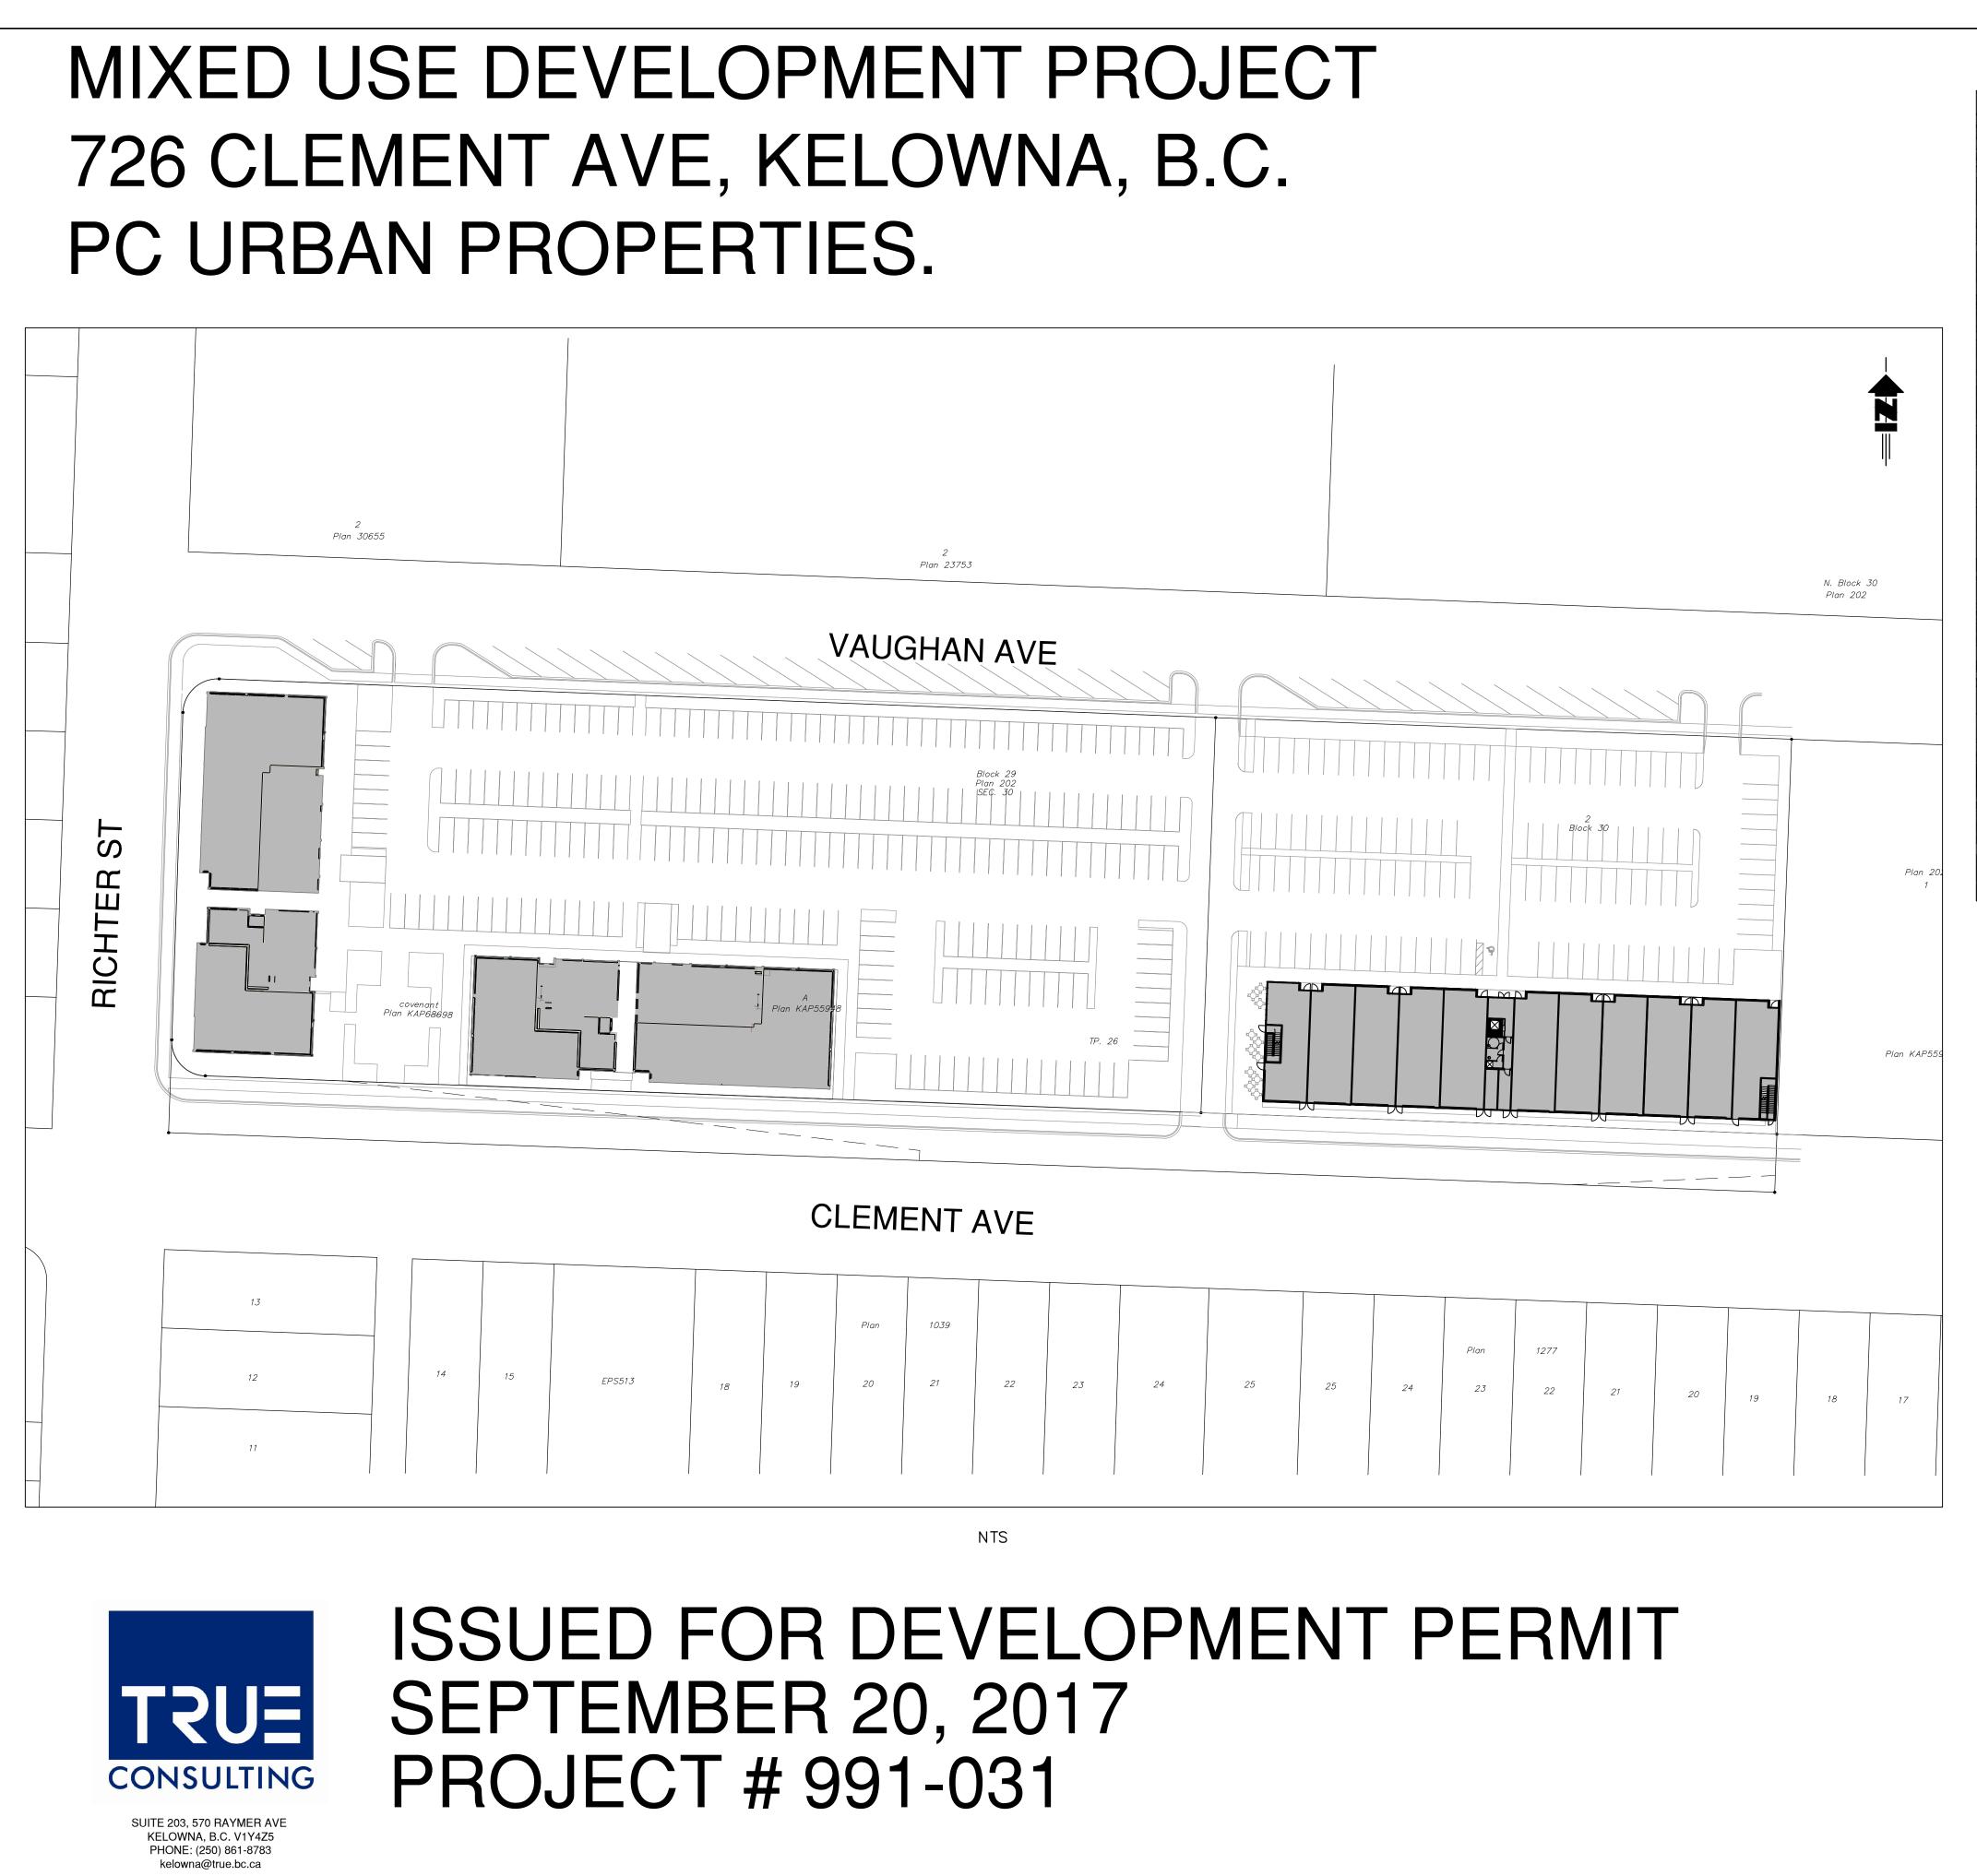

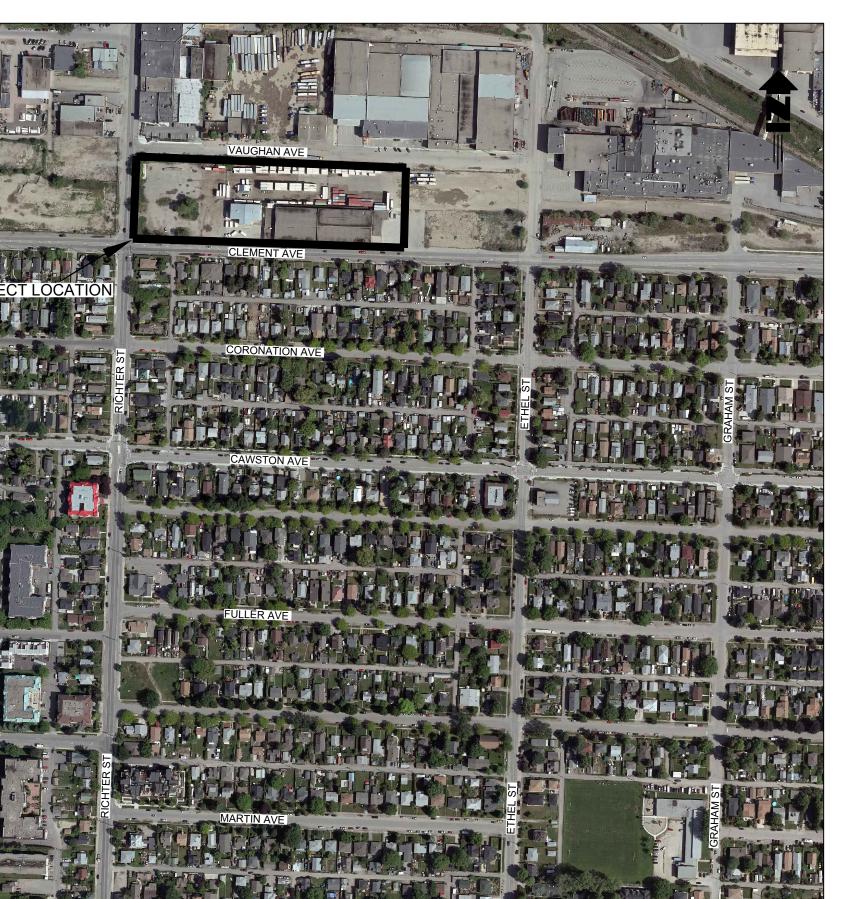LOCATION PLAN NTS

LIST OF DRAWINGS				
001	GENERAL NOTES			
002	LEGAL SURVEY PLAN			
003	TOPOGRAPHIC SURVEY PLAN			
004	ARCHITECTURAL SITE PLAN			
005	SITE REMOVALS PLAN			
006	EROSION & SEDIMENT CONTROL PLAN			
007	GRADING PLAN 1			
008	GRADING PLAN 2			
009	GRADING PLAN - OFFSITE CROSS SECTIONS			
010	SERVICING PLAN 1			
011	SERVICING PLAN 2			
012	STORMWATER MANAGEMENT PLAN			
013	DETAILS			

20

A. GENERAL NOTES:

1) ALL WORK SHALL BE CARRIED OUT IN ACCORDANCE WITH BC WORKERS COMPENSATION (OCCUPATIONAL HEALTH AND SAFETY) AMENDMENT ACT (BC REGS 296/97, 185/99, 253/2001). 2)ALL WORK AND MATERIALS SHALL CONFORM WITH CURRENT MMCD AND CITY OF KELOWNA SPECIFICATIONS. 3)THE CONTRACTOR IS ADVISED THAT BUILDING CONSTRUCTION WORKS BY OTHERS WILL BE ONGOING DURING THE PERIOD OF THIS CONTRACT. THE CONTRACTOR SHALL COORDINATE CONSTRUCTION ACTIVITIES WITH

OTHER CONTRACTORS AND PREVENT CONSTRUCTION CONFLICTS. 4) INFORMATION SHOWN ON THESE PLANS REGARDING LOCATION AND/OR SIZE OF EXISTING UTILITIES OR SERVICES HAS BEEN PROVIDED BY OTHERS. THE CONTRACTOR IS RESPONSIBLE FOR LOCATING AND PROTECTING ALL UTILITIES PRIOR TO COMMENCING WORK. ALL EXISTING UTILITIES MUST BE LOCATED AND VERIFIED FOR SIZE, DEPTH, ELEVATION, ETC. BY BC ONE CALL PRIOR TO COMMENCEMENT OF WORK. ANY VARIANCE FROM THESE PLANS IS TO BE IMMEDIATELY REPORTED TO THE ENGINEER. LOST TIME AND/OR RELATED COSTS FOR ADDITIONAL MATERIALS OR LABOUR DUE TO THE FAILURE OF THE CONTRACTOR TO CONFIRM UTILITY LOCATIONS AND NOTIFY THE ENGINEER OF VARIANCES PRIOR TO CONSTRUCTION WILL BE AT THE CONTRACTOR'S EXPENSE.

5) MATERIAL SUBSTITUTIONS PROPOSED BY CONTRACTOR MUST BE SUBMITTED TO THE ENGINEER, WHO WILL REVIEW AND SEEK REQUISITE REGULATORY AGENCY APPROVALS. NO SUBSTITUTIONS SHALL BE DEEMED AS ACCEPTED BY THE OWNER UNTIL WRITTEN APPROVALS ARE PROVIDED BY THE ENGINEER. 6) LASER ALIGNMENT CONTROL TO BE UTILIZED ON ALL SEWER INSTALLATIONS.

7)BEDDING OF ALL SEWERS SHALL BE PER CITY OF KELOWNA STANDARDS, UNLESS NOTED OTHERWISE. 8) PROJECT GEOTECHNICAL REPORT-INTERIOR TESTING SERVICES LTD., DATED NOV 25, 2016 (JOB 16.260)

## B. SITE PREPARATION WORKS

1) EROSION AND SEDIMENT CONTROL WORKS TO BE INSTALLED PRIOR TO COMMENCING OTHER WORKS. 2) GRADING TOLERANCE SHALL BE  $\pm 25$  mm of design.

3) ALL TOPSOIL AND UNSUITABLE FILL MATERIALS WITHIN PROJECT AREA SHALL BE STRIPPED AND EXPORTED TO BACK OF SITE PRIOR TO SUBGRADE CONSTRUCTION UNLESS OTHERWISE NOTED FOR ON-SITE STOCKPILING BY ENGINEER. GEOTECHNICAL REPORT NOTES VARIABLE STRIPPING DEPTHS; DEPTH OF STRIPPING SHALL BE PER GEOTECHNICAL ENGINEER'S DIRECTION DURING CONSTRUCTION. 4) FILL MATERIALS TO BE PLACED IN MAXIMUM 300mm LIFT THICKNESSES. FILLS ARE SUBJECT TO

COMPACTION TESTING PER GEOTECHNICAL REPORT RECOMMENDATIONS. 5)FOR DETAILS RE: BUILDING PAD PREPARATION REQUIREMENTS, REFER TO ARCHITECTURAL AND STRUCTURAL

DESIGN DRAWINGS. 6)FILL MATERIALS REQUIRE APPROVALS FROM GEOTECHNICAL ENGINEER PRIOR TO IMPORTING TO SITE.

STORM SEWER NOTES:

1) CATCHBASINS TO BE AS PER CITY OF KELOWNA STANDARD DWG SS-S11A AND SS-S11C. DRYWELLS TO BE PER CITY OF KELOWNA STANDARD DWGS SS-S51 AND SS-S52.

2) STORM SEWER (INCLUDING CATCHBASIN LEADS) SHALL BE PVC CONFORMING TO ASTM F794 UNLESS OTHERWISE NOTED.

3)ALL STORM SEWERS SHALL HAVE RUBBER GASKETED JOINTS.

4) ALL MANHOLE AND CATCHBASIN EXCAVATIONS TO BE BACKFILLED WITH GRANULAR MATERIAL COMPACTED TO 98% SPD.

5)"MODULOC" OR EQUIVALENT PRE-CAST MANHOLE AND CATCHBASIN ADJUSTERS TO BE USED IN LIEU OF BRICKING. ADJUSTING UNITS TO BE PARGED ON OUTSIDE ONLY.

6) ALL SINGLE CATCHBASIN LEADS TO BE 150mm DIA. ALL DOUBLE CATCHBASIN LEADS TO BE 200MM DIA. 7)BUILDING SERVICES TO BE TERMINATED 1.0m FROM OUTSIDE FACE OF BUILDING C/W 2"x4" STAKE PAINTED GREEN.

8) CONTRACTOR TO PROVIDE CCTV CAMERA INSPECTIONS OF ALL STORM AND SANITARY SEWERS INCL. PICTORIAL REPORT AND TWO (2) DVD COPIES. ALL SEWERS TO BE FLUSHED PRIOR TO CAMERA INSPECTION.

9)DE-WATERING MEASURES TO BE INCLUDED IN BID PRICE (IF/AS REQUIRED).

10)ALL MANHOLES AND CATCHBASINS TO BE PARGED.

D. SANITARY SEWER NOTES:

1) SANITARY SEWERS SHALL BE DR35 PVC PIPE UNLESS OTHERWISE NOTED.


2) SANITARY MANHOLES TO BE AS PER MMCD STANDARD DWGS S1 THROUGH S4.

3)CONTRACTOR SHALL BE RESPONSIBLE FOR PRESSURE TESTING OF ALL SANITARY SEWER MAINS AND SERVICES, SUCH TESTING TO BE COORDINATED WITH AND WITNESSED BY THE ENGINEER. 4) CONTRACTOR TO NOTIFY ENGINEER A MINIMUM OF 72 HOURS PRIOR TO PRESSURE TESTING AND VIDEO INSPECTION OF SANITARY SEWER SYSTEM.


5)BUILDING SERVICES TO BE TERMINATED 1.0m FROM OUTSIDE FACE OF BUILDING C/W 2"x4" MARKER STAKE PAINTED RED.

6)DE-WATERING MEASURES TO BE INCLUDED IN BID PRICE (IF/AS REQUIRED).

E. WATERMAIN NOTES: 1)WATERMAIN AND FITTINGS TO BE PVC C900, CLASS 150 WITH GASKETED JOINTS UNLESS NOTED OTHERWISE C/W AWG SOLID COPPER TRACKING WIRE. 2)WATER SERVICE CONNECTIONS TO BE AS PER CITY OF KELOWNA STANDARD DWGS SS-W2. 3)A MINIMUM HORIZONTAL SEPARATION OF 3.0m AND A MINIMUM VERTICAL SEPARATION OF 0.30m BETWEEN WATERMAINS AND SANITARY SEWERS MUST BE MAINTAINED IF WATERMAIN ABOVE SEWER, OR 0.50m VERTICAL SEPARATION IF WATERMAIN BELOW SEWER. 4) WATERMAIN BEDDING TO BE SUITABLE GRANULAR BEDDING MATERIAL AS PER CITY OF KELOWNA STANDARD DWG SS-G4. 5)ALL HYDRANTS SHALL BE AS PER CITY OF KELOWNA STANDARD DWG SS-W4. CONTRACTOR TO ORIENT HYDRANT AS DIRECTED BY THE FIRE DEPARTMENT. CONTRACTOR TO OBTAIN WRITTEN DIRECTION FROM THE FIRE DEPARTMENT AND PROVIDE COPY TO THE ENGINEER PRIOR TO REQUESTING CERTIFICATION OF SUBSTANTIAL COMPLETION. 6) ALL VALVES SHALL OPEN LEFT (COUNTER CLOCKWISE). ALL VALVE BOXES SHALL BE AS PER MMCD STANDARD DWG W3. 7)ALL HYDRANT FLANGE ELEVATIONS TO BE SET 0.15m ABOVE FINISHED GRADE; TOLERANCE= <u>+</u> 50mm. 8)THRUST BLOCKS TO BE CONSTRUCTED PER MMCD STANDARD DWG W1. 9) MINIMUM DEPTH OF COVER FOR ALL WATERMAINS SHALL BE 1.50m PER CITY OF KELOWNA SPECIFICATIONS. 10)BUILDING SERVICES TO BE TERMINATED 1.0m FROM OUTSIDE FACE OF BUILDING C/W 2"x4" MARKER STAKE PAINTED BLUE. 11)DE-WATERING MEASURES TO BE INCLUDED IN BID PRICE (IF/AS REQUIRED). 12) SINGLE WATER METER FOR SITE'S PROVIDED IN EXISTING VAULT AT NORTHEAST CORNER OF SITE F. <u>SURFACE WORKS:</u> 1)LIGHT DUTY PAVEMENT STRUCTURE TO BE CONSTRUCTED AS FOLLOWS: 50mm HOT MIX ASPHALT 100mm-BASE (19mm CRUSHED GRANULAR BASE) 250mm-75mm MANUFACTURED SUBBASE APPROVED SUBGRADE, MIN CBR OF 5 (PROOF ROLL REQUIRED TO BE WITNESSED BY GEOTECHNICAL ENGINEER; CONTRACTOR SHALL PROVIDE A MINIMUM 48 HOURS ADVANCE NOTICE TO ENGINEER)

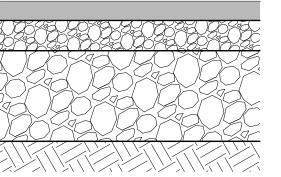

2) HEAVEY DUTY PAVEMENT STRUCTURE TO BE CONSTRUCTED AS FOLLOWS:

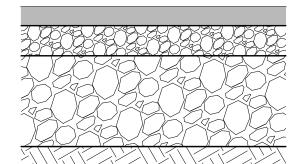

75–100mm HOT MIX ASPHALT 100mm-BASE

(19mm CRUSHED GRANULAR BASE)

250mm-75mm MANUFACTURED SUBBASE

APPROVED SUBGRADE, MIN CBR OF 5 (PROOF ROLL REQUIRED TO BE WITNESSED BY GEOTECHNICAL ENGINEER; CONTRACTOR SHALL PROVIDE A MINIMUM 48 HOURS ADVANCE NOTICE TO ENGINEER)

3) MAXIMUM SLOPE = 2(H):1(V) UNLESS NOTED OTHERWISE.

4) ON-SITE CURB TO BE EXTRUDED CONCRETE PER DETAIL SHOWN ON DRAWING 009. 5)ALL MANHOLE LIDS, CATCHBASIN GRATES, VALVE BOX COVERS, ETC. SHALL BE SET FLUSH WITH FINISHED ASPHALT.


6)FOR LANDSCAPE AND IRRIGATION DESIGNS REFER TO LANDSCAPE ARCHITECTS DRAWINGS

G. OFF SITE WORKS: (NONE ANTICIPATED AT THIS TIME)

1)CONTRACTOR SHALL COORDINATE ALL WORKS OUTSIDE OF PRIVATE PROPERTY WITH THE CITY OF KELOWNA AND OBTAIN ALL NECESSARY PERMITS.

2)CONTRACTOR TO PROVIDE ENGINEER WITH MINIMUM 72 HOURS ADVANCE NOTICE PRIOR TO COMMENCING ANY WORKS WITHIN CITY OF KELOWNA ROAD RIGHT OF WAY.




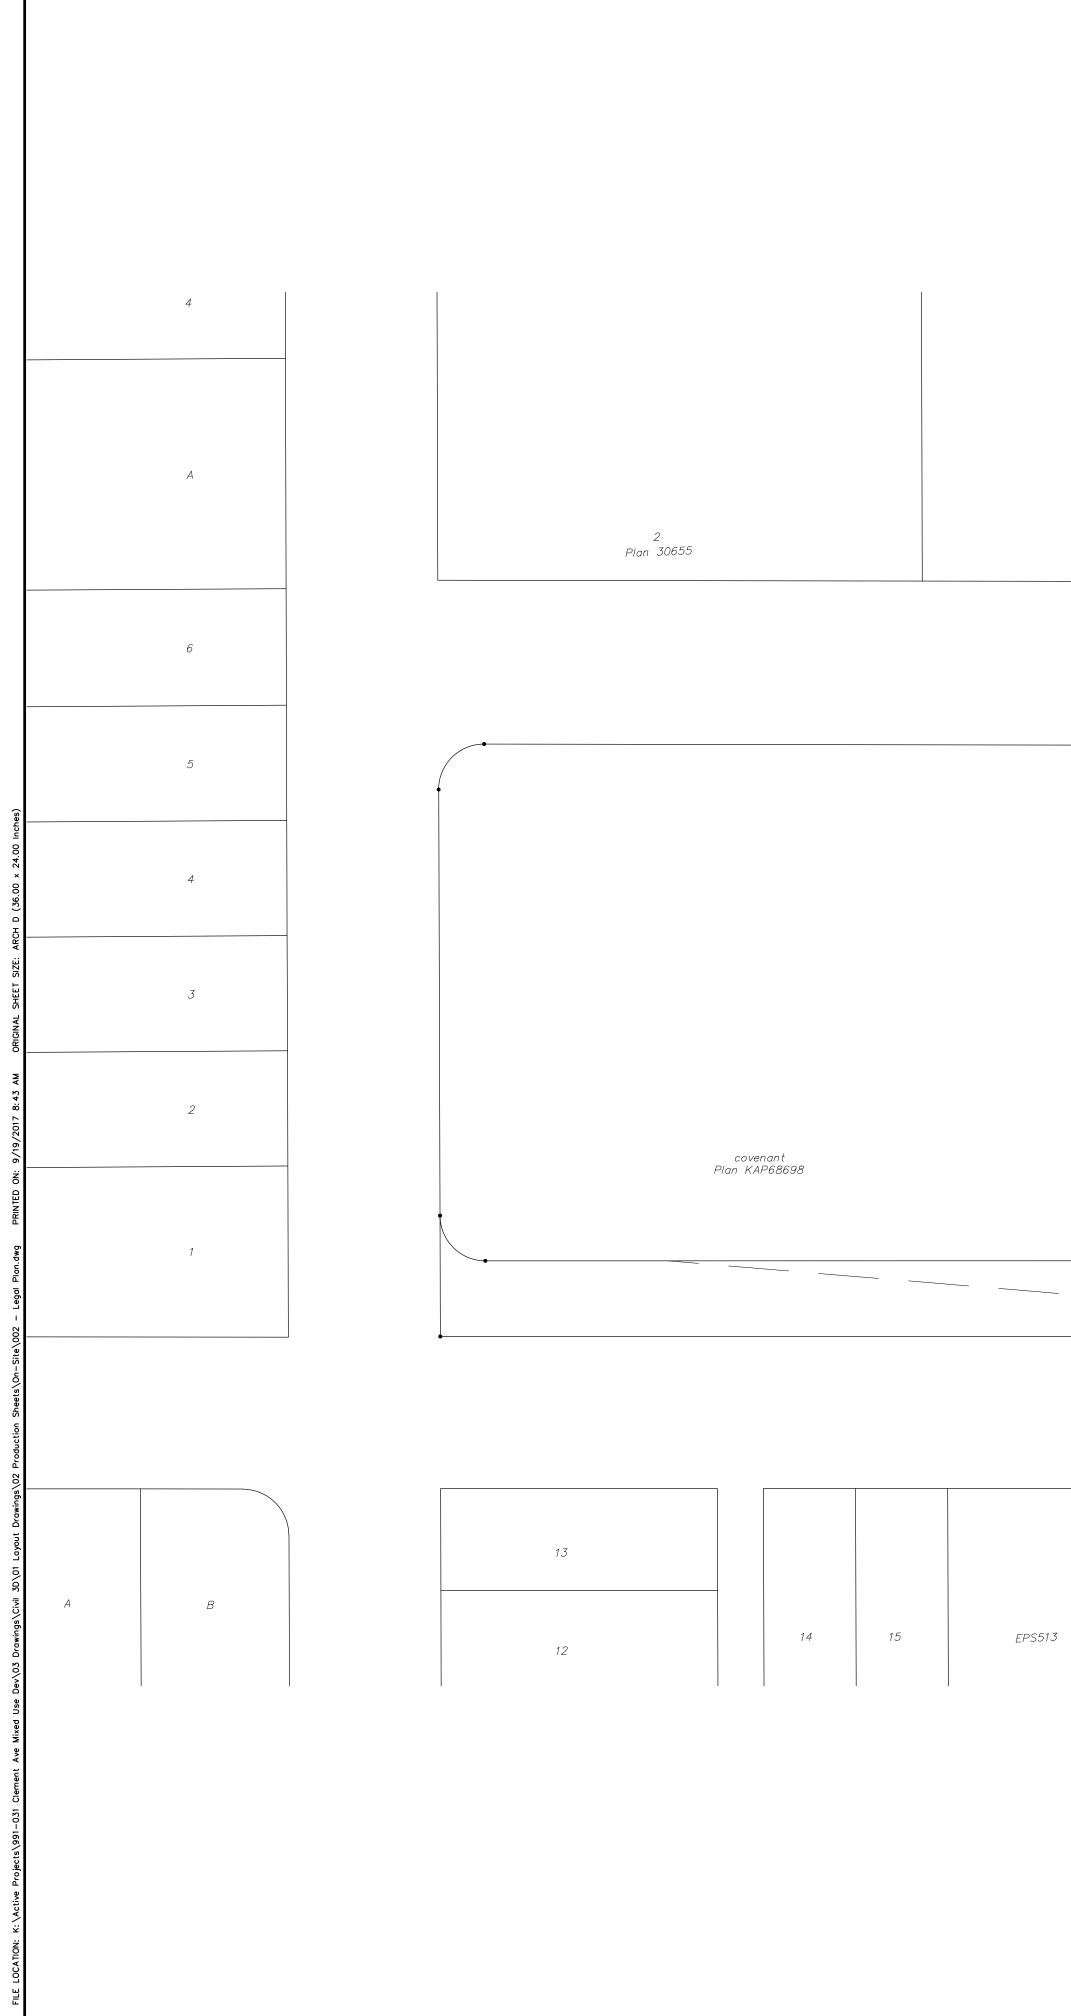


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			LEGEND
	2 Pian 23753	Nr. Black 33           Pport 202	NOTE: LEGAL SURVEY INFORMATION SHOWN THIS PLAN SURVEYED AND CONSOLIDATED BY VECTOR LAND SURVEYING LTD. PROVIDED TO TRUE ON JULY 19, 2017.
	Block 29 Plan 202 SEC. 30	Block 30 Plan 202 1	ISSUED FOR SEPTEMBER 20, 2017 DEVELOPMENT PERMIT
	А Plan КАР55948 ТР. 26	B Plan KAP55948	<b>TRUE</b> CONSULTING
			• Property re-imagined CLEMENT AVE MIXED USE DEVELOPMENT
3 18	Plan 1039 19 20 21 22 23 24	25 25 24 23 22 21 20 19 18 17 16	LEGAL PLAN
			SCALE       1:500         DESIGN BY       DM         DRAWN BY       AP         DATE       DECEMBER 2016         PROJECT No.       991-031         ACAD FILE       SHEET         DRAWING No.       SHEET         991-031-0002       REVISION         2       2

				LEGEND
	2 Plan 23753		N. Block 30           Plan 202	NOTE: LEGAL SURVEY INFORMATION SHOWN THIS PLAN SURVEYED AND CONSOLIDATED BY VECTOR LAND SURVEYING LTD. PROVIDED TO TRUE ON JULY 19, 2017.
	Block 29 Plan 202 SEC. 30	Block 30	Plan 202 1	ISSUED FOR SEPTEMBER 20, 2017 DEVELOPMENT PERMIT
	A Plan KAP55948 TP. 26	В	Plan KAP55948	TRUE CONSULTING
				* PCUIDAD property re-imagined CLEMENT AVE MIXED USE DEVELOPMENT
18	Plan     1039       19     20       21     22       23     24	25     25     24     23     22     21     20     19	18 17 16	LEGAL PLAN
				SCALE1:500DESIGN BYDMDRAWN BYAPDATEDECEMBER 2016PROJECT No.991-031ACAD FILEPRAWING No.DRAWING No.SHEET2OF 13P991-031-0002REVISION2

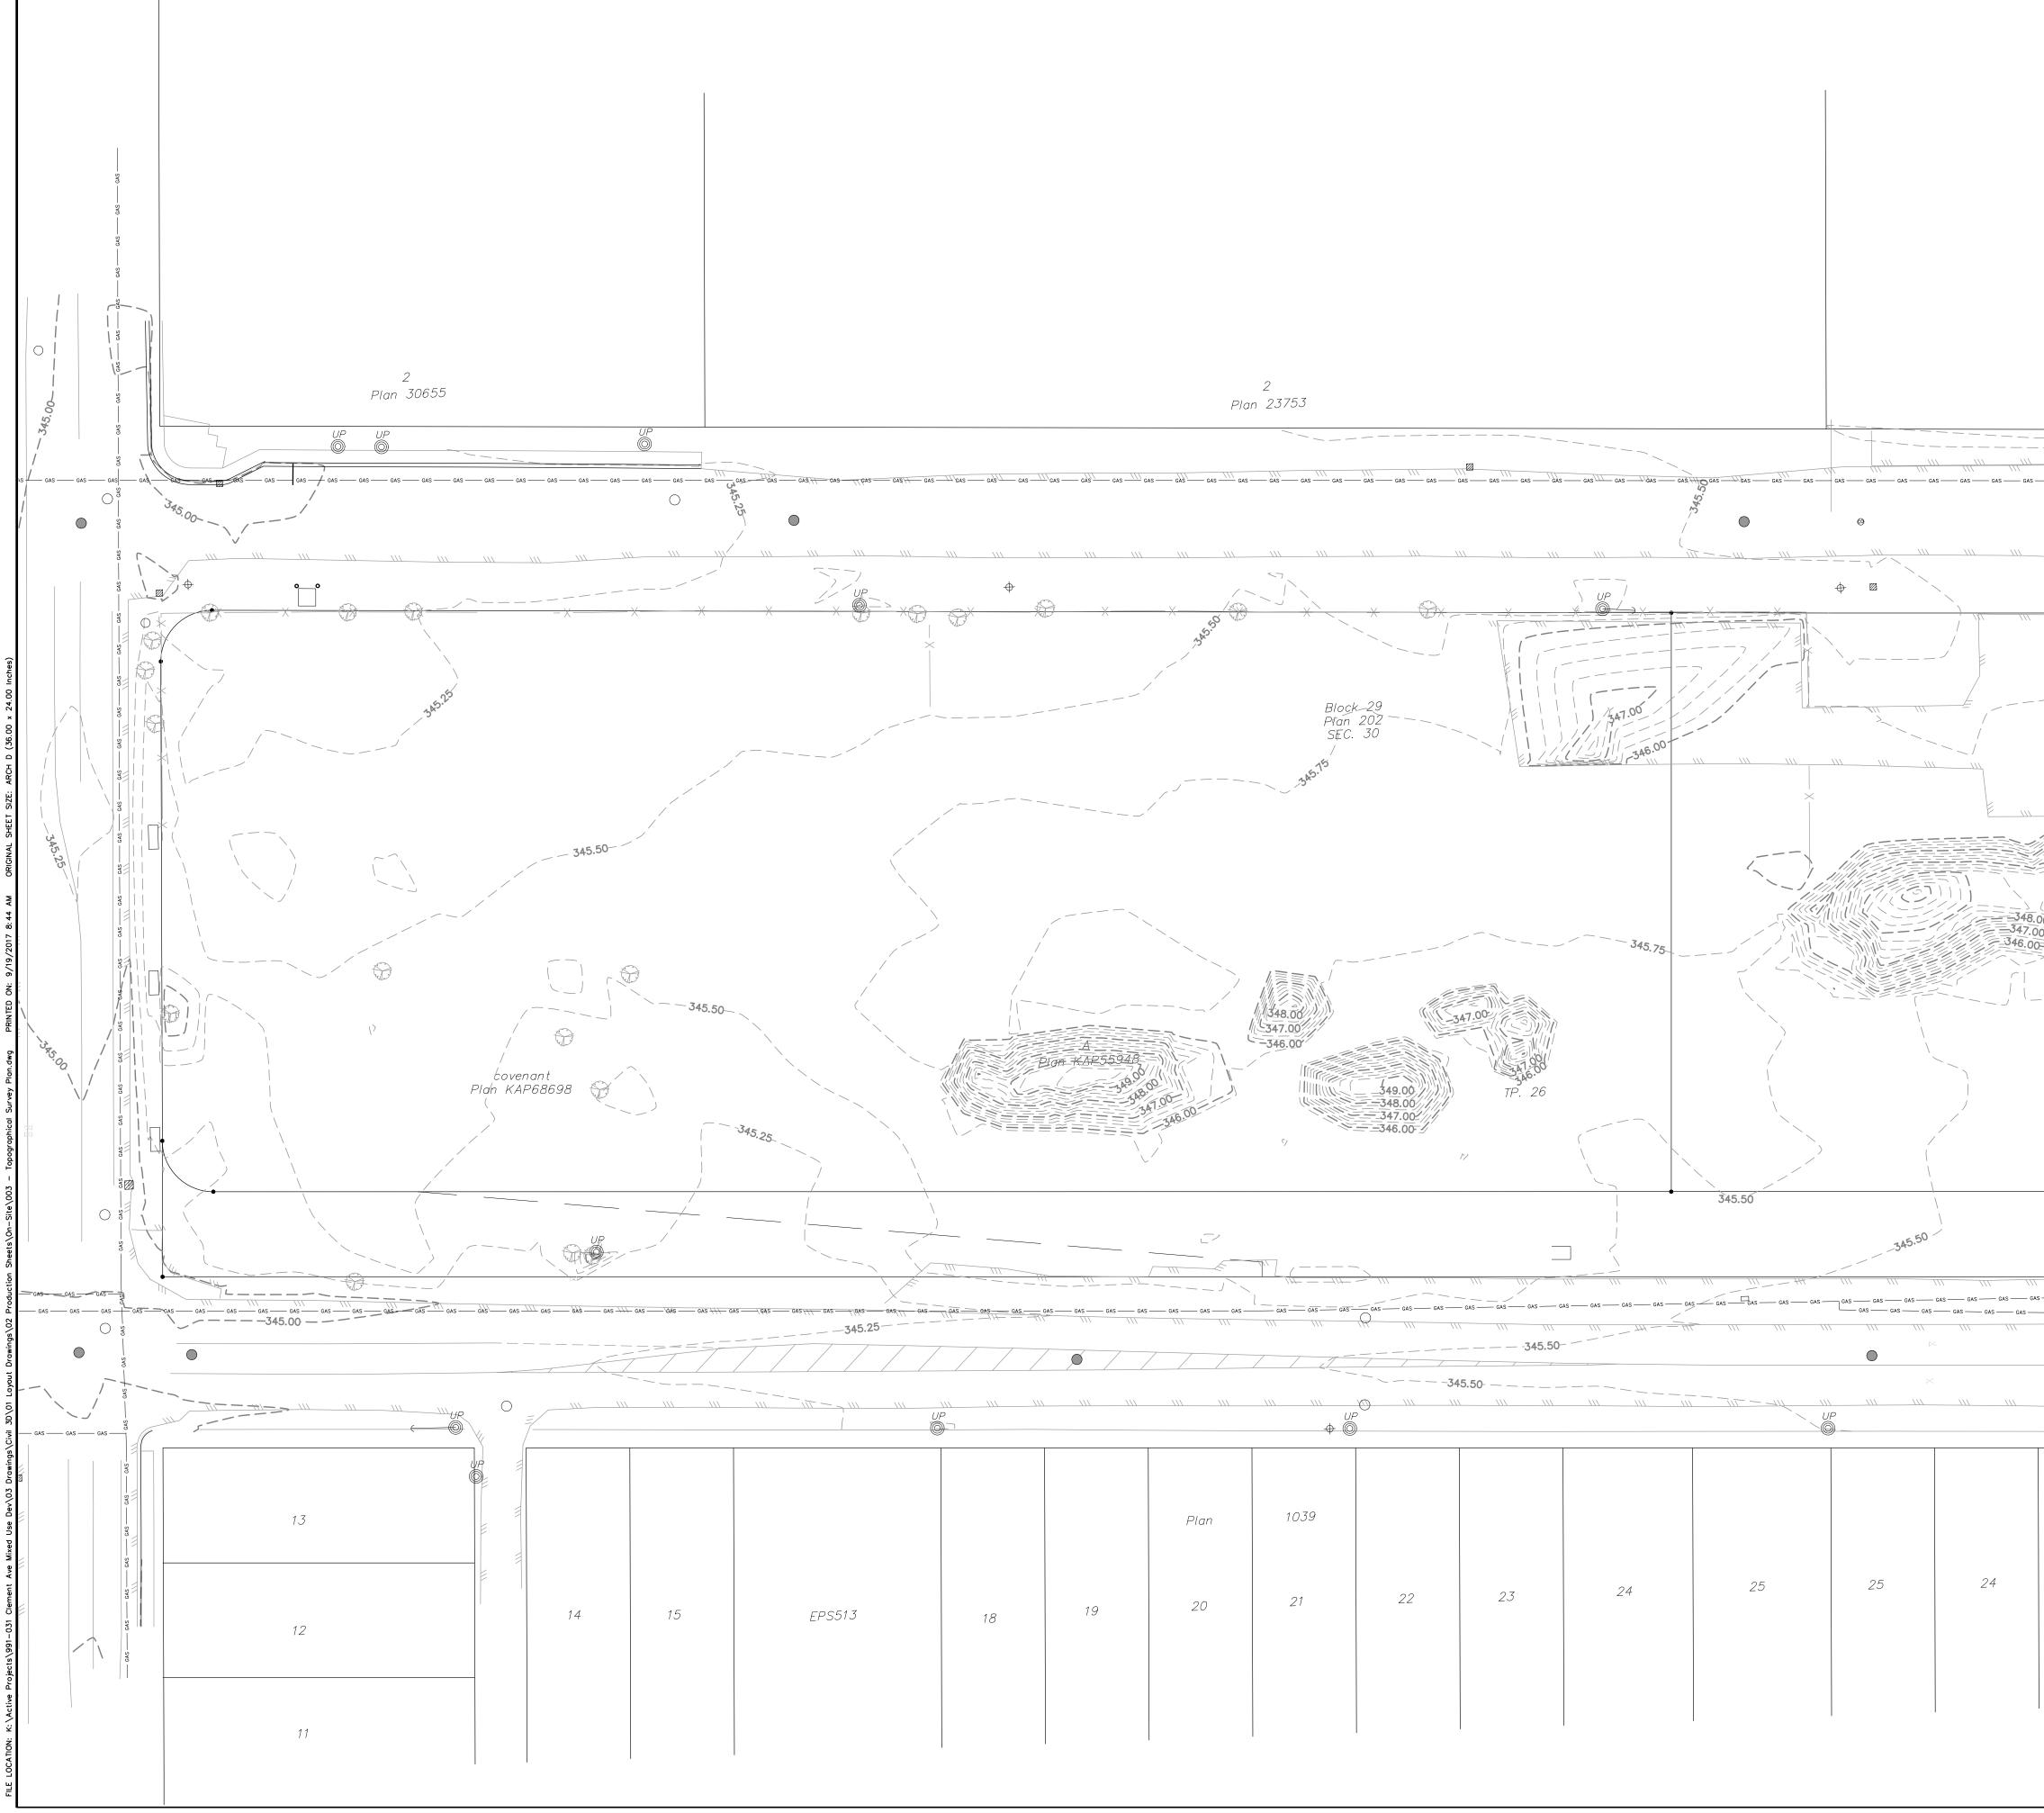


					NOTE: TOPOGRAPH PLAN SURV	EXISTING TREE EXISTING TREE L EXISTING TREE L ORIGINAL GROUN EXISTING CATCH EXISTING MANHO EXISTING FENCE	D CONTOURS BASIN LE POLE STANDARD
AS GAS GAS GAS		- CAS CAS CAS CAS CAS CAS CAS CAS (AS CAS (AS CAS (AS (AS	(\\\ \\\\		2 SEPT 20/17 1 MAY 05/17 No. DATE	ISSUED FOR DEVELOPMENT PERMIT CLIENT REVIEW DESCRIPTION REVISIONS	AP DM AP DM BY APP'D
	2 Block 3	345.75 30 B				OR SEPTEMBER 2 LOPMENT PE	ERMIT
(\) \(\(\) \(\(\(\) GASGASGAS		5 - GAS - GA			C	property re-in	nagined VE
CAS					ТС	DPOGRAPHIC SURVEY PLAN	AL
Plan 23	1277 22	21	20	19	SCALE DESIGN BY DRAWN BY	<b>1:400</b>   АР	

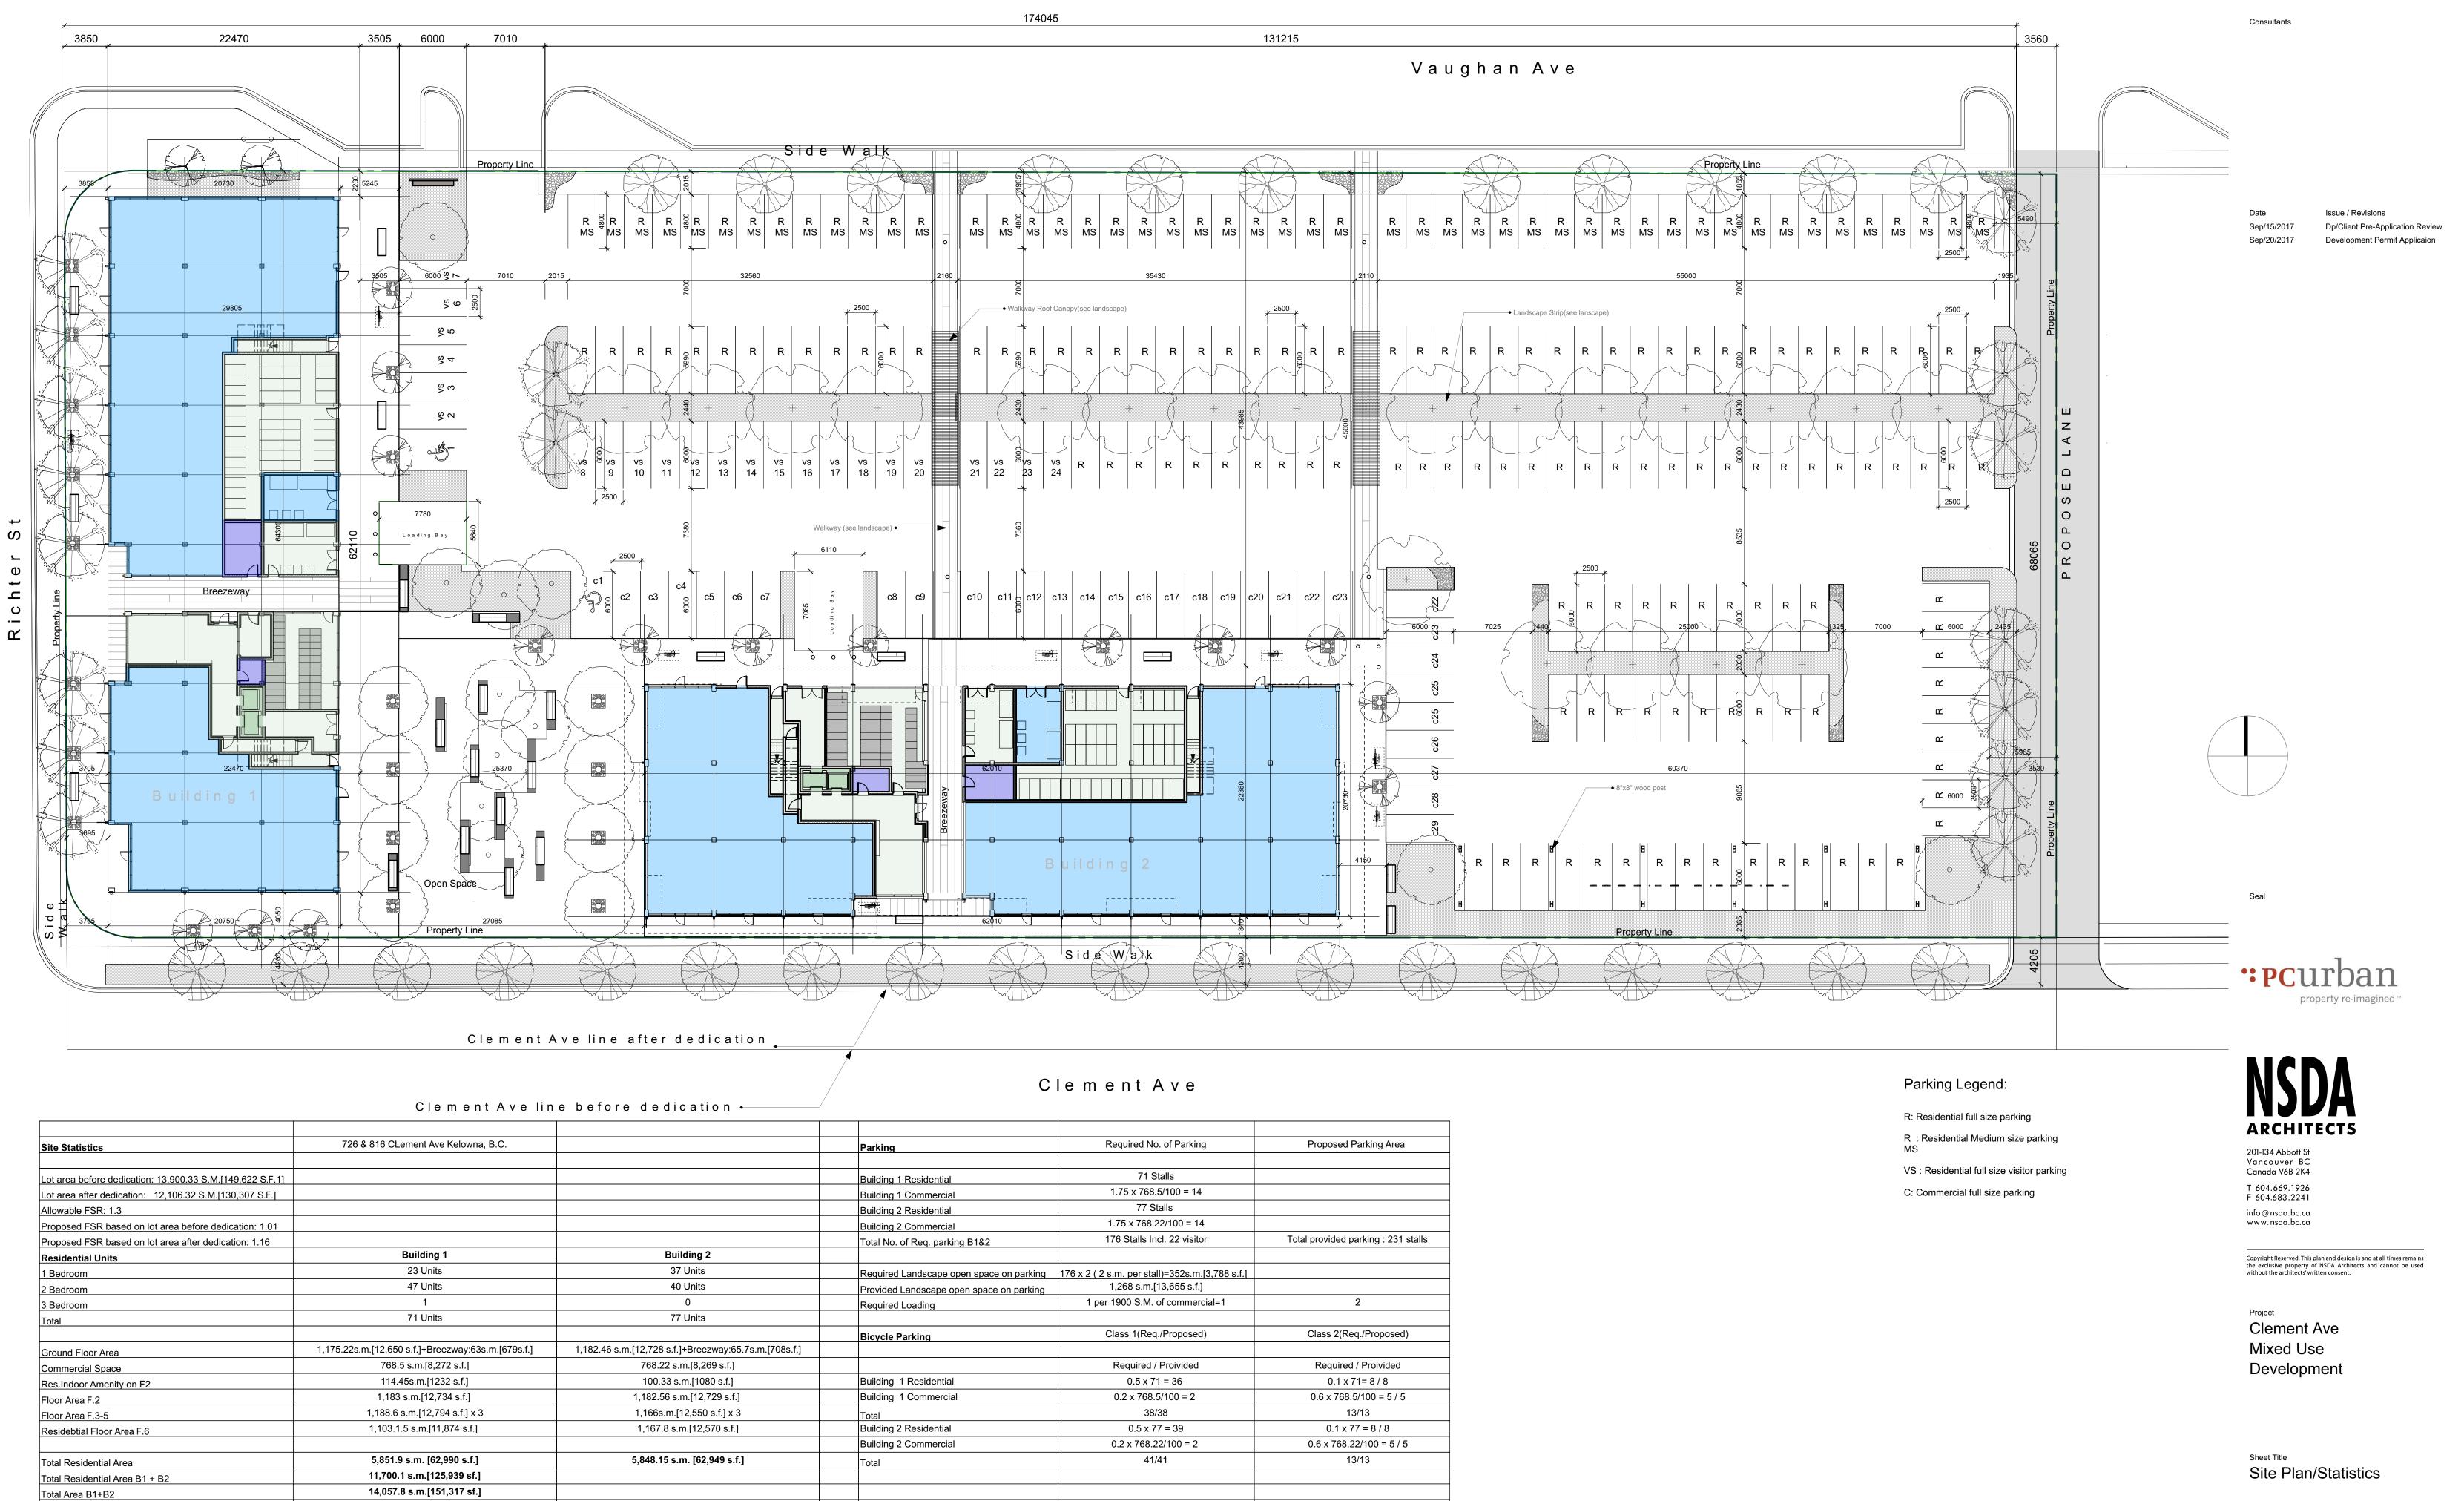

		-
Site Statistics	726 & 816 CLement Ave Kelowna, B.C.	
Lot area before dedication: 13,900.33 S.M.[149,622 S.F.1]		
Lot area after dedication: 12,106.32 S.M.[130,307 S.F.]		
Allowable FSR: 1.3		
Proposed FSR based on lot area before dedication: 1.01		
Proposed FSR based on lot area after dedication: 1.16		
Residential Units	Building 1	Building 2
1 Bedroom	23 Units	37 Units
2 Bedroom	47 Units	40 Units
3 Bedroom	1	0
Total	71 Units	77 Units
Ground Floor Area	1,175.22s.m.[12,650 s.f.]+Breezway:63s.m.[679s.f.]	1,182.46 s.m.[12,728 s.f.]+Breezway:65.7s.m.[708s.f.]
Commercial Space	768.5 s.m.[8,272 s.f.]	768.22 s.m.[8,269 s.f.]
Res.Indoor Amenity on F2	114.45s.m.[1232 s.f.]	100.33 s.m.[1080 s.f.]
Floor Area F.2	1,183 s.m.[12,734 s.f.]	1,182.56 s.m.[12,729 s.f.]
Floor Area F.3-5	1,188.6 s.m.[12,794 s.f.] x 3	1,166s.m.[12,550 s.f.] x 3
Residebtial Floor Area F.6	1,103.1.5 s.m.[11,874 s.f.]	1,167.8 s.m.[12,570 s.f.]
	5,851.9 s.m. [62,990 s.f.]	5,848.15 s.m. [62,949 s.f.]
Total Residential Area	11,700.1 s.m.[125,939 sf.]	0,040.10 3.111. [02,040 3.1.]
Total Residential Area B1 + B2		
Total Area B1+B2	14,057.8 s.m.[151,317 sf.]	
Private Open Space Area	Building 1	Building 2
Required	23(1BDR)x10+47(2BDR)x15=935 s.m.[10,064 s.f.]	37(1BDR)x10+40(2&3BDR)x15=970 s.m.[10,441 s.f.]
Provided 2nd Floor Deck	2nd F.Deck :386.2s.m.[4,157 s.f.]	2nd F.Deck :413.6 s.m.[4,452s.f.]
Provided Deck on Floor 3,4 & 5	135 s.m.[1,453 s.f.] x 3 = 405[4,359 s.f.]	126.06 s.m.[1,357 s.f.] x 3 = 378.2 s.m.[4,071 s.f.]
Floor 6	Decks:222 s.m.[2,389s.f.]	Decks:138 s.m.[1,485s.f.]
Total provided open space in building	1,013.2 s.m.[10,906 s.f.]	929.8 s.m.[10,008 s.f.]


arking	Required No. of Parking	Proposed Parking Area
uilding 1 Residential	71 Stalls	
uilding 1 Commercial	1.75 x 768.5/100 = 14	
uilding 2 Residential	77 Stalls	
	1.75 x 768.22/100 = 14	
uilding 2 Commercial otal No. of Req. parking B1&2	176 Stalls Incl. 22 visitor	Total provided parking : 231 stall
equired Landscape open space on parking	176 x 2 ( 2 s.m. per stall)=352s.m.[3,788 s.f.]	
rovided Landscape open space on parking	1,268 s.m.[13,655 s.f.]	
equired Loading	1 per 1900 S.M. of commercial=1	2
icycle Parking	Class 1(Req./Proposed)	Class 2(Req./Proposed)
	Required / Proivided	Required / Proivided
uilding 1 Residential	0.5 x 71 = 36	0.1 x 71= 8 / 8
uilding 1 Commercial	0.2 x 768.5/100 = 2	0.6 x 768.5/100 = 5 / 5
otal	38/38	13/13
uilding 2 Residential	0.5 x 77 = 39	0.1 x 77 = 8 / 8
uilding 2 Commercial	0.2 x 768.22/100 = 2	0.6 x 768.22/100 = 5 / 5
otal	41/41	13/13

Project Number 16049 Scale 1/250 Sheet Number A-002

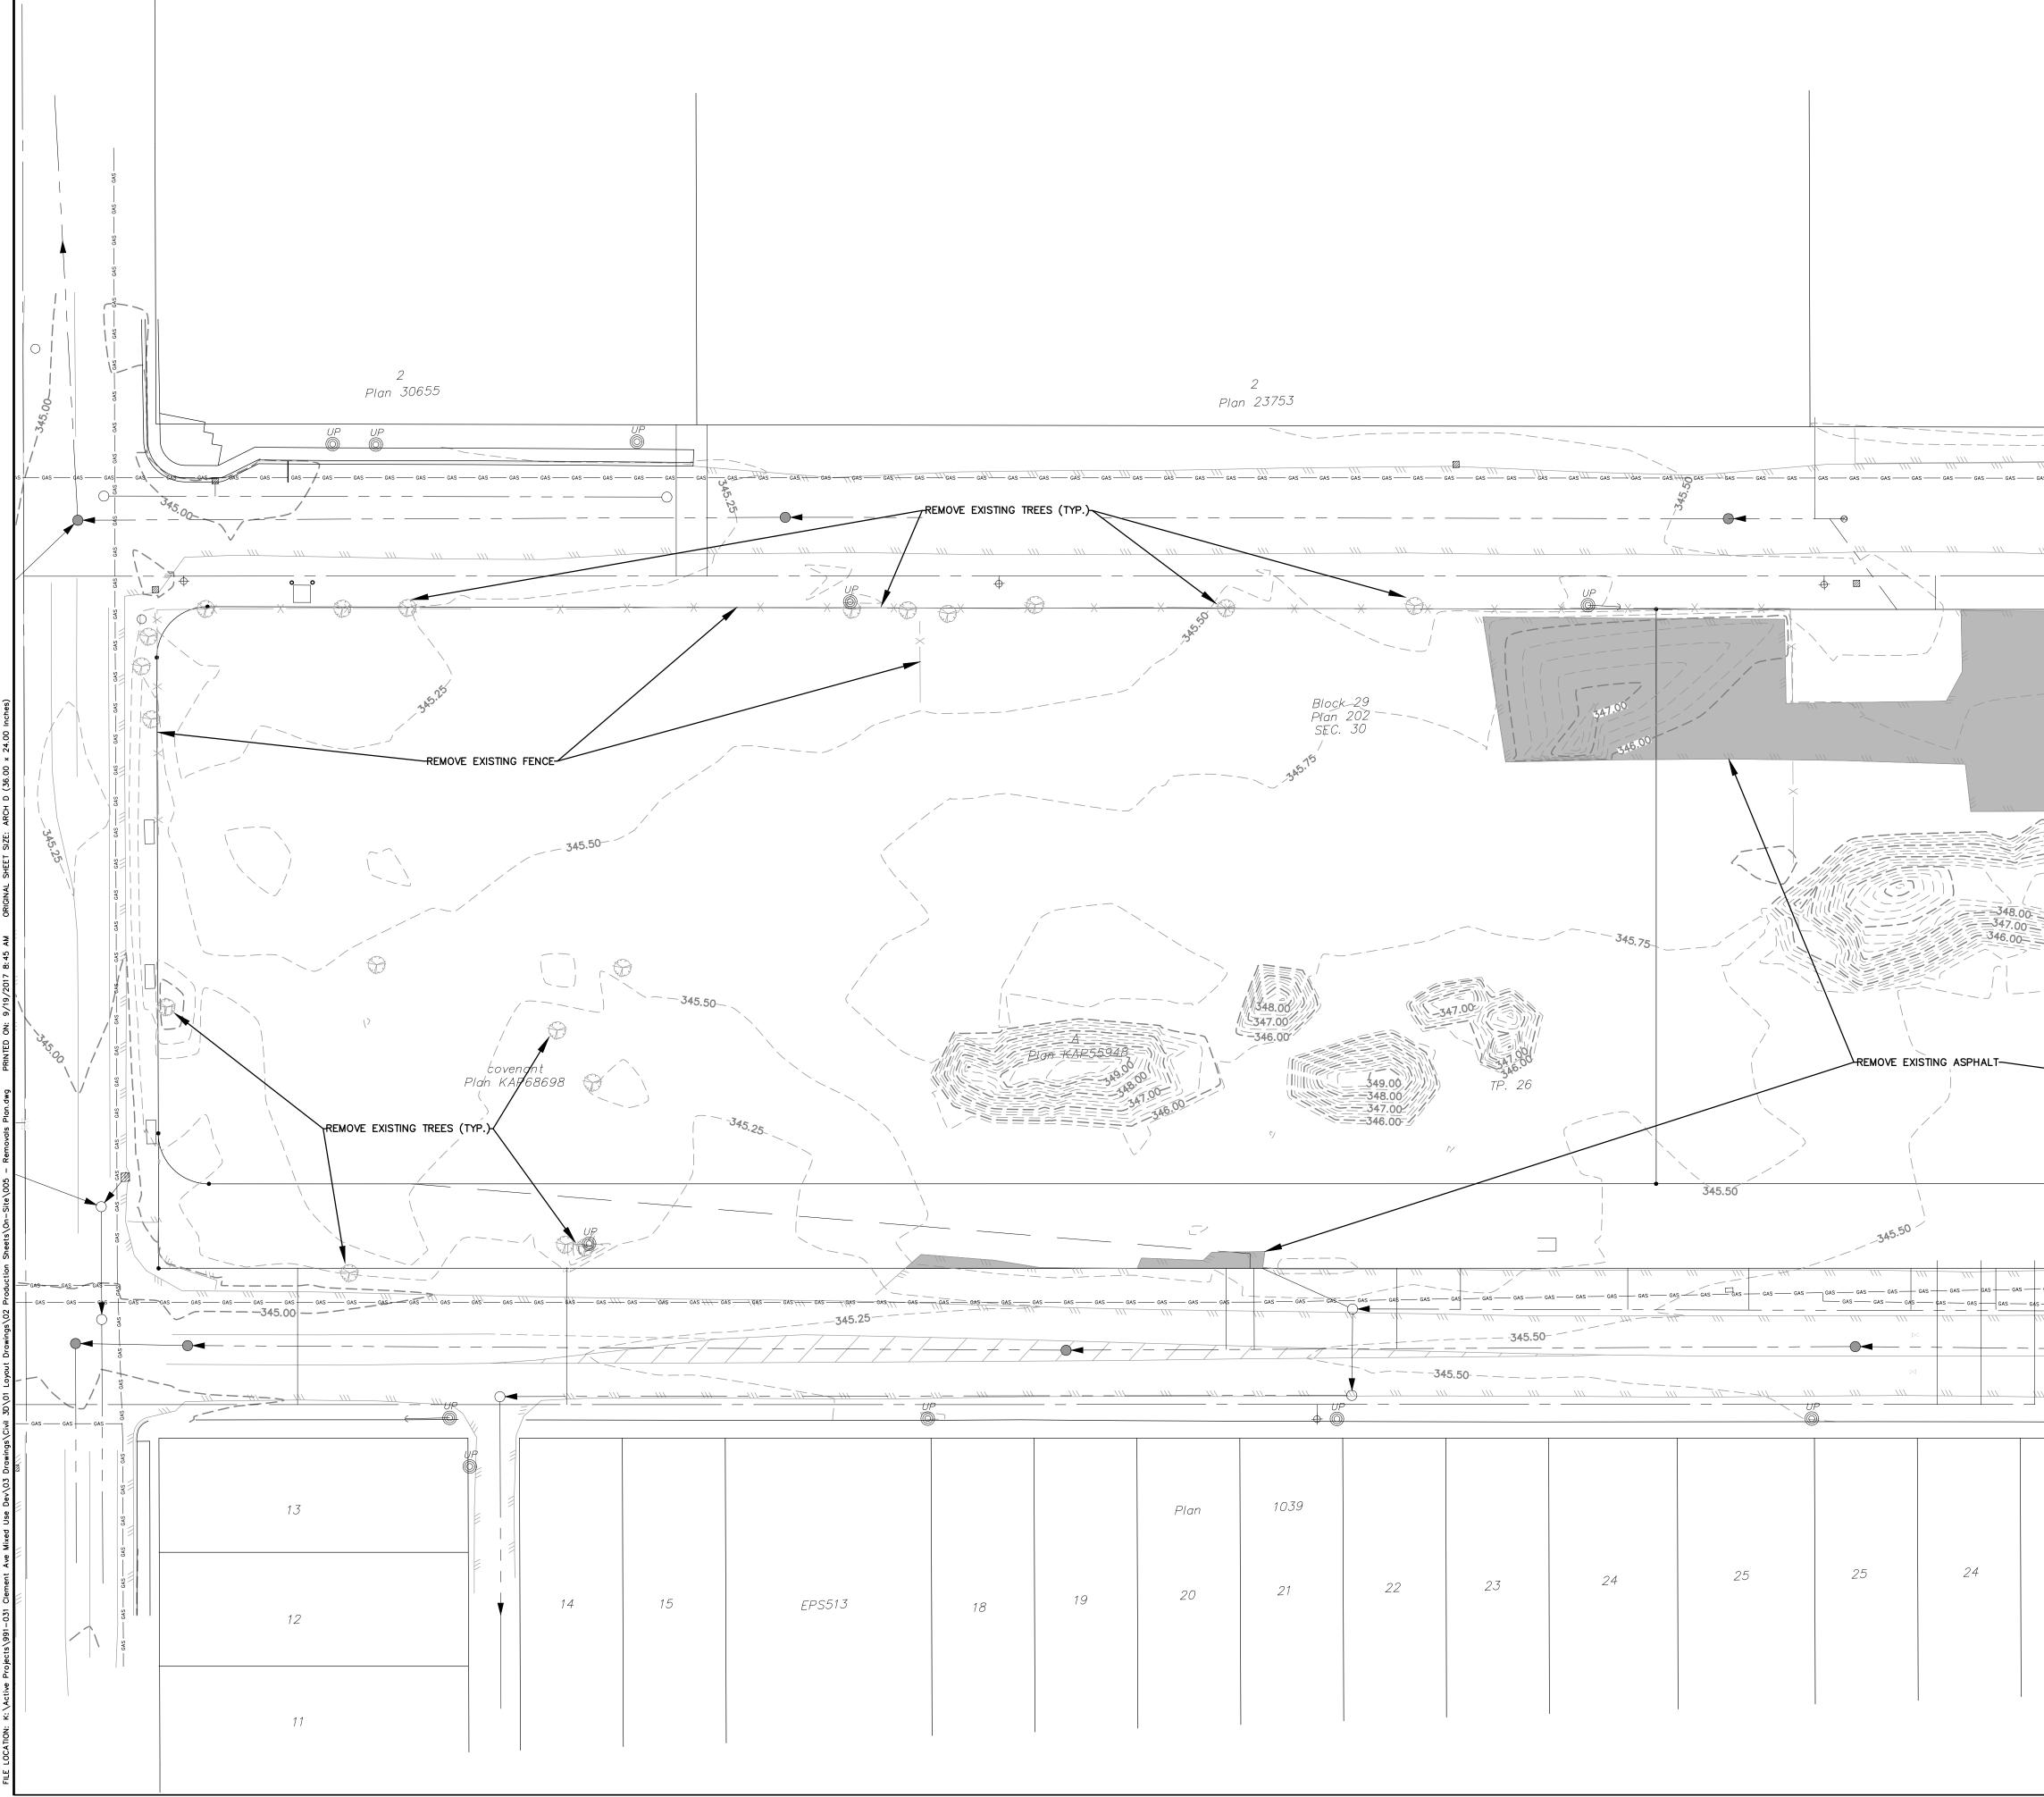






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GAS GAS GAS		GAS	GAS (\)		-         20/17           1         MAY 05/17           CLIENT REVIEW	AP DM AP DM BY APP'D
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Plan		345.75		0+020	REMOVALS PLAN	
23	22	21	20	19	SCALE     1:400       DESIGN BY     DM       DRAWN BY     AP       DATE     DECEMBER 2016       PROJECT No.     991-031       ACAD FILE     ORAWING NO.       991-031-0005     SHEET       5     O       REVISIC     2	ON 13

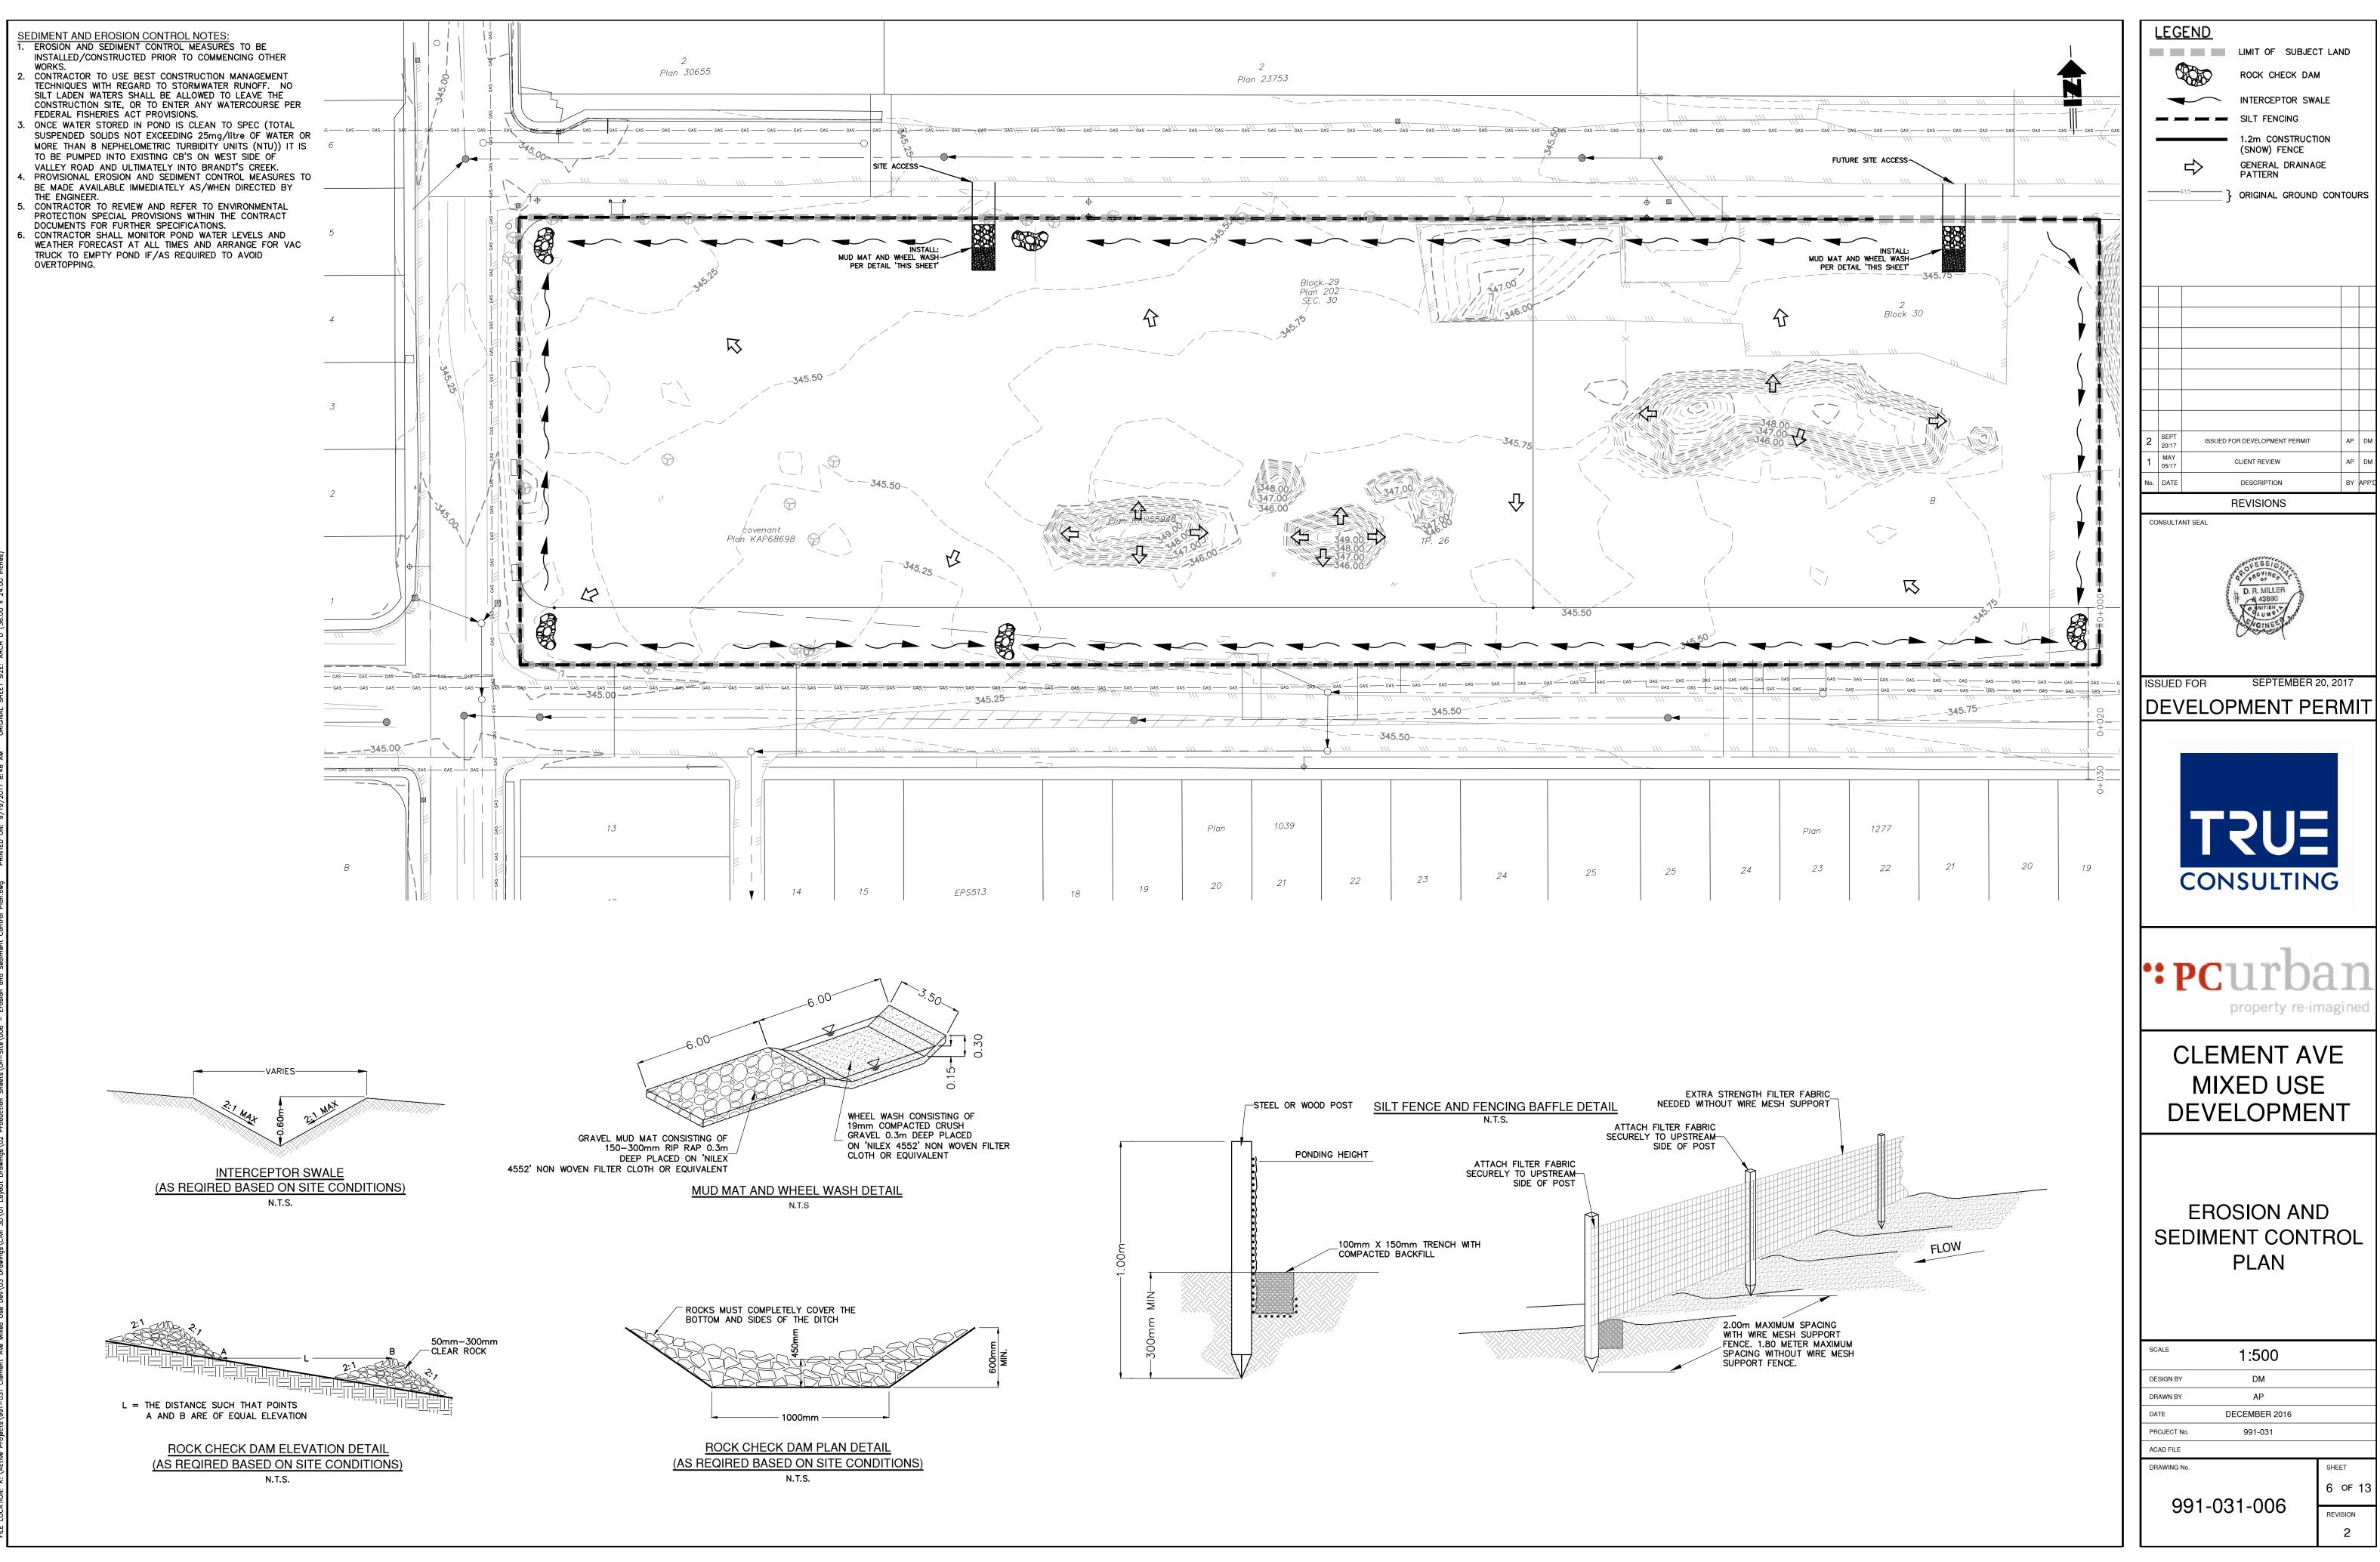





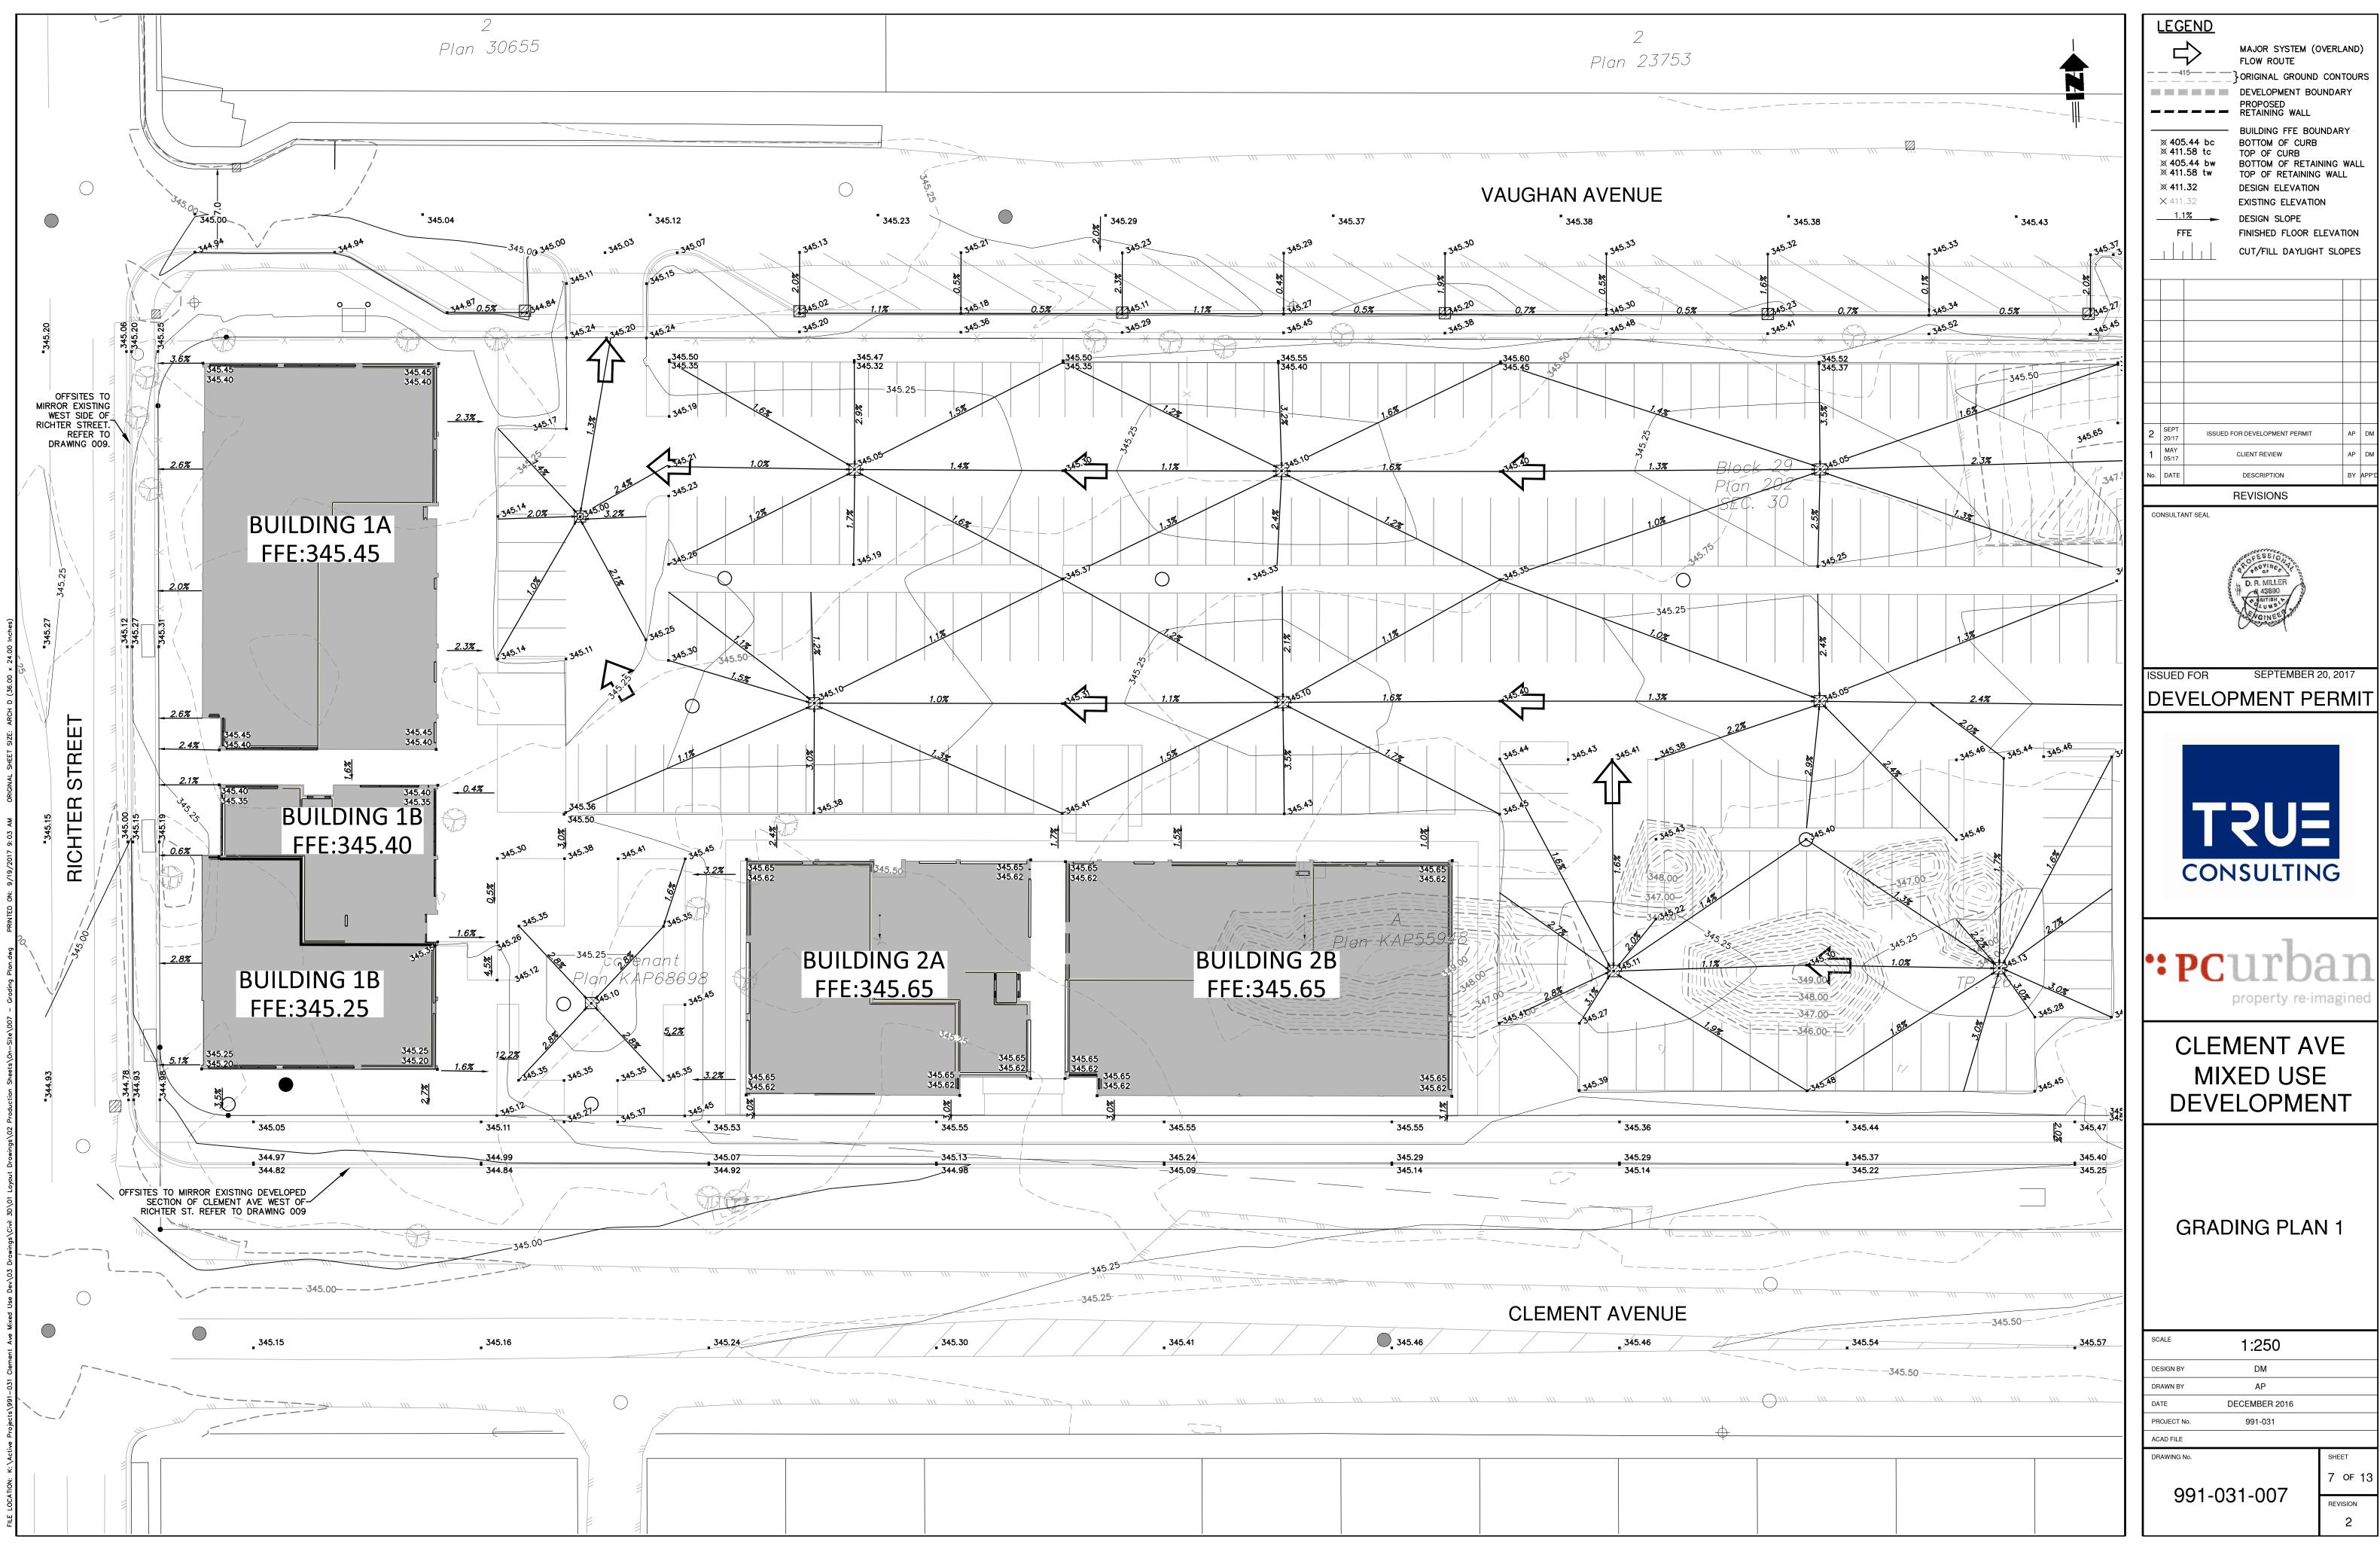


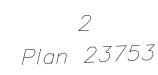


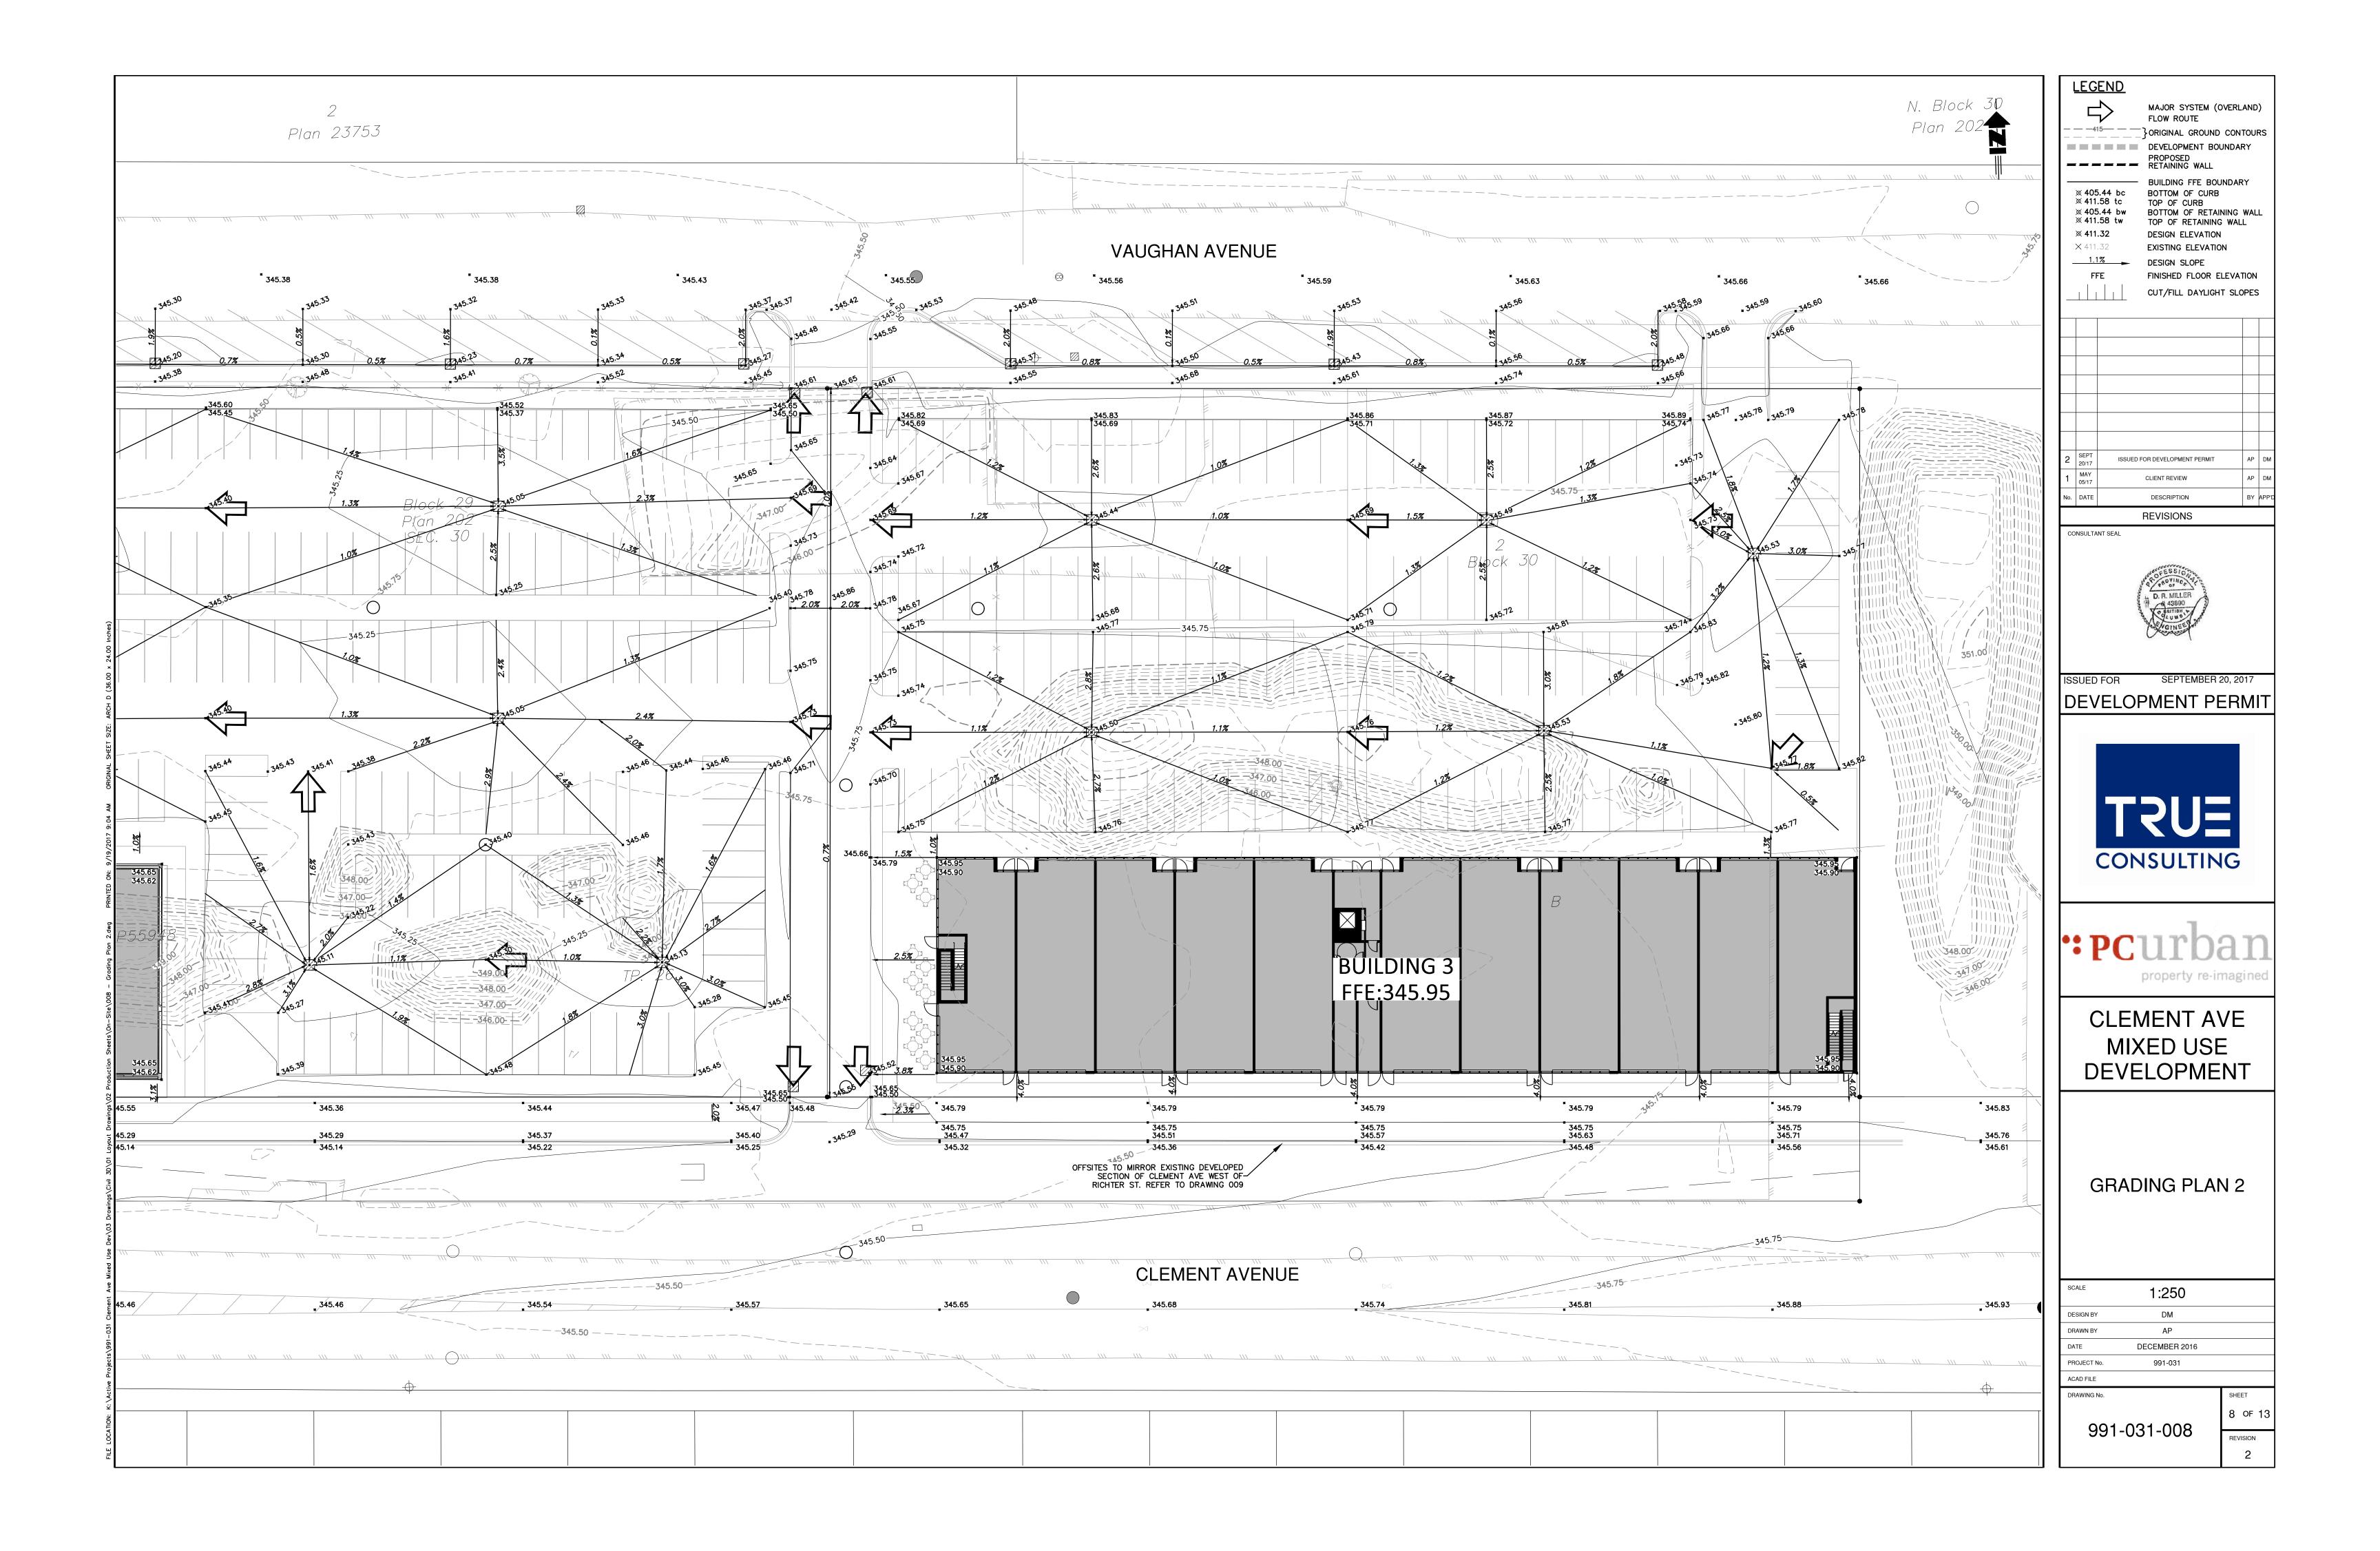


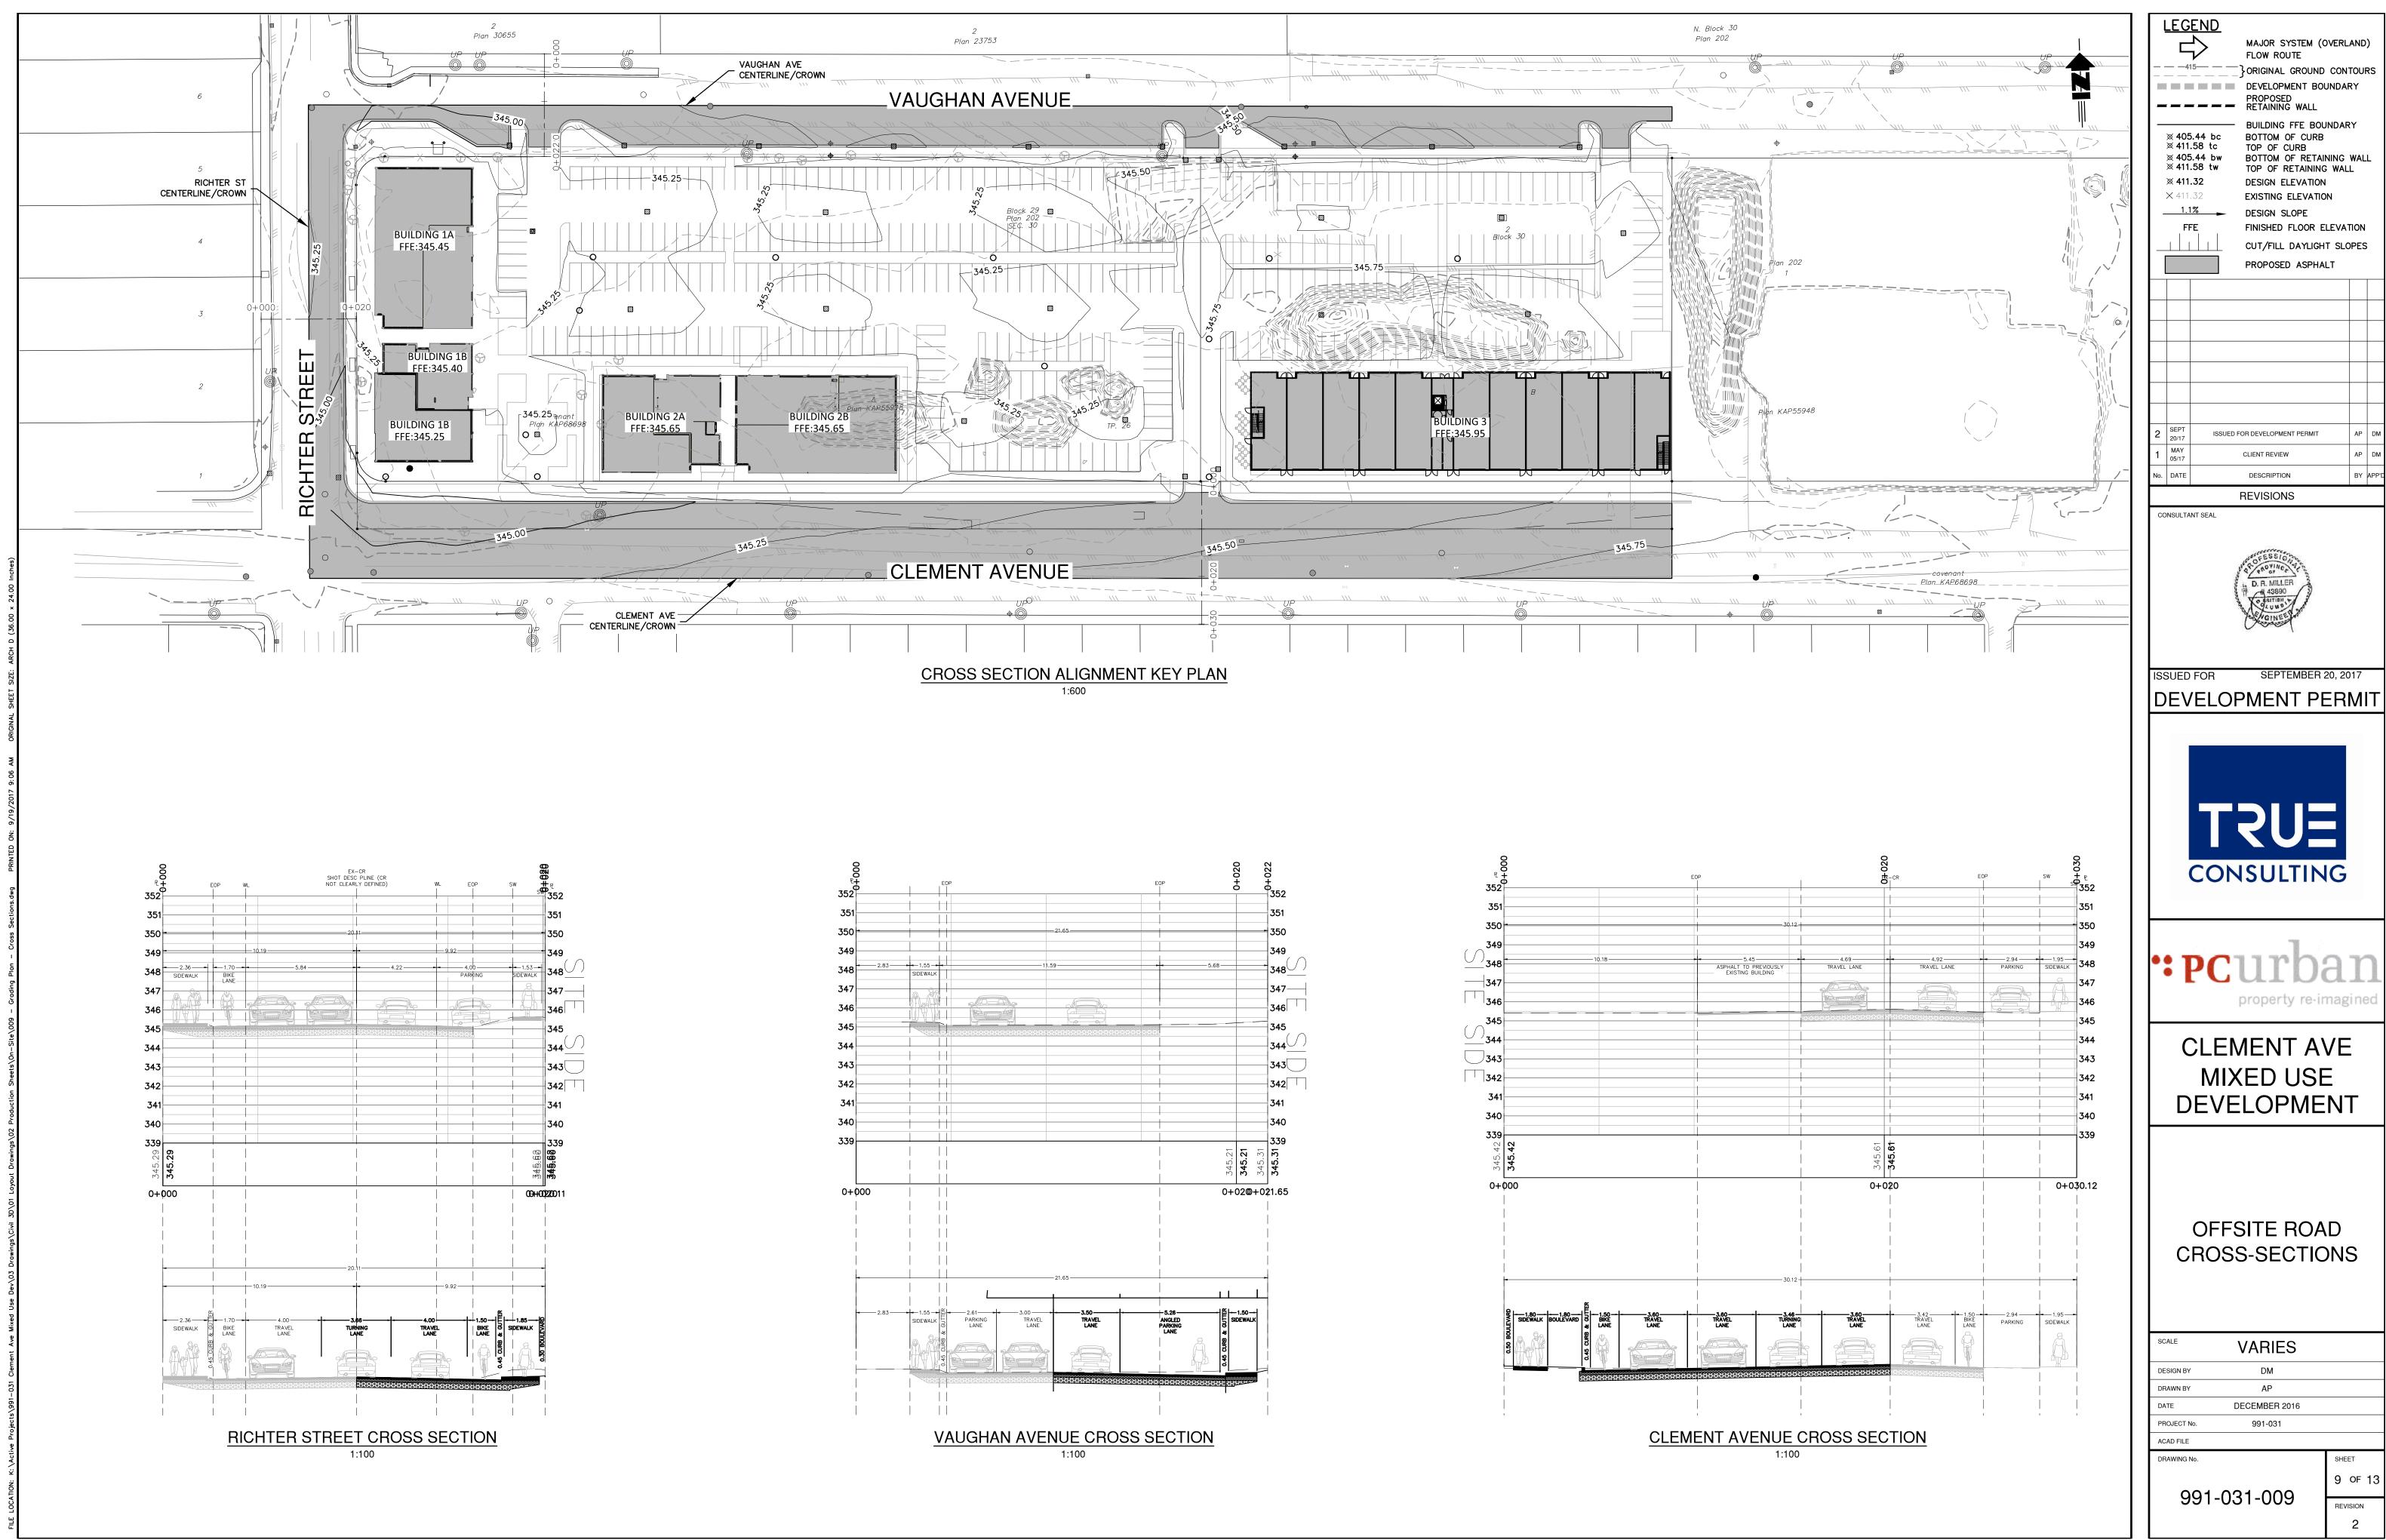

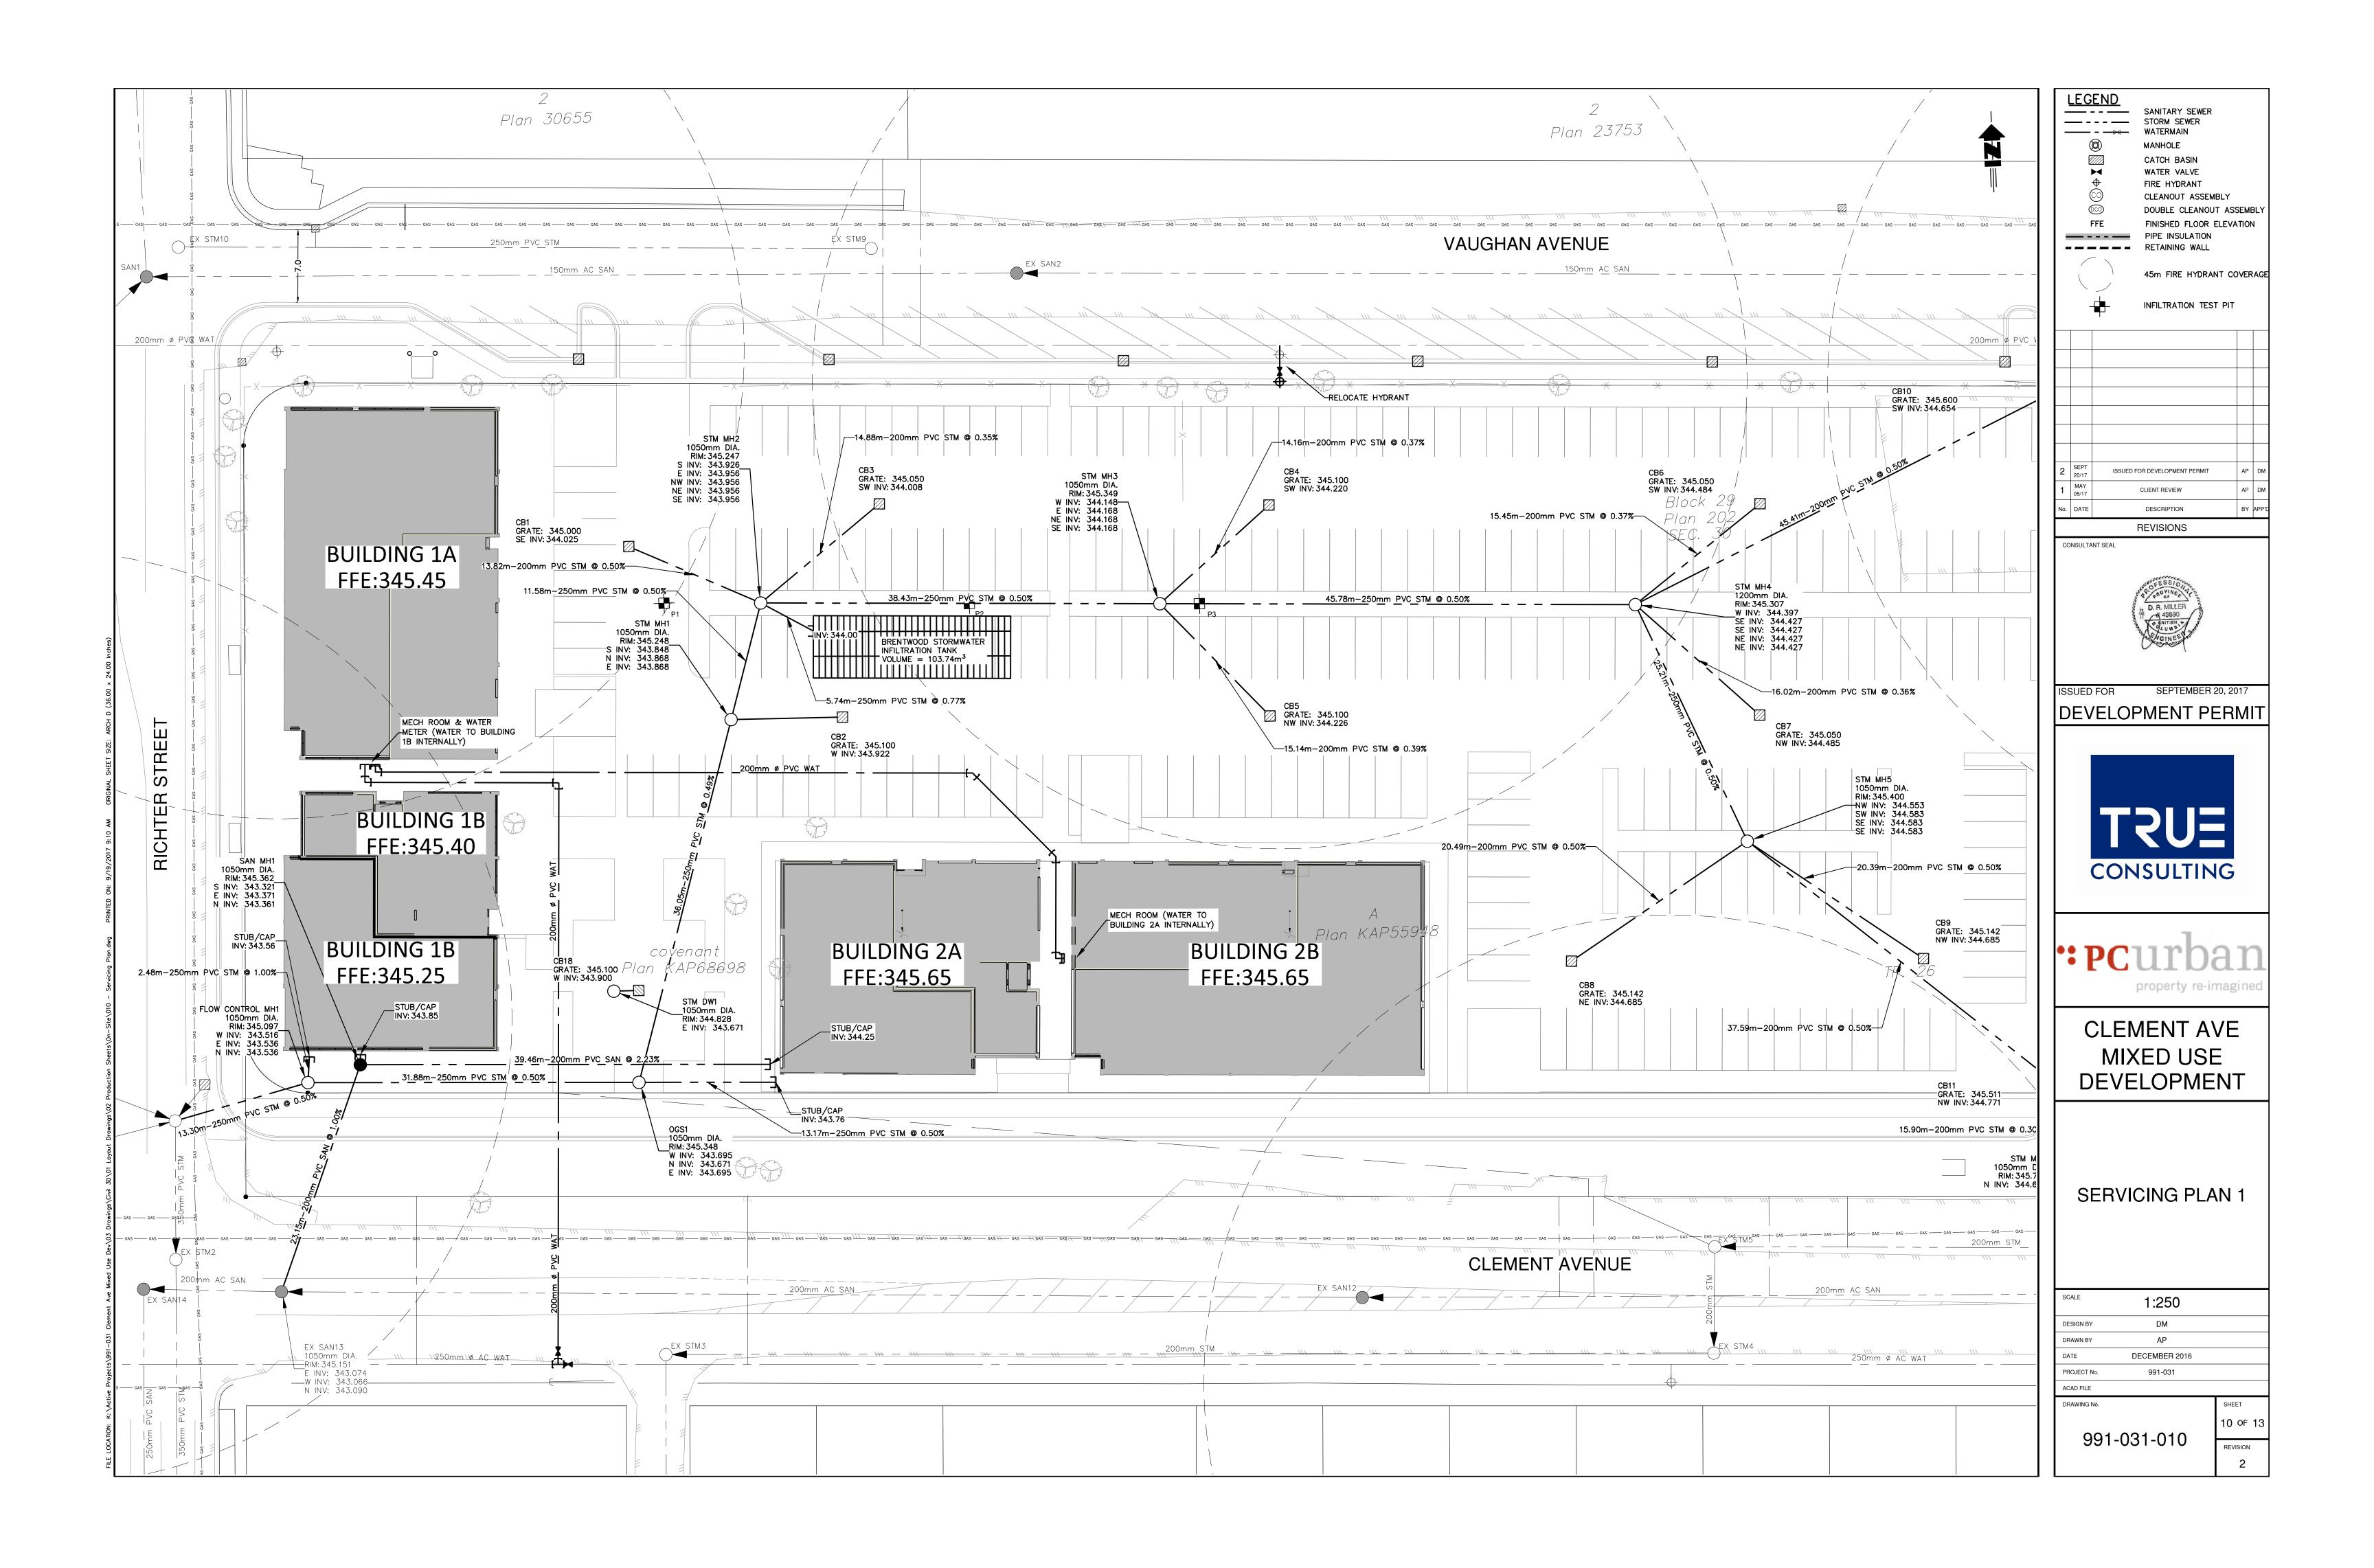


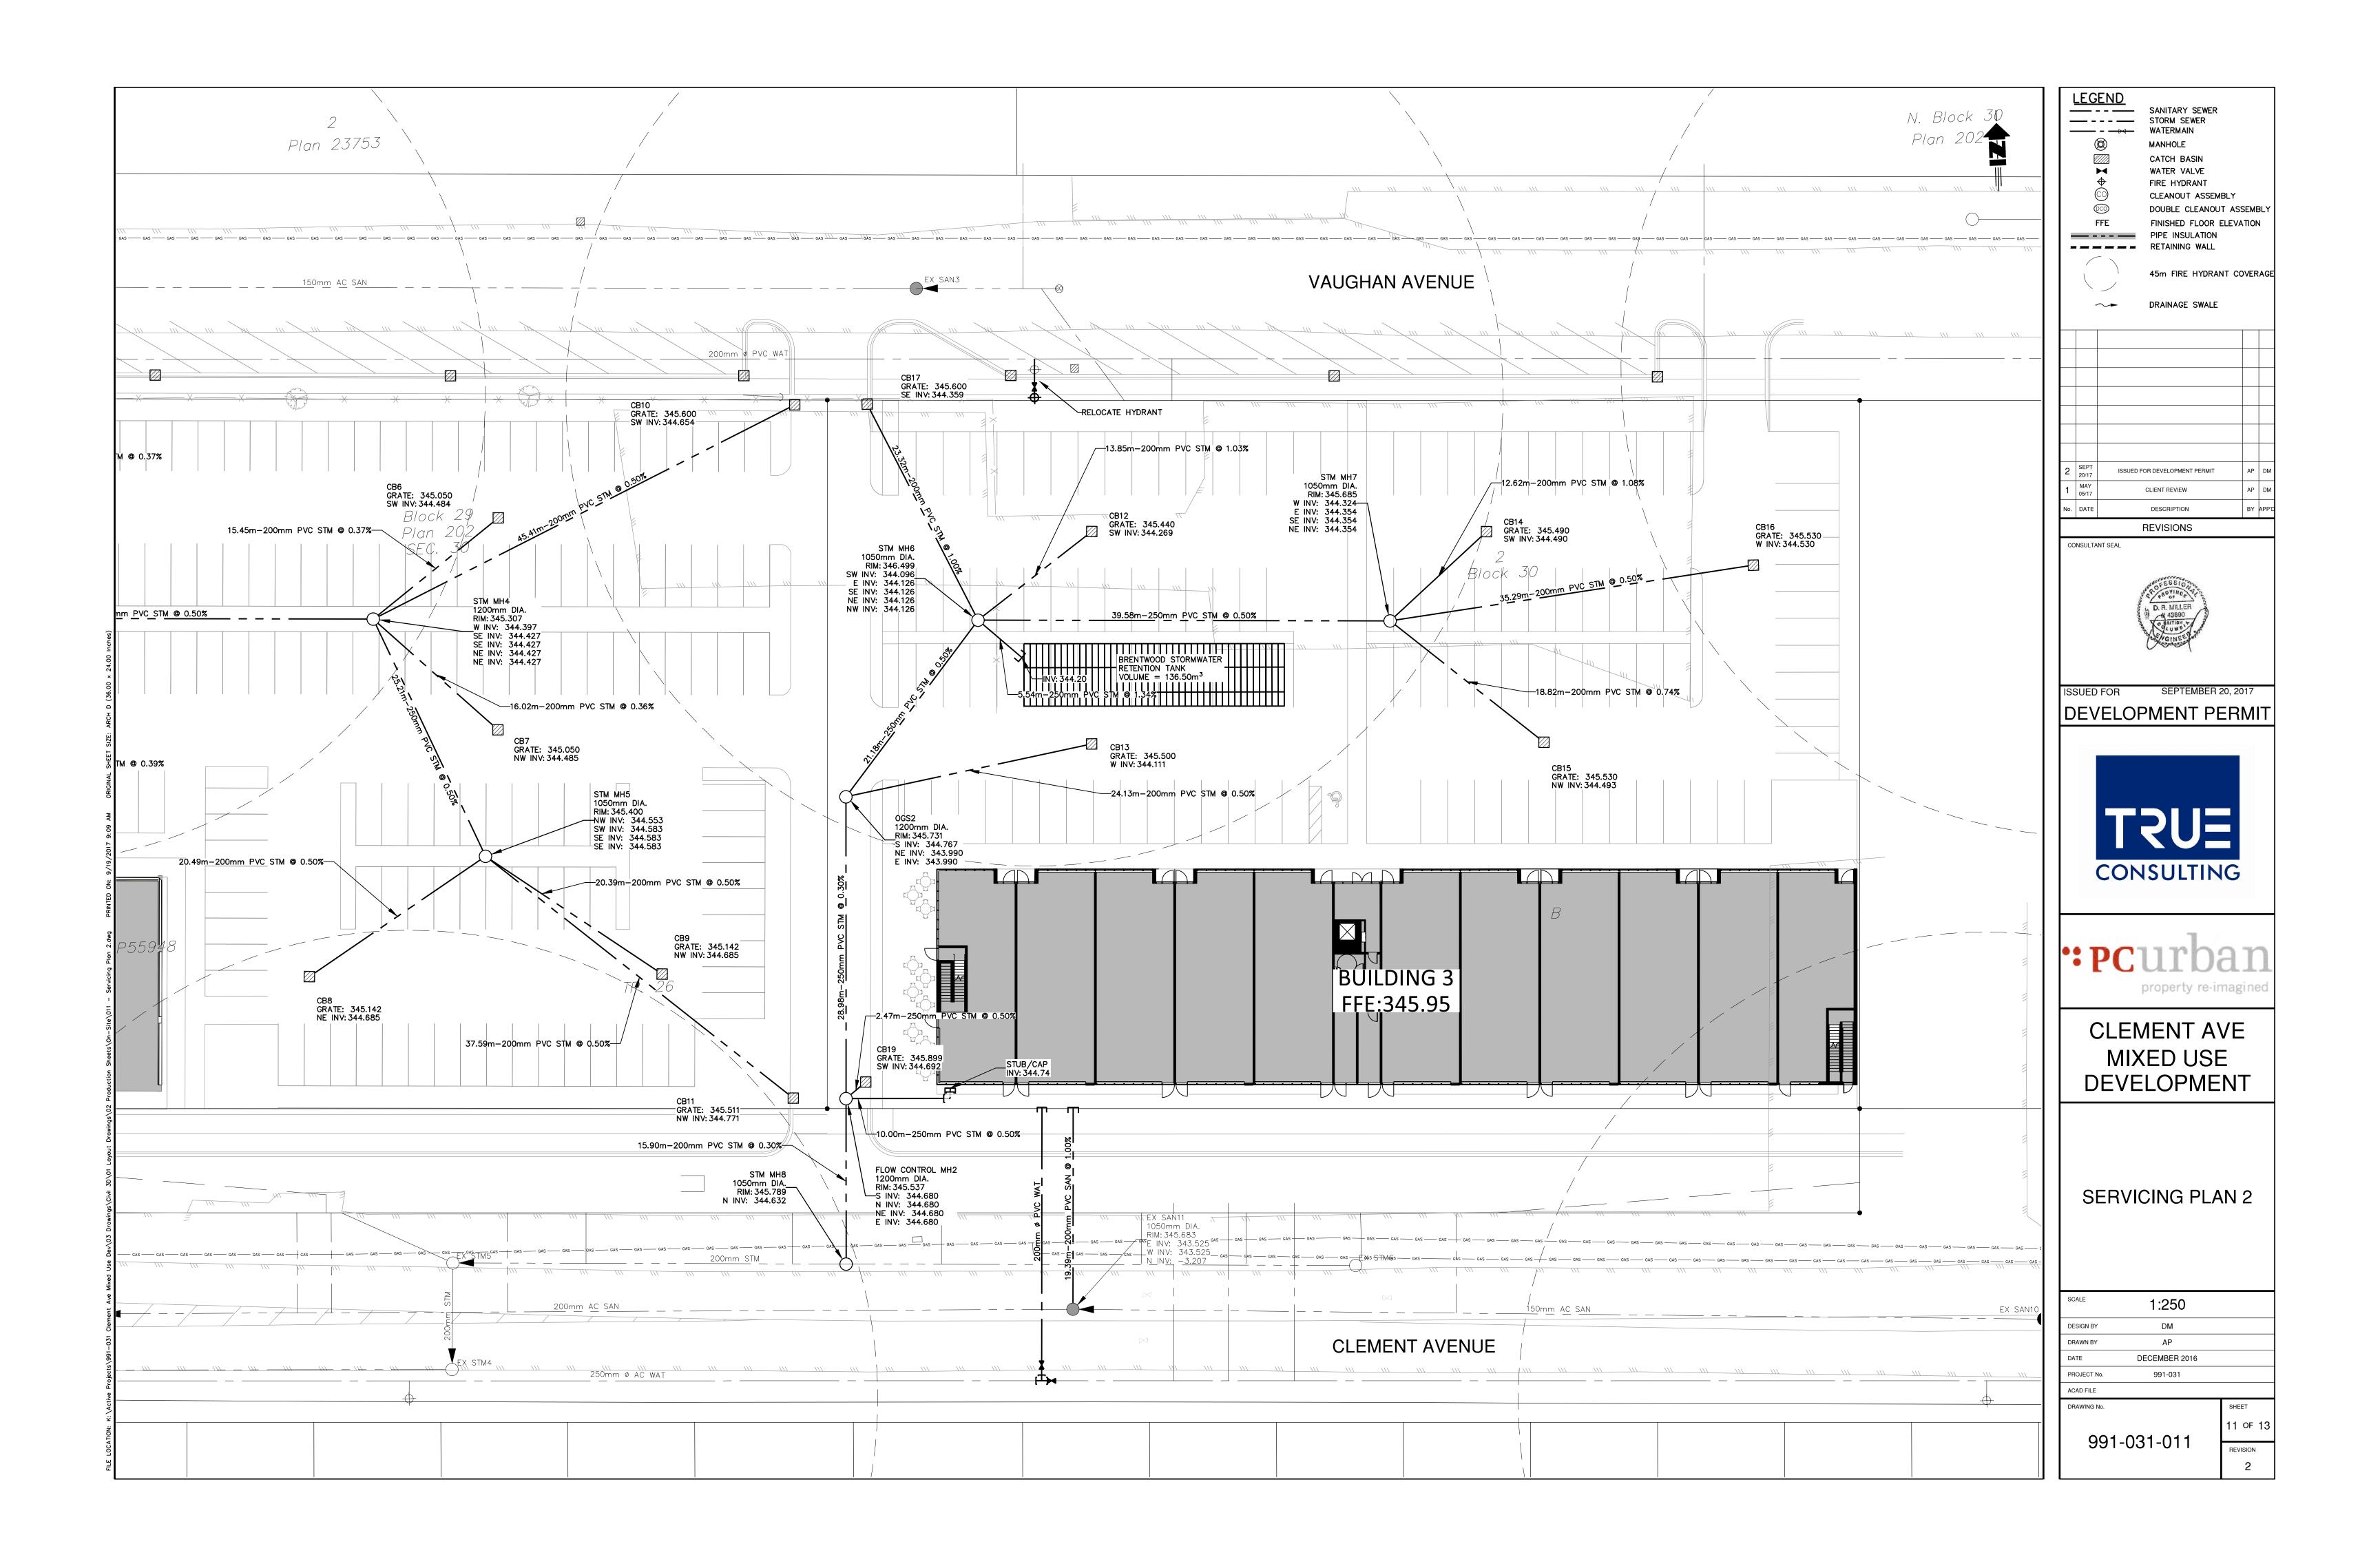


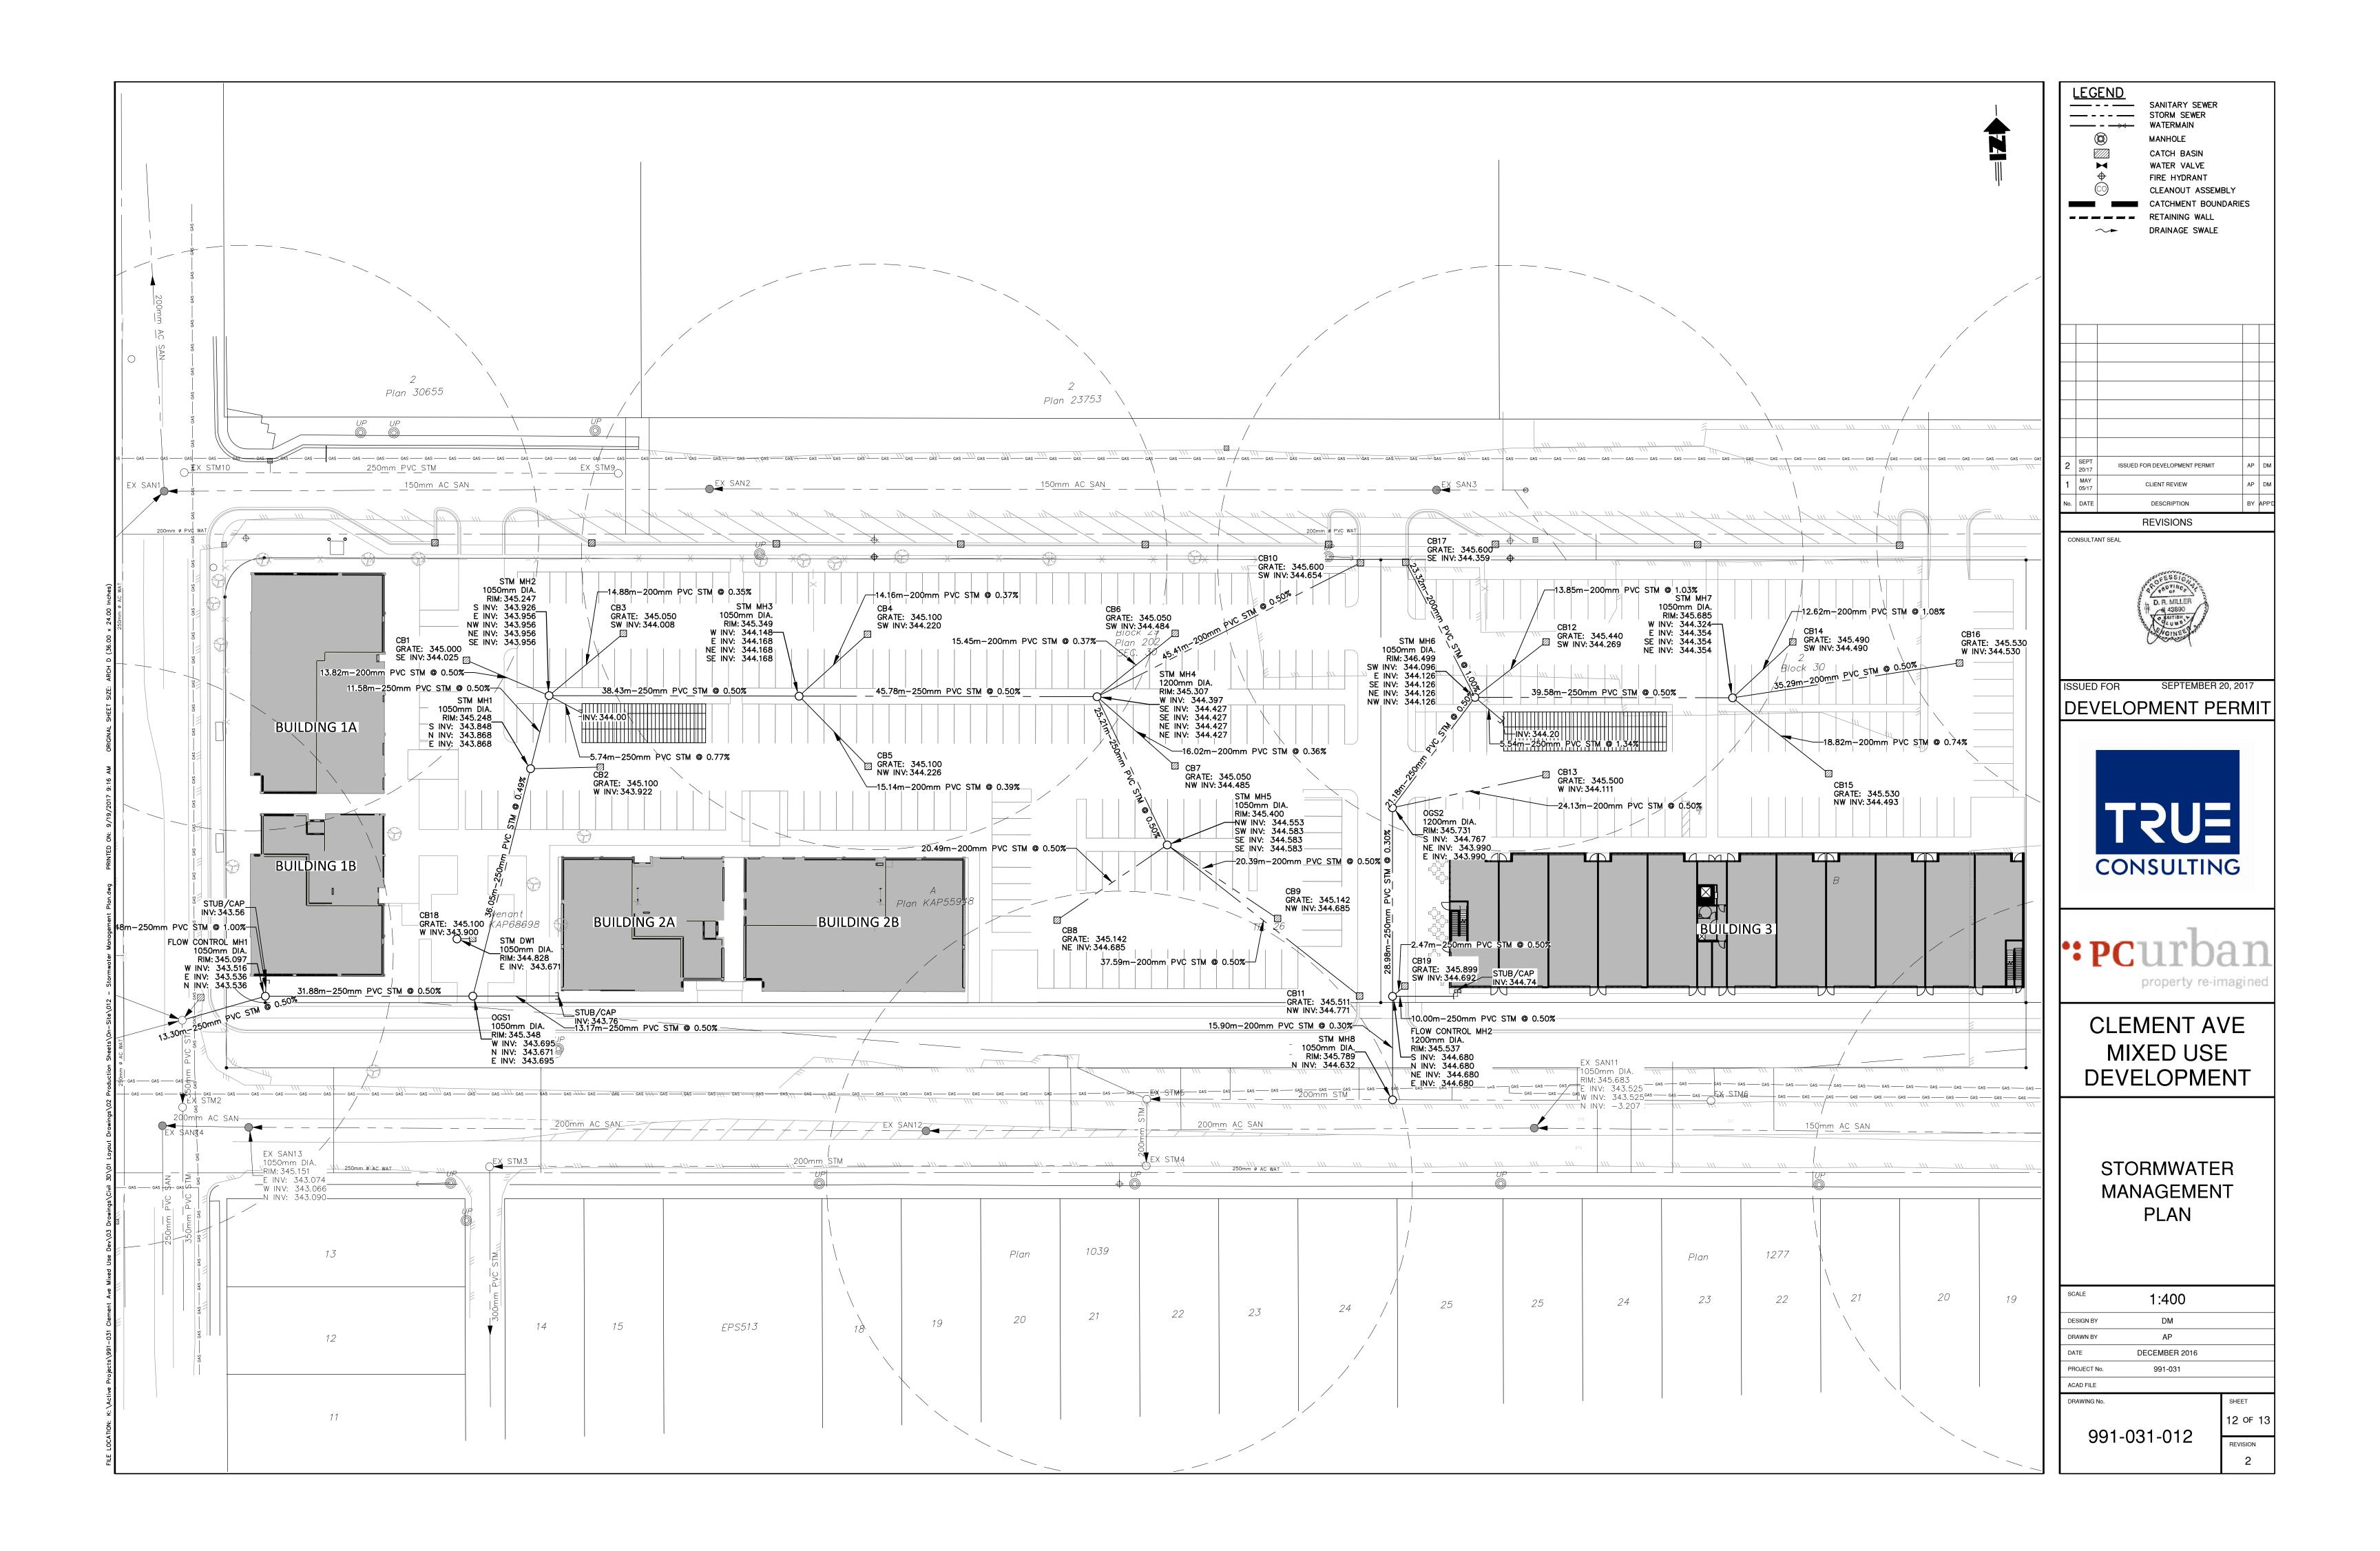

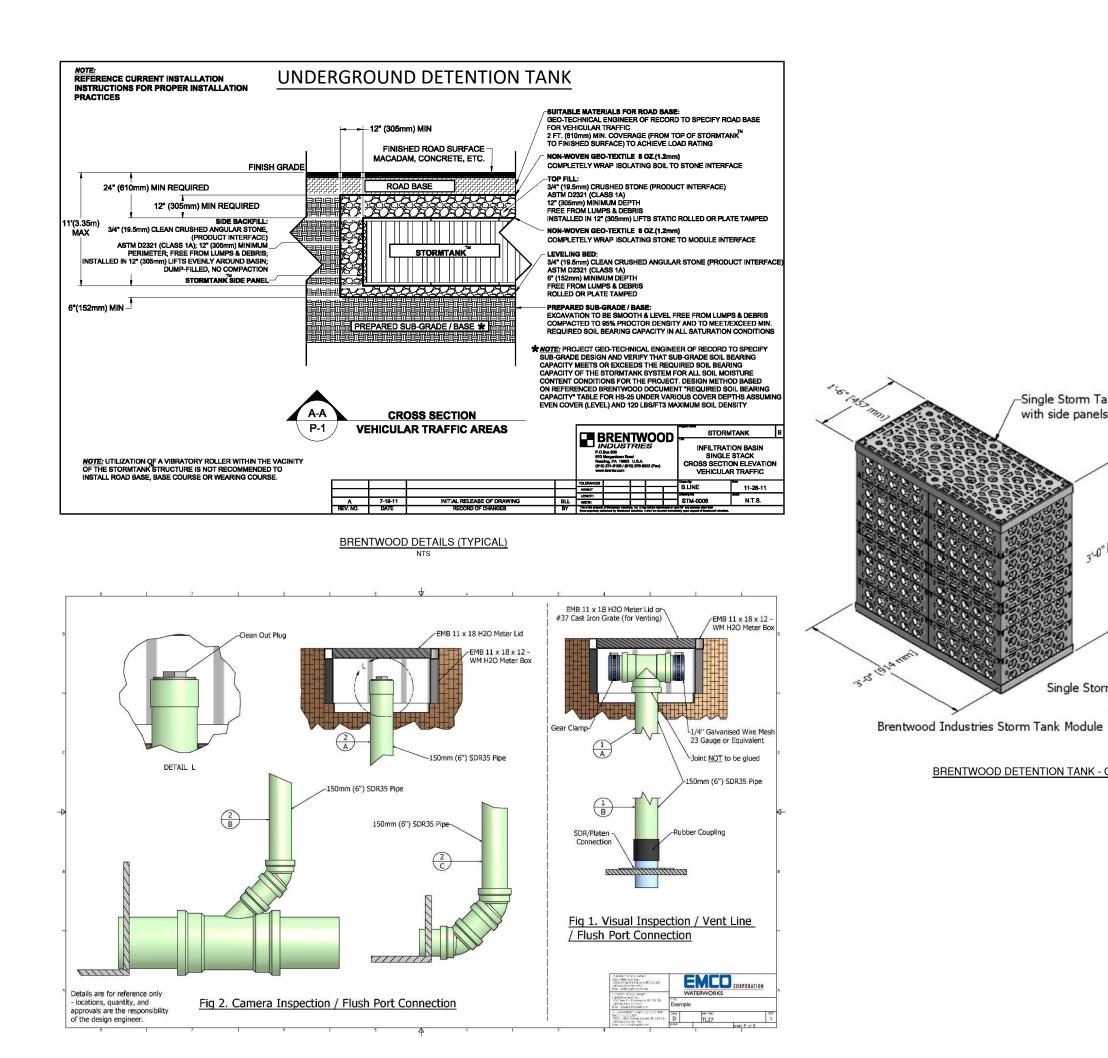


BRENTWOOD VENT DETAIL (TYPICAL)

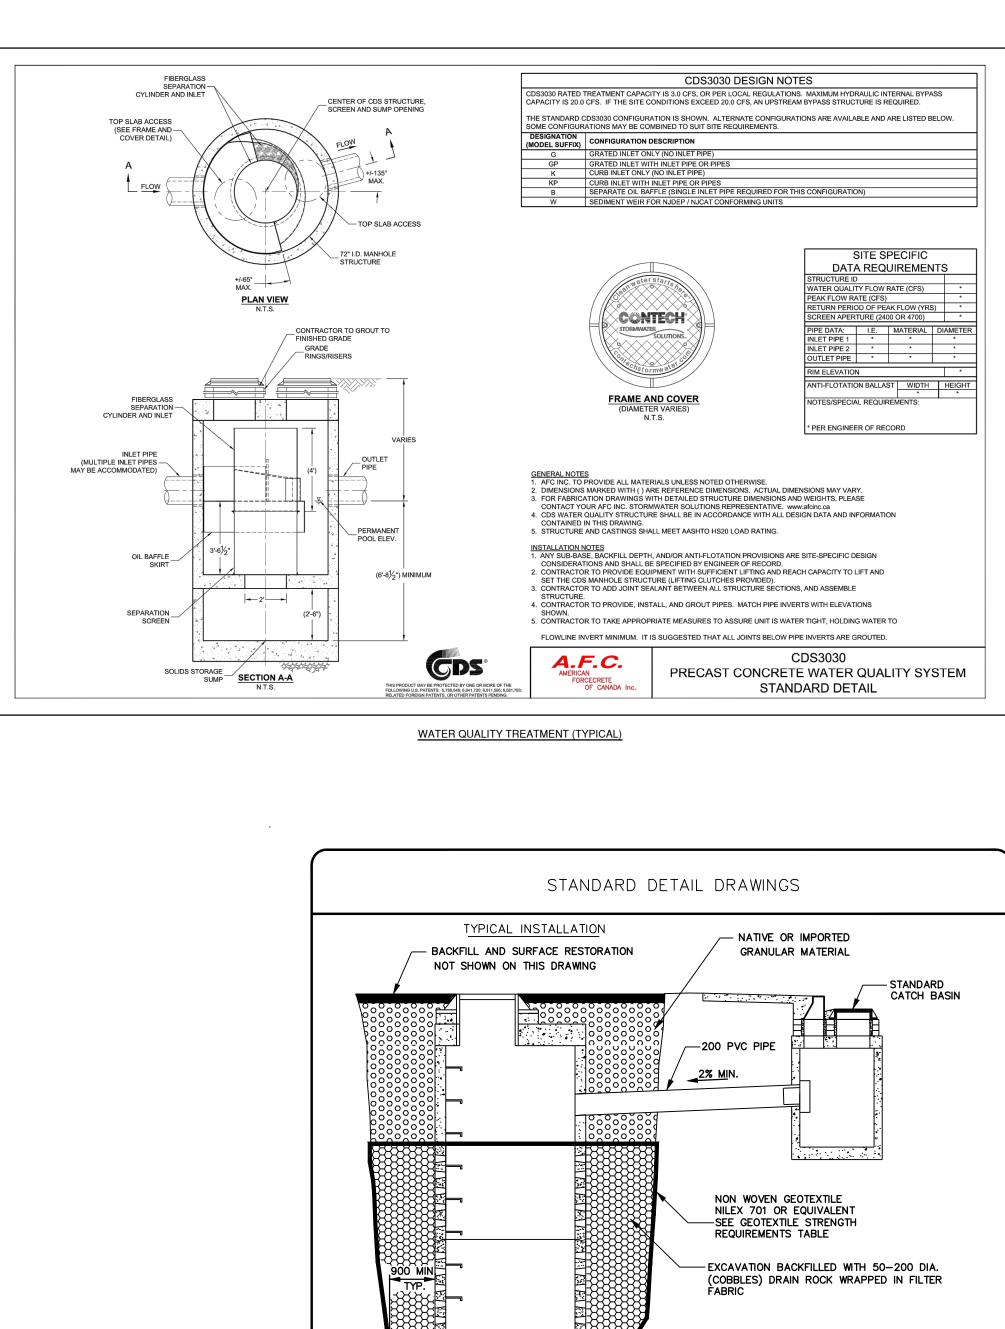

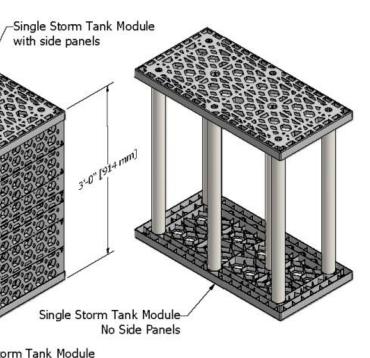

BRENTWOOD DETENTION TANK - CELL DIMENSIONS (TYPICAL)

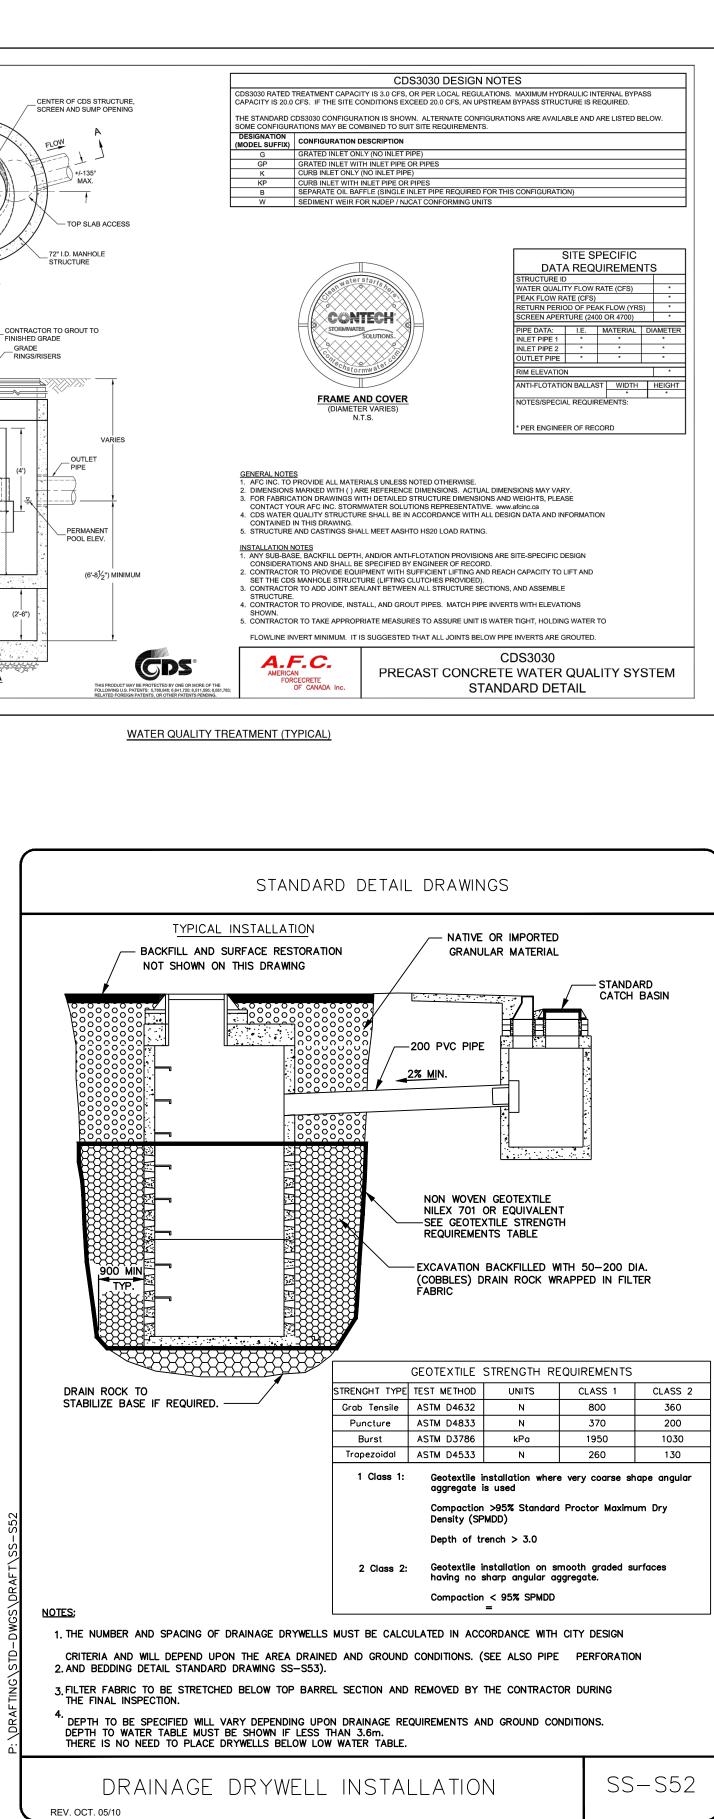



# **Clement Avenue and Richter Street Mixed-Use**

# LANDSCAPE ARCHITECTURAL SET - ISSUED FOR REVIEW - 18 SEPTEMBER 2017

# LANDSCAPE DRAWING INDEX

SHEET No.	SHEET NAME
L1.0	COVER SHEET AND CONT
L1.1	CONCEPT PLAN - WEST S
L1.2	CONCEPT PLAN - EAST SI
L1.3	PLAZA CONCEPT OPTION
L2.0	PRECEDENT MATERIALS
L2.1	PLANT MATERIALS AND S
L2.2	PLANTING PLAN - WEST S
L2.3	PLANTING PLAN - EAST S
L3.0	IRRIGATION PLAN



ITEXT PLAN SIDE SIDE NS

SCHEDULE SIDE SIDE

# **GENERAL NOTES**

ALL LANDSCAPE ARCHITECTURAL DRAWINGS IN THIS PACKAGE SHALL BE READ IN CONJUNCTION WITH ALL OTHER LANDSCAPE ARCHITECTURAL DRAWINGS, DETAILS, SPECIFICATIONS, AND OTHER CORRESPONDANCE THAT MAY BE ISSUED DURING THE COURSE OF THE CONTRACT.

IF A DISCREPANCY OCCURS BETWEEN THE DRAWINGS AND THE SPECIFICATIONS OR ANY OTHER DOCUMENT ASSOCIATED WITH THE PROJECT, THE CONFLICT SHALL BE REPORTED IN WRITING TO THE LANDSCAPE ARCHITECT TO OBTAIN CLARIFICATION AND APPROVAL BEFORE PROCEEDING WITH WORKS.

THE CONTRACTOR SHALL VISIT THE SITE TO VERIFY THE TRUE EXISTING CONDITIONS. ANY UNCLEAR ISSUES SHALL BE CLARIFIED WITH THE LANDSCAPE ARCHITECT. NO CLAIM SHALL BE ALLOWED FOR EXTRAS WHICH MAY ARISE THROUGH NEGLECT OF THIS ADVICE.

ALL EXISTING INFORMATION IS BASED ON AVAILABLE RECORDS AND SHALL NOT BE CONSTRUED TO BE COMPLETE OR ACCURATE.

LAYOUT OF HARDSCAPE, SITE FURNITURE, SOIL, PLANTING, AND ALL OTHER MATERIALS IS TO BE STAKED OUT AND APPROVED BY THE LANDSCAPE ARCHITECT PRIOR TO INSTALLATION.

ALL PLANTING SHALL BE IN ACCORDANCE WITH BC LANDSCAPE STANDARD, LATEST EDITION. THE CONTRACTOR IS RESPONSIBLE FOR DETERMINING THE EXISTENCE, LOCATION, AND ELEVATION OF ALL UTILITIES AND CONCEALED STRUCTURES, AND IS RESPONSIBLE FOR NOTIFYING THE APPROPRIATE COMPANY, DEPARTMENT OR PERSON(S) OF ITS INTENTION TO CARRY OUT ITS OPERATIONS.

CONNECT LANDSCAPE ARCHITECTURE INC. DOES NOT GUARANTEE THE EXISTENCE, LOCATION, AND ELEVATION OF UTILITIES OR CONCEALED STRUCTURES AT THE PROJECT SITE.

FINAL SPACING, SELECTION, TREE SPECIES TO THE SATISFACTION OF THE CITY OF KELOWNA.

ALL PUBLIC REALM DETAILS TO CITY OF KELOWNA STANDARDS



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4 ISSUED FOR CLIENT REVIEW	17-09-18
3 ISSUED FOR CLIENT REVIEW	17-06-27
2 ISSUED FOR CLIENT REVIEW	17-05-31
1 ISSUED FOR CLIENT REVIEW	17-05-24
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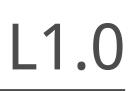


## Clement Avenue and Richter Street Mixed-Use

726 and 816 Clement Avenue Kelowna, British Columbia

Scale:	1/16"=1'-0"
Drawn:	KD
Reviewed:	DS
Project No.	06-545

LANDCAPE COVER PAGE AND CONTEXT PLAN







CONNECT LANDSCAPE ARCHITECTURE INC. DOES NOT GUARANTEE THE EXISTENCE, LOCATION, AND ELEVATION OF UTILITIES AND / OR CONCEALED STRUCTURES AT THE PROJECT SITE.

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ISSUED FOR CLIENT REVIEW	17-05-24
EVISIONS	



## Clement Avenue and Richter Street Mixed-Use

726 and 816 Clement Avenue Kelowna, British Columbia

Scale:	1:200
Drawn:	KD
Reviewed:	DS
Project No.	06-545

LANDSCAPE CONCEPT WEST SIDE

L1.1





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3 IS	SUED FOR CLIENT REVIEW	
		17-06-27
2 IS	SUED FOR CLIENT REVIEW	17-05-31
1 IS	SUED FOR CLIENT REVIEW	17-05-24




## Clement Avenue and Richter Street Mixed-Use

726 and 816 Clement Avenue Kelowna, British Columbia


Scale:	1:200
Drawn:	KD
Reviewed:	DS
Project No.	06-545

LANDSCAPE CONCEPT EAST SIDE

L1.2

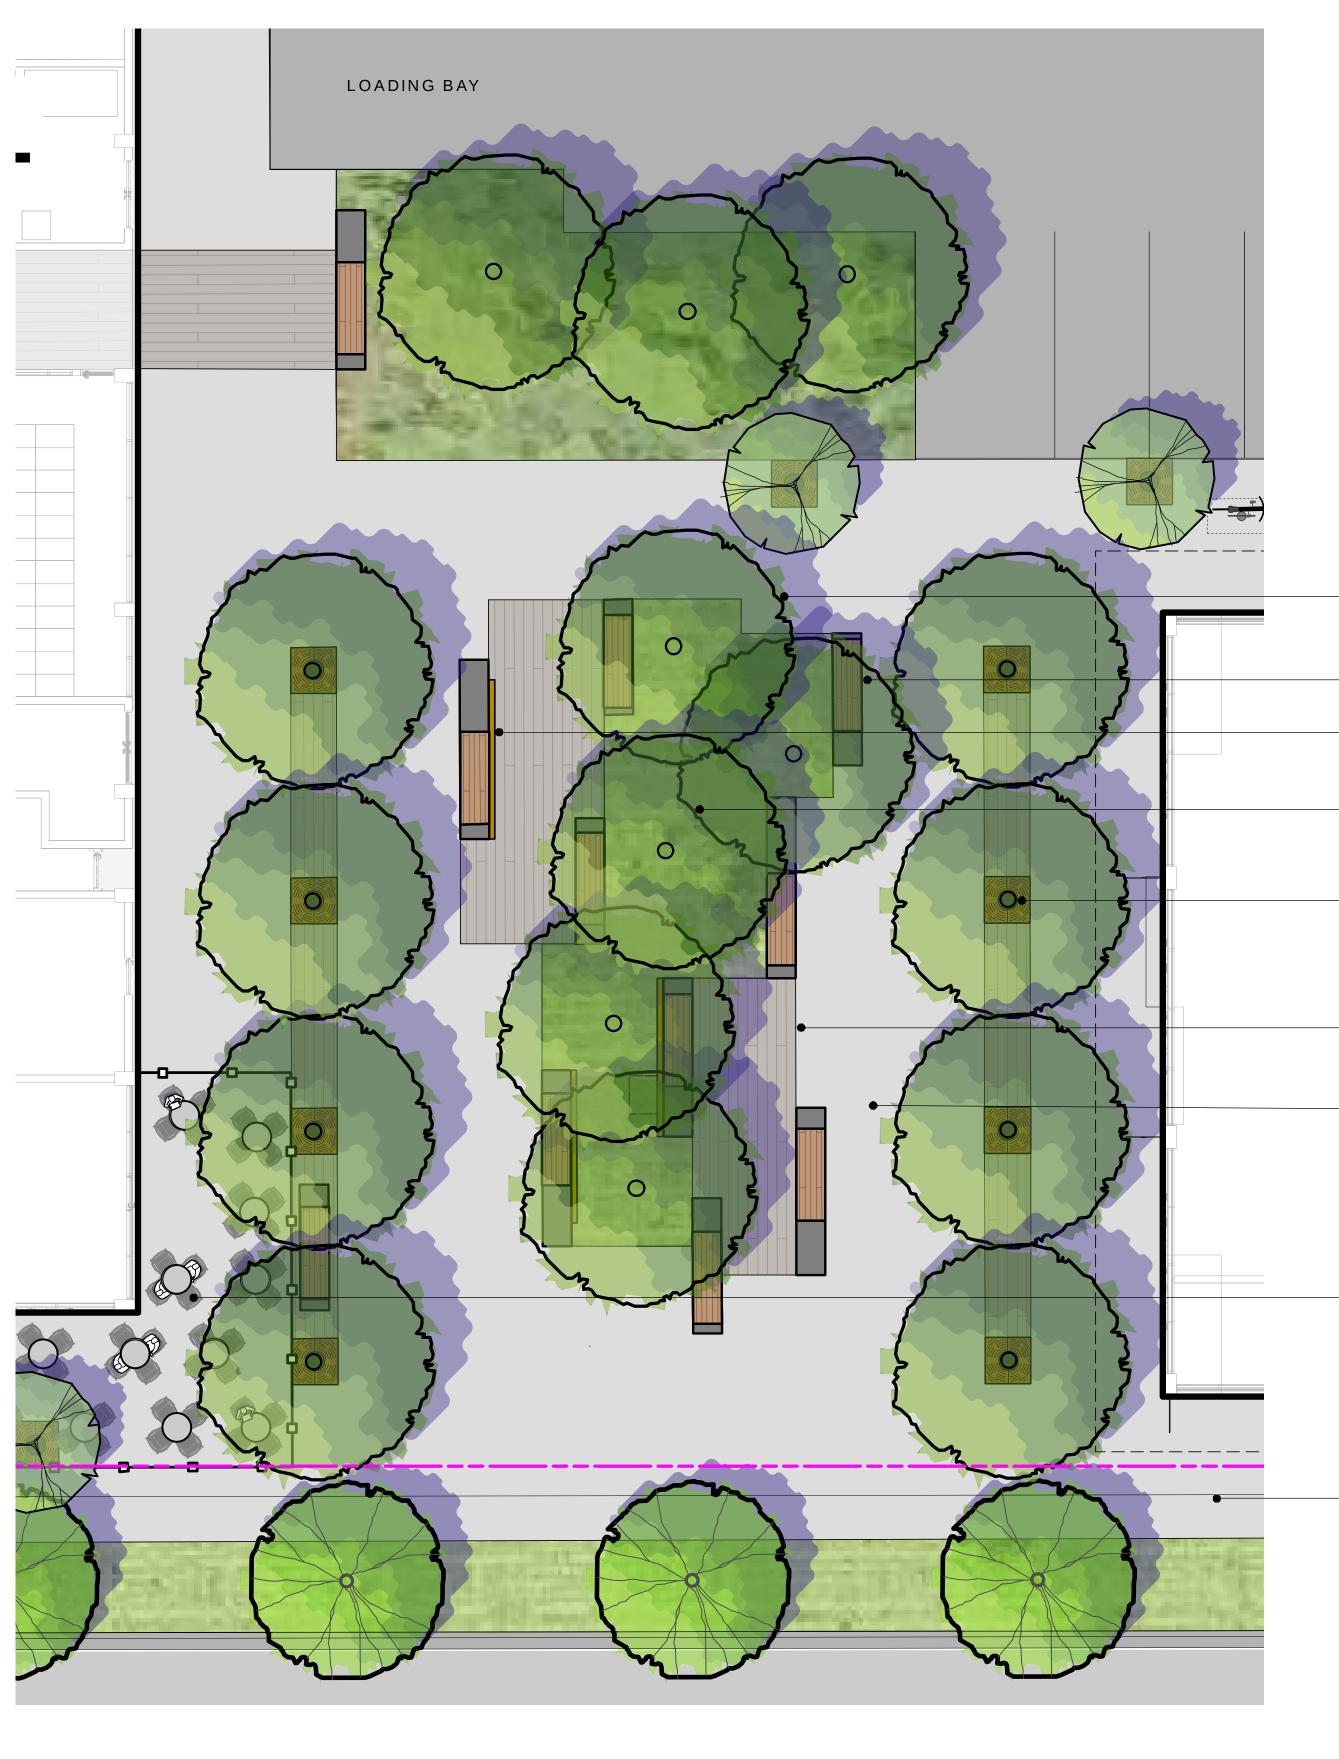

**DETAILED COURTYARD PLAN - 1:100** 

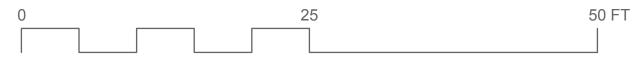

## - SHADE TREES

- CUSTOM SEATING

– POTENTIAL ART PANEL LOCATIONS

CENTRAL PLANTING AREA - WITH SHADE TREES

- TREES IN TREE GRATES

SPECIAL PAVING DEFINES - SEATING ZONES

- CIRCULATION ZONE

- POSSIBLE RESTAURANT PATIO

- SIDEWALK









# LANDSCAPE CHARACTER AND PRECEDENTS



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CONNECT LANDSCAPE ARCHITECTURE INC. DOES NOT GUARANTEE THE EXISTENCE, LOCATION, AND ELEVATION OF UTILITIES AND / OR CONCEALED STRUCTURES AT THE PROJECT SITE.

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# Clement Avenue and Richter Street Mixed-Use

726 and 816 Clement Avenue Kelowna, British Columbia

1:100
KD
DS
06-545

LANDSCAPE CONCEPT MEZZANINE - LEVEL 3

L1.3

# LANDSCAPE CHARACTER

•RUSTIC MATERIALS COMBINED WITH DROUGHT-TOLERANT PLANTS.

•ATTRACTIVE ORNAMENTAL GRASSES.

•LOCAL MATERIALS, RIVER COBBLE, BOULDERS, TIMBERS.





# SEATING AND WALLS

•LARGE AND SIMPLE FORMS.

•COLOURS THAT CONTRAST WITH THE PLANTING MATERIALS.

•BOARD-FORM CONCRETE FOR CUSTOM SEATS AND WALLS, TO RELATE TO PACKING BOX THEME.

•POTENTIAL FOR TIMBERS INTEGRATED AS SEAT TOPS

# MATERIALS

•TEXTURED CONCRETE PAVING - MIX OF BROOMED AND SAND-BLASTED FINISHES.

•BOARD-FORM CONCRETE FOR WALLS, PLANTERS, SEAT ELEMENTS.

•WOOD-LOOK CONCRETE PAVERS IN FEATURE AREAS TO ADD TO TEXTURE AND CHARACTER.






# MATERIALS


•WEATHERED STEEL (CORE-TEN) TO BRING COLOUR AND TEXTURE.

•PATTERNS OR SIMPLE CUT-OUTS FOR IMAGES AND LOGOS.

•TREE GRATES AND OTHER ELEMENTS TO MATCH STEEL AND BRING COLOUR TO DIFFERENT SURFACES.

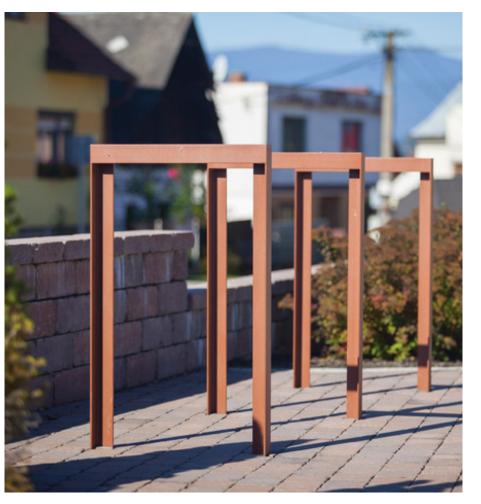



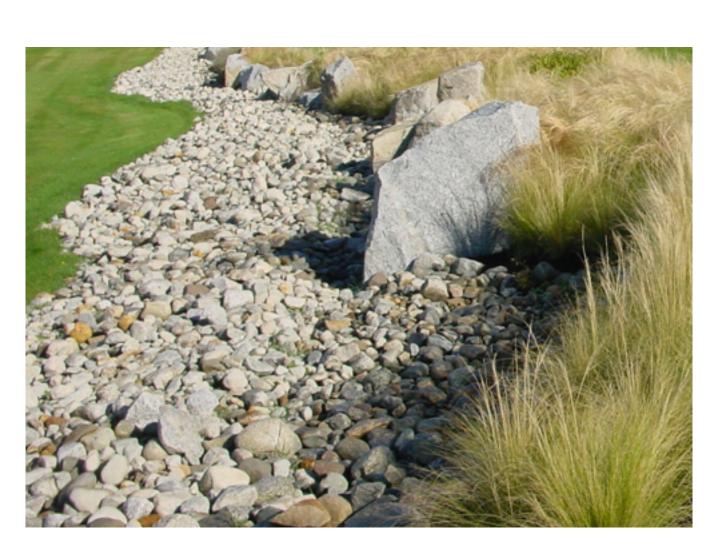



















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R	EVISIONS	



## Clement Avenue and Richter Street Mixed-Use

726 and 816 Clement Avenue Kelowna, British Columbia

Scale:	As Shown
Drawn:	DS
Reviewed:	DS
Project No.	06-545

MATERIALS AND CHARACTER


# LANDSCAPE CHARACTER

•RUSTIC MATERIALS COMBINED WITH DROUGHT-TOLERANT PLANTS.

•ATTRACTIVE ORNAMENTAL GRASSES MIXED WITH NATIVE AND DROUGHT-TOLERANT SHRUBS AND PERENNIALS

•LOCAL MATERIALS, RIVER COBBLE, BOULDERS



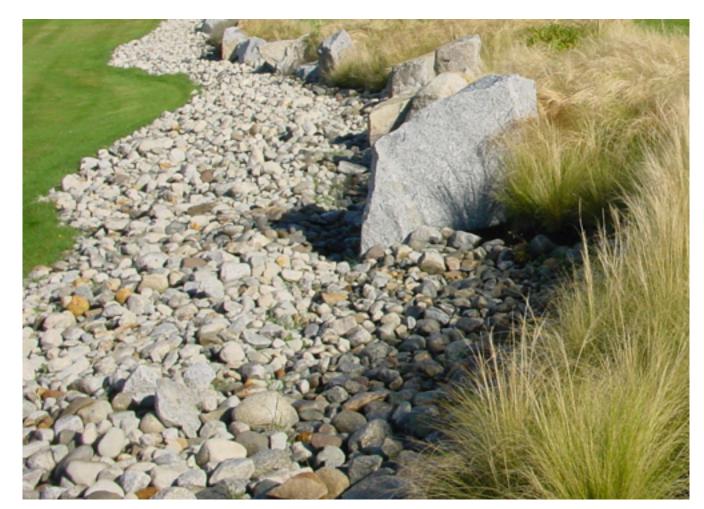



## PLANT SCHEDULE

KEY	QTY	BOTANICAL NAME	COMMON NAME	SIZE	SPACING	SUN EXP.
Trees						
	29	Acer rubrum 'Armstrong'	Armstrong Red Maple	7cm cal. 1.8m std. Full braching Ba	As Shown &B	$\bigcirc$ $\bigcirc$
	17	Acer saccharum 'Apollo'	Apollo Fastigiate Sugar Maple	6cm cal. 1.8m std. Full braching Ba	As Shown &B	$\bigcirc$
	17	Fraxinus pennsylvanica 'Prairie Spire'	Prairie Spire Ash	7cm cal. 1.8m std. Full braching Ba	As Shown &B	$\bigcirc igodot$
	19	Robinia pseudoacacia 'Frisia'	Golden Locust	7cm cal. 1.8m std. Full braching Ba	As Shown &B	$\bigcirc igodot$
	19	Tilia cordata 'Greenspire'	Greenspire Linden	7cm cal. 1.8m std. Full braching Ba	As Shown &B	$\bigcirc$
Shrubs						
	145	Artemesia tridentata	Mountain Sage	#2 pot	@600mm O.C.	0
SWA ZWI	377	Berberis 'Ruby Glow'	Dwarf Red Barberry	#3 pot	@600mm O.C.	$\bigcirc$
on and the	27	Clethra alnifolia	Sweet Pepper Bush	#2 pot	@1200mm O.C	

* **	145	Artemesia tridentata	Mountain Sage	#2 pot	@600mm O.C.	$\bigcirc$
2442	377	Berberis 'Ruby Glow'	Dwarf Red Barberry	#3 pot	@600mm O.C.	$\bigcirc$
Sand way	27	Clethra alnifolia	Sweet Pepper Bush	#2 pot	@1200mm O.C.	$\bigcirc \bigcirc \bigcirc \bigcirc \bigcirc$
	217	Cornus sericea 'Arctic Fire'	Dwarf Dogwood	#2 pot	@750mm O.C.	$\bigcirc \bigcirc$
	346	Cotoneaster dammeri	Little Leaf Cotoneaster	#2 pot	@600mm O.C.	$\bigcirc \bigcirc$
$\bigotimes$	265	Ericameria nauseousus	Rabbit Bush	#2 pot	@600mm O.C.	$\bigcirc \bigcirc$
$\bigcirc$	356	Picea abies 'Nidiformus'	Bird's Nest Spruce	#2 pot	@600mm O.C.	$\bigcirc \bigcirc$
	119	Rhus aromatica 'Gro-Low'	Gro'Low Sumac	#2 pot	@750mm O.C.	$\bigcirc \bigcirc$
	30	Ribes alpinum	Alpine Flowering Current	#3 pot	@900mm O.C.	$\bigcirc$ $\bigcirc$
$\bigcirc$	189	Symphoricarpos albus	Snowberry	#3 pot	@600mm O.C.	$\bigcirc$ $\bigcirc$
	26	Taxus X Media 'Hicksii'	Hick's Yew	1.2m High, B&B	@600mm O.C.	$\bigcirc \bigcirc \bullet \bullet$

Ornam	nental Grasse	es					
(		320	Calamagrostis x Acutiflora	Feather Reed Grass	#2 pot	@750mm O.C.	$\bigcirc \bigcirc$
Ì	$\otimes$	230	'Karl Foerster' Pennisetum alopecuroides	Dwarf Fountain Grass	#2 pot	@750mm O.C.	$\bigcirc$ $\bigcirc$
	*	259	'Hameln' Sporobolus heterolepis	Prairie Dropseed	#2 pot	@600mm O.C.	$\bigcirc$
Pereni	nials						
	*	67	Achillea millefolium	Yarrow	10cm pot	@450mm O.C.	$\bigcirc$
	$\bigcirc$	106	Echinacea purpurea	Purple Cone Flower	#1 pot	@600mm O.C.	$\bigcirc \bigcirc$
	*	24	Rudbeckia triloba	Browneyed Susan	#1 pot	@600mm O.C.	$\bigcirc$
	$\oplus$	89	Salvia nermerosa 'Caradonna'	Midnight Salvia	10cm pot	@450mm O.C.	$\bigcirc$

Full Sun 🔘

Part Sun / Shade 🌗

Shade 🕒



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4	ISSUED FOR CLIENT REVIEW	17-09-18
3	ISSUED FOR CLIENT REVIEW	17-06-27
2	ISSUED FOR CLIENT REVIEW	17-05-31
1	ISSUED FOR CLIENT REVIEW	17-05-24
RI	EVISIONS	
	-	




# Clement Avenue and Richter Street Mixed-Use

726 and 816 Clement Avenue Kelowna, British Columbia

Scale:	As Shown
Drawn:	KD
Reviewed:	DS
Project No.	06-545

# PLANT SCHEDULE

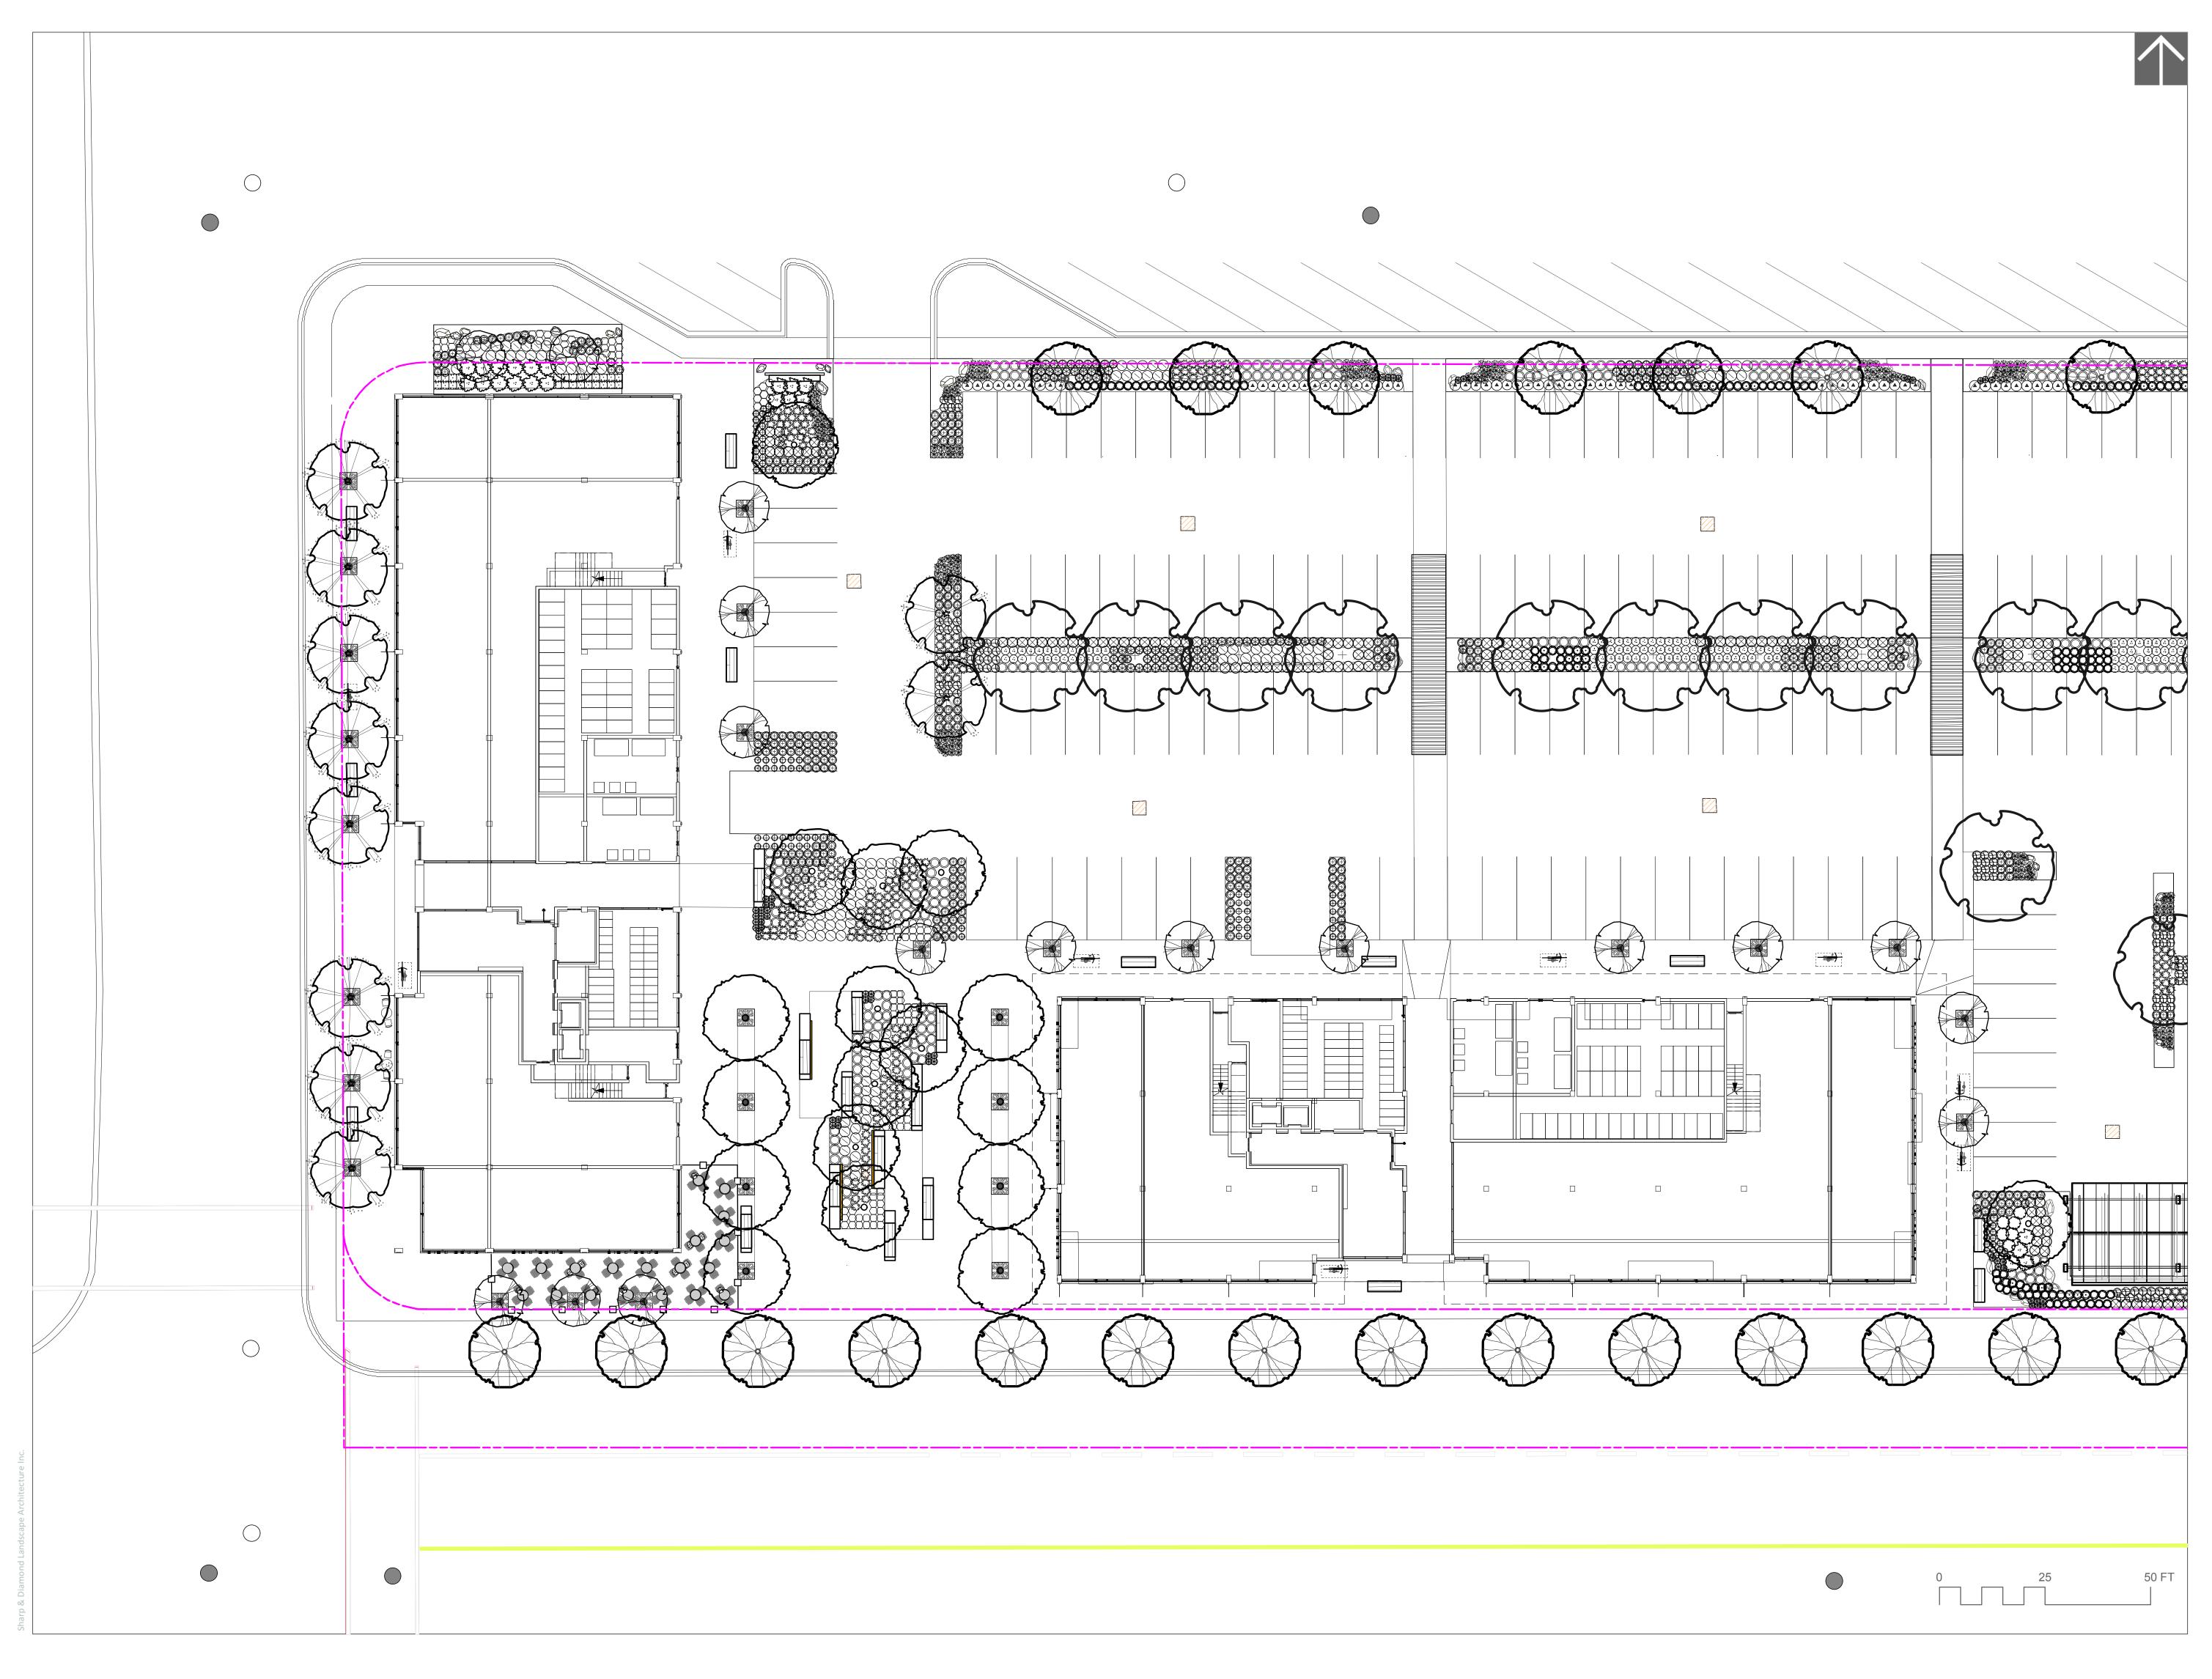



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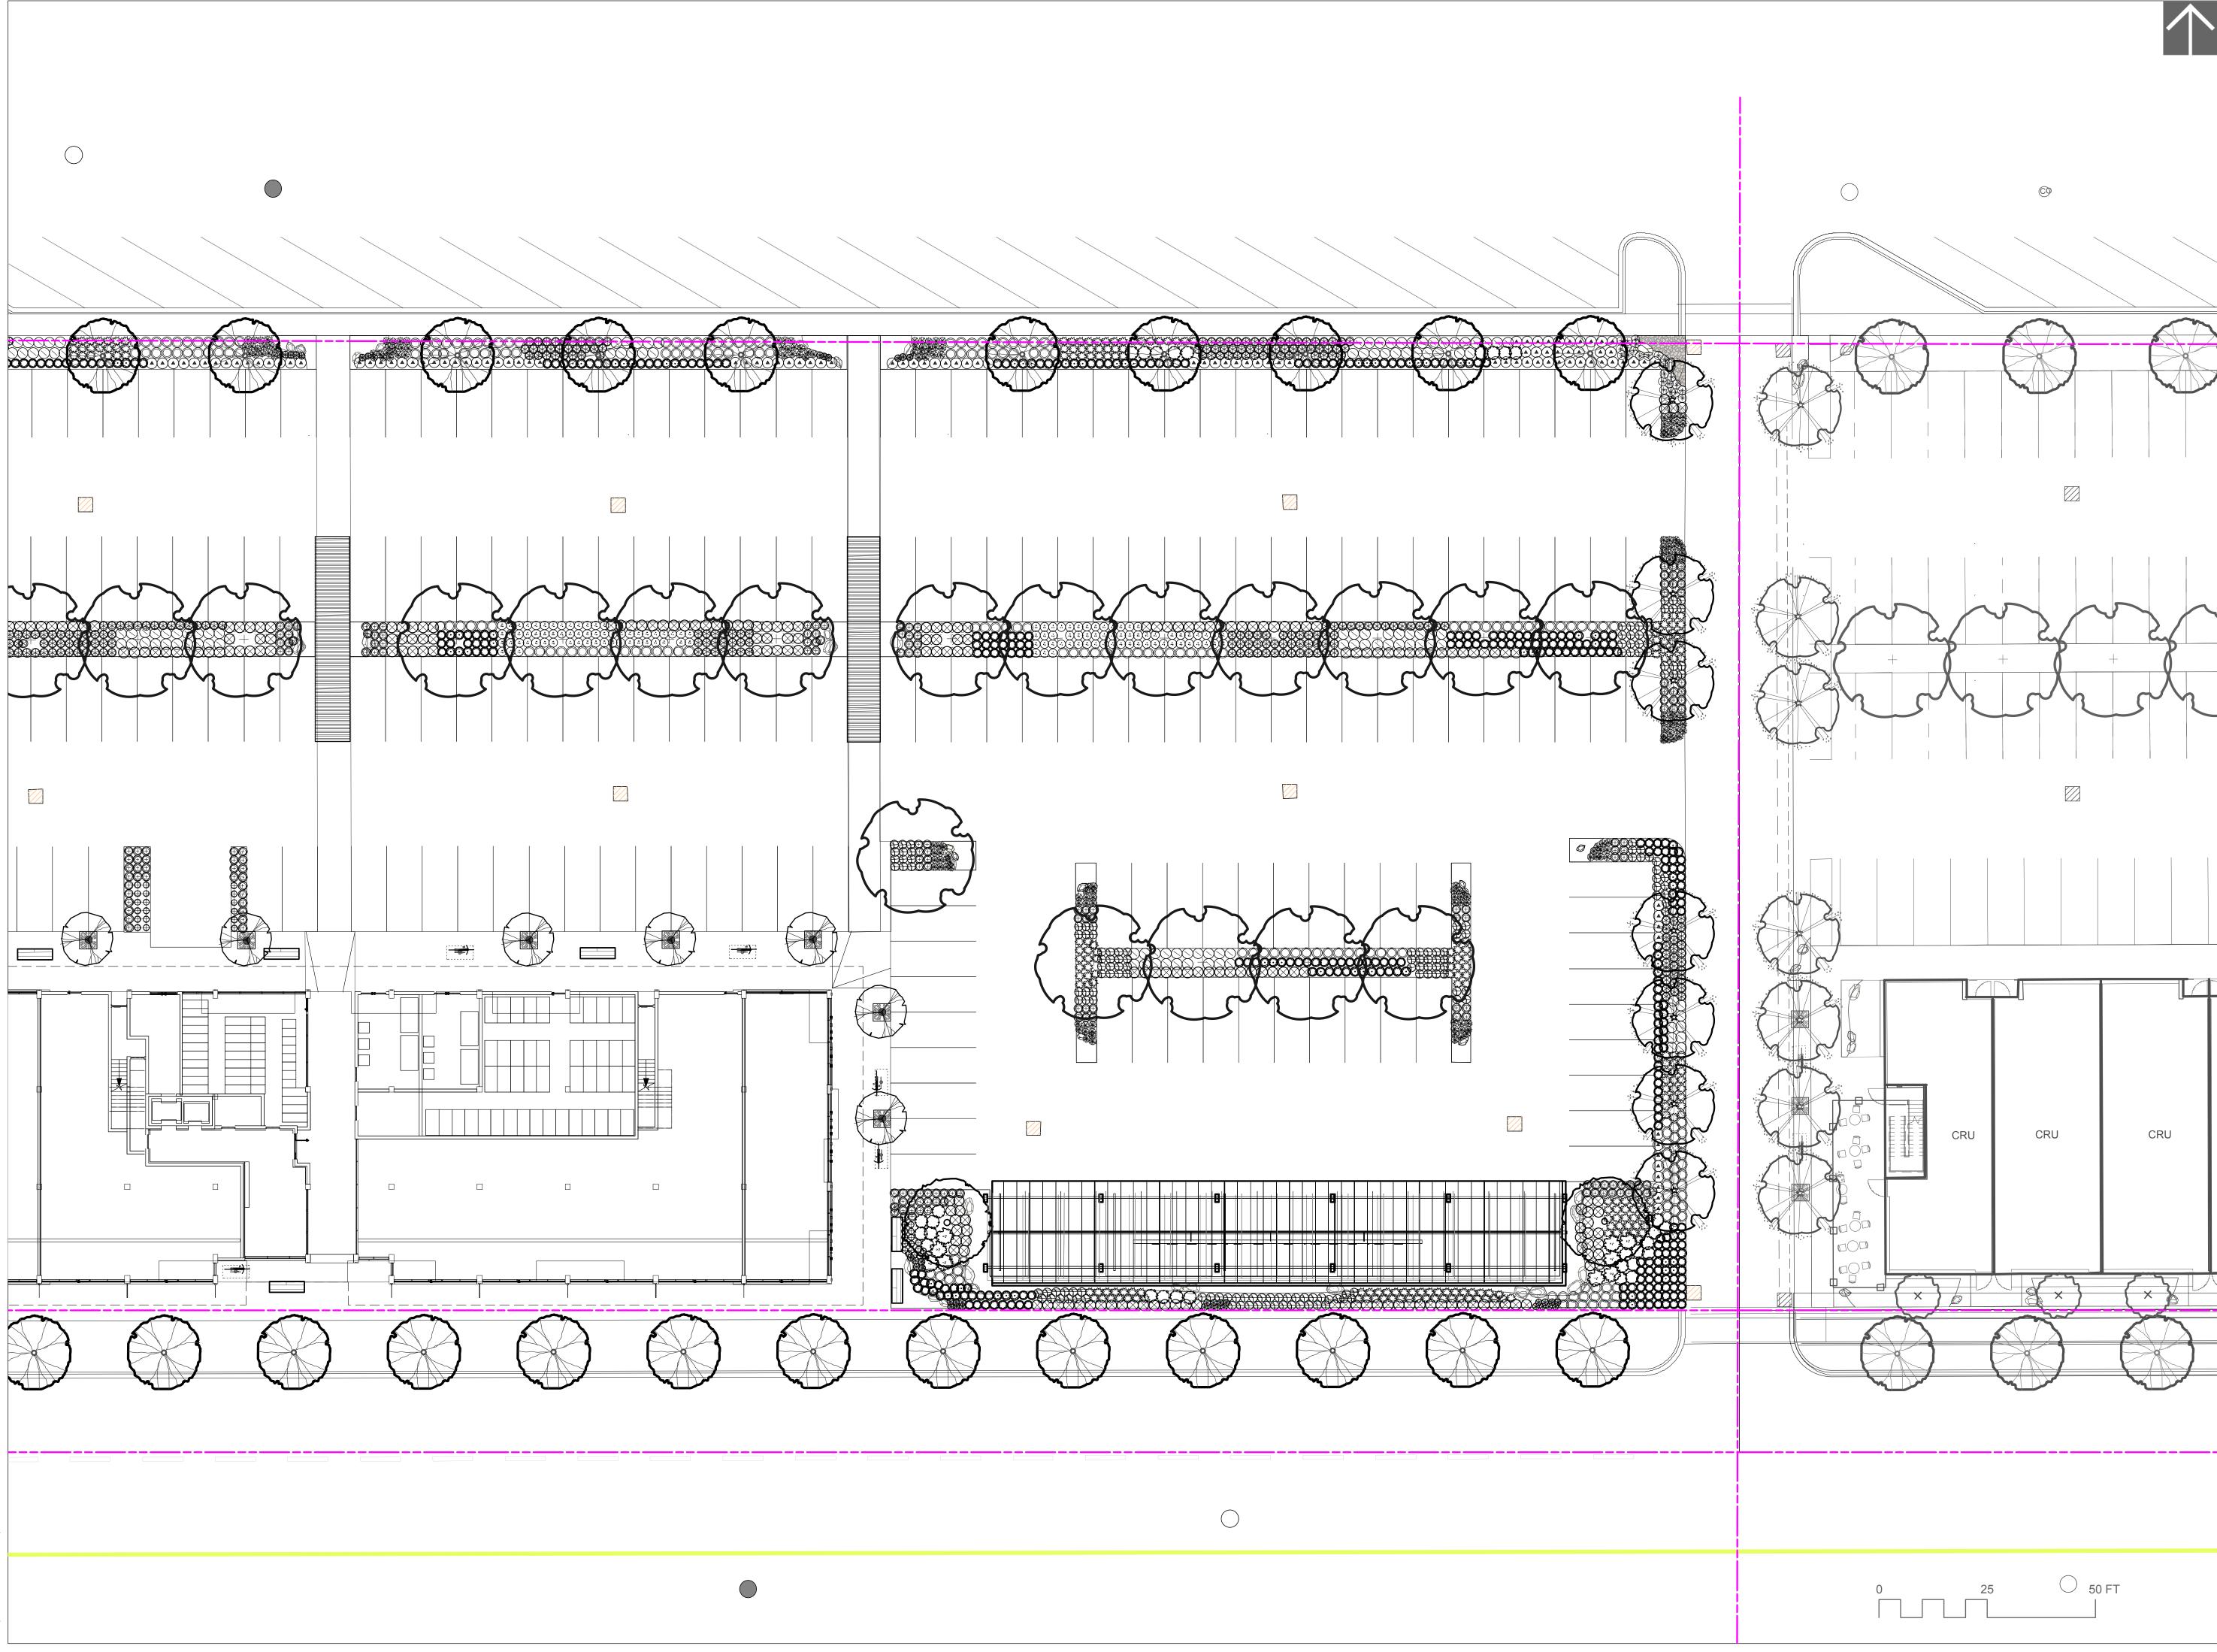


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LANDSCAPE PLANTING PLAN WEST SIDE



harp & Diamond Landscape Ar



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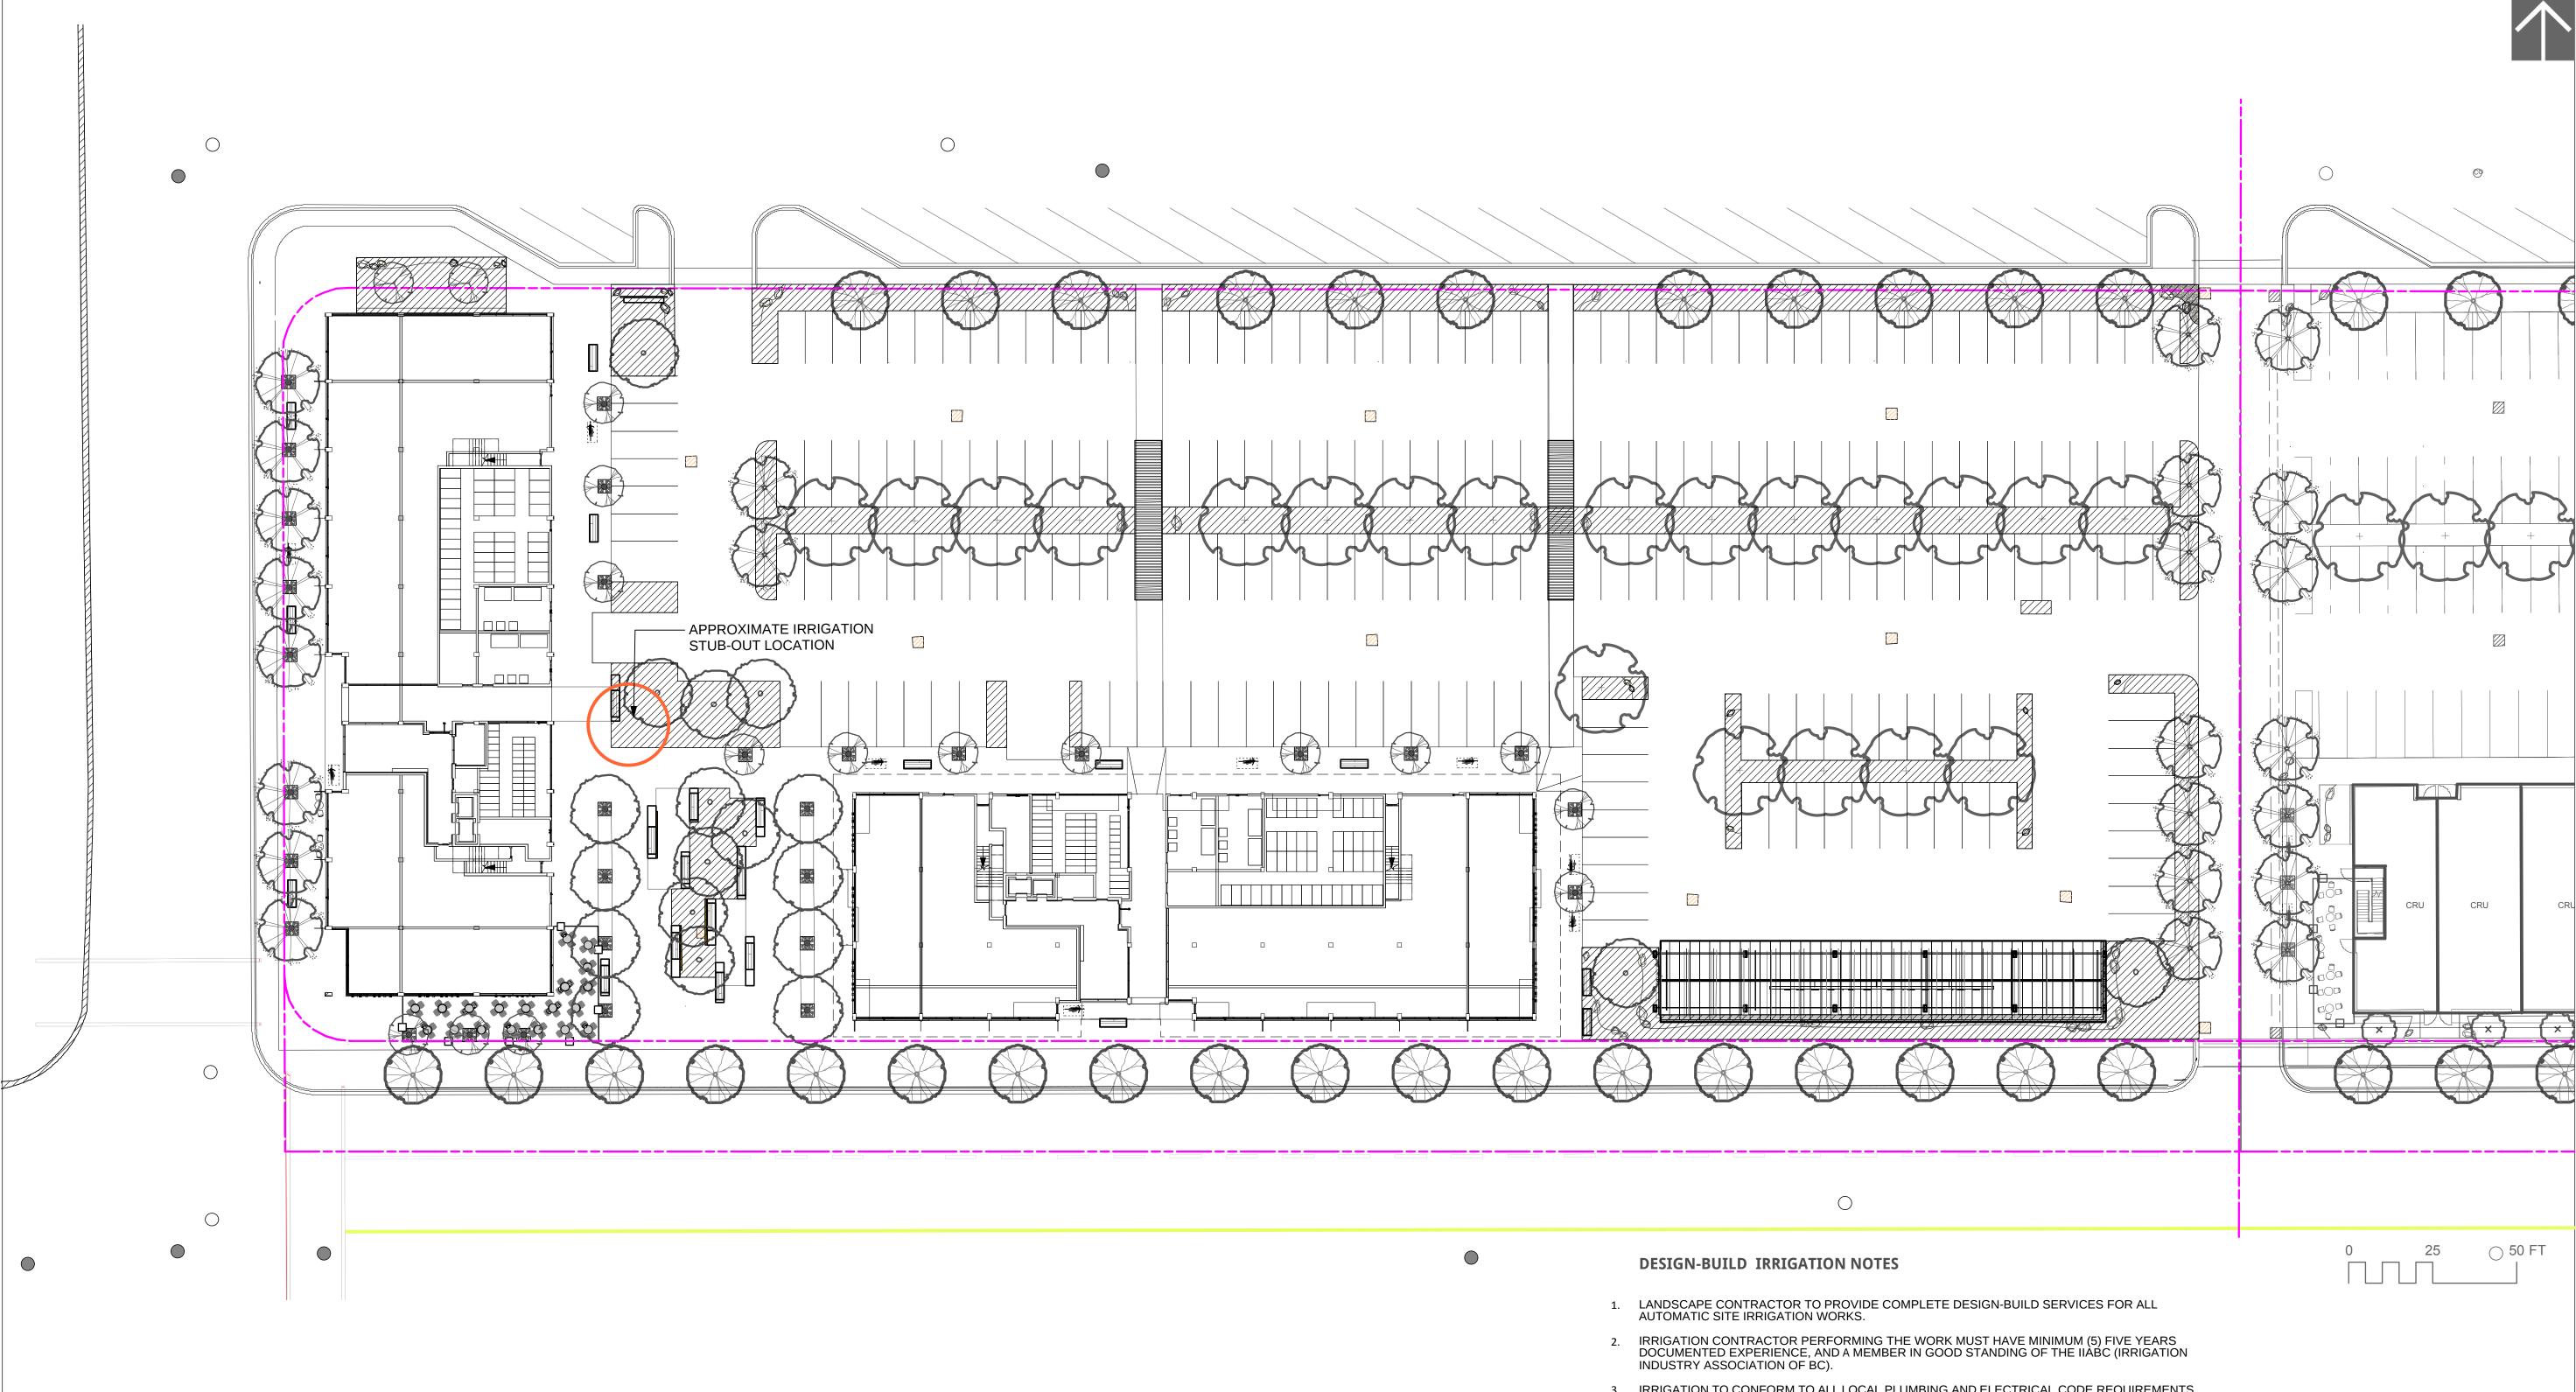


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LANDCAPE PLANTING PLAN EAST SIDE



- IRRIGATION TO CONFORM TO ALL LOCAL PLUMBING AND ELECTRICAL CODE REQUIREMENTS. CONTRACTOR IS RESPONSIBLE FOR COORDINATION WITH MECHANICAL AND ELECTRICAL CONSULTANTS AND TRADES.
- 4. IRRIGATION TO CONFORM TO ALL IIABC STANDARDS WITH THE FOLLOWING EXCEPTIONS: MATERIALS SECTION 8B: ALL PIPE TO BE MINIMUM CLASS 200 b. MATERIALS SECTION 5G: NO WIRE SMALLER THAN 14 GAUGE DIRECT BURIAL
- 5. COORDINATE WITH CIVIL CONTRACTOR TO PROVIDE PVC SLEEVING WHERE REQUIRED.
- 6. IRRIGATION STUB-OUTS AND HOSE BIBS PER MECHANICAL PLANS. 7. PROVIDE SHOP DRAWINGS FOR IRRIGATION LAYOUT TO CONSULTANT FOR REVIEW AND
- APPROVAL PRIOR TO FABRICATION AND INSTALLATION. INCLUDE SLEEVING, DRIP LINE, PIPE SIZE, VALVE BOXES, ETC., AND ALL IRRIGATION COMPONENT SPECIFICATIONS. VALVE BOXES TO BE LOCATED IN LOW-VISIBLE, PLANTED AREAS ONLY AND LOCATIONS TO BE APPROVED.
- HIGH EFFICIENCY IRRIGATION TECHNOLOGY TO BE EMPLOYED INCLUDE, BUT ARE NOT LIMITED TO: CENTRAL SHUT-OFF VALVE, HIGH EFFICIENCY DRIP IRRIGARTION LINES AND MOTION SENOR/RAIN DELAY CONTROLLER
- 9. TEST SYSTEM PRIOR TO COMPLETION OF LANDSCAPE WORKS TO ENSURE NO LEAKAGE AND SPECIFIED PSI IS MET. PROVIDE WRITTEN NOTICE THAT PRESSURE TESTING HAS MET STANDARDS (LEAKS SHALL NOT BE REPAIRED BY PATCHING).
- 10. PROVIDE COVERAGE AND CONTROLLER TEST WHEN SYSTEM IS COMPLETE AND MAKE ADJUSTMENTS AS REQUIRED.
- 11. PROVIDE AS-BUILT RECORD DRAWINGS TO SCALE SHOWING LOCATIONS OF ALL CONCEALED COMPONENTS, PIPING SYSTEM AND CONDUIT.
- 12. MAINTAIN AND OPERATE IRRIGATION PER MANUFACTURER'S RECOMMENDATIONS THROUGHOUT WARRANTY PERIOD WINTERIZE AS REQUIRED.
- 13. PROVIDE (3) COPIES OF INSTRUCTIONS MANUALS FOR OPERATION AND MAINTENANCE OF SYSTEM AND CONTROLS, SEASONAL ACTIVITY AND SHUTDOWN AND MANUFACTURER'S PARTS CATALOGUE.
- 14. INSTRUCT OWNER'S PERSONNEL IN THE OPERATION AND MAINTENANCE OF SYSTEM, INCLUDING ADJUSTING OF SPRINKLER HEADS. USE OPERATION AND MAINTENANCE MATERIAL AS BASIS FOR DEMONSTRATION.



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WATER CONSERVATION AND IRRIGATION PLAN

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