

April 30th, 2021 Our File: 2128

City of Kelowna 1435 Water St, Kelowna, BC V1Y 1J4

Attention: Aaron Thibeault, Planner II at City of Kelowna

Dear Mr. Thibeault,

Re: Development Permit / Rezoning for property located at 1875 Richter Street

This development proposal will adhere to the requirements of the RM3r zone as described in the City of Kelowna Zoning Bylaw No. 8000.

### **Project Description**

The current zoning for the site is RU6. With an OCP future land use designation of MRL, we are seeking a rezoning from RU6 to RM3r zone. The proposed project is a 3-storey multi-family residential development located at 1875 Richter Street. It is purpose built rental housing consisting of main level parking with 2 levels of residential above, providing 20 1-bedroom 1-bath rental units.

#### **Design Rationale**

The main building entrance will be off Richter Street, and vehicular access will be from a laneway off Rowcliffe Avenue, providing a secure entrance into an open-air parkade. In addition to vehicular parking, the main floor will provide plenty of bike parking. We have chosen to provide the bonus long-term bicycle parking for this project considering its proximity to surrounding transportation corridors. The property is flanked by bicycle lanes on both Richter Street and Sutherland Avenue, making this a very convenient location for those biking to and from work.

The material selection consists of a light-colored stucco, horizontal wood-patterned siding, and brick. These materials are complimented by the incorporation of glass along the balcony railings, full-height glass wall dividing the front elevation of the building, and vertical wood elements to provide security and screening of the parking. Additionally, to add texture to the front entry, we have created a pattern within the brickwork to create more visual appeal along Richter Street. The pedestrian entrance off Richter Street serves to create an inviting focal point surrounded by this glass and textured brick façade. In conjunction with the proposed landscaping, a thoughtful interface between the street and the building is created.

Continued ...



The garbage will be enclosed within the parking garage with easy access to the laneway but screened from neighbouring properties.

We are seeking no variances as we feel that the development has been designed appropriately for the site and location.

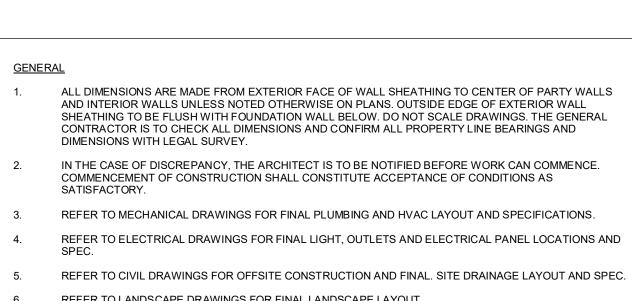
I trust that you will find our application in good order. Please contact our office if you require any further information.

Kind Regards,

NOvation Architecture Ltd.

Paul M. Schuster, Architect
AIBC, CAB, MRAIC and NCARB Certified

(250) 718 - 1302 paul@novationarchitecture.com



**GENERAL NOTES:** 

REFER TO MECHANICAL DRAWINGS FOR FINAL PLUMBING AND HVAC LAYOUT AND SPECIFICATIONS.

REFER TO LANDSCAPE DRAWINGS FOR FINAL LANDSCAPE LAYOUT. REFER TO STRUCTURAL DRAWINGS FOR FINAL WALL/FLOOR/ROOF/COLUMN LAYOUT AND SPECIFICATIONS.

ASSURANCE / COMPLIANCE REQUIREMENTS THE CURRENT BCBC 2018, IT'S REQUIREMENTS AND ALL AGENDA, SHALL FORM AN INTEGRAL PART OF

THESE DRAWINGS. ALL CONSTRUCTION MATERIALS AND PROCEDURES SHALL CONFIRM TO THESE

ALL WORK TO CONFORM TO LOCAL BYLAWS AND DEVELOPMENT PERMIT REQUIREMENTS.

ALL DRAWINGS ARE TO BE READ AS A COMPLETE SET IN CONJUNCTION WITH SPECIFICATIONS AND CIVIL, STRUCTURAL, MECHANICAL, ELECTRICAL, AND LANDSCAPE DRAWINGS AS APPLICABLE. ALL WORK WILL BE SUBJECT TO FIELD REVIEW BY THE ARCHITECT AND OR OTHER REGISTERED

PROFESSIONAL AND BY THE CONSULTING ENGINEERS NAMED ON THESE DRAWINGS TO MEET THE

MUNICIPAL LETTERS OF ASSURANCE / COMPLIANCE REQUIREMENTS. ALL WORK MUST MEET THE APPROVAL OF THE PROFESSIONAL CONSULTANTS.

ALL WORK MUST MEET THE STANDARDS OF THE BC TRADE ASSOCIATIONS GOVERNING EACH TRADE

STARTING WORK ON THIS PROJECT BY ANY SUB-CONTRACTOR MEANS THAT THE ABOVE REQUIREMENTS HAVE BEEN REVIEWED AND NO EXTRA CLAIM FOR COST WILL BE PUT FORWARD TO MEET THE PROFESSIONAL CONSULTANTS FIELD REVIEW REQUIREMENTS.

THE SUB-CONTRACTORS ARE RESPONSIBLE FOR SITE SAFETY AND TO MEET ALL REQUIREMENTS OF THE WORKERS COMPENSATION BOARD.

ALL SUB-CONTRACTORS WILL BE REQUIRE TO ACKNOWLEDGE COMPLIANCE WITH ABOVE CONDITIONS BY SIGNING A COPY OF THESE REQUIREMENTS WHICH MUCH ACCOMPANY THEIR QUOTATION.

GENERAL CONTRACTOR IS TO KEEP RECORD AND PROVIDE ARCHITECT WITH COPIES OF MUNICIPAL INSPECTION SLIPS.

THE CONTRACTOR / CLIENT IS TO INFORM THE ARCHITECT IN WRITING 24 HOURS PRIOR TO STARTING CONSTRUCTION OF THE PROJECT.

THE SUB-CONTRACTOR IS TO CHECK ALL DIMENSIONS AFFECTING HIS TRADE AND IN THE CASE OF DISCREPANCY THE CONTRACTOR IS TO BE NOTIFIED BEFORE WORK CAN COMMENCE.

THE CONTRACTOR IS TO NOTIFY THE ARCHITECT 24 HOURS PRIOR TO A REQUIRED INSPECTION.

### CODE ANALYSIS / ZONING: SYMBOL LEGEND:

**B.C. BUILDING CODE (2018) ANALYSIS BUILDING SECTION** 

SECTION NUMBER

**WALL SECTION** 

SECTION NUMBER

- DETAIL NUMBER

DETAIL NUMBER

SCALE: 1/8" = 1'-0"

Door Tags

Window Tags

**Assembly Tags** 

0' - 0" x 0' - 0" DOOR SIZE

**DETAIL** 

LOCATION OF SECTION DRAWING

LOCATION OF SECTION DRAWING

LOCATION OF DETAIL DRAWING

- LOCATION OF DETAIL DRAWING

LOCATION OF FIRST OCCURANCE

WINDOW TYPE -

ASSEMBLY TYPE -

SEE CONSTRUCTION SCHEDULE

SEE WINDOW DETAILS

MAJOR OCCUPANCY CLASSIFICATION: PART 3 **GOVERNING CODE PART: GRADE ELEVATION:** 346.18m **BUILDING HEIGHT:** 3 STOREY FACING NO. OF STREETS: 2 STREETS **BUILDING AREA:** 737m<sup>2</sup> **SPRINKLERS:** NONSPRINKLERED

BASIC CODE CLASSIFICATION:

3.2.2.53 GROUP C, UP TO 3 STORIES, NONSPRINKLERED - MAX. - MAX. AREA 750m<sup>2</sup> IF 3 STOREYS **COMBUSTIBLE OR NON-COMBUSTIBLE** - FLOORS, MEZZANINES, AND LOADBEARING: (45 MIN. FRR)

FIRE ALARM REQUIRED: 3.2.4.1 CENTRAL MONITORING: 3.2.4.7.(4) YES STANDPIPE REQUIRED: **HIGH RISE BUILDING: SMOKE CONTROL MEASURES: EMERGENCY GENERATOR REQUIRED:** NO **EMERGENCY POWER SUPPLY DURATION:** 1/2 Hrs **EMERGENCY LIGHTING: 3.2.7.3** YES **EXIT SIGNS REQUIRED: 3.4.5.1** FIRE PUMPS REQUIRED: MINOR RELAXATION/EQUIVALENCIES REQUIRED: MINOR RELAXATION/EQUIVALENCIES ACCEPTED: N/A **INTERCONNECTED FLOOR SPACE: 3.2.8.2.(6)** 

BCBC 2018 3.4.2.5. MAX. TRAVEL DISTANCE

EXISTING ZONING = RU6 PROPOSED ZONING = RM3r

SITE AREA =  $1,299.1m^2$ 

F.A.R. = 0.75 AMENITY BONUS F.A.R. = 0.05

TOTAL =  $0.80 \times 1,299.1 \text{m}^2$  $= 1,039.2m^2 (11,185.9ft^2)$ 

(ALLOWABLE = 50% w/ AMENITY BONUS)PROVIDED = 24 STALLS TOTAL REQUIRED = 330m<sup>2</sup> TOTAL PROVIDED = 384m<sup>2</sup>

BUILDING SITE COVERAGE = 48%

OVERALL SITE COVERAGE = 58% (ALLOWABLE = 60%)

20 UNITS x 1.25 STALLS = 25 STALLS 20 UNITS x 0.14 = 3 VISTOR STALLS - 10% STALLS (RENTAL) - 5 STALLS (BONUS-BIKE PARKING) TOTAL = 20 STALLS

**CONTEXT SITE PLAN:** 

**BIKE PARKING** REQ'D SHORT-TERM = 6 STALLS PROVIDED = 6 STALLS REQ'D BONUS LONG-TERM = 20 STALLS

MAX. HEIGHT = 10m OR 3 STOREYS ACTUAL HEIGHT = 10m AND 3 STOREYS

SETBACKS FRONT = 4.5m; SIDE = 4.0m; REAR = 3.0m



**DRAWING INDEX: CONSULTANTS:** 

<u>ARCHITECTURAL</u> NOVATION ARCHITECTURE LTD. 302-2237 LECKIE ROAD KELOWNA, BC V1X 6Y5 TEL. (236) 420-4144 FAX. (250) 000-0000

APLIN & MARTIN CONSULTANTS LTD. 1258 ELLIS STREET KELONWA, BC V1Y 1Z4 TEL. (250) 448-0157

OUTLAND DESIGN 303 - 590 K.L.O. ROAD KELOWNA, BC V1Y 7S2 TEL. (250) 868-9270

ARCHITECTURAL DRAWING LIST

NAME A0.00 **COVER SHEET** A1.00 SITE PLAN A2.00 **FOUNDATION PLAN** A2.01 MAIN FLOOR PLAN SECOND FLOOR PLAN A2.03 THIRD FLOOR PLAN A2.04 **ROOF PLAN** A2.05 OVERALL ROOF PLAN A3.00 **EXTERIOR ELEVATIONS** A3.01 **EXTERIOR ELEVATIONS** 

**BUILDING SECTIONS** 

DOOR & WINDOW SCHEDULE

A4.00

A5.00

**ILLUSTRATION:** 



20210430 ISSUED FOR DEVELOPMENT DESCRIPTION REVISIONS

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302 - 2237 LECKIE ROAD KELOWNA BC V1X 6Y5

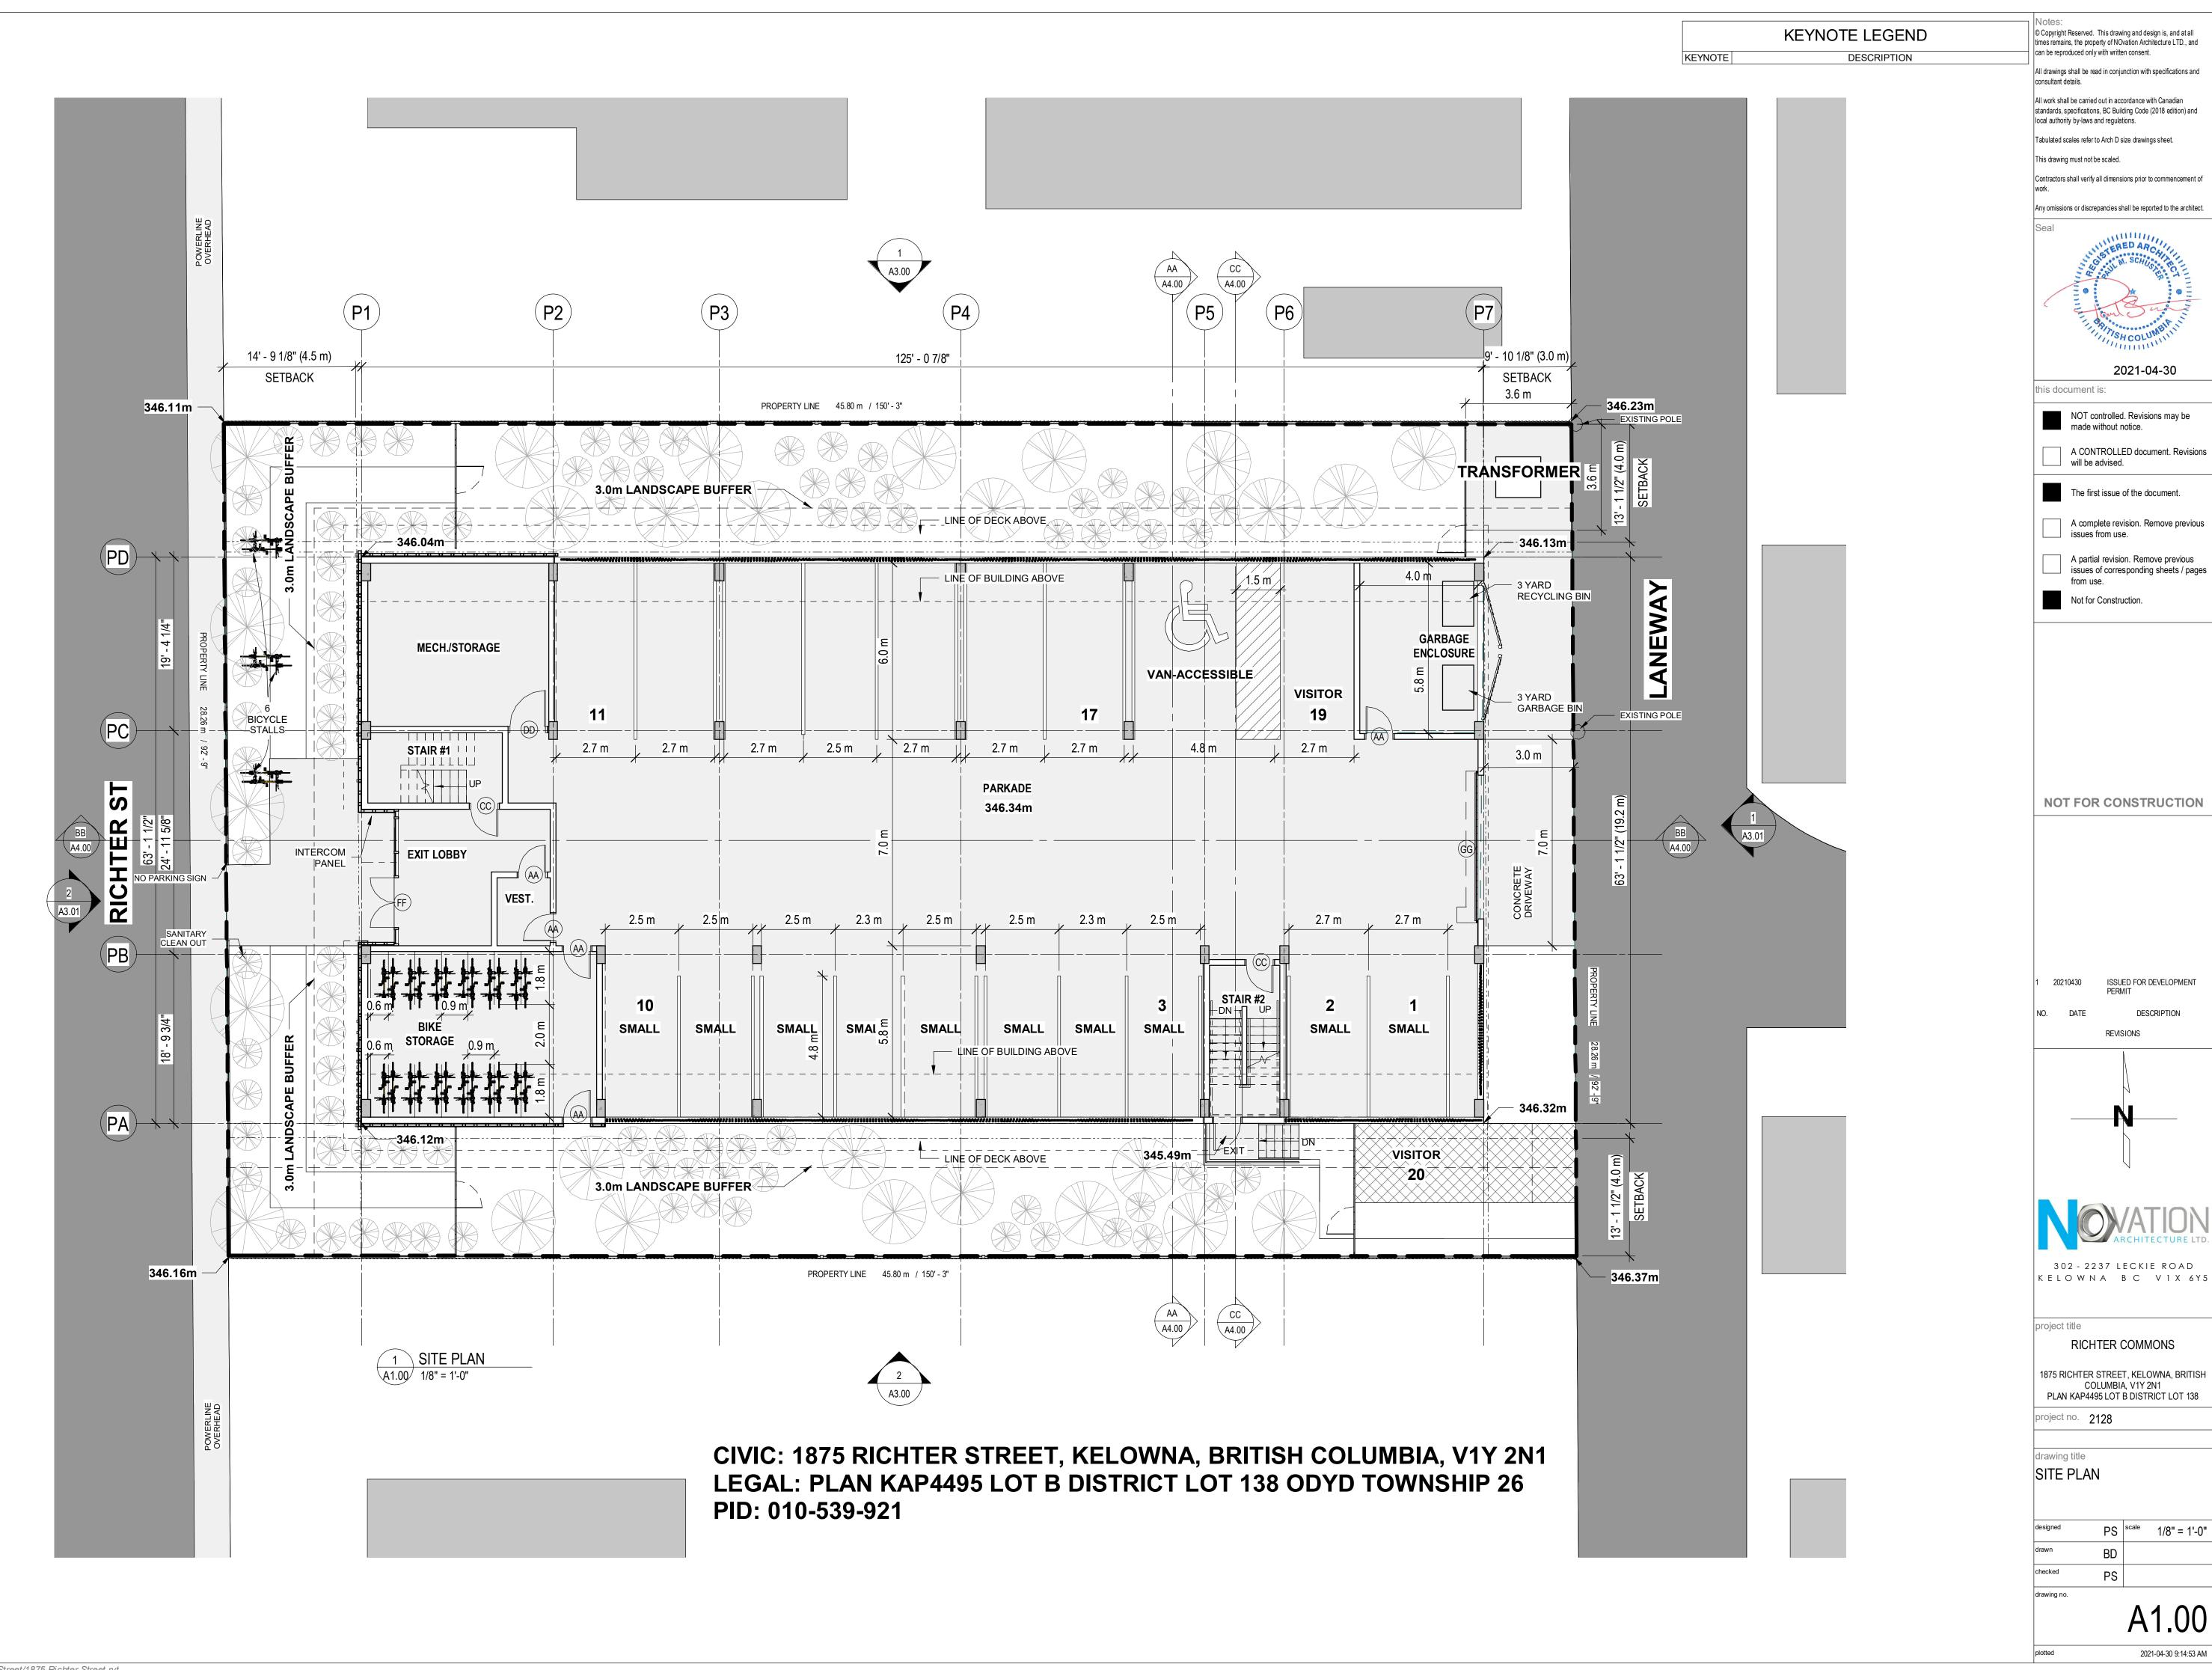
RICHTER COMMONS

875 RICHTER STREET, KELOWNA, BRITISH COLUMBIA, V1Y 2N1 PLAN KAP4495 LOT B DISTRICT LOT 138

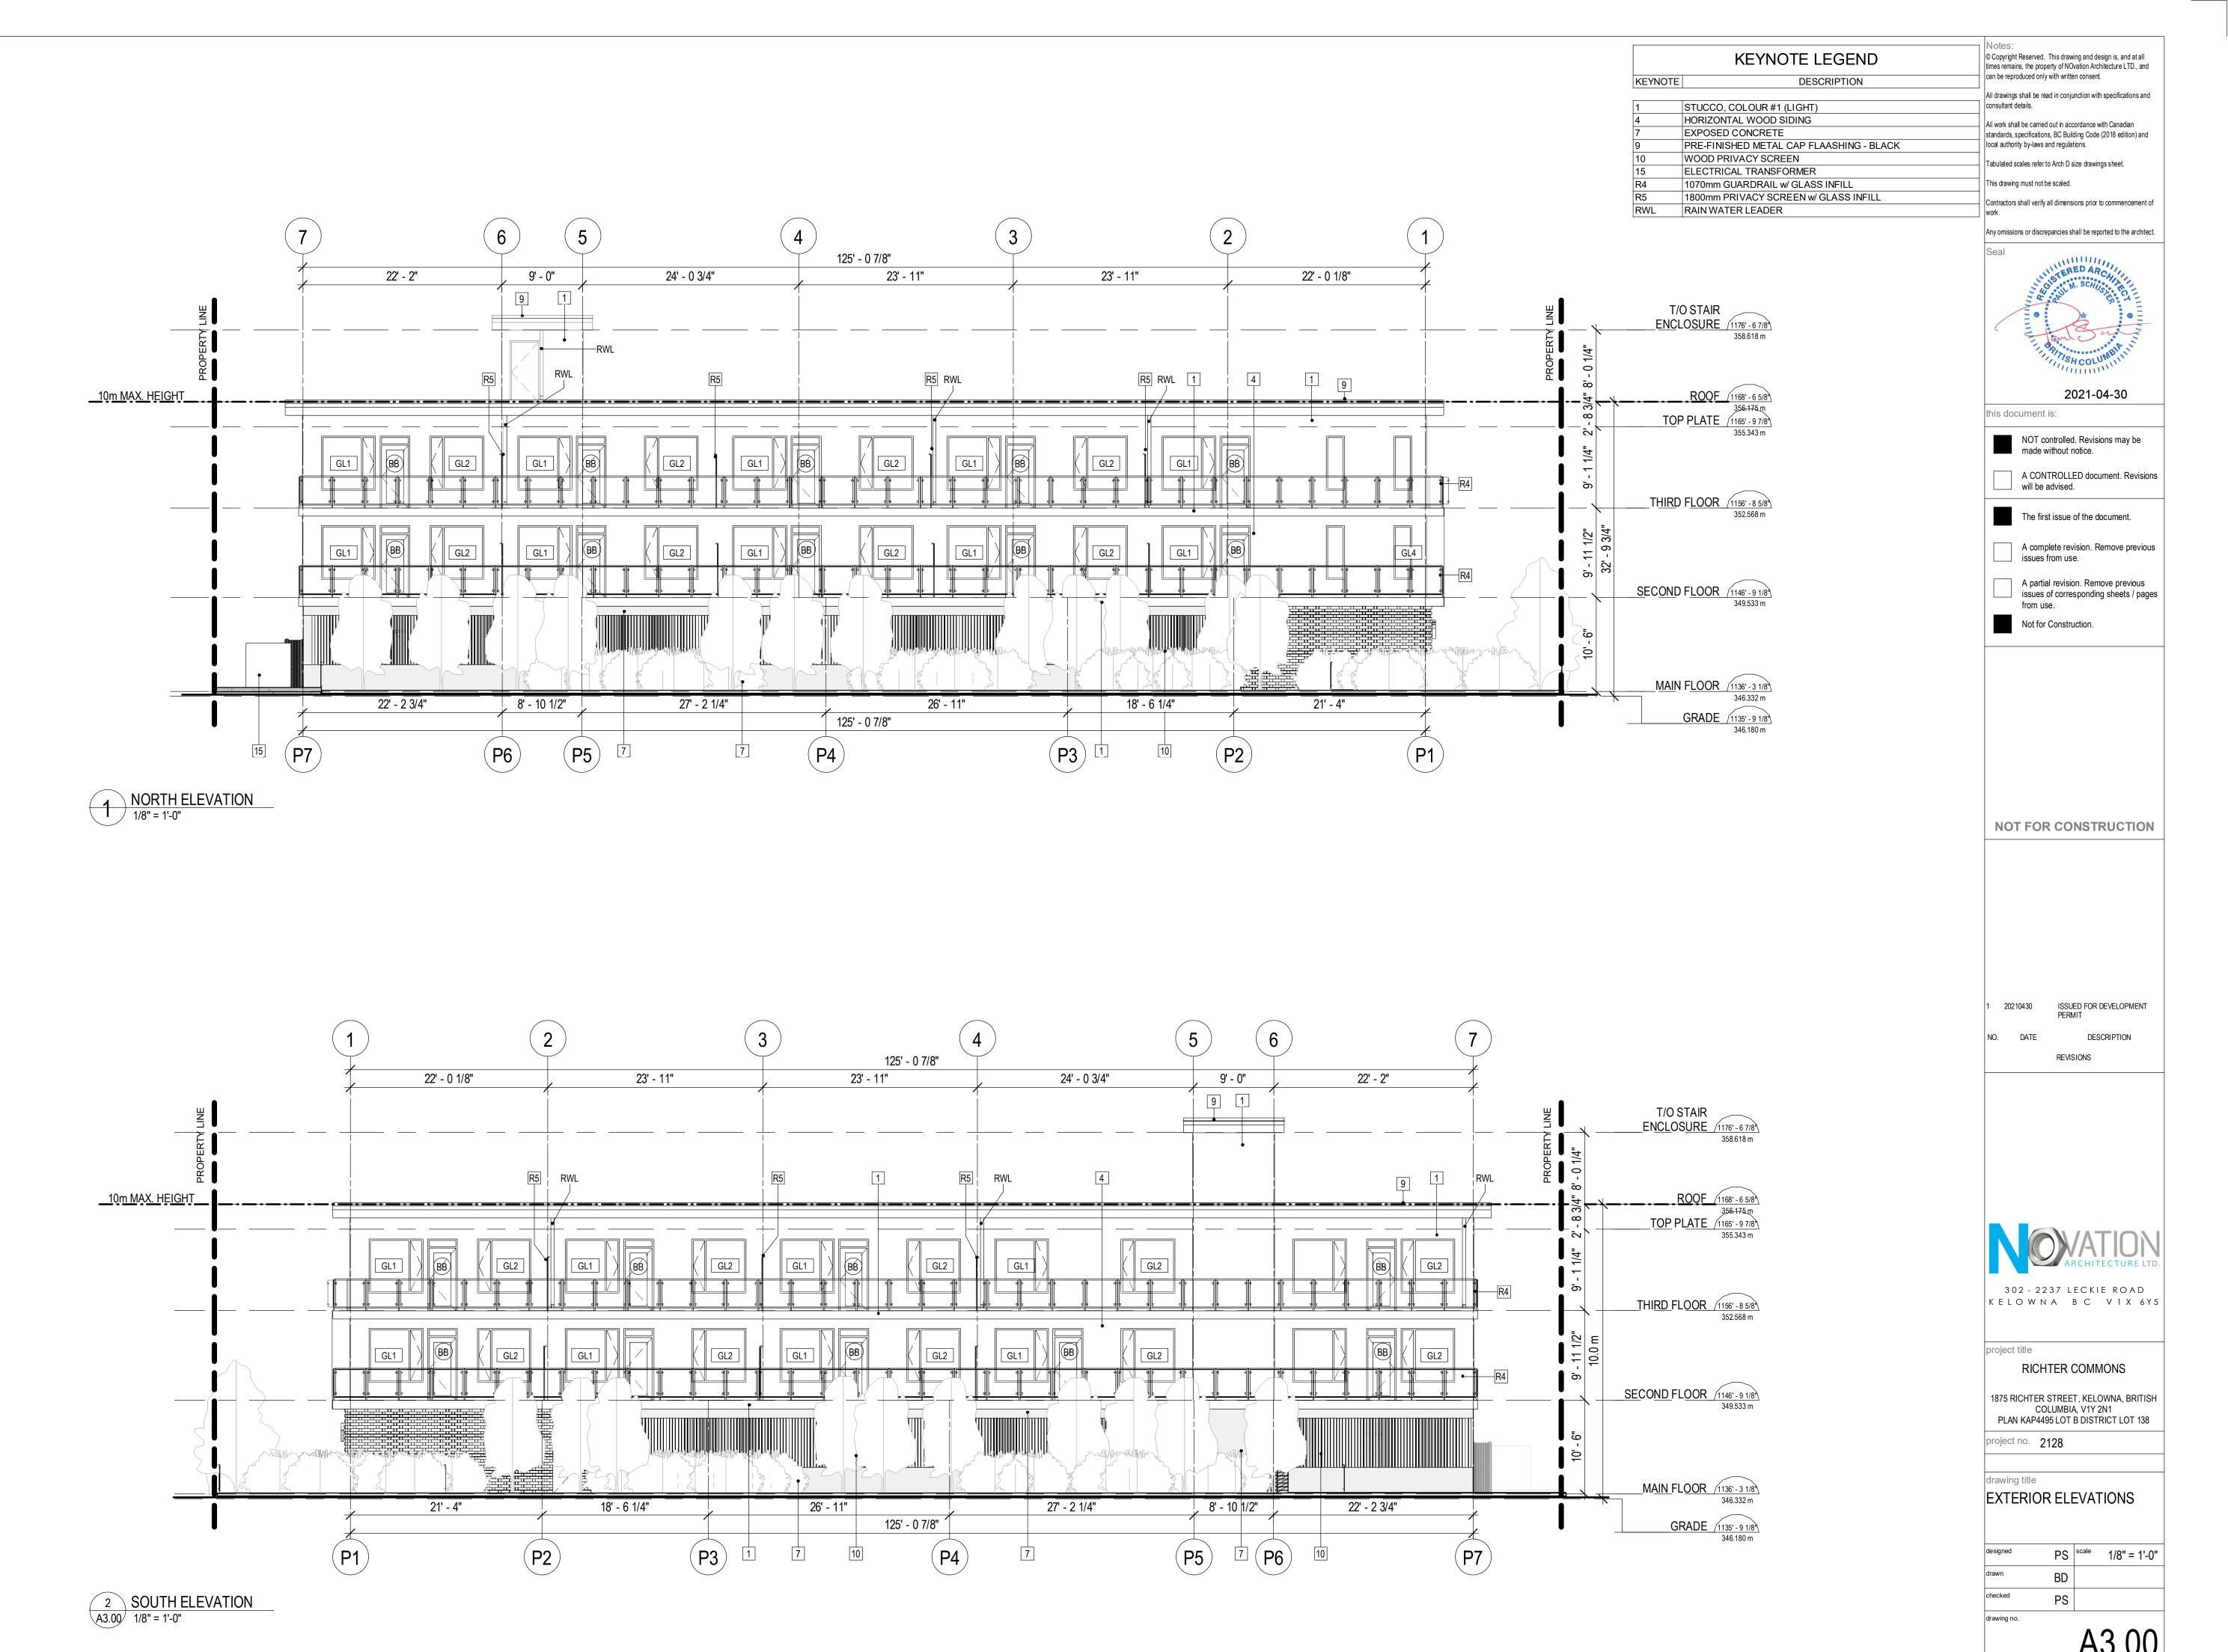
COVER SHEET

1" = 1'-0"

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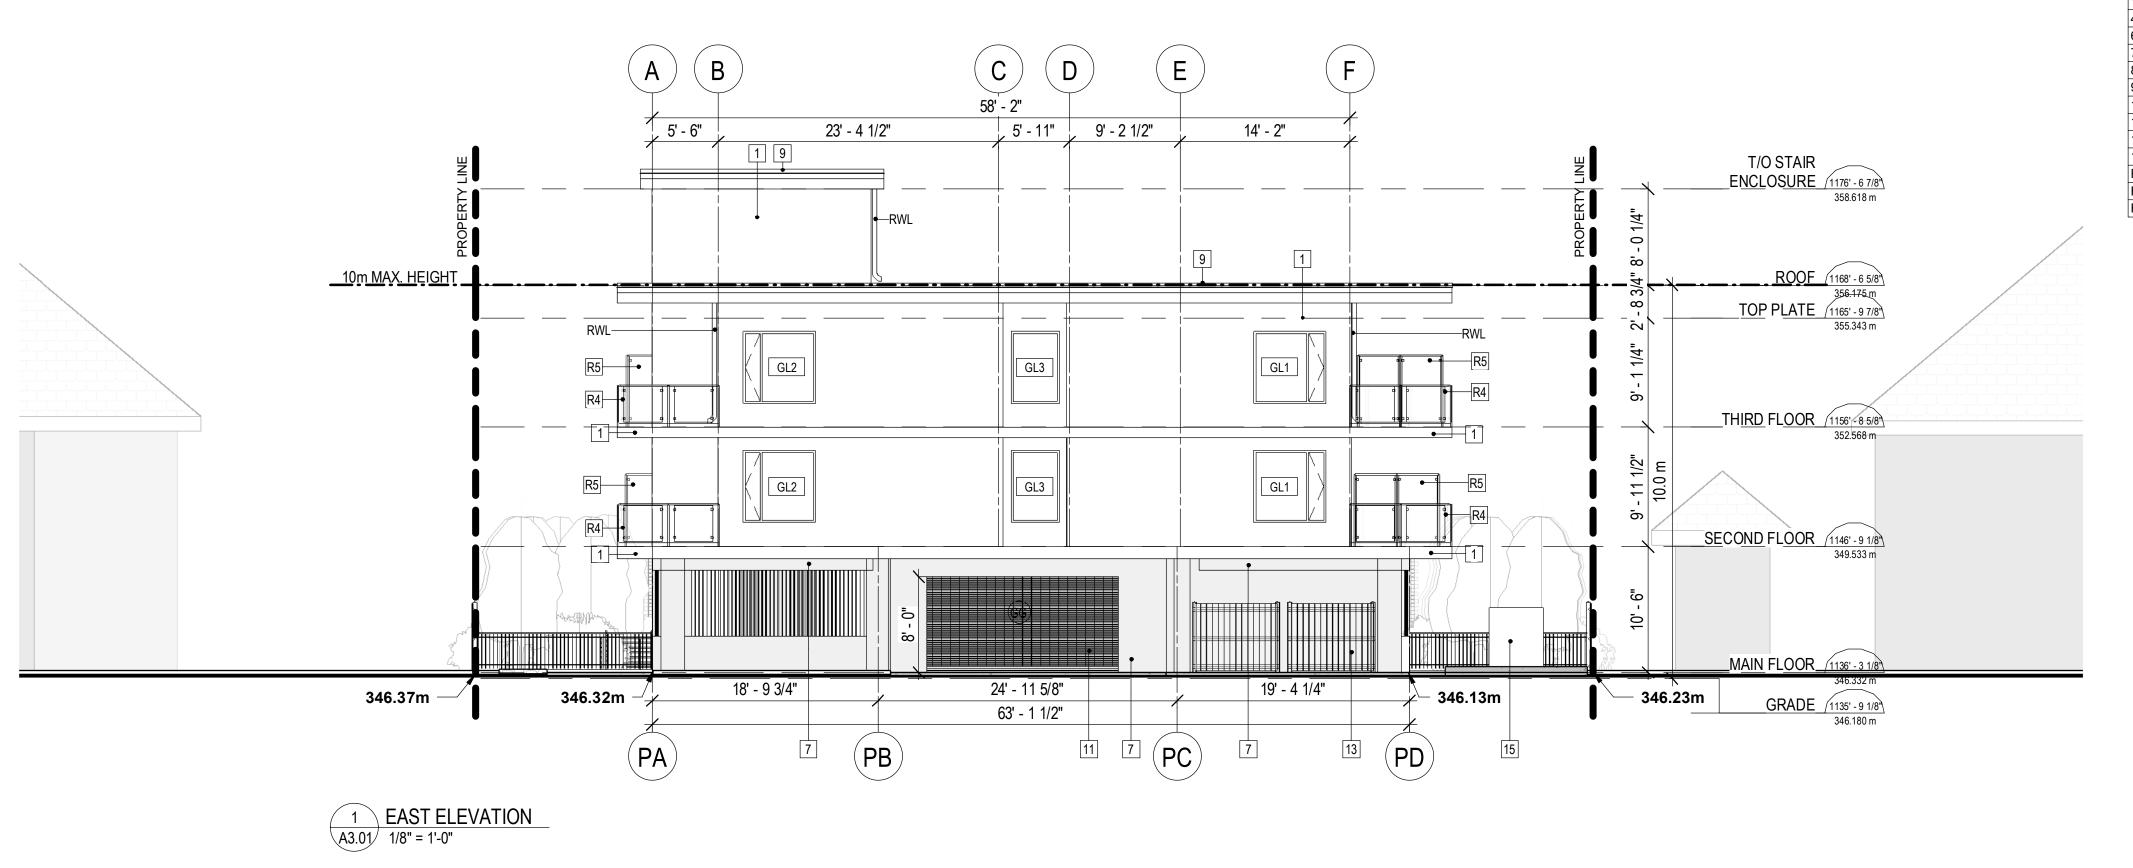


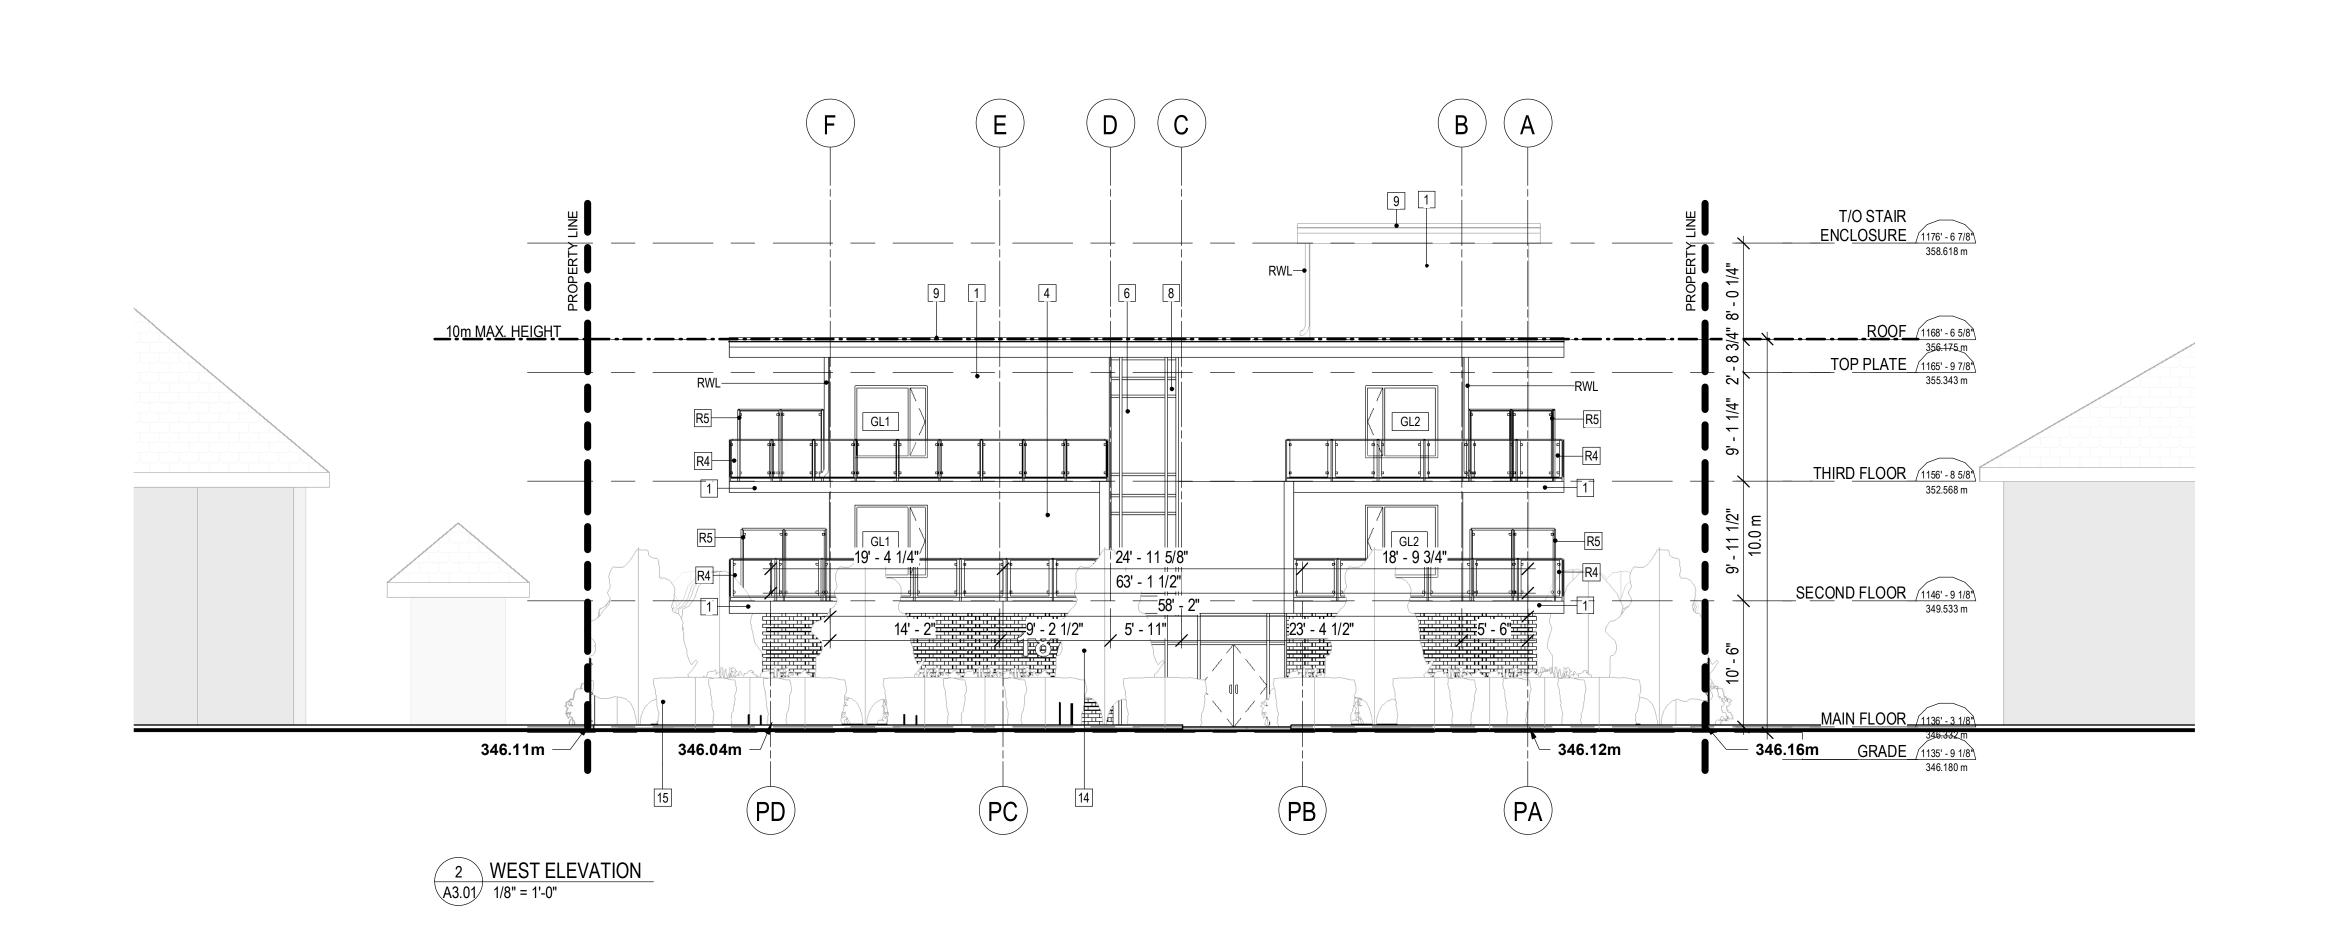
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Project File Name and Location: BIM 360://1875 Richter Street/1875 Richter Street.rvt

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| KEYNOTE | DESCRIPTION                                 | can be reproduced only with written consent.  |  |
|         |   | All drawings shall be read in conjunction with specifications and   |  |
| 1       | STUCCO, COLOUR #1 (LIGHT)                   | consultant details.   |  |
| 4       | HORIZONTAL WOOD SIDING                      | All work shall be carried out in accordance with Canadian   |  |
| 6       | CLEAR GLAZING                               | standards, specifications, BC Building Code (2018 edition) and  |  |
| 7       | EXPOSED CONCRETE                            | local authority by-laws and regulations.  |  |
| 8       | SPANDREL PANEL                              | Tabulated scales refer to Arch D size drawings sheet.   |  |
| 9       | PRE-FINISHED METAL CAP FLAASHING - BLACK    | Tabalated could foot to file in a size didning of lock.   |  |
| 11      | OVERHEAD SECURITY GILLE                     | This drawing must not be scaled.  |  |
| 13      | WASTE ENCLOSURE GATE                        | Contractors shall verify all dimensions prior to commencement of  |  |
| 14      | SIGNAGE; PROVIDE POWER AND REQUIRED BACKING | work.   |  |
| 15      | ELECTRICAL TRANSFORMER                      |   |  |
| R4      | 1070mm GUARDRAIL w/ GLASS INFILL            | Any omissions or discrepancies shall be reported to the architect.  |  |
| R5      | 1800mm PRIVACY SCREEN w/ GLASS INFILL       | Seal  |  |
| RWL     | RAIN WATER LEADER                           | Seal Seal   |  |
|         |   | M. SCHU   |  |

Any omissions or discrepancies shall be reported to the architect.

Seal

2021-04-30

this document is:

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The first issue of the document.

A complete revision. Remove previous

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RICHTER COMMONS

1875 RICHTER STREET, KELOWNA, BRITISH COLUMBIA, V1Y 2N1 PLAN KAP4495 LOT B DISTRICT LOT 138

project no. 2128

drawing title

EXTERIOR ELEVATIONS

designed PS scale 1/8" = 1'-0"

drawn BD

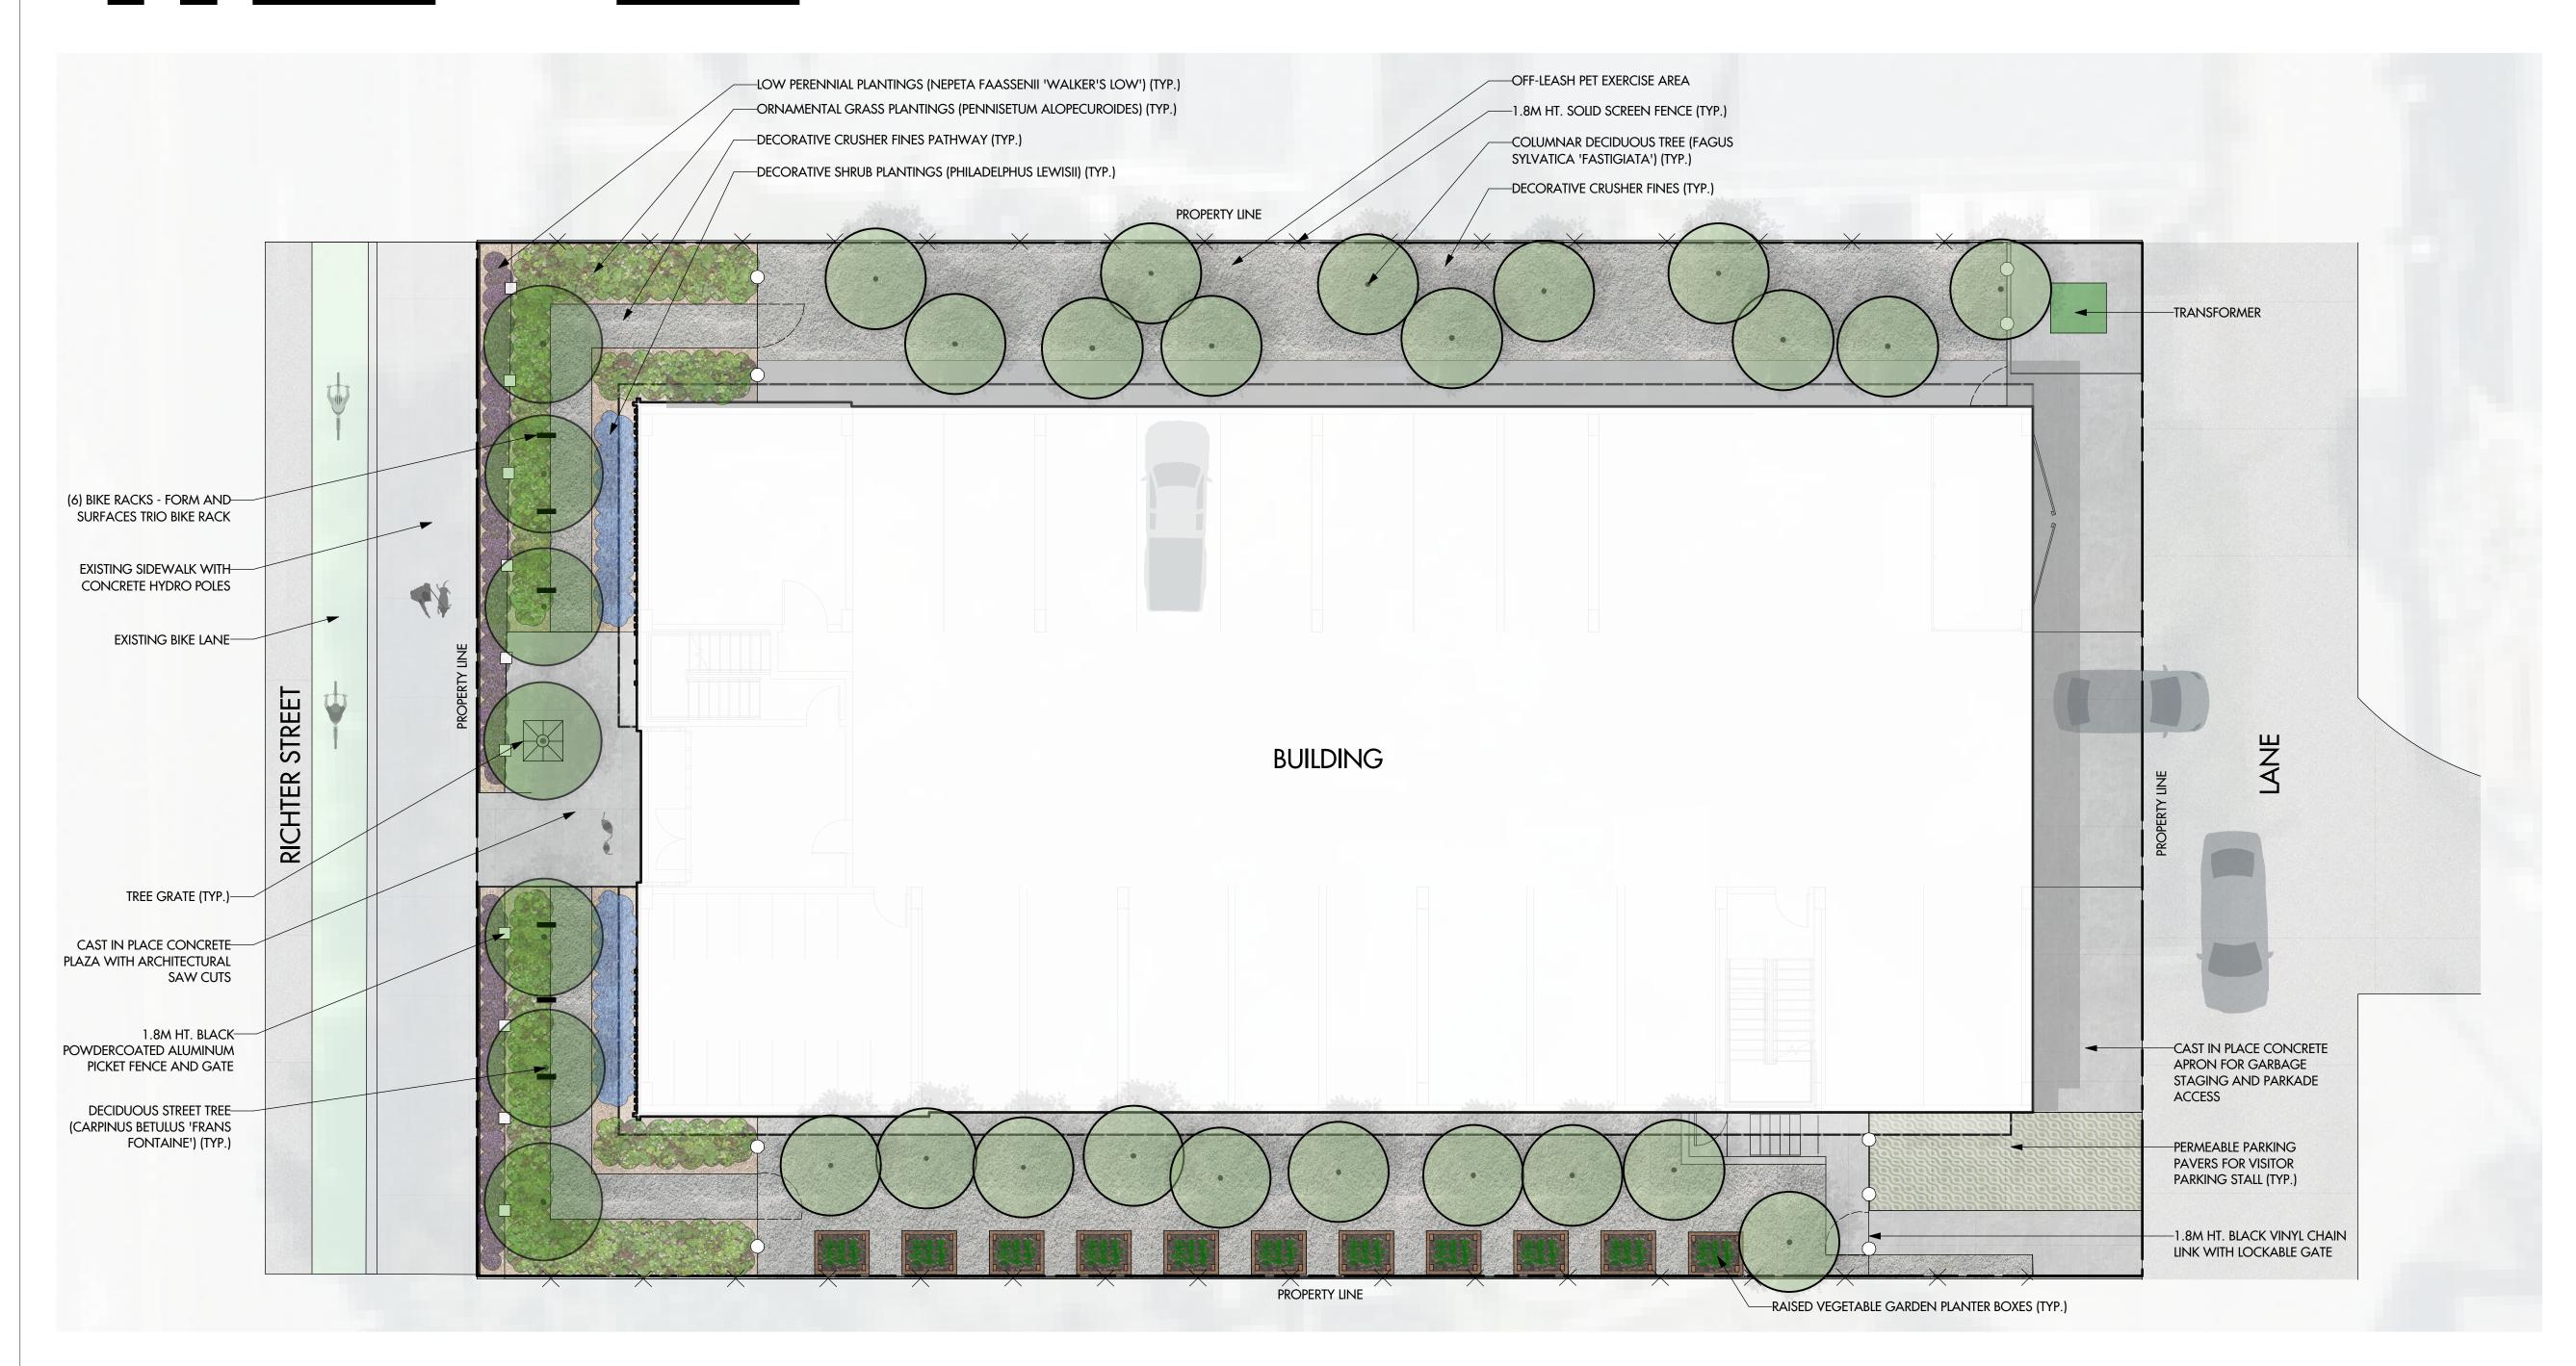
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| BOTANICAL NAME                        | COMMON NAME             | QTY | SIZE/SPACING & REMARKS        |
|---------------------------------------|-------------------------|-----|-------------------------------|
| TREES                                 |                         |     |                               |
| CARPINUS BETULUS 'FRANS FONTAINE'     | FRANS FONTAINE HORNBEAM | 7   | 6cm CAL.                      |
| FAGUS SYLVATICA 'FASTIGIATA' (DAWYCK) | PYRAMIDAL GREEN BEECH   | 22  | 6cm CAL.                      |
| SHRUBS                                |                         |     |                               |
| PHILADELPHUS LEWISII                  | WILD MOCK ORANGE        | 10  | #02 CONT. /2.4M O.C. SPACING  |
| PERENNIALS, GRASSES & GROUNDCOVERS    |                         |     |                               |
| NEPETA FAASSENII 'WALKER'S LOW'       | CATMINT                 | 58  | #01 CONT. /0.60M O.C. SPACING |
| PENNISETUM ALOPECUROIDES              | FOUNTAIN GRASS          | 21  | #01 CONT. /1.0M O.C. SPACING  |

## **NOTES**

- 1. PLANT MATERIAL AND CONSTRUCTION METHODS SHALL MEET OR EXCEED THE CANADIAN LANDSCAPE STANDARD.
- 2. ALL SOFT LANDSCAPE AREAS SHALL BE WATERED BY A FULLY AUTOMATIC TIMED UNDERGROUND IRRIGATION SYSTEM.

3. TREE AND SHRUB BEDS TO BE DRESSED IN A MINIMUM 75mm DOUGLAS RED FIR MULCH, AS SHOWN IN PLANS. DO NOT PLACE WEED MAT UNDERNEATH TREE AND SHRUB BEDS.

- 4. TREE AND SHRUB BEDS TO RECEIVE A MINIMUM 300mm DEPTH TOPSOIL PLACEMENT.
- 6. SITE GRADING AND DRAINAGE WILL ENSURE THAT ALL STRUCTURES HAVE POSITIVE DRAINAGE AND THAT NO WATER OR LOOSE IMPEDIMENTS WILL BE DISCHARGED FROM THE LOT ONTO ADJACENT PUBLIC, COMMON, OR PRIVATE PROPERTIES.



303-590 KLO Road Kelowna, BC V1Y 7S2 T (250) 868-9270 www.outlanddesign.ca



PROJECT TITLE

# 1875 RICHTER STREET DEVELOPMENT

Kelowna, BC

DRAWING TITLE

# CONCEPTUAL LANDSCAPE PLAN

ISSUED FOR / REVISION

| 2 3 | 21.04.14 | Review |
|-----|----------|--------|
|     |          |        |
| 4   |          |        |
| 5   |          |        |

| PROJECT NO | 21-045        |
|------------|---------------|
| DESIGN BY  | FB            |
| DRAWN BY   | MC            |
| CHECKED BY | FB            |
| DATE       | APR. 14, 2021 |
| SCALE      | 1:100         |
| PAGE SIZE  | 24"x36"       |
|            |               |

SEA



Drawing Number

L 1/2

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