

March 6, 2023 Page 1 of 4

#### Transmittal

#### Re: Design Rationale Summary Development of 1267-1289 Pridham Avenue & 1266-1288 Sutherland Avenue, Kelowna, BC (The Site)

Dear City of Kelowna Planning Department,

Further to submitted information as it pertains to the DP application associated with the proposed Development at The Site (referred to as Collinson Rise) in Kelowna, we offer the following Design Rationale summary for the project:

Located in the heart of the Capri-Landmark Urban Centre, the vision for the project was to design a residential building that aligned with the 2040 Official Community Plan. In response to the OCP, the building is to be classified as high density residential, with the design including a total of 240 residential units. Of the 240 units, 6 are townhomes and the remainder are condos. The condos are broken into the following: 147 micro suites, 6 studios, 40 one-bed, 36 two-bed, and 5 three-bed. The overall concept of the building was in response to several influences that were considered during the design process. One of the most important concepts was recognizing that the Developer opted to provide generous amenity spaces to compliment the proposed unit mix. In response to the market analysis for the immediate area, this approach results in the provision of more attainable residences, while creating a comfortable place to live that benefits from generous shared amenities. Further to the proposed unit mix and amenity spaces, the Developer has taken an innovative approach toward the creation of a "Green Building". The "Green Building" idea includes planting as part of the building design emphasized by a raised landscaped courtyard that is shared by all residents and enhances the visual impact of those oriented toward the south facing courtyard. The planting will act as a design feature that makes the building feel both welcoming and alive.

In response to the shared amenity options, the project concept evolved to blend publicly accessible portions of the building at the ground level with the more private ground-oriented townhome residences. This blend helps to create human scale interaction between the street and building, thereby bringing the residential feel of a taller building down to the entry level. Transparent design of the public spaces at the street level helps to reinforce the human scale and results in an inviting overall form and allows for direct connection between those inside the building and the street. The intent of the project is to employ cutting edge glazed exterior systems (triple glazed, high performance vision panels) at the public amenity and entry spaces. The use of these types of systems will ensure physical shading systems are not required and will ensure a visual connection is maintained between the users of the entry level spaces and the street scape. This visual connection between inside and outside in conjunction with the private townhome entries creates a variety of experiences between the pedestrian scale traffic on the street and the activities within the building. Choosing to locate a blend of amenity spaces at the entry level emphasizes the priority to include shared facilities for those living at Revo. Additionally, the Revo project offers generous amenity spaces besides those that are visible at ground level resulting in a mix of shared lounges, a gymnasium, bike storage, bike repair shop, storage lockers, terraced greenspace on the second level, and a rooftop patio and atrium, all intended to enhance the experience of living in more compact suites.

To keep the overall massing and height of the building complimentary to existing and proposed new projects in the immediate area, the residences above the entry level were laid out in a U shape. The U shape approach results in a south oriented internal courtyard that further increases the sense of privacy for the residences that are oriented toward the centre of the U, as well as resulting in a generous green space

#### Matt Johnston, Architect AIBC, LEED AP



#### **Transmittal**

March 6, 2023 Page 2 of 4

for all residences to share above the entry level. This raised courtyard at the centre of the building design was important for both the well being of the residents and for the introduction of additional green space. The U shape of the proposed design also provides more balance to the human scale as the courtyard sits at an appropriate height in relation to the street.

Another unique feature of the project is that it fronts onto two separate avenues (namely: Pridham to the north and Sutherland to the south). In response to this feature, the building was developed with the concept of two front entries for pedestrians, however vehicle access is only accessed off the north side; leaving the street façade oriented toward Sutherland without vehicle impact. Vehicle access includes a ramp down to the lower parkade for the assigned parking spaces and is limited to one vehicle access point from Pridham Avenue. To reduce the emphasis on the vehicle access point, the garage doors are screened by the more forward residential portion of the building, and double height lobbies help emphasize pedestrian entries while minimizing vehicle access. Both north and south lobbies have direct access to different amenities to encourage equal sharing of the entrances by the residents of the building and to establish a priority to the human scale activities at both entries to the building.

The form and character of the project design was inspired by the Developer's vision and preferences, blended with influences from a similar sized development proposal located nearby. Overall, the project design includes modern accents that blend horizontal and vertical elements with the use of angles to encourage a creative and visually stimulating façade. The material selections will blend stucco, fibre cement and metal siding to create contrast and interest. Faux wood exterior accents will engage the viewer's eye while complimenting the greenery integrated into the design, providing a warm and natural look.



Matt Johnston, Architect AIBC, LEED AP



March 6, 2023 Page 3 of 4

#### **Transmittal**

Render of Revo (view from Sutherland Avenue, looking north)



Render of Revo (view from Pridham Avenue, looking south)

The renderings above and on the previous page are intended to more clearly illustrate the various shapes, materials and colours proposed for the building:

- i. Angled balconies and buildouts are proposed to create a playful and unique design.
- ii. Faux wood can be seen as accents on small portions of the building and act as privacy screens between private balconies.
- iii. Wood-look soffits are proposed to provide a warm accent when viewing the building at the pedestrian scale from the street.
- iv. A combination of light and dark materials creates contrast between accent elements.
- v. Architectural features and material changes break up the building façade, creating a visually pleasing design.
- vi. Large windows connect the building to the street, encouraging human interaction.

Further to the more modern overall form and character, the orientation of the U shape toward the south will take advantage of the natural light to brighten the internal living spaces as well as align the building orientation to Sutherland Avenue. Overall, the building massing includes generous side yard setbacks, thereby being sensitive to existing homes and future adjacent developments in the area. Front yard and flanking street setbacks meet minimum requirements thereby allowing for pedestrian areas in front of the building while maximizing the site coverage. The overall height of the building is 22m (6 storeys), in accordance with the recommended OCP building heights and the city of Kelowna zoning bylaw requirements. Accordingly, Revo is a thoughtful design that enhances the human experience while meeting the recommendations, guidelines, and current city policies for the site. To obtain a desirable FAR of 1.9 while remaining mindful of the massing and relevance to the street is a challenge; however, as a collaborative team we are excited at how the building will engage the community while providing much needed attainable residences to the neighbourhood.

Matt Johnston, Architect AIBC, LEED AP



**Transmittal** 

March 6, 2023 Page 4 of 4

Proposing a high-density residential development that can utilize the existing infrastructure, services and amenities while remaining close to employment centres also aligns with the OCP. Nearby amenities include shopping, personal services, and restaurants, thus allowing most errands from the location to be accomplished by foot or bicycle. To further reduce the reliance on personal vehicles and to reduce the overall number of vehicles anticipated for the project, two car-share spaces will be included on site. With the surrounding area quickly evolving and densifying, this proposed development is in full alignment with the changing community and will be perfectly situated to accommodate the shifting needs of Kelowna residents. Given the location in the Capri-Landmark Urban Centre, we feel the proposed development aligns with the City's vision and our own when it comes to a healthy, sustainable community that is less reliant on automotive means of transportation.

In summary, the rationale for this project is as follows:

- I. Provide much needed residential units and various unit types to an area of Kelowna experiencing an increased demand for compact living.
- II. Provide a thoughtful, "Green Building" infill design on a property located in the heart of an existing urban centre of Kelowna. The "Green" aspects of the building align with the goal to expand parks and greenery within the urban centre.
- III. Provide exceptional shared amenity space within the building to provide the residents a healthy and happy space to interact.
- IV. Propose a residential development that meets the City of Kelowna Parking Bylaw requirements and includes two car-share spaces as part of helping to reduce the reliance on vehicle use in an environmentally responsible way.

This proposed development recognizes the City of Kelowna's strategic approach to overall residential growth including better use of precious developable land in accordance with the City's OCP/Future Land Use, Healthy City Strategy, and planning initiatives and aligns with the City's long-term vision. Accordingly, our team looks forward to community support in response to this Development Permit application.

Sincerely:


Matt Johnston // Architect AIBC, LEED AP LIME Architecture Inc.

# <u>SUTHERLAND & PRIDHAM AVENUES, KELOWNA BC</u>



VIEW FROM SUTHERLAND AVENUE



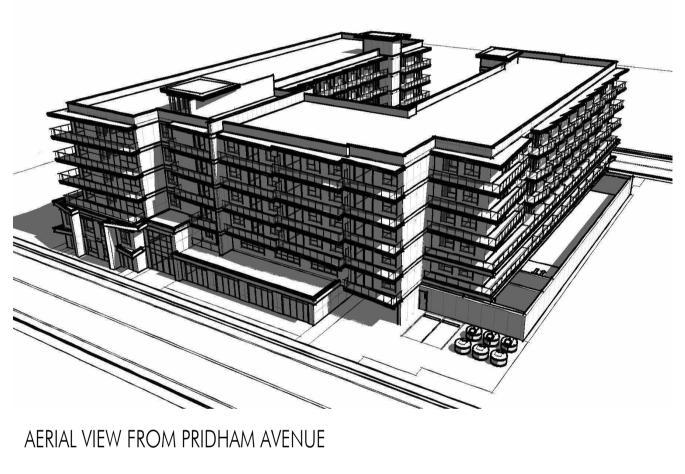

VIEW FROM SUTHERLAND AVENUE

## PROPERTY DESCRITION

CIVIC: 1266, 1276, 1288 SUTHERLAND AVENUE & 1267, 1277, 1289 PRIDHAM AVENUE, KELOWNA BC LEGAL: LOTS 5, 6, 7, 13, 14, AND 15 BLOCK 3; DL 137 ODYD PLAN 9625

## <u>CONSULTANT TEAM</u>


#### OWNER/ OPERATOR

COLLINSON RISE LP 1100-1631 Dickson Avenue Vancouver, BC V7Y 0B5 250-212-6743

Contact(s): Ryan Tamblyn ARCHITECTURAL

LIME ARCHITECTURE INC. 205-1626 Richter Street Kelowna, BC V1Y 2M3 250-448-7801

Contact(s): Stephanie Sannuto Stefan Van Deventer

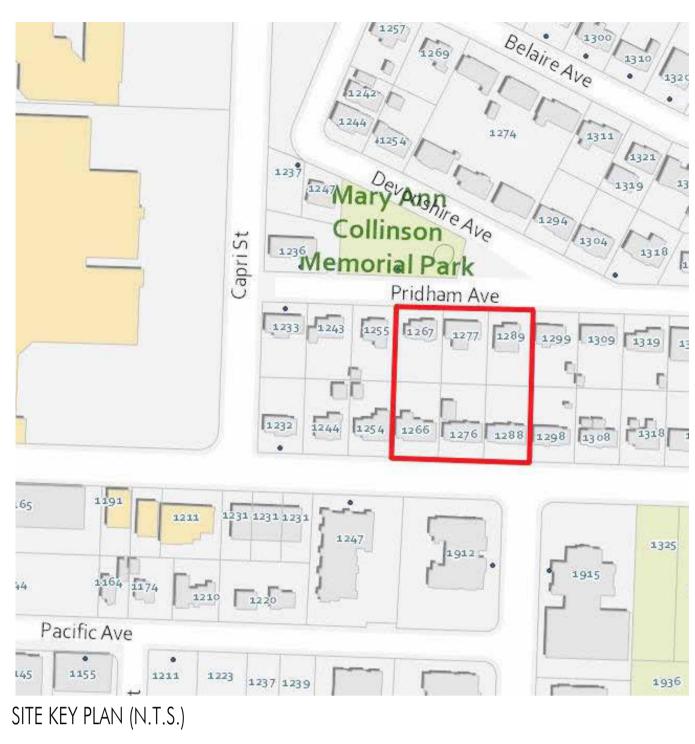



AERIAL VIEW FROM SUTHERLAND AVENUE

STRUCTURAL	<u>CIVIL</u>	LANDS
ROV Engineering Consultants 101-2040 Springfield Road Kelowna, BC V1Y 9N7 250-860-7801	Aplin Martin 1258 Ellis Street Kelowna, BC V1Y 1Z4 250-448-0157	Ecora 210-1 Kelowi 250-7
Contact(s): Mahdi Yazdinezhad	Contact(s): Davin Shillong Josh Graff	Conta Achim

## ARCHITECTURAL SHEET LIST

A-000COVER SHEETA-001PROJECT INFORMATIONA-002PROJECT INFORMATIONA-100BASEMENT PARKADE PLANA-101BASEMENT - NORTH PARKING PLANA-102BASEMENT - SOUTH PARKING PLANA-103LEVEL 1 PLANA-104LEVEL 1 - NORTH PARKING PLANA-105LEVEL 1 - SOUTH PARKING PLANA-106LEVEL 2 PLANA-107LEVEL 2 PLANA-108LEVEL 3 PLANA-109LEVEL 4 PLANA-110LEVEL 5 PLANA-111LEVEL 6 PLANA-112ROOFTOP AMENITY	LAN
A-114 COLOUR KEY PLANS A-115 TYPICAL UNIT LAYOUTS	
A-116 TYPICAL UNIT LAYOUTS	
A-117 TYPICAL UNIT LAYOUTS	
A-118 TYPICAL UNIT LAYOUTS	
A-119 TYPICAL UNIT LAYOUTS	
A-200 NORTH ELEVATION	
A-201 SOUTH ELEVATION	
A-202 EAST ELEVATION	
A-203 WEST ELEVATION	
A-204 COURTYARD ELEVATION	
A-205 COURTYARD ELEVATION	

#### <u>DSCAPING</u>

ra )-1715 Dickson Avenue owna, BC V1Y 9G6 )-762-9993

tact(s): m Muller

#### <u>CONTRACTOR</u>

Millennial Developments 1100-1631 Dickson Avenue Kelowna, BC V1Y 0B5 250-718-1609

Contact(s): Jim Marcotte Sean Caha

	<b>LIME</b> ARCHITECTURE INC.
	PHONE:250-448-7801
www.limear	205-1626 Richter Street, Kelowna, BC V1Y 2M3 <b>"chitecture.com</b>
COPYRIGHT.	
LIME Architecture In- service, they may no reproduced in any ne expressed written co Architecture Inc. All shall check and veri data and conditions commencement of c discrepancies are to immediately to LIME	rawings and e exclusive property of c. As instruments of the used or nanner without the nsent of LIME Contracting Trades fy all levels, dimensions, on the site prior to any work. Any
building by-laws and local authorities hav as the british columb (most recent edition) revisions and adden assume full responsi and protection of all ground utilities, wire	current municipality d requirements of other ing jurisdiction as well bia building code - ) including all published da. All trades shall blity for the locations I under and above s and conduit ng (but not limited to)
Revision No.,	
and Descripti 02.25.23 FOR 03.06.23 FOR 03.17.21 FOR	DP DP
Plot Date 04.14.23 PROJECT	
Revo (Collinso	TLE
COVEF	RSHEET
Drawing No.	00
Contraction of the second seco	ED ARCHING
	COP-

# <u>SUTHERLAND & PRIDHAM AVENUES, KELOWNA BC</u>

#### PROPERTY DESCRIPTION


CIVIC: 1266, 1276, 1288 SUTHERLAND AVENUE & 1267, 1277, 1289 PRIDHAM AVENUE, KELOWNA BC LEGAL: LOTS 5, 6, 7, 13, 14, AND 15 BLOCK 3; DL 137 ODYD PLAN 9625

ZONING CALCULATIONS:
CURRENT: UC2 (RESIDENTIAL)
SITE INFORMATION:

GROSS SITE AREA= 54,848 SF (5,096m<sup>2</sup>) ALLOWED/REQUIRED ALLOWABLE SITE COVERAGE= 85% (46,621 SF) 90% (49,363 SF) ALLOWABLE SITE COVERAGE + HARDSCAPING= F.A.R. + BONUS DENSITY= 1.8 + 0.25 (112,428 SF) HEIGHT= 22.0m (6 STOREYS) YARD SETBACKS: FRONT YARD= 2.0m GARAGE FROM STREET= 6.0m SIDE YARD= 0.0m FRONT YARD ABOVE 16.0m (4TH FLOOR) =3.0m SIDE YARD ABOVE 16.0m (4TH FLOOR) = 4.0m PRIVATE & COMMON AMENITY SPACE: COMMON = 240 UNITS x  $4.0m^2/UNIT = 960m^2$  (10,333 SF)  $7.5m^2/UNIT = 1,147.5m^2 (12,352 \text{ SF})$ PRIVATE: BACHELOR UNITS =  $15.0 \text{m}^2/\text{UNIT} = 600 \text{m}^2$  (6,458 SF) PRIVATE: 1-BEDROOM UNITS = $25.0 \text{m}^2/\text{UNIT} = 1,175 \text{m}^2 (12,648 \text{ SF})$ PRIVATE: UNITS WITH MORE THAN 1-BEDROOM = PARKING CALCULATIONS: MICRO / BACHELOR UNITS (0-BEDROOM) = 153 UNITS x 0.8 =122.4 1 BEDROOM UNITS = 40 UNITS x 0.9 = 3647 UNITS x 1.0 = 472 + BEDROOM UNITS =VISITOR PARIKING = 34 BASE REDUCTION FOR 2 CAR-SHARE = - 10 BASE REDUCTION FOR LONG TERM BICYCLE BONUS = - 5 224 + 2 CAR-SHARE total parking = ACCESSIBLE PARKING =6 (2 VAN ACCESSIBLE) BONUS LONG-TERM BICYCLE STORAGE: UNIT TYPE BACHELOR & 1-BEDROOM =  $1.25 \times 193 \text{ UNITS} = 241$ 2-BEDROOM = $1.5 \times 36 \text{ UNITS} = 54$ 3-BEDROOM = $2 \times 5 \text{ UNITS} = 10$ TOWNHOMES = N/A TOTAL =305 (ROUNDED)

# SHORT-TERM\_BICYCLE STORAGE:6 PER ENTRANCE =12TOWNHOUSES =4TOTAL =16

PARKING SCHEDULE		
COUNT	TYPE	
4	ACCESSIBLE - 90 deg	
127	REGULAR - 90 deg	
93	SMALL - 90 deg	
2	VAN ACCESSIBLE - 90 deg	
Grand total: 226		

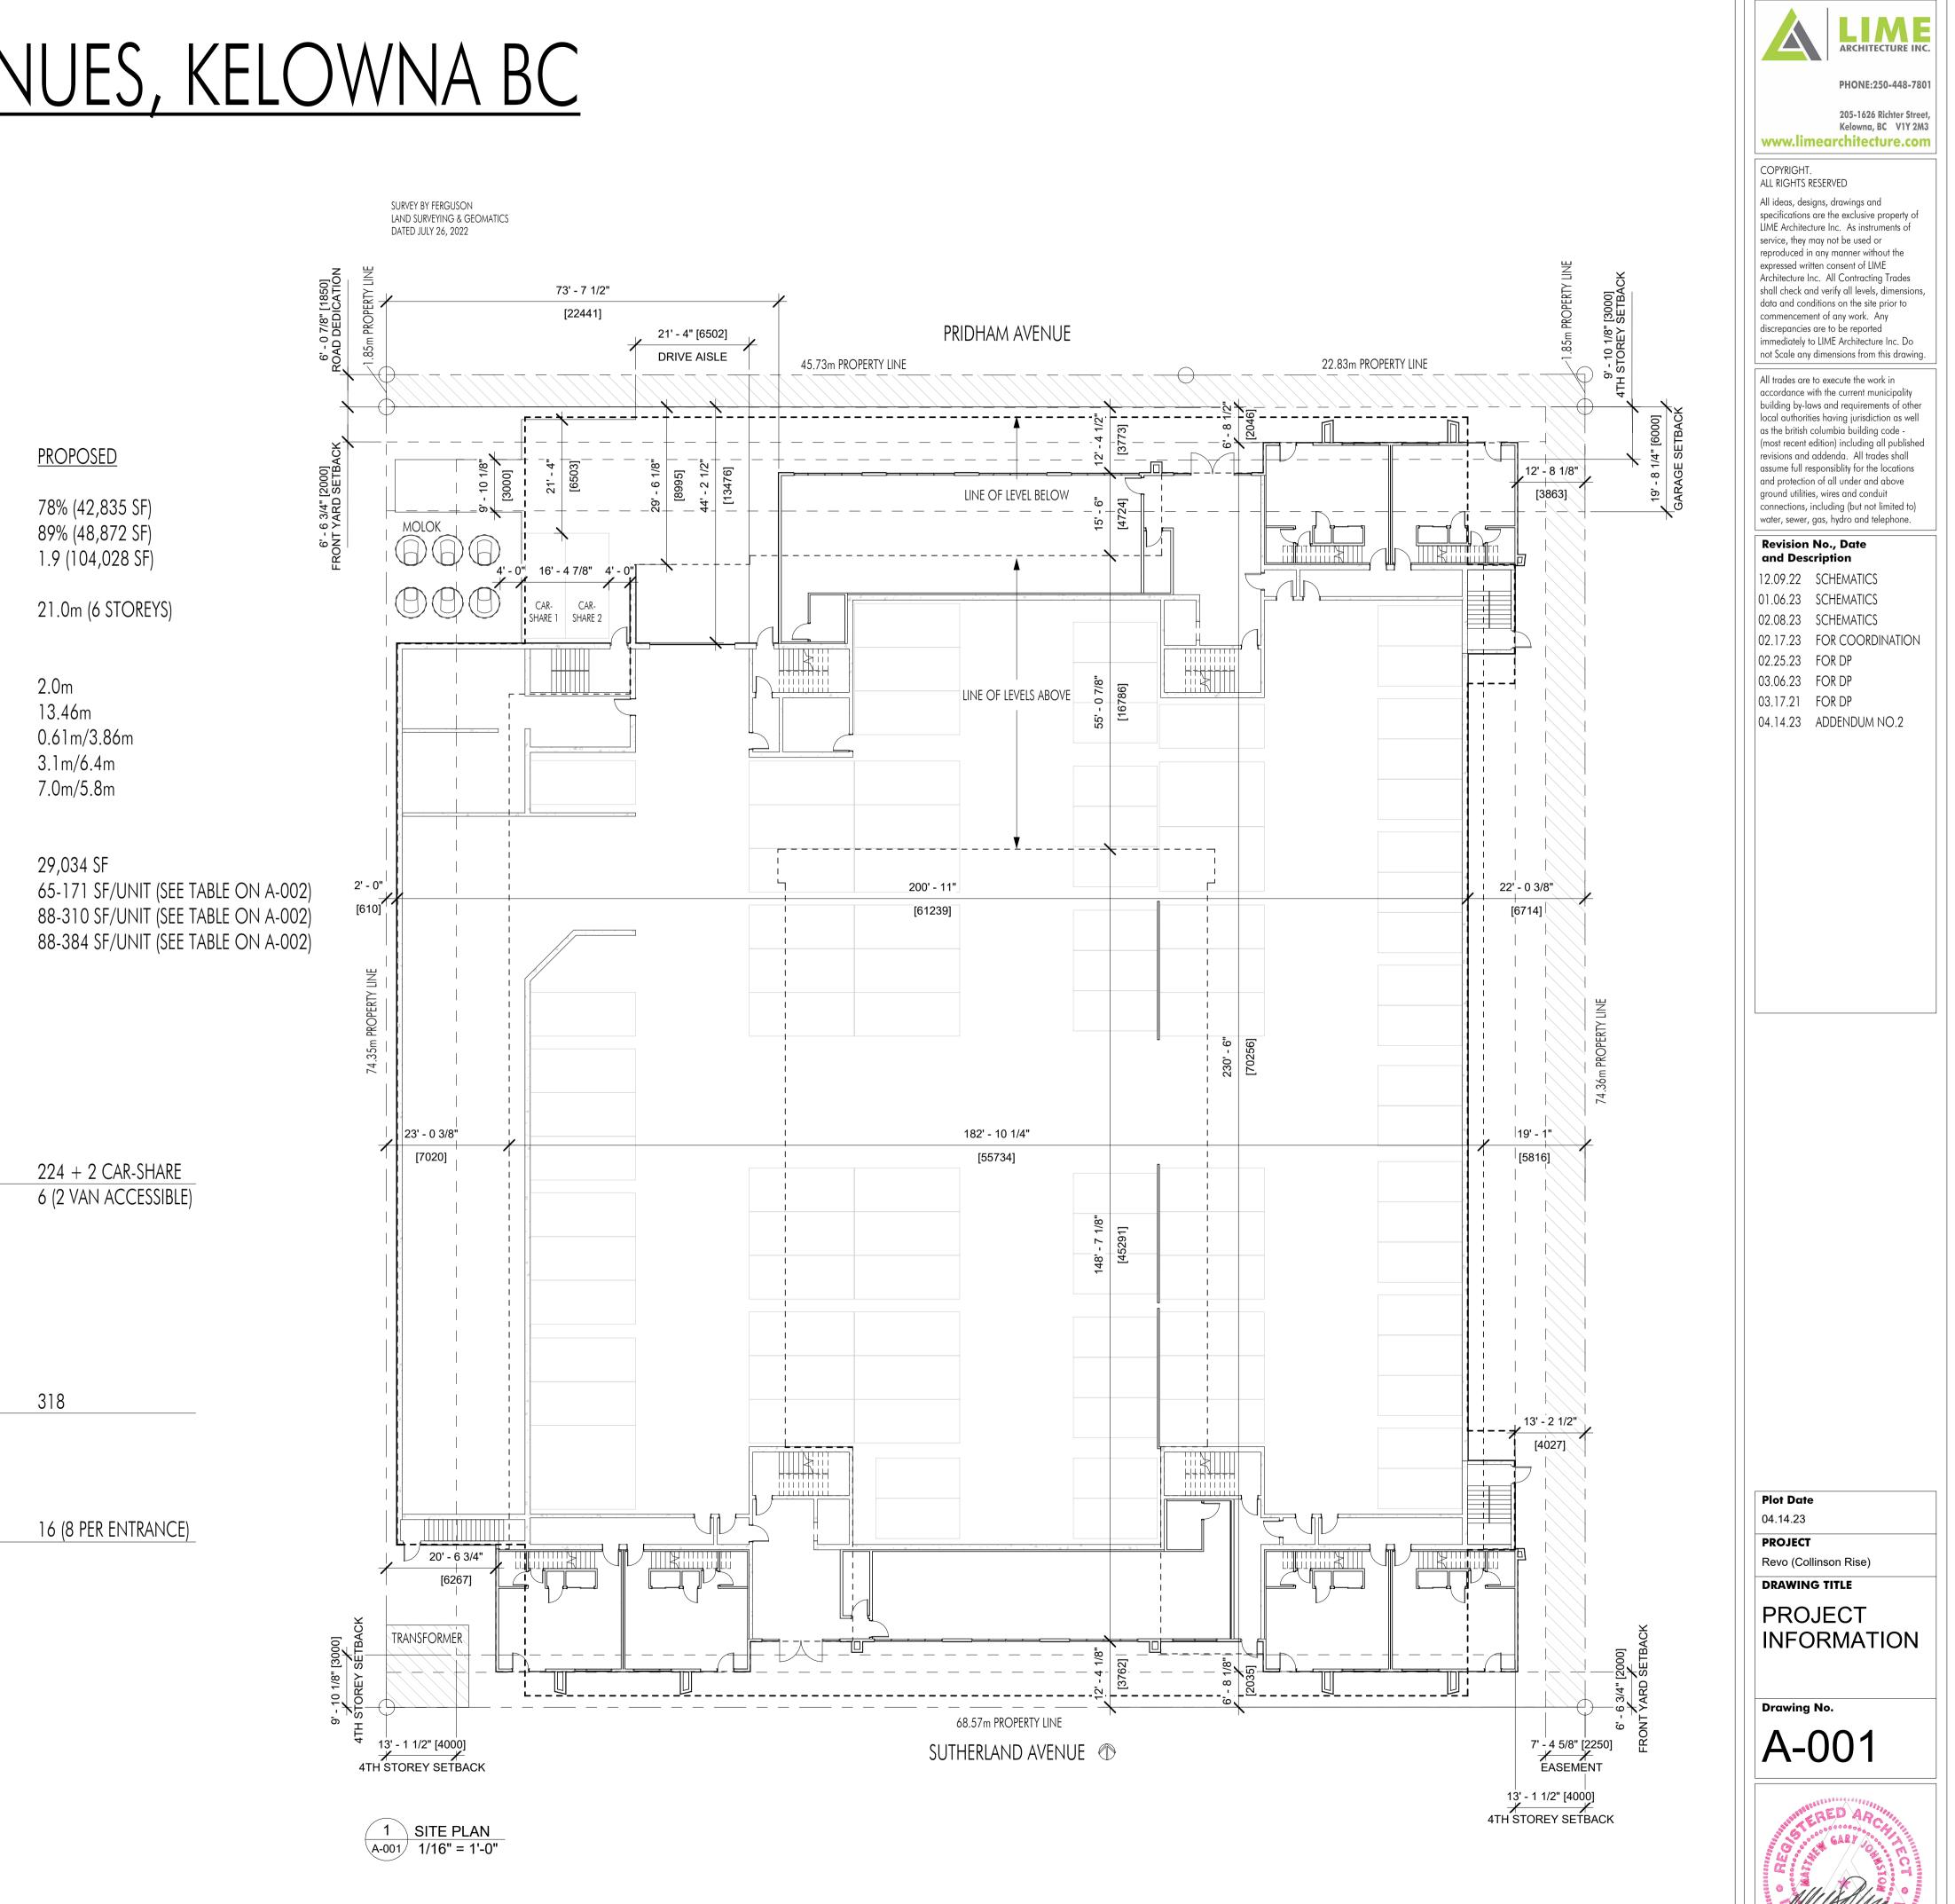

	UNIT CALCUL		PRIVATE	
UNIT	BEDROOMS	AREA	AMENITY SPACE	UN
101 - ENTRY		529 SF		329
101 - SECOND	2	475 SF	0 SF	330
102 - ENTRY		529 SF		331
102 - SECOND	2	475 SF	0 SF	332
103 - ENTRY		529 SF		333
103 - SECOND	2	475 SF	0 SF	334
104 - ENTRY		529 SF		335
104 - SECOND	2	475 SF	0 SF	336
105 - ENTRY		529 SF		337
105 - SECOND	2	475 SF	0 SF	338
106 - ENTRY		529 SF		339
106 - SECOND	2	475 SF	0 SF	340
201	1	530 SF	128 SF	341
202	2	631 SF	226 SF	342
203	0	307 SF	74 SF	343
204	0	307 SF	74 SF	344
205	0	307 SF	171 SF	345
206	0	307 SF	171 SF	346
207	0	307 SF	74 SF	347
208	0	307 SF	74 SF	348
209	0	307 SF	171 SF	401
210	0	307 SF	171 SF	402
210	0	307 SF	74 SF	402
212	0	307 SF	74 SF	403
212	0	307 SF	171 SF	404
213	0	307 SF	171 SF	405
214 215	0	307 SF 307 SF	74 SF	408
215	3	921 SF	376 SF	407
217	1	534 SF	110 SF	409
218	0	307 SF	90 SF	410
219	0	307 SF	94 SF	411
220	0	307 SF	94 SF	412
221	0	307 SF	92 SF	413
222	0	425 SF	98 SF	414
223	0	307 SF	92 SF	415
224	0	307 SF	90 SF	416
225	2	854 SF	130 SF	417
226	2	706 SF	169 SF	418
227	0	396 SF	95 SF	419
228	0	307 SF	118 SF	420
229	0	307 SF	74 SF	421
230	0	307 SF	118 SF	422
231	0	307 SF	74 SF	423
232	0	307 SF	118 SF	424
233	0	307 SF	74 SF	425
234	0	307 SF	118 SF	426
235	0	307 SF	74 SF	427
236	0	307 SF	118 SF	428
237	0	307 SF	74 SF	429
238	0	307 SF	118 SF	430
239	0	307 SF	74 SF	431
240	1	581 SF	156 SF	432
241	2	663 SF	160 SF	433
242	1	486 SF	310 SF	434
301	2	652 SF	95 SF	435
302	1	508 SF	106 SF	436
303	1	530 SF	128 SF	430
304	2	631 SF	88 SF	438
305	0	307 SF	74 SF	439
306	0	307 SF 307 SF	74 SF 74 SF	439
307	0	307 SF 307 SF	67 SF	440
308	0	307 SF	67 SF	442
309	0	307 SF	74 SF	443
310	0	307 SF	74 SF	444
311	0	307 SF	67 SF	445
312	0	307 SF	67 SF	446
313	0	307 SF	74 SF	447
314	0	307 SF	74 SF	448
315	0	307 SF	67 SF	501
316	0	307 SF	74 SF	502
317	1	436 SF	96 SF	503
318	3	921 SF	376 SF	504
319	1	534 SF	110 SF	505
320	0	307 SF	74 SF	506
321	1	591 SF	152 SF	507
322	0	307 SF	68 SF	508
323	0	307 SF	68 SF	509
324	2	710 SF	140 SF	510
325	0	307 SF	65 SF	510
326	0	307 SF 307 SF	65 SF	512
320	1	493 SF	98 SF	
				513
328	0	307 SF	74 SF	514

UNIT CALCULATIONS			
UNIT	# OF BEDROOMS	UNIT AREA	PRIVATE AMENITY SPACE
329	2	829 SF	384 SF
330	2	715 SF	110 SF
331	2	706 SF	169 SF
332 333	0	396 SF 436 SF	95 SF 96 SF
334	0	307 SF	74 SF
335	0	307 SF	67 SF
336 337	0	307 SF 307 SF	74 SF 67 SF
338	0	307 SF	74 SF
339	0	307 SF	67 SF
340	0	307 SF	74 SF
341 342	0	307 SF 307 SF	67 SF 74 SF
343	0	307 SF	67 SF
344	0	307 SF	74 SF
345	1	434 SF	104 SF
346 347	1 2	581 SF 694 SF	88 SF 161 SF
348	2	740 SF	143 SF
401	2	652 SF	95 SF
402	1	508 SF	98 SF
403 404	1 2	530 SF 631 SF	116 SF 88 SF
405	0	307 SF	67 SF
406	0	307 SF	67 SF
407	0	307 SF	67 SF
408 409	0	307 SF 307 SF	67 SF 67 SF
410	0	307 SF	67 SF
411	0	307 SF	67 SF
412	0	307 SF	67 SF
413 414	0	307 SF 307 SF	67 SF 67 SF
415	0	307 SF	67 SF
416	0	307 SF	67 SF
417	1	436 SF	96 SF
418 419	3	921 SF 534 SF	282 SF 110 SF
420	0	307 SF	74 SF
421	1	591 SF	152 SF
422 423	0	307 SF 307 SF	68 SF 68 SF
423	2	710 SF	140 SF
425	0	307 SF	65 SF
426	0	307 SF	65 SF
427 428	1 0	493 SF 307 SF	130 SF 74 SF
429	2	829 SF	273 SF
430	2	715 SF	100 SF
431	2	706 SF	154 SF
432 433	0	396 SF 436 SF	86 SF 96 SF
434	0	307 SF	67 SF
435	0	307 SF	67 SF
436	0	307 SF	67 SF
437 438	0	307 SF 307 SF	67 SF 67 SF
439	0	307 SF	67 SF
440	0	307 SF	67 SF
441 442	0	307 SF 307 SF	67 SF 67 SF
442	0	307 SF 307 SF	67 SF
444	0	307 SF	67 SF
445	1	434 SF	95 SF
446 447	1 2	581 SF 694 SF	88 SF 148 SF
447	2	740 SF	148 SF 143 SF
501	2	652 SF	95 SF
502	1	508 SF	98 SF
503 504	1 2	530 SF 631 SF	116 SF 88 SF
505	0	307 SF	67 SF
506	0	307 SF	67 SF
507	0	307 SF	67 SF
508 509	0	307 SF 307 SF	67 SF 67 SF
510	0	307 SF 307 SF	67 SF
511	0	307 SF	67 SF
512	0	307 SF	67 SF
513 514	0	307 SF 307 SF	67 SF 67 SF
ر <del>ح</del>	-		

	# OF		PRIVATE
UNIT	BEDROOMS	AREA	AMENITY SPACE
515 516	0	307 SF 307 SF	67 SF 67 SF
517	1	436 SF	96 SF
518	3	921 SF	282 SF
519	1	534 SF	110 SF
520	0	307 SF	74 SF
521	1	591 SF	152 SF
522	0	307 SF	68 SF
523	0	307 SF	68 SF
524	2	710 SF	140 SF
525 526	0	307 SF 307 SF	65 SF 65 SF
520	1	493 SF	130 SF
528	0	307 SF	74 SF
529	2	829 SF	273 SF
530	2	715 SF	100 SF
531	2	706 SF	154 SF
532	0	396 SF	86 SF
533	1	436 SF	96 SF
534	0	307 SF	67 SF
535	0	307 SF	67 SF
536	0	307 SF	67 SF
537	0	307 SF	67 SF
538 539	0	307 SF 307 SF	67 SF 67 SF
540	0	307 SF 307 SF	67 SF
540	0	307 SF 307 SF	67 SF
542	0	307 SF	67 SF
543	0	307 SF	67 SF
544	0	307 SF	67 SF
545	1	434 SF	95 SF
546	1	581 SF	88 SF
547	2	694 SF	148 SF
548	2	740 SF	143 SF
601	2	652 SF	95 SF
602	1	508 SF	98 SF
603	1	530 SF	116 SF
604	2	631 SF	88 SF
605 606	0	307 SF 307 SF	67 SF 67 SF
607	0	307 SF	67 SF
608	0	307 SF	67 SF
609	0	307 SF	67 SF
610	0	307 SF	67 SF
611	0	307 SF	67 SF
612	0	307 SF	67 SF
613	0	307 SF	67 SF
614	0	307 SF	67 SF
615	0	307 SF	67 SF
516	0	307 SF	67 SF
617	1	436 SF	96 SF
618 619	3	921 SF 534 SF	282 SF 110 SF
519 520	0	307 SF	74 SF
520 521	1	591 SF	152 SF
622	0	307 SF	68 SF
522 523	0	307 SF	68 SF
624	2	710 SF	140 SF
625	0	307 SF	65 SF
626	0	307 SF	65 SF
627	1	493 SF	130 SF
628	0	307 SF	74 SF
629	2	829 SF	273 SF
630 631	2	715 SF	100 SF 154 SF
631 632	2	706 SF 396 SF	154 SF 86 SF
532 533	1	436 SF	96 SF
535 534	0	307 SF	67 SF
635	0	307 SF	67 SF
636	0	307 SF	67 SF
637	0	307 SF	67 SF
638	0	307 SF	67 SF
539	0	307 SF	67 SF
640	0	307 SF	67 SF
641	0	307 SF	67 SF
642	0	307 SF	67 SF
643	0	307 SF	67 SF
644	0	307 SF	67 SF
645	1	434 SF	95 SF
646	1	581 SF	88 SF
647	2	694 SF	148 SF
648	2	740 SF	143 SF

UNIT COUNT				
UNIT TYPES	# of BEDROOMS	# OF UNITS		
1-BED	1	35		
1-BED + DEN	1	5		
2-BED	2	31		
2-BED + DEN	2	5		
3-BED	3	5		
MICRO	0	147		
STUDIO	0	6		
TOWNHOUSE	2	6		
Grand total: 240		240		

Grand total: 240

## ADDENDUM NO.3



PHONE:250-448-7801

#### 205-1626 Richter Street, Kelowna, BC V1Y 2M3 www.limearchitecture.com

#### COPYRIGHT. ALL RIGHTS RESERVED

All ideas, designs, drawings and specifications are the exclusive property of LIME Architecture Inc. As instruments of service, they may not be used or reproduced in any manner without the expressed written consent of LIME Architecture Inc. All Contracting Trades shall check and verify all levels, dimensions, data and conditions on the site prior to commencement of any work. Any discrepancies are to be reported immediately to LIME Architecture Inc. Do not Scale any dimensions from this drawing.

All trades are to execute the work in accordance with the current municipality building by-laws and requirements of other local authorities having jurisdiction as well as the british columbia building code -(most recent edition) including all published revisions and addenda. All trades shall assume full responsiblity for the locations and protection of all under and above ground utilities, wires and conduit connections, including (but not limited to) water, sewer, gas, hydro and telephone.

#### **Revision No., Date** and Description


03.06.23 FOR DP 03.17.21 FOR DP


#### Plot Date


04.14.23 PROJECT

Revo (Collinson Rise)

DRAWING TITLE PROJECT INFORMATION

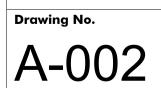

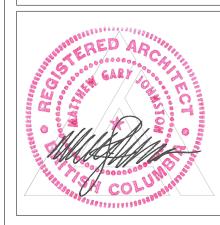

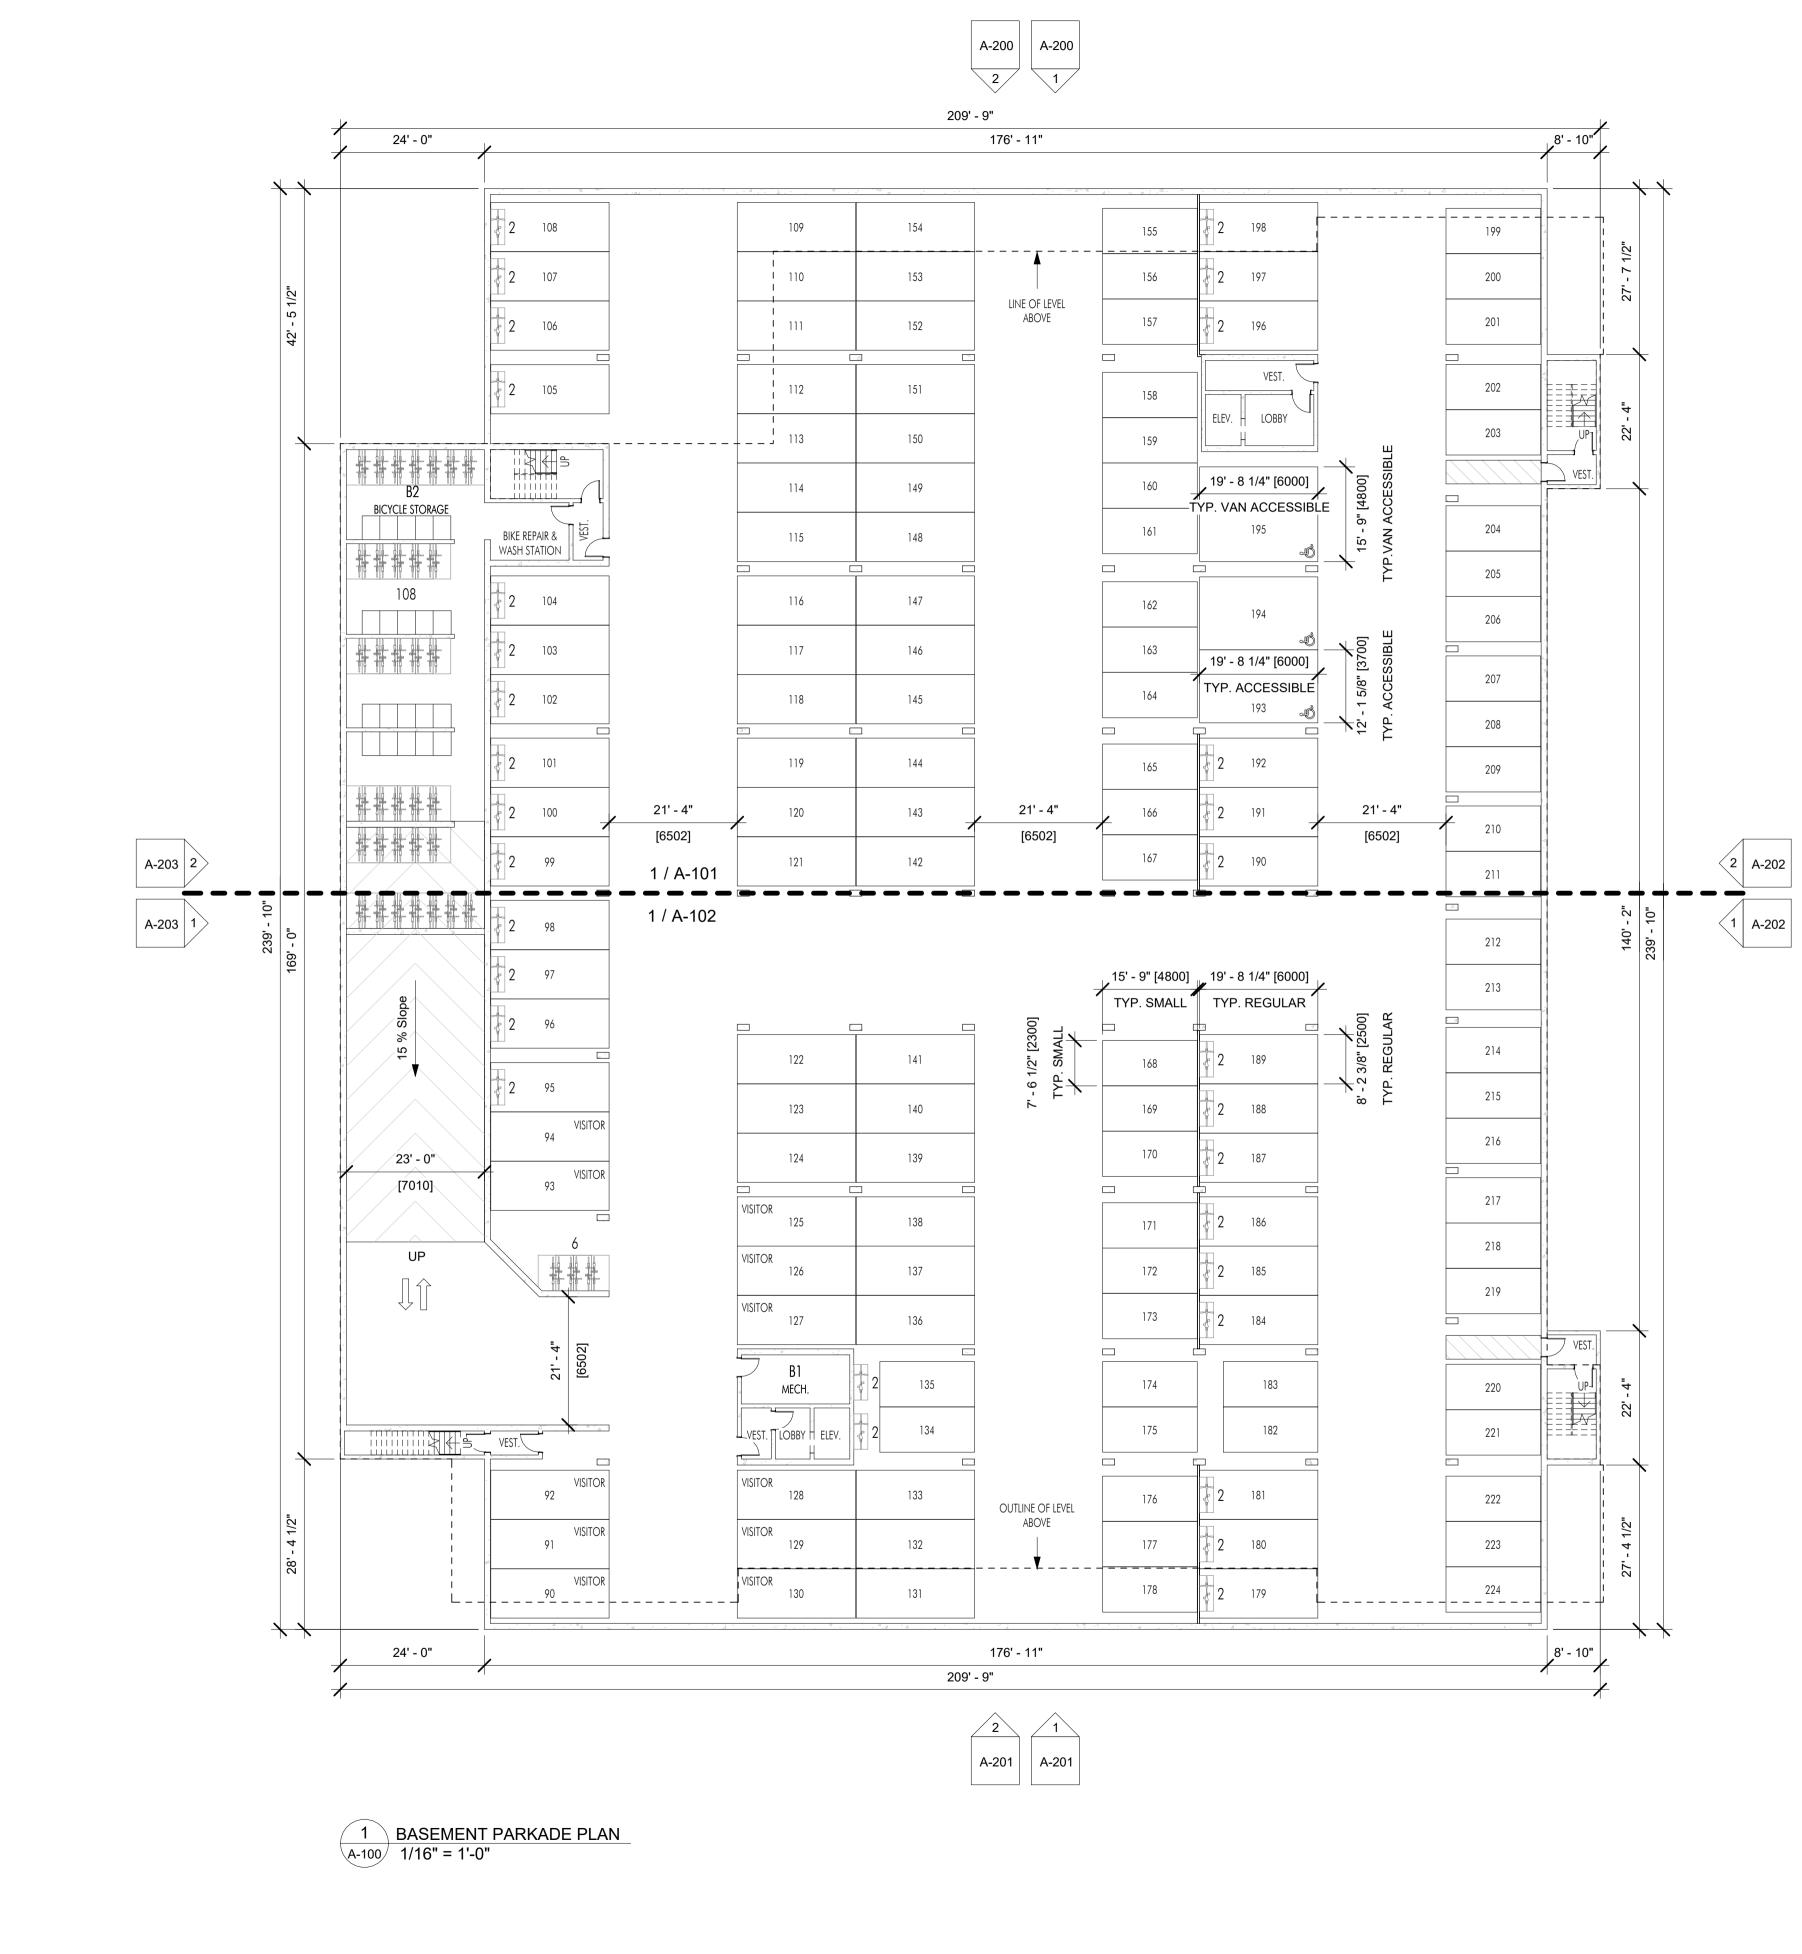

## **LIME** ARCHITECTURE INC.

PHONE:250-448-7801

#### 205-1626 Richter Street, Kelowna, BC V1Y 2M3 www.limearchitecture.com

#### COPYRIGHT. ALL RIGHTS RESERVED

All ideas, designs, drawings and specifications are the exclusive property of LIME Architecture Inc. As instruments of service, they may not be used or reproduced in any manner without the expressed written consent of LIME Architecture Inc. All Contracting Trades shall check and verify all levels, dimensions, data and conditions on the site prior to commencement of any work. Any discrepancies are to be reported immediately to LIME Architecture Inc. Do not Scale any dimensions from this drawing.

All trades are to execute the work in accordance with the current municipality building by-laws and requirements of other local authorities having jurisdiction as well as the british columbia building code -(most recent edition) including all published revisions and addenda. All trades shall assume full responsiblity for the locations and protection of all under and above ground utilities, wires and conduit connections, including (but not limited to) water, sewer, gas, hydro and telephone.

#### **Revision No., Date** and Description

	•
2.09.22	SCHEMATICS
1.06.23	SCHEMATICS
2.17.23	FOR COORDINATION
2.25.23	FOR DP
3.06.23	FOR DP
3.17.21	FOR DP
4.14.23	ADDENDUM NO.2
4.25.23	ADDENDUM NO.3

#### Plot Date 04.14.23


PROJECT Revo (Collinson Rise)

DRAWING TITLE

BASEMENT PARKADE PLAN


Drawing No.



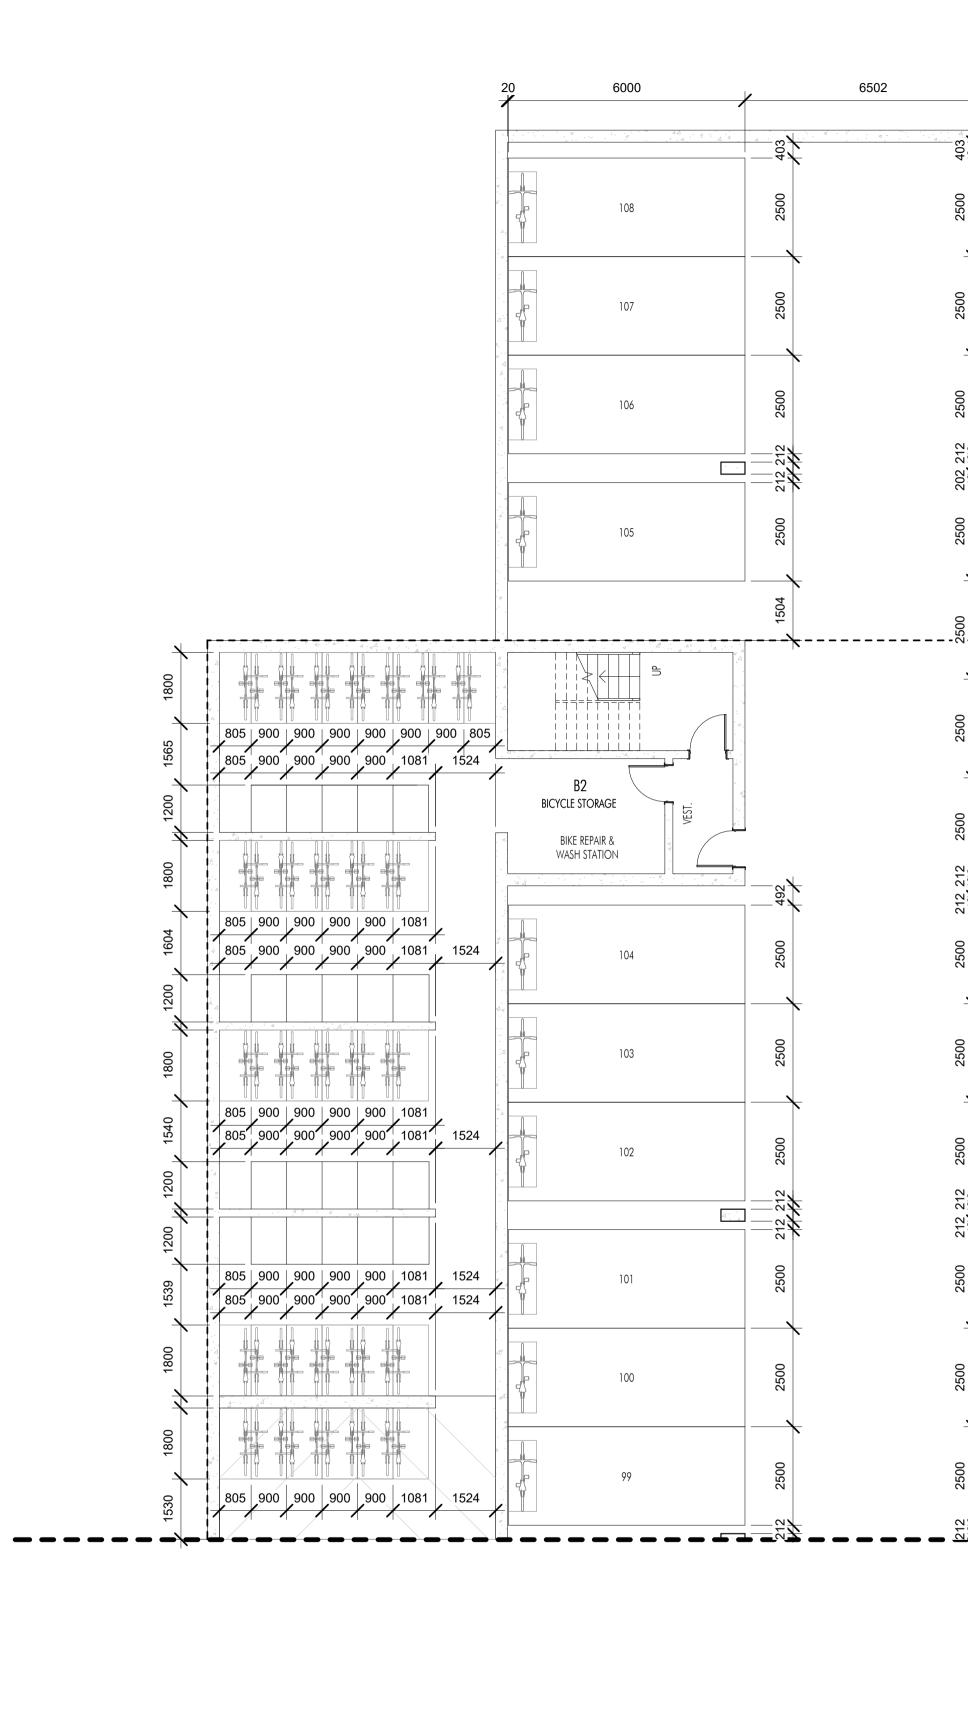

1BASEMENT PARKADE PLAN - NORTH PARKING PLANA-1011/8" = 1'-0"

	 6000 4	0 6000	/	6502	4800 1	22 6000
	-			,		
403			403	n n n n n n n n n n n n n n n n n n n		
4						
2500	109	154	2500	, 5300	155	198
2500	110	153	2500		156	197
2500	111	152	2 2500		157	196
202 212			202 212			
20			—ĝ <b>*</b>	602		VEST.
, 2500	112	151	2500	5300	158	
2500	113	150	2500	5300	159	
2500	114	149	2500	5300	160	
2500	115	148	2500	5300	161	195
212			-13			
212 212			212			<u> </u>
2500	116	147	2500	5300	162	194
2500	117	146	2500	5300	163	-J
12 2500	118	145	2 2500	2300	164	193
212 212			$\mathbf{z} = \mathbf{z}$			
2500	119	144	2500 212	2300	165	192
2500	120	143	2500	5300	166	191
2500	121	142	2500	5 2300	167	190
212			212 212			

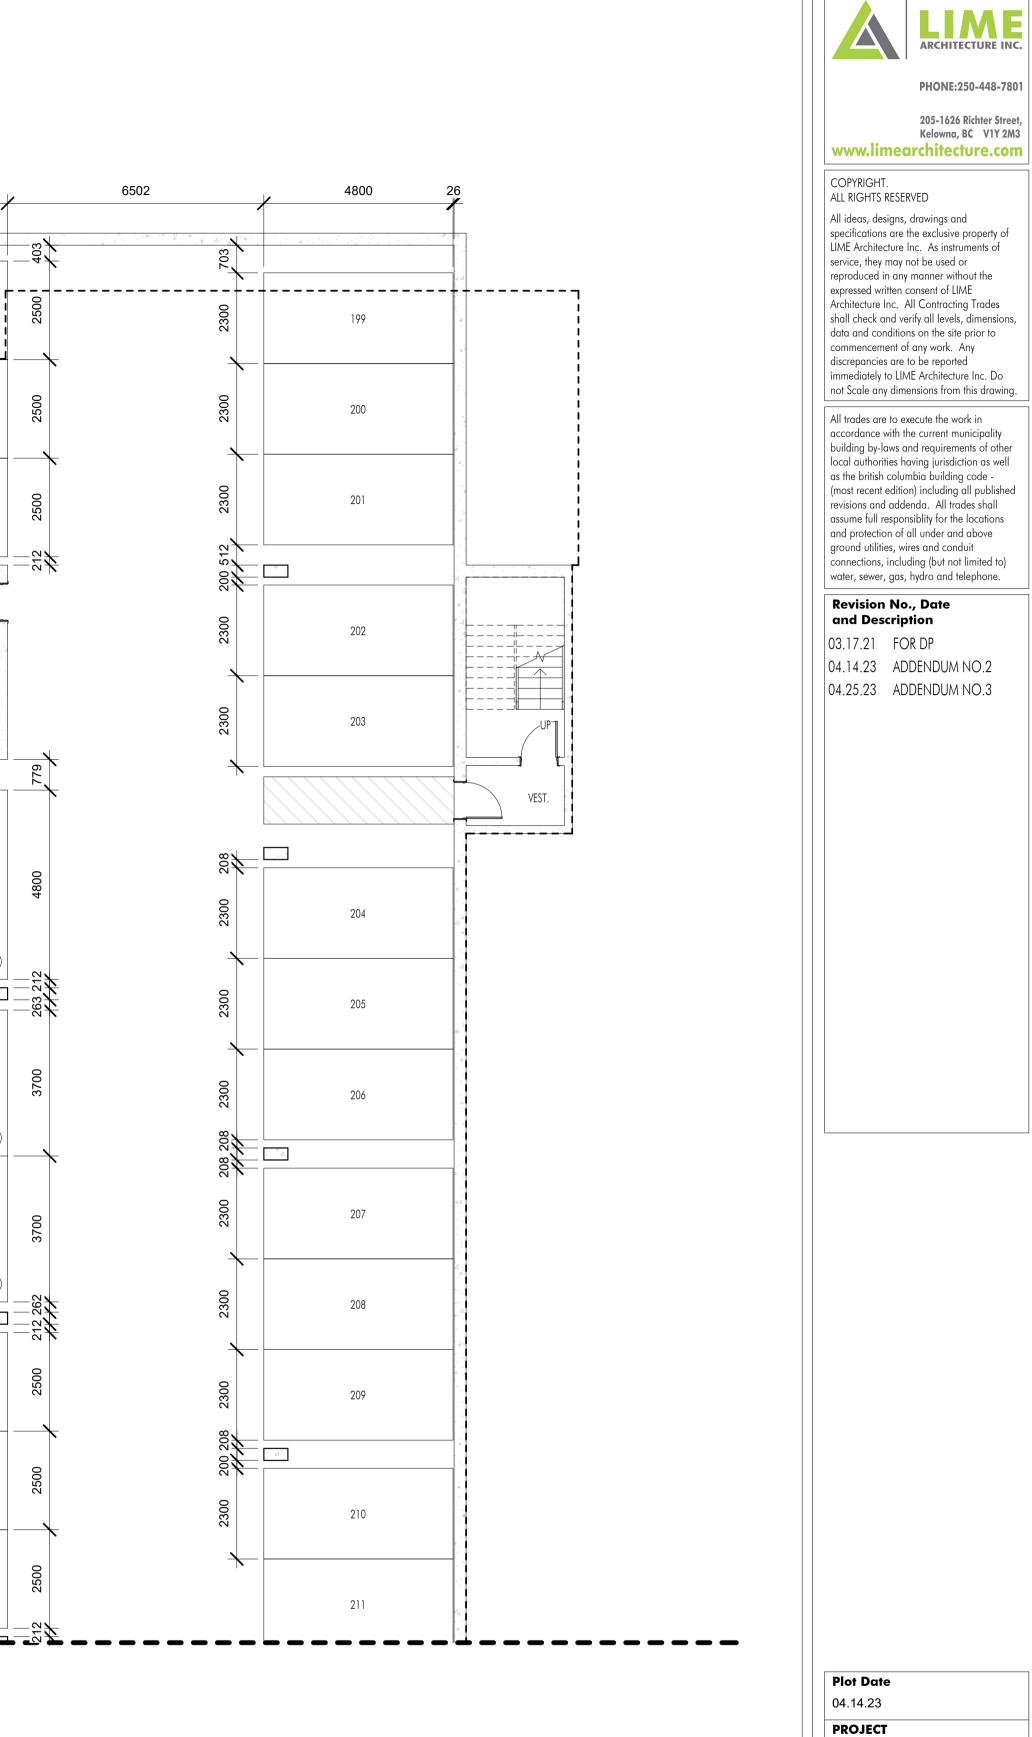

## ADDENDUM NO.3

A-101

Revo (Collinson Rise)


BASEMENT -

PARKING PLAN


DRAWING TITLE

NORTH

Drawing No.

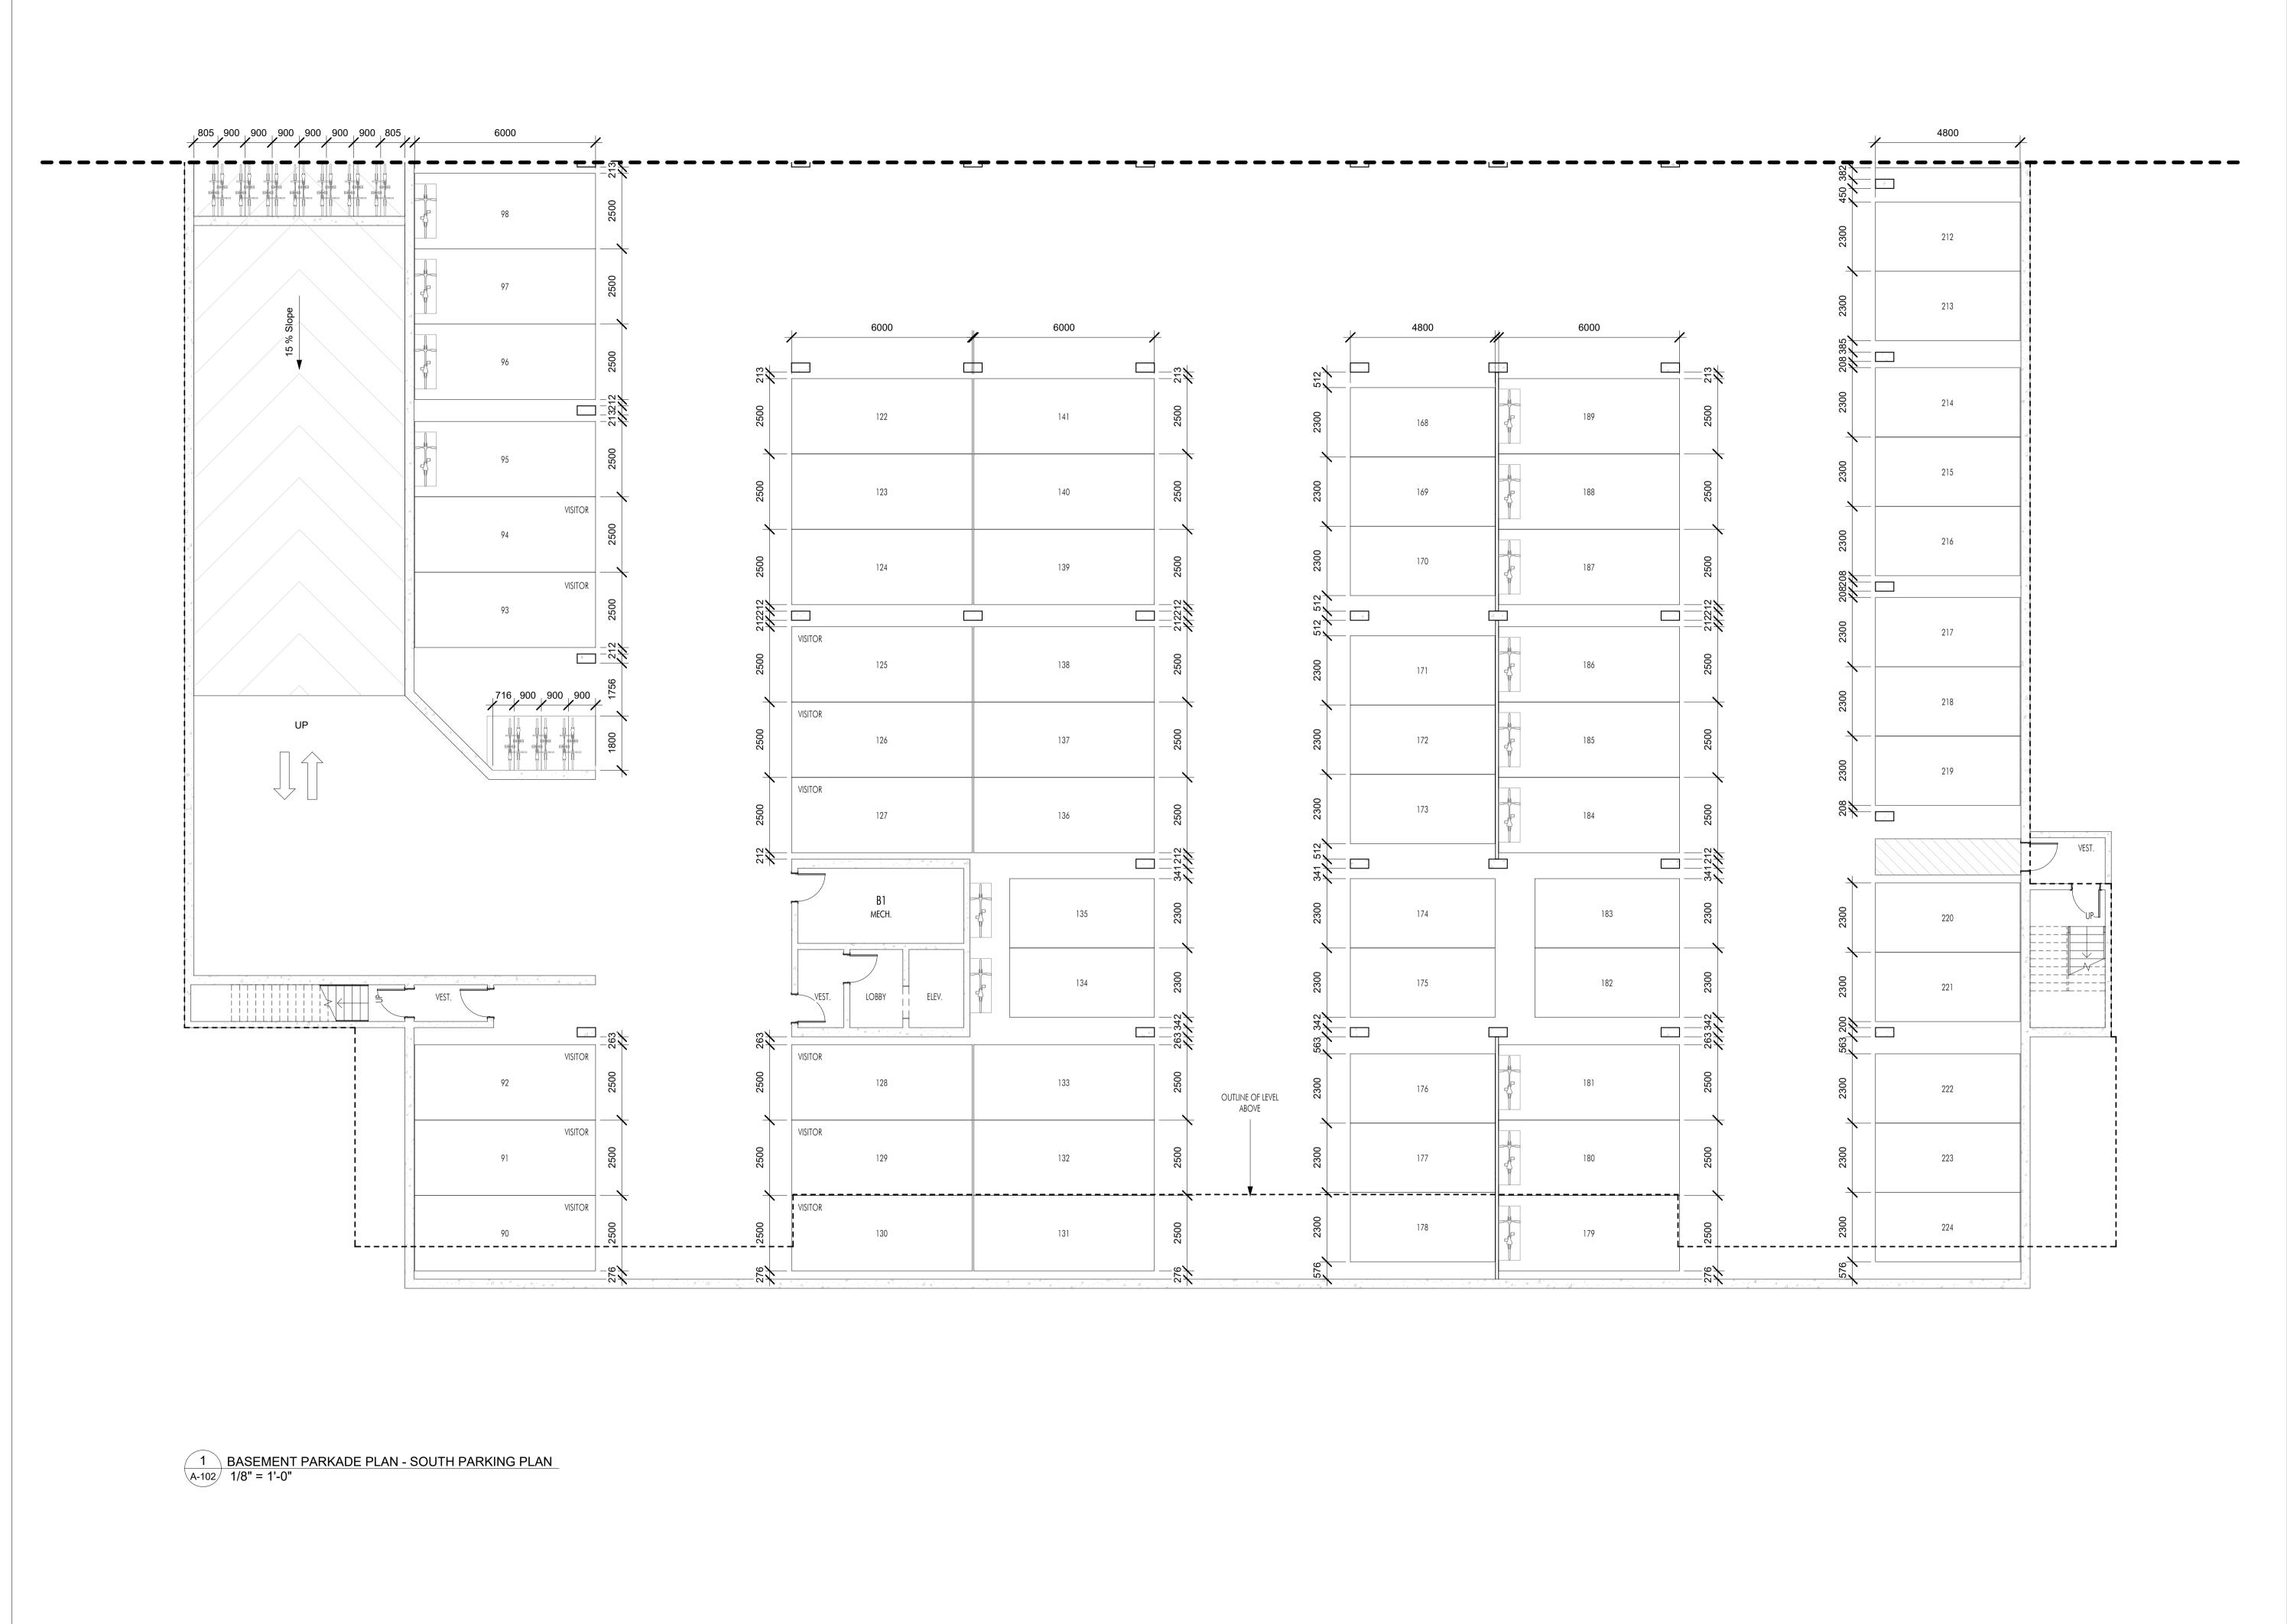



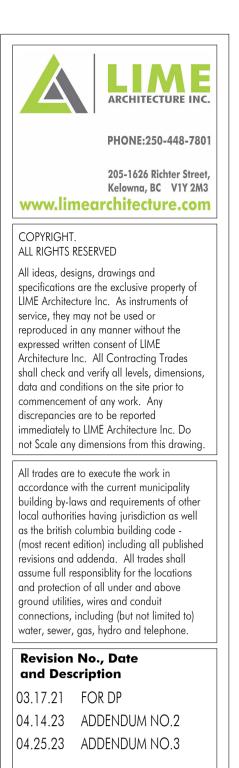

**Plot Date** 04.14.23

PROJECT

Revo (Collinson Rise)

BASEMENT -


PARKING PLAN

DRAWING TITLE

SOUTH

Drawing No.

A-102

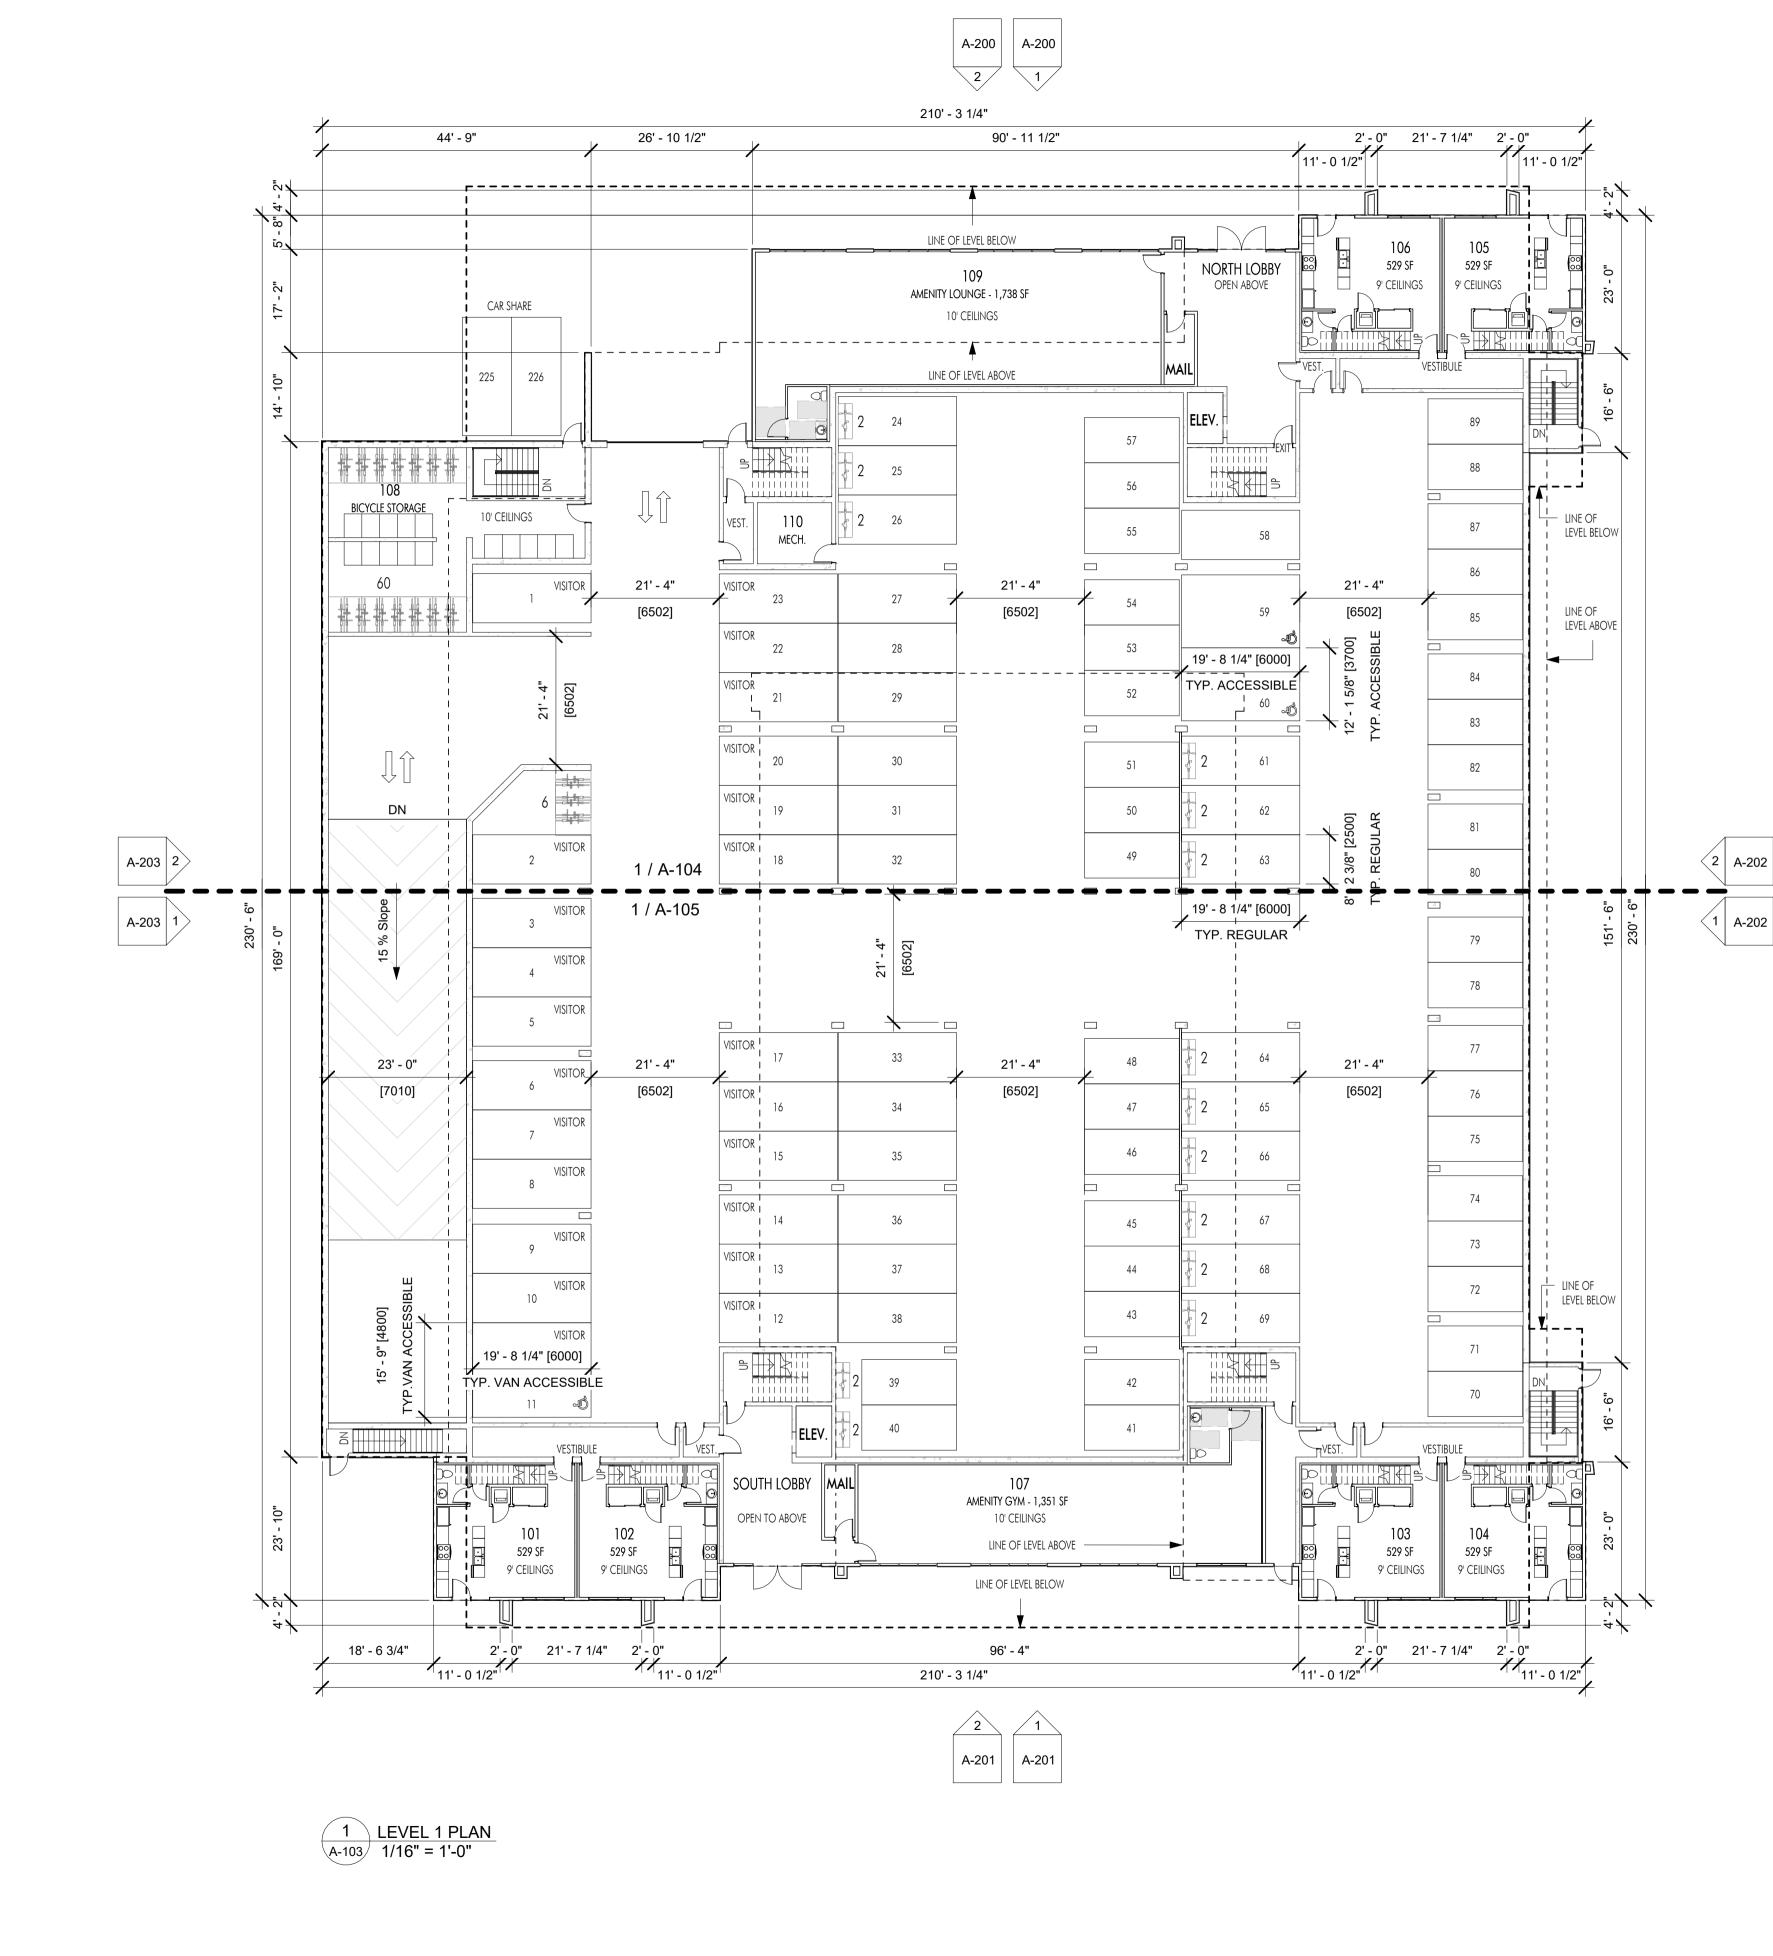



PHONE:250-448-7801

#### 205-1626 Richter Street, Kelowna, BC V1Y 2M3 www.limearchitecture.com

#### COPYRIGHT. ALL RIGHTS RESERVED

All ideas, designs, drawings and specifications are the exclusive property of LIME Architecture Inc. As instruments of service, they may not be used or reproduced in any manner without the expressed written consent of LIME Architecture Inc. All Contracting Trades shall check and verify all levels, dimensions, data and conditions on the site prior to commencement of any work. Any discrepancies are to be reported immediately to LIME Architecture Inc. Do not Scale any dimensions from this drawing. All trades are to execute the work in

accordance with the current municipality building by-laws and requirements of other local authorities having jurisdiction as well as the british columbia building code -(most recent edition) including all published revisions and addenda. All trades shall assume full responsiblity for the locations and protection of all under and above ground utilities, wires and conduit connections, including (but not limited to) water, sewer, gas, hydro and telephone.


#### **Revision No., Date** and Description

und Dest	nphon
02.17.23	FOR COORDINATION
02.25.23	FOR DP
03.17.21	FOR DP
04.14.23	ADDENDUM NO.2
04.25.23	ADDENDUM NO.3

# LEVEL 1 PLAN

Revo (Collinson Rise)

DRAWING TITLE

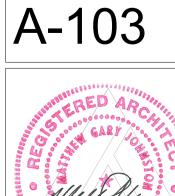


Plot Date


04.14.23

PROJECT


Drawing No.




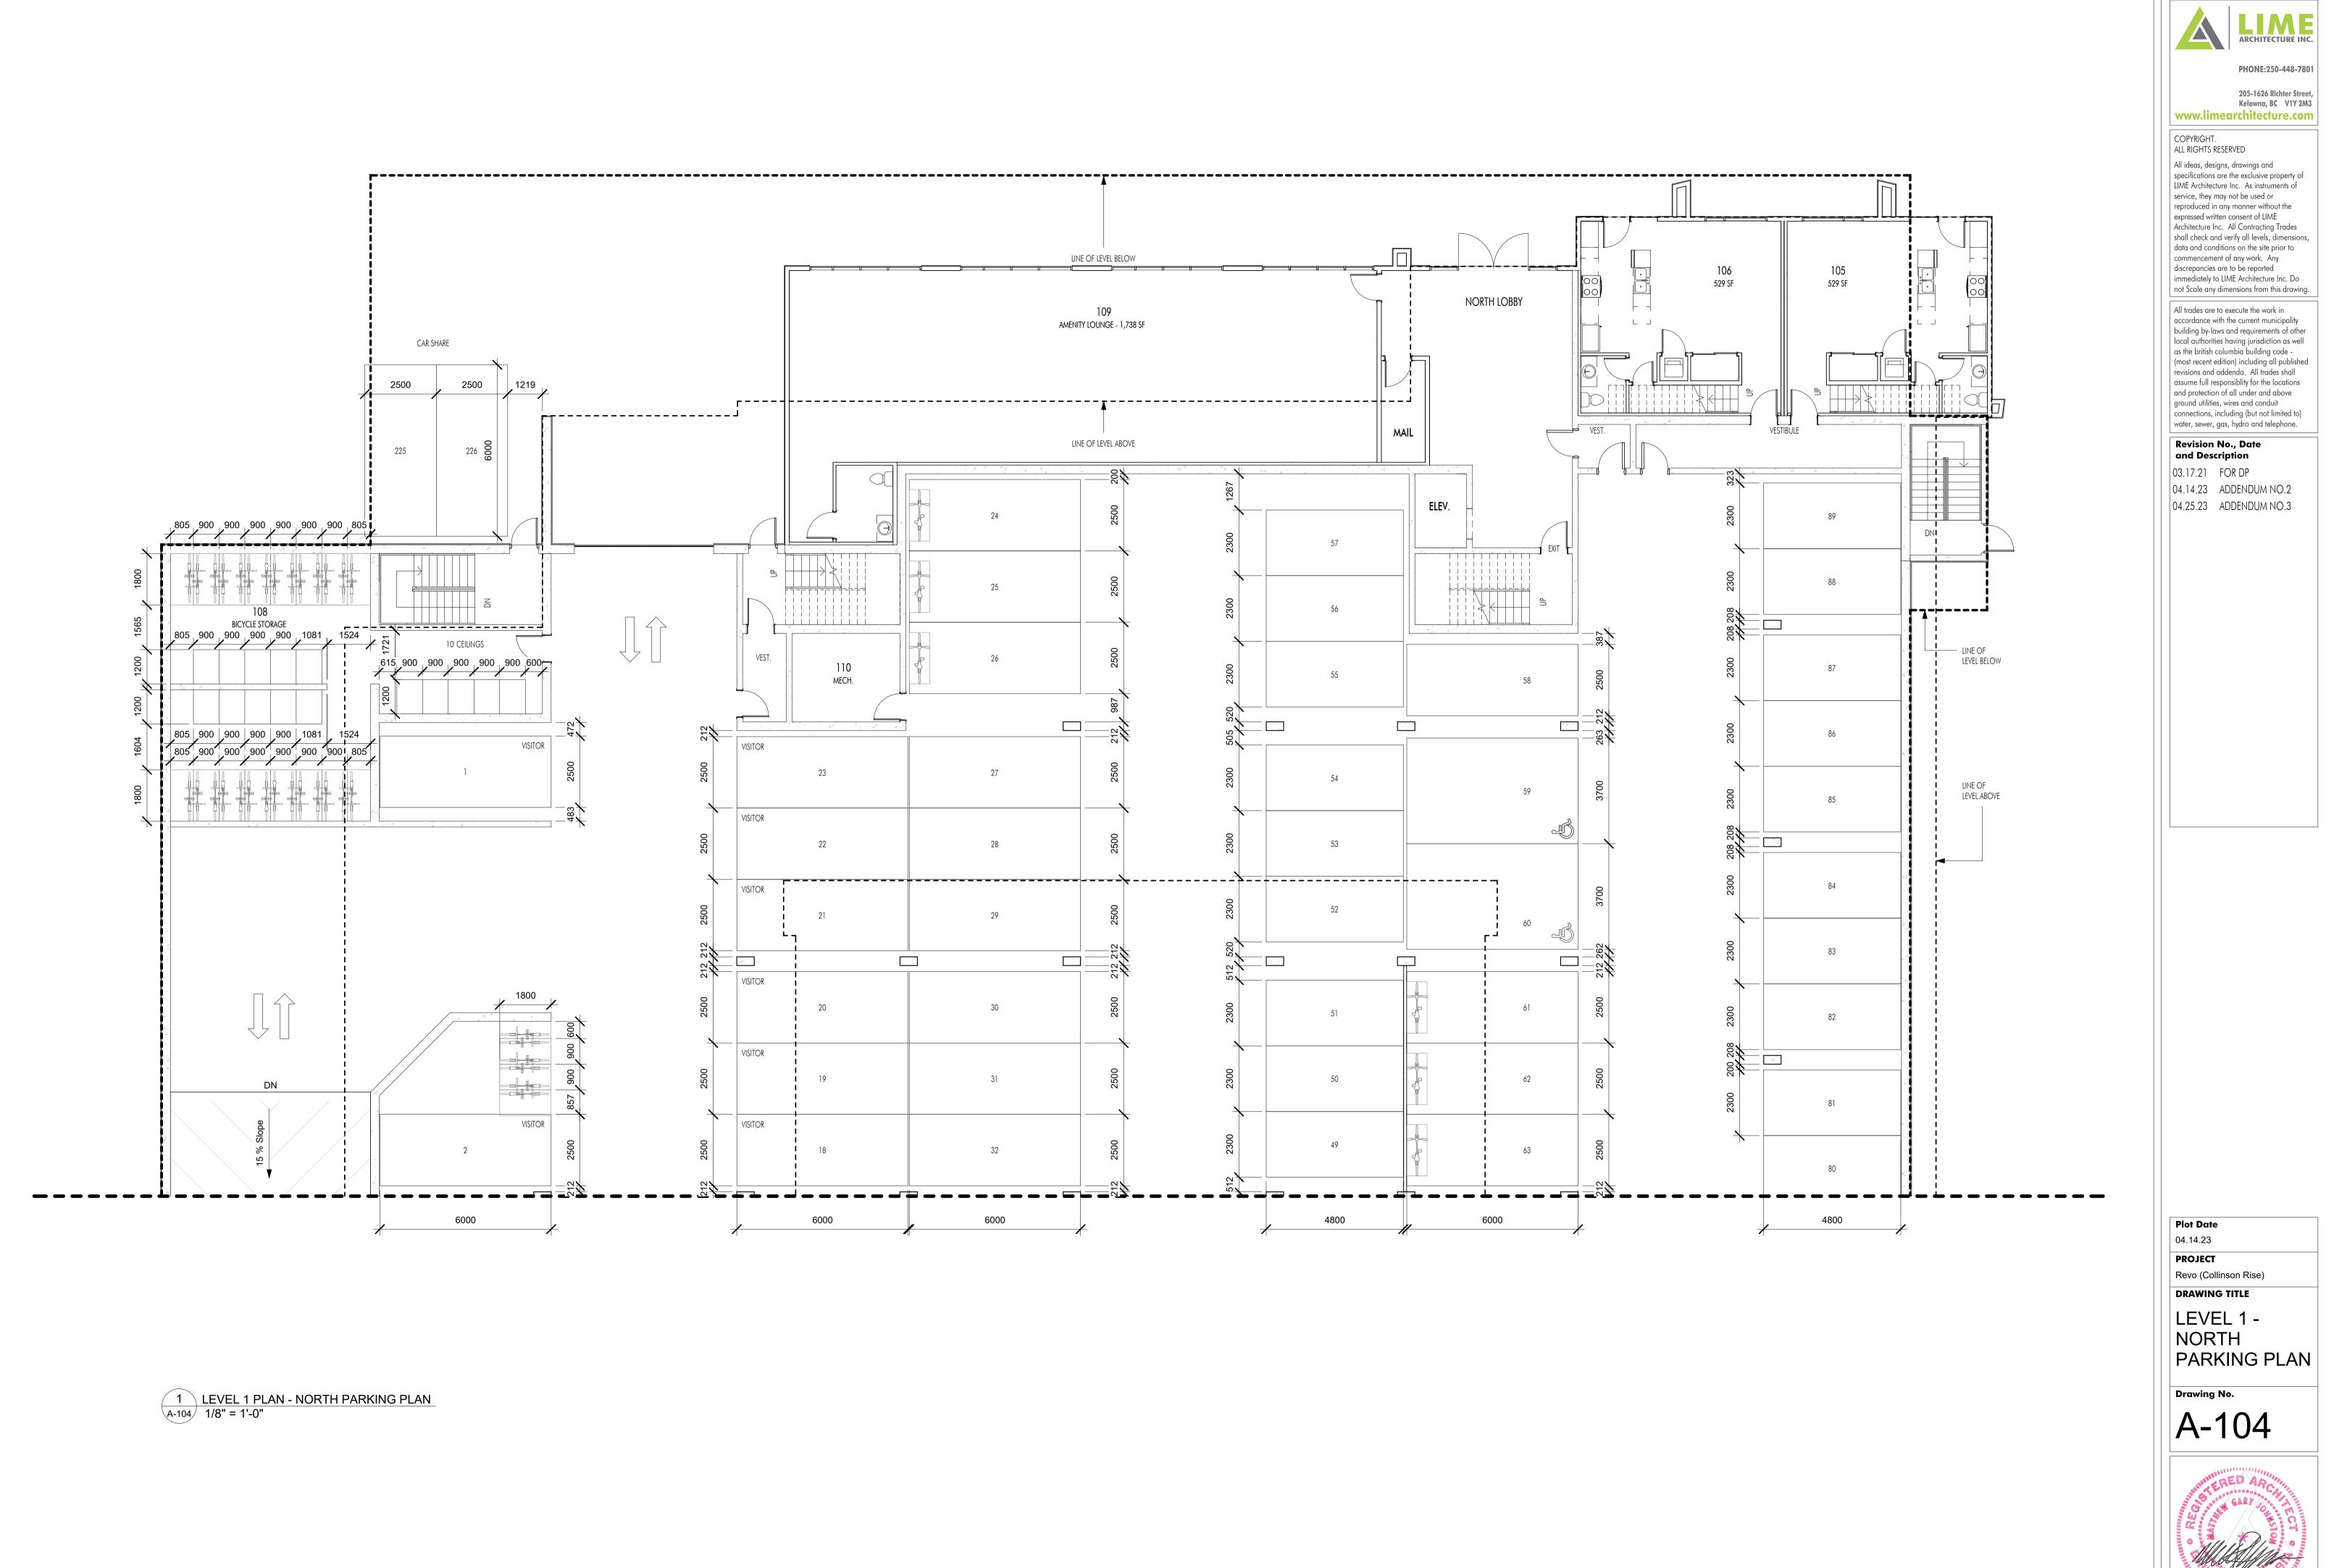

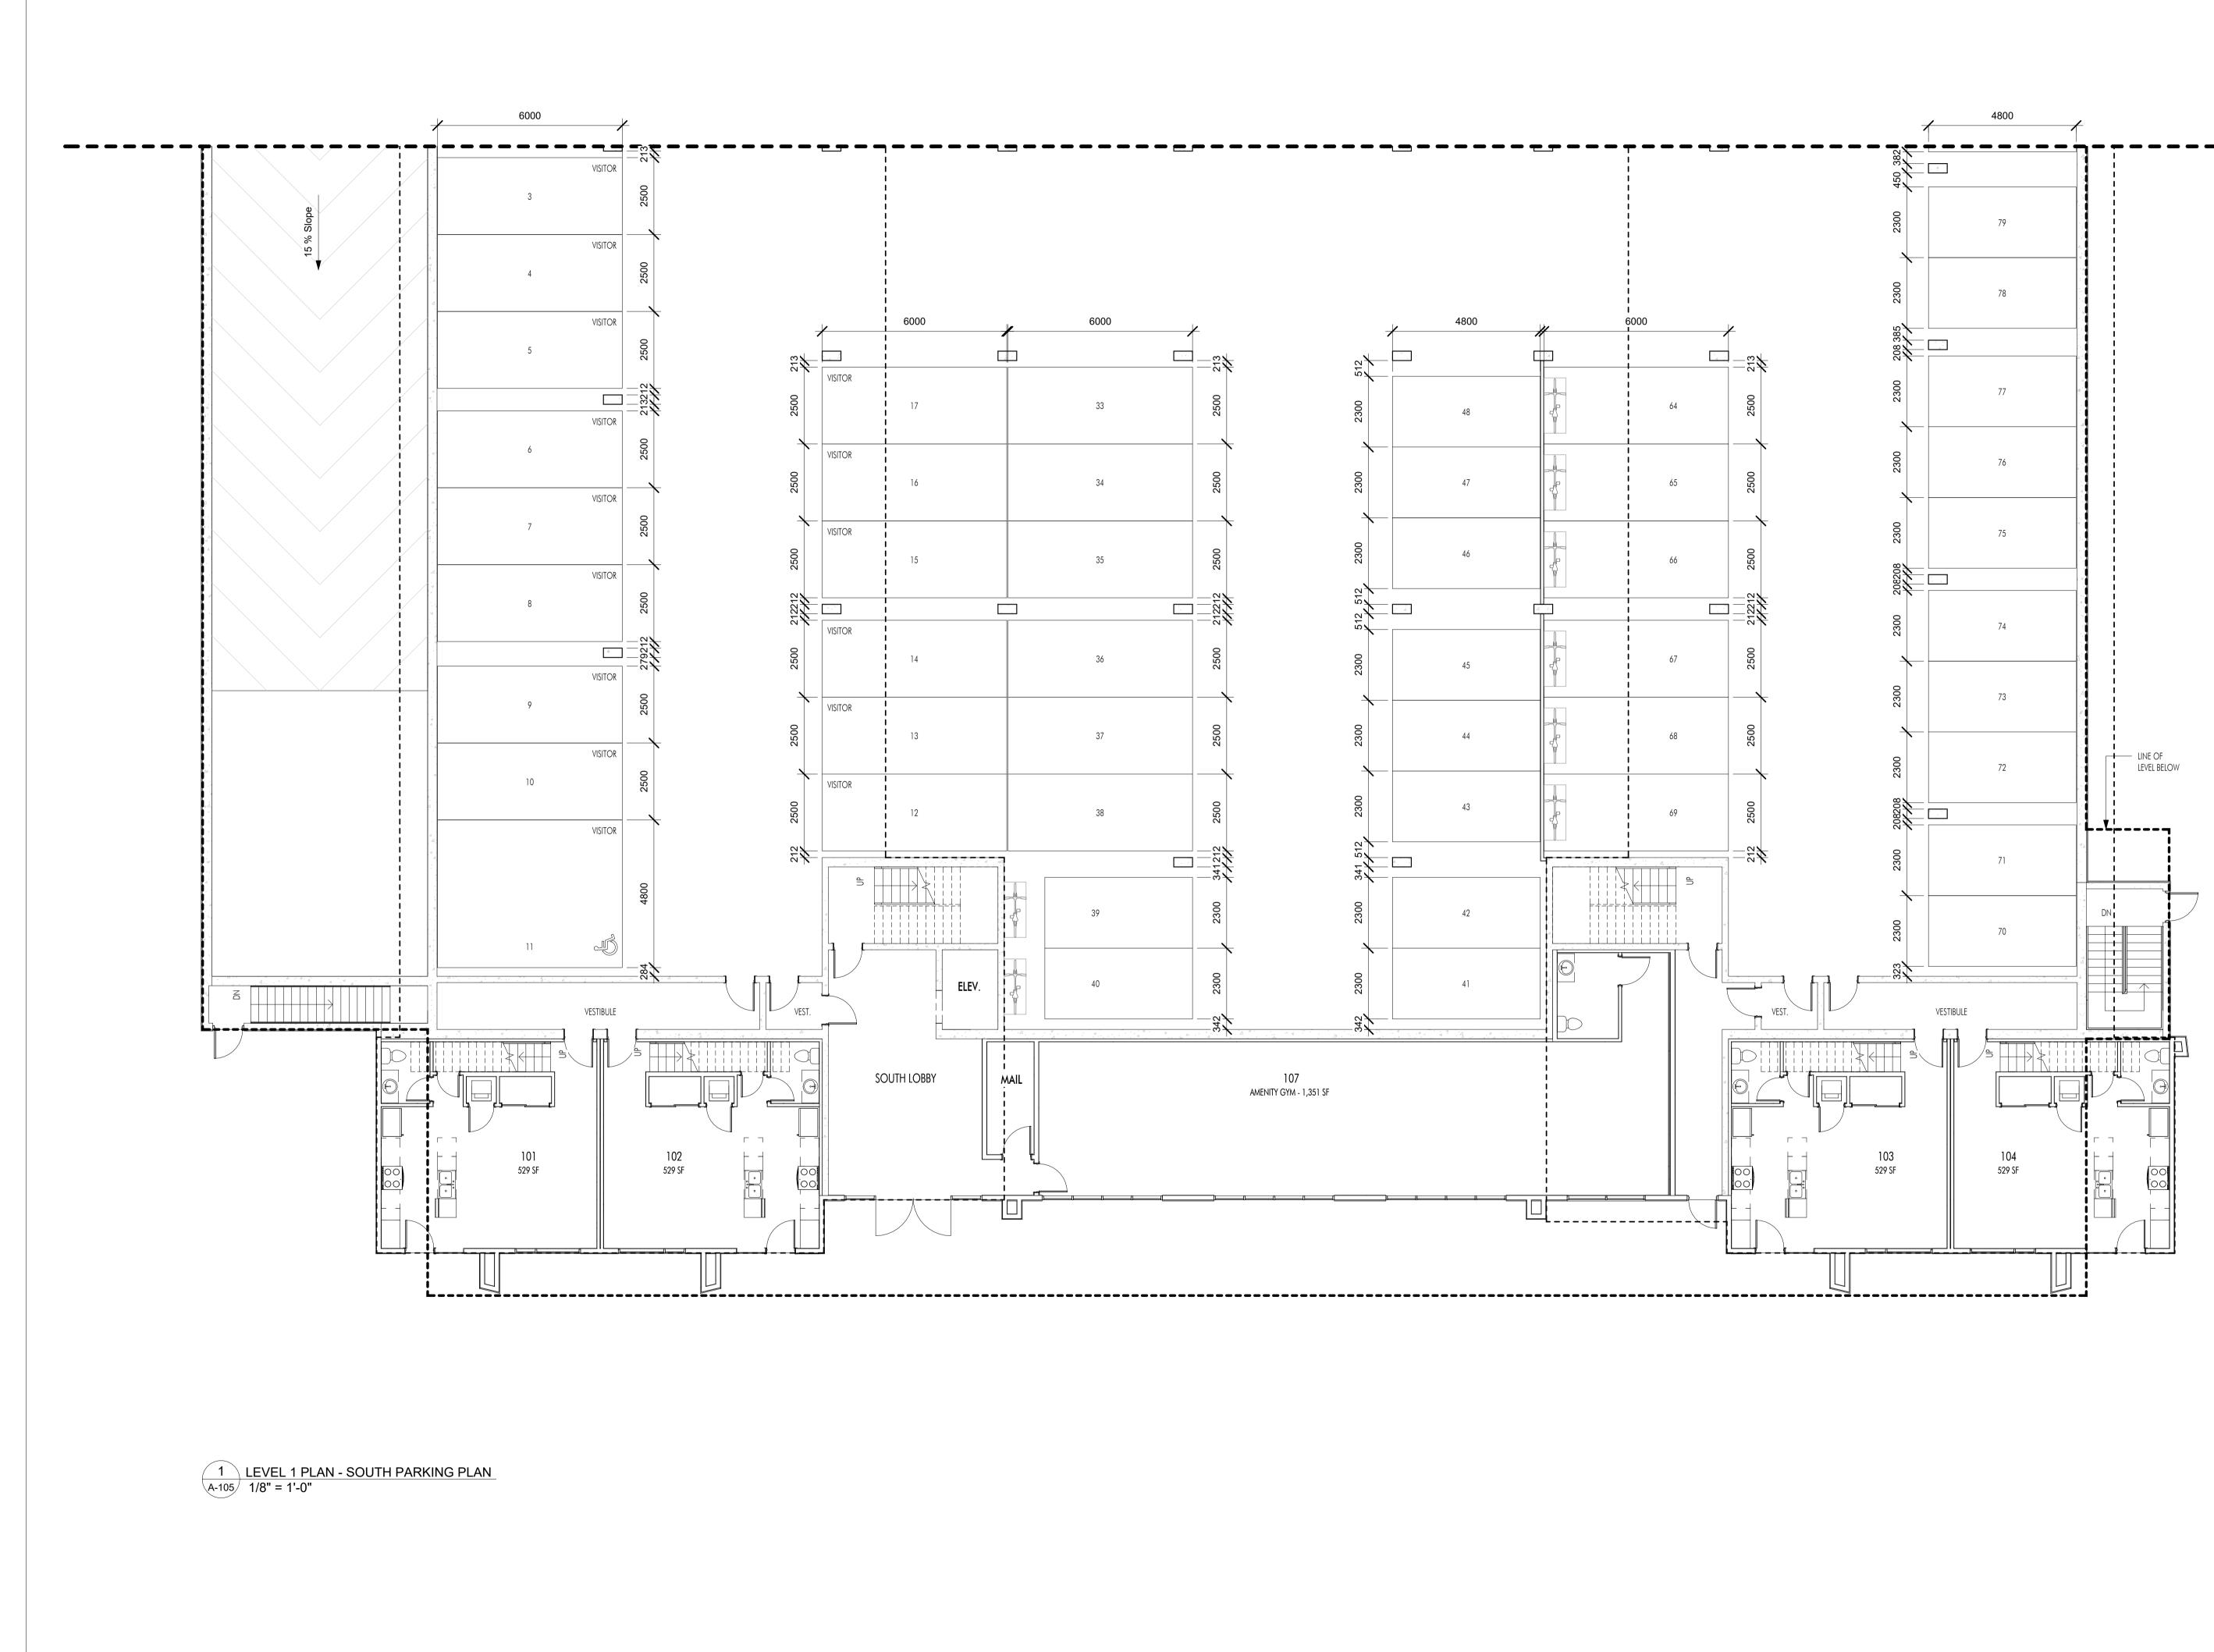



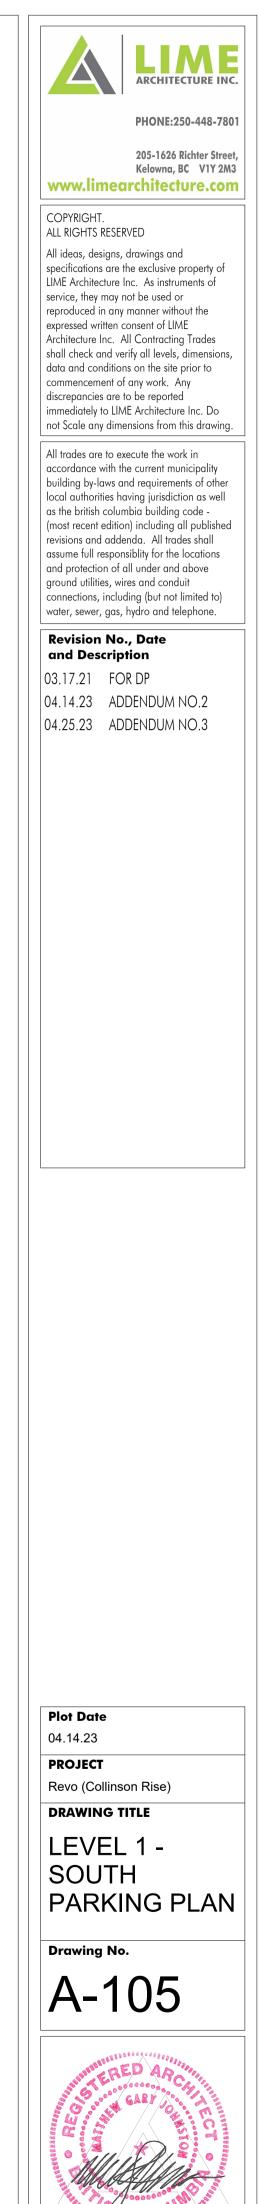

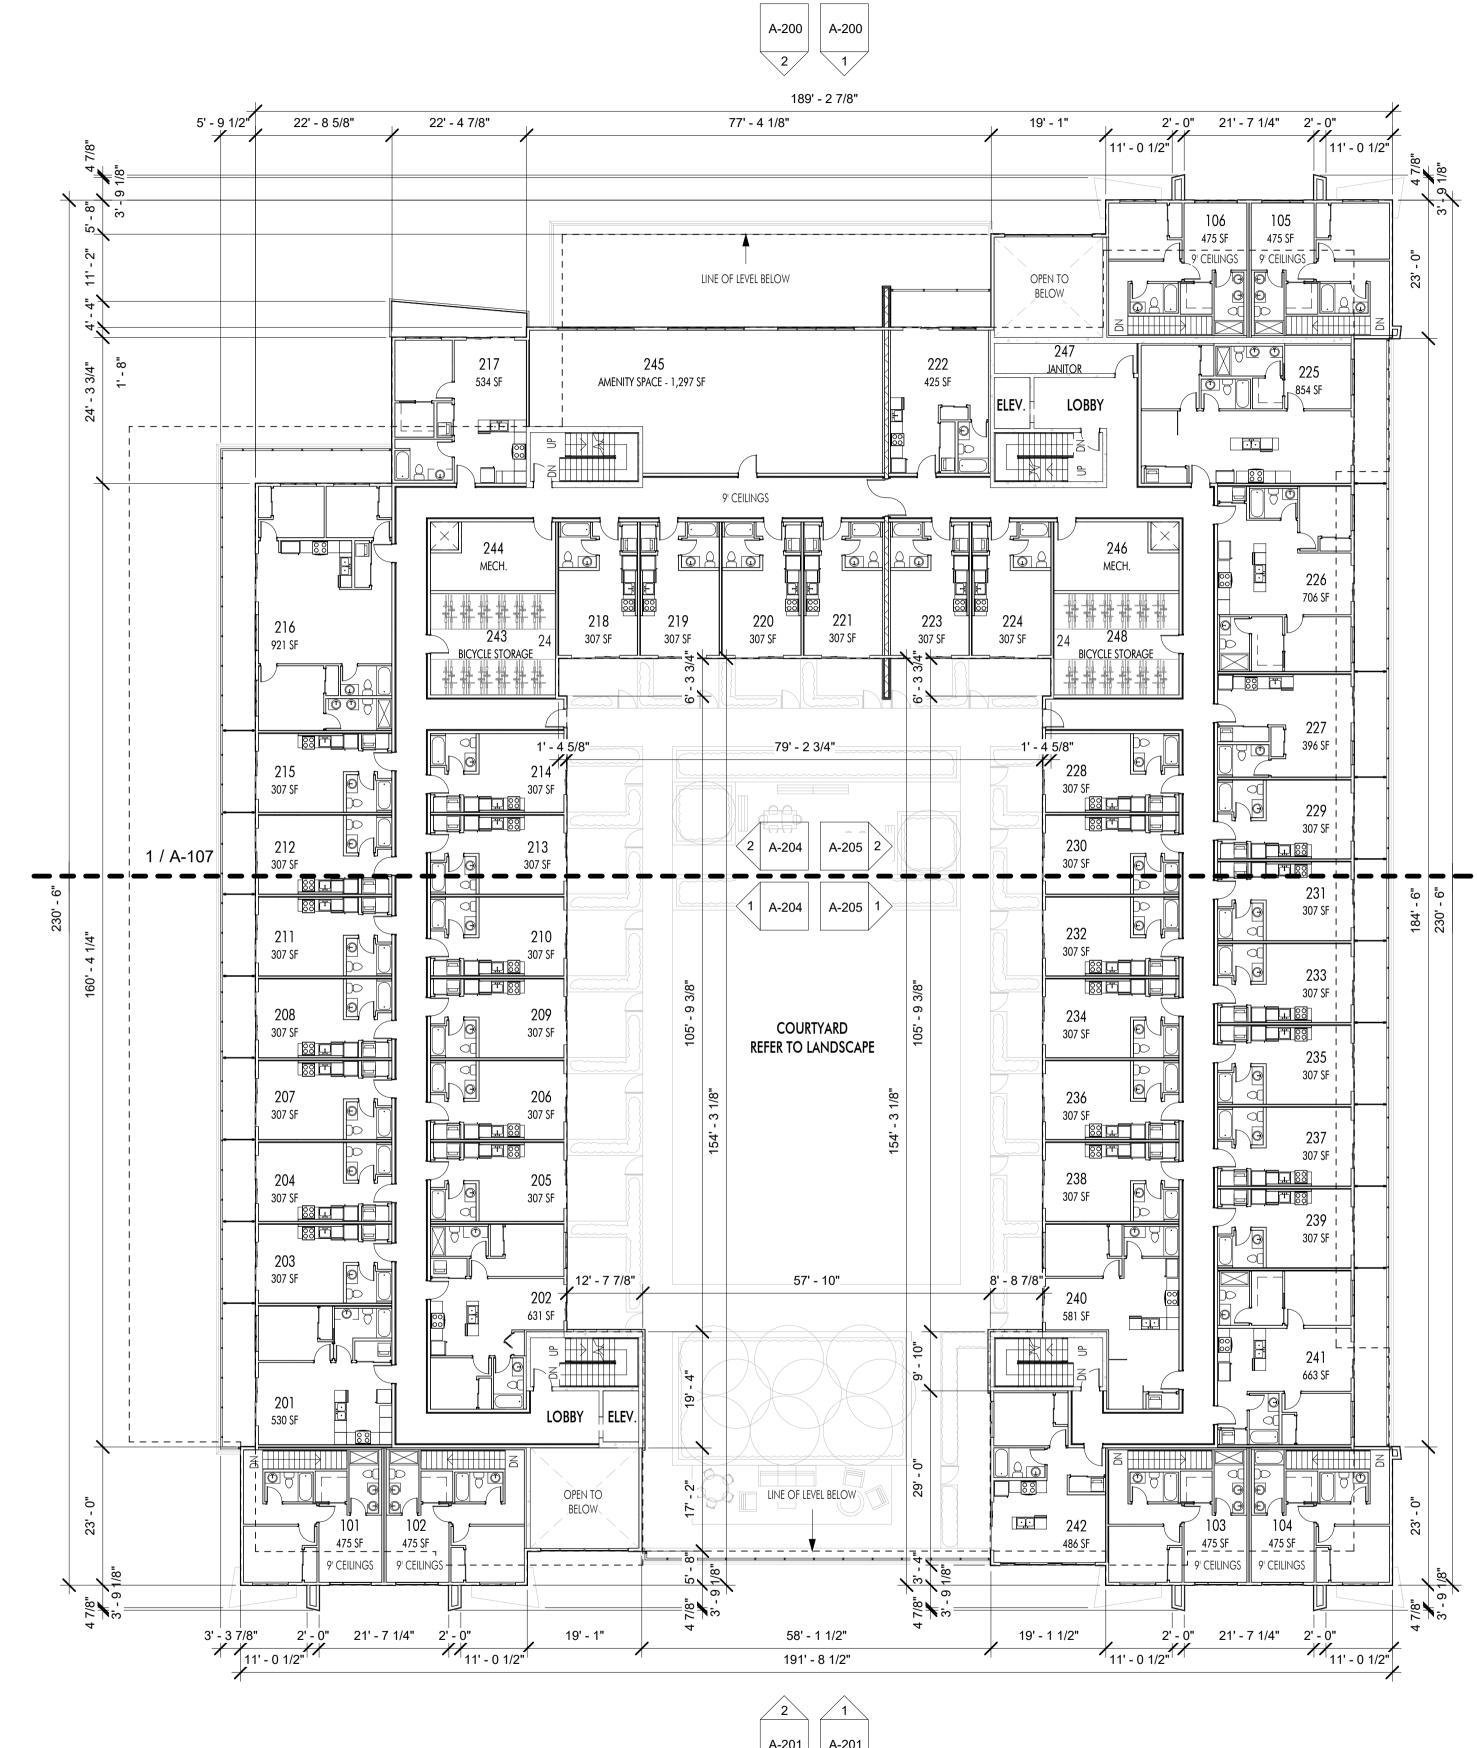

1 LEVEL 2 PLAN A-106 1/16" = 1'-0"

A-201 A-201

## ADDENDUM NO.3



PHONE:250-448-7801

#### 205-1626 Richter Street, Kelowna, BC V1Y 2M3 www.limearchitecture.com

#### COPYRIGHT.

ALL RIGHTS RESERVED All ideas, designs, drawings and specifications are the exclusive property of LIME Architecture Inc. As instruments of service, they may not be used or reproduced in any manner without the expressed written consent of LIME Architecture Inc. All Contracting Trades shall check and verify all levels, dimensions, data and conditions on the site prior to commencement of any work. Any discrepancies are to be reported immediately to LIME Architecture Inc. Do not Scale any dimensions from this drawing. All trades are to execute the work in accordance with the current municipality building by-laws and requirements of other local authorities having jurisdiction as well as the british columbia building code -(most recent edition) including all published revisions and addenda. All trades shall assume full responsiblity for the locations and protection of all under and above ground utilities, wires and conduit connections, including (but not limited to) water, sewer, gas, hydro and telephone. **Revision No., Date** and Description 02.17.23 FOR COORDINATION 02.25.23 FOR DP 03.06.23 FOR DP 03.17.21 FOR DP

04.14.23 ADDENDUM NO.2

# A-106



Plot Date

04.14.23


PROJECT


Revo (Collinson Rise)

LEVEL 2 PLAN

DRAWING TITLE

Drawing No.

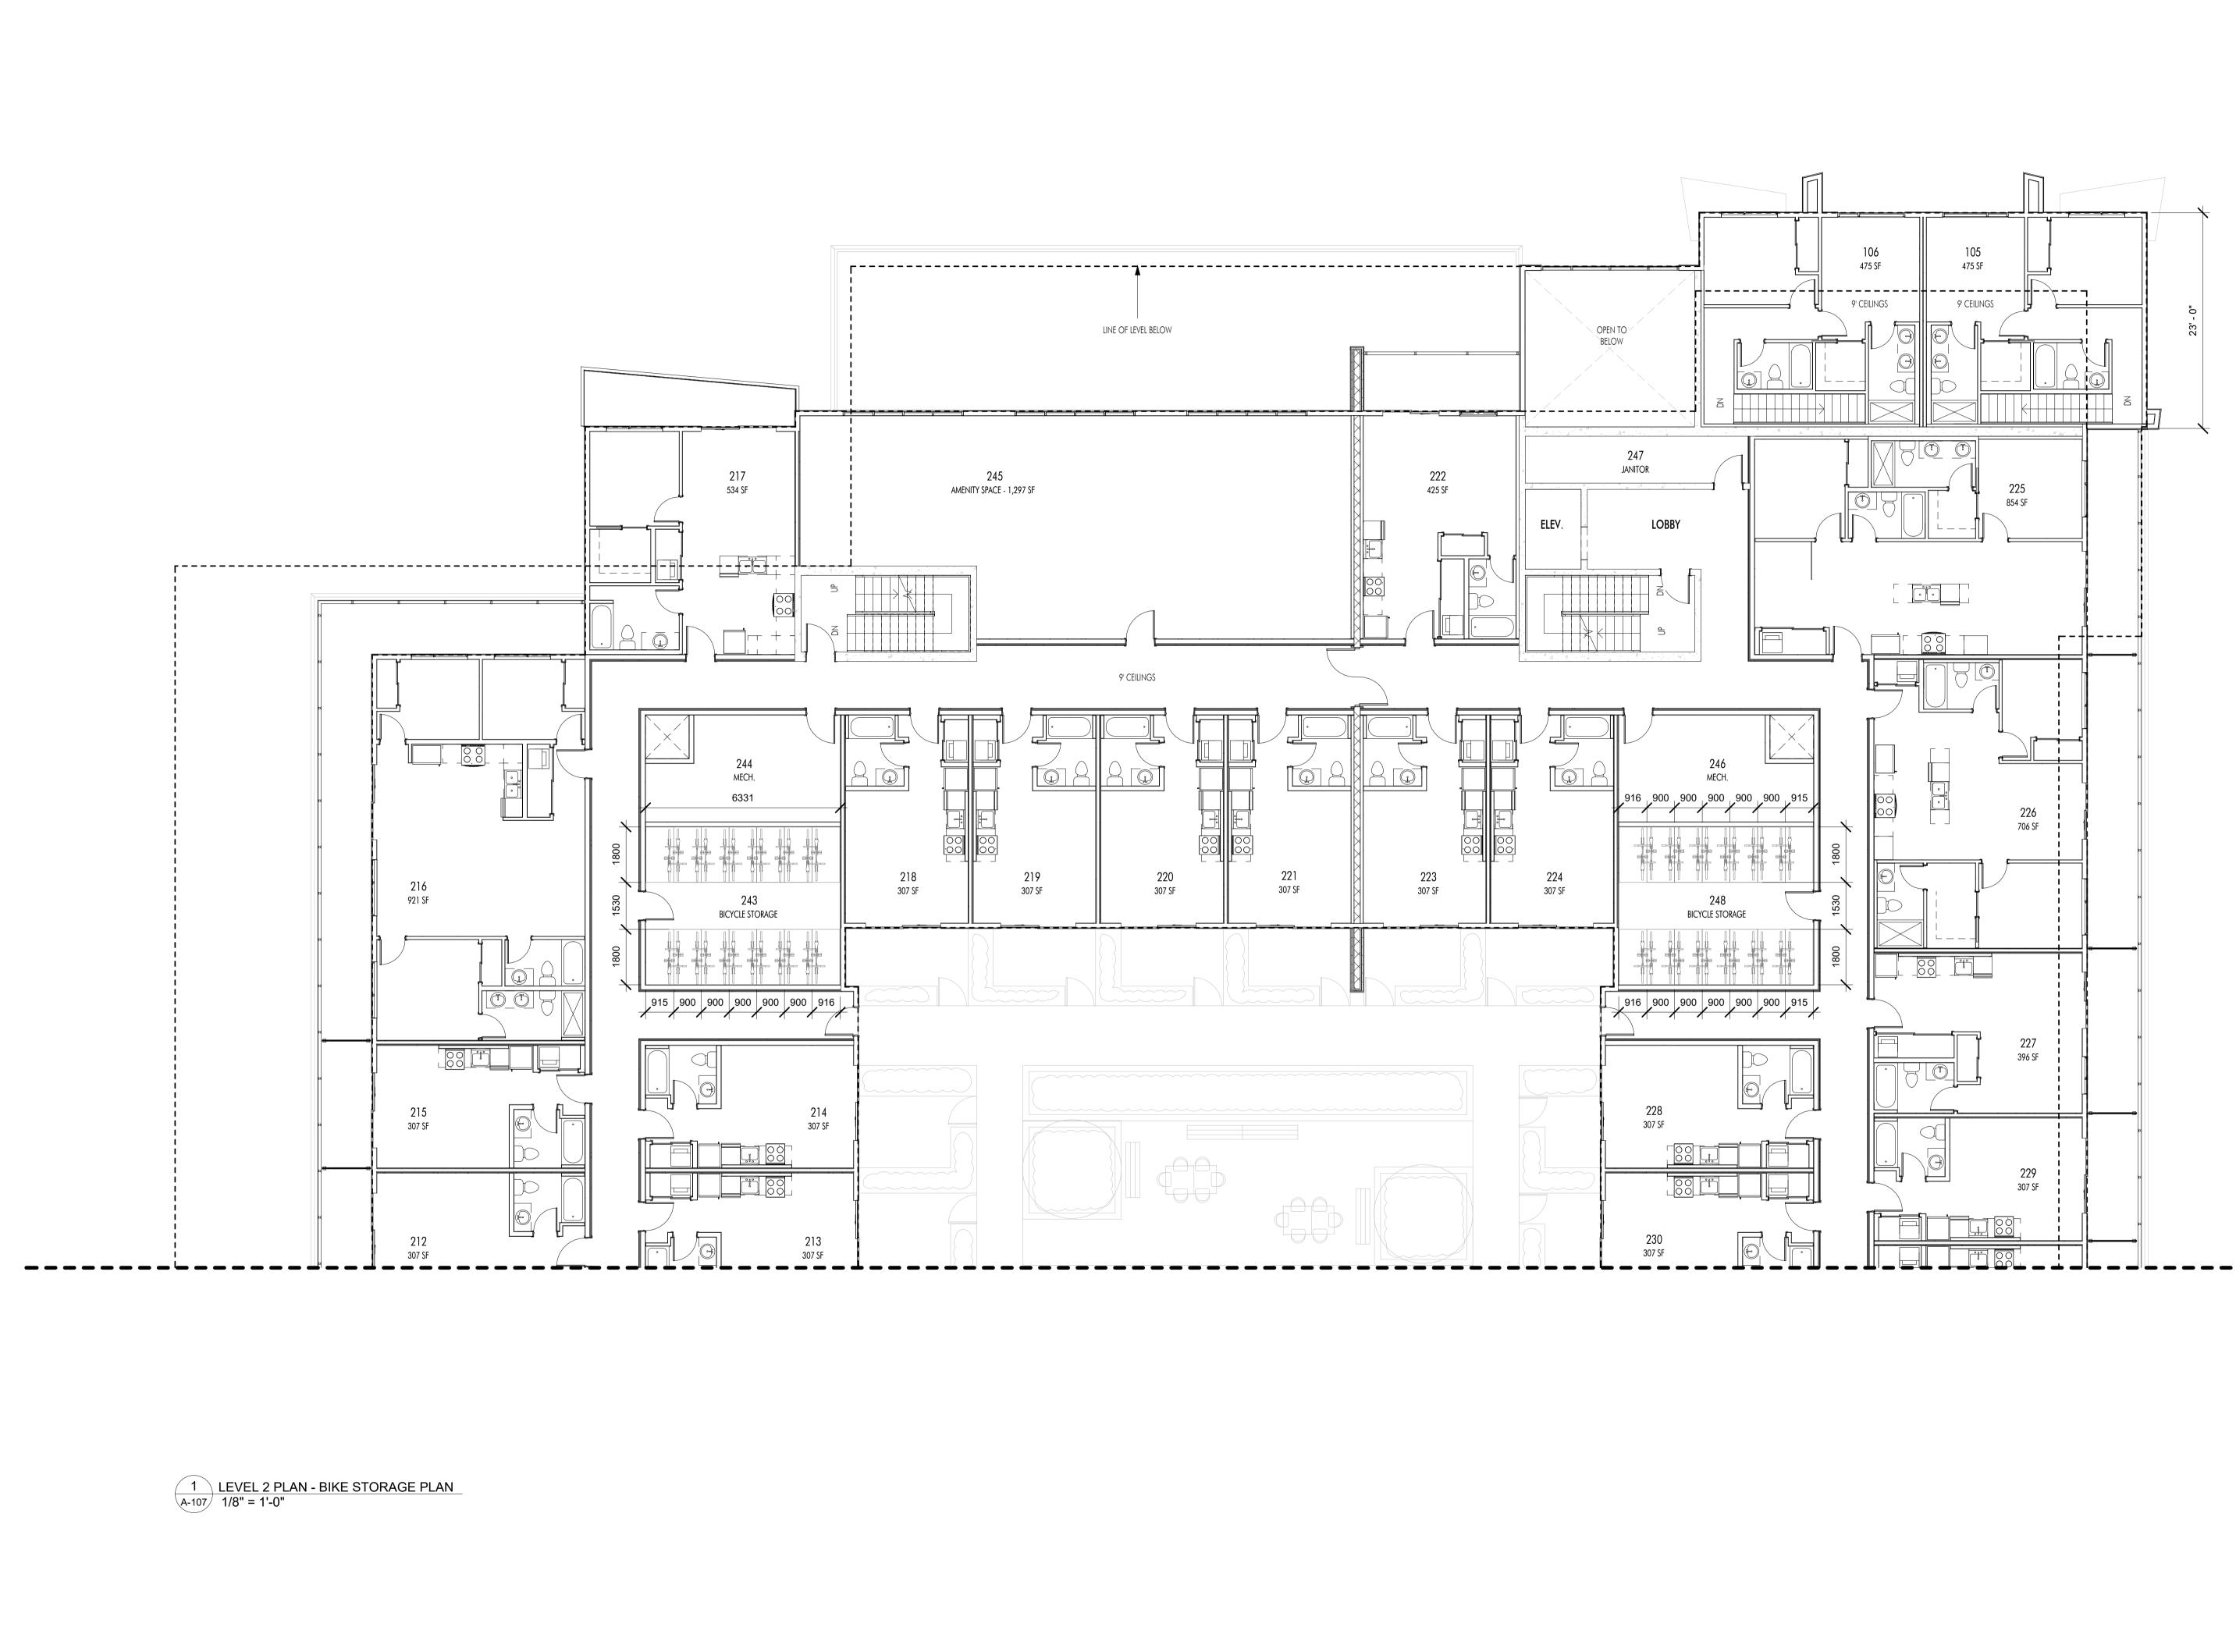

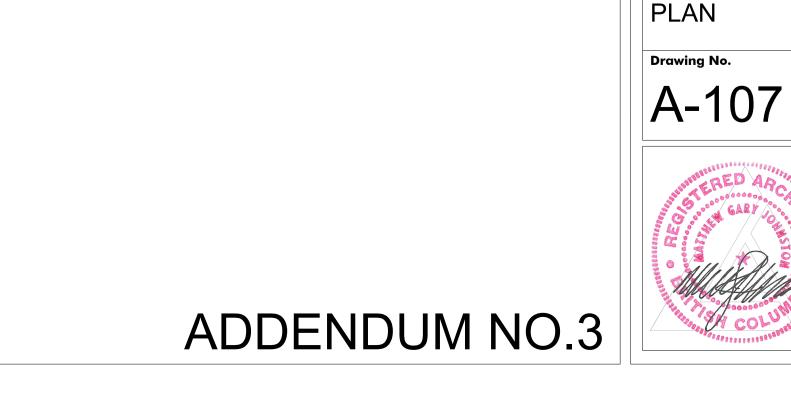



#### PHONE:250-448-7801

205-1626 Richter Street, Kelowna, BC V1Y 2M3 www.limearchitecture.com

#### COPYRIGHT. ALL RIGHTS RESERVED

All ideas, designs, drawings and specifications are the exclusive property of LIME Architecture Inc. As instruments of service, they may not be used or reproduced in any manner without the expressed written consent of LIME Architecture Inc. All Contracting Trades shall check and verify all levels, dimensions, data and conditions on the site prior to commencement of any work. Any discrepancies are to be reported immediately to LIME Architecture Inc. Do not Scale any dimensions from this drawing. All trades are to execute the work in accordance with the current municipality building by-laws and requirements of other local authorities having jurisdiction as well as the british columbia building code -(most recent edition) including all published revisions and addenda. All trades shall assume full responsiblity for the locations and protection of all under and above ground utilities, wires and conduit connections, including (but not limited to) water, sewer, gas, hydro and telephone. **Revision No., Date** 

#### and Description

03.17.21 FOR DP 04.14.23 ADDENDUM NO.2

#### Plot Date 04.14.23


PROJECT

Revo (Collinson Rise) DRAWING TITLE

LEVEL 2 - BIKE STORAGE

PLAN

Drawing No.

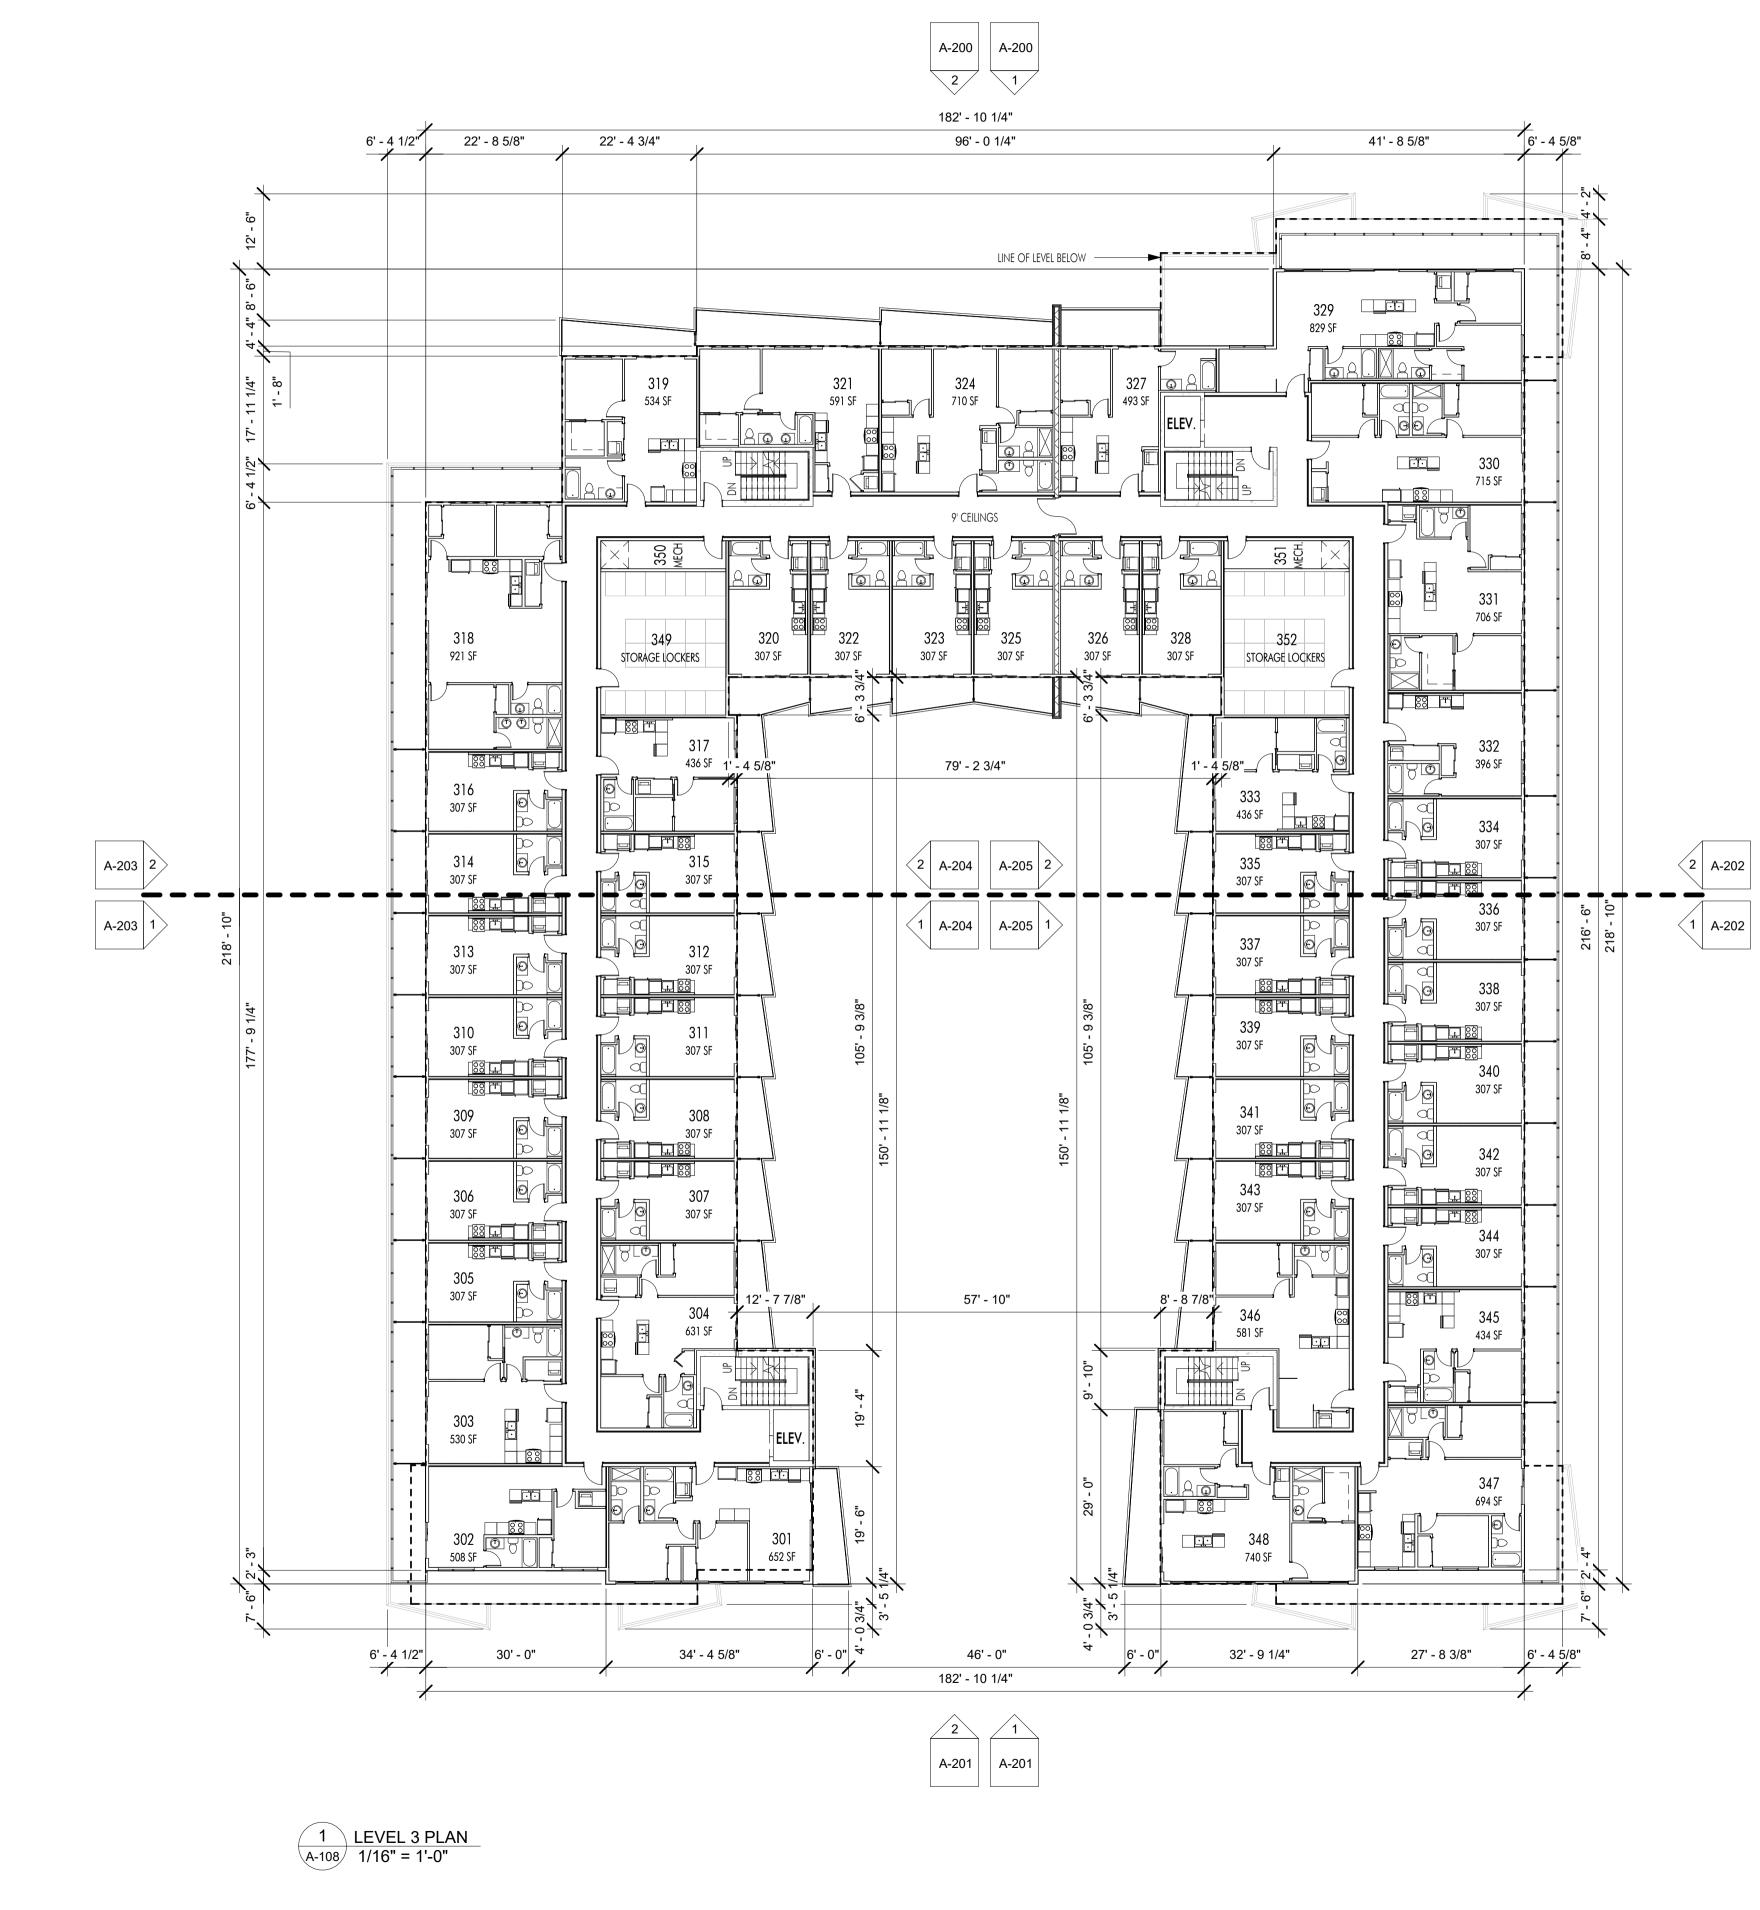



PHONE:250-448-7801

#### 205-1626 Richter Street, Kelowna, BC V1Y 2M3 www.limearchitecture.com


#### COPYRIGHT. ALL RIGHTS RESERVED

All ideas, designs, drawings and specifications are the exclusive property of LIME Architecture Inc. As instruments of service, they may not be used or reproduced in any manner without the expressed written consent of LIME Architecture Inc. All Contracting Trades shall check and verify all levels, dimensions, data and conditions on the site prior to commencement of any work. Any discrepancies are to be reported immediately to LIME Architecture Inc. Do not Scale any dimensions from this drawing. All trades are to execute the work in accordance with the current municipality

building by-laws and requirements of other local authorities having jurisdiction as well as the british columbia building code -(most recent edition) including all published revisions and addenda. All trades shall assume full responsiblity for the locations and protection of all under and above ground utilities, wires and conduit connections, including (but not limited to) water, sewer, gas, hydro and telephone.

#### **Revision No., Date** and Description

02.17.23 FOR COORDINATION 02.25.23 FOR DP 03.06.23 FOR DP 03.17.21 FOR DP

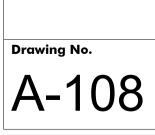


DRAWING TITLE

Plot Date

04.14.23

PROJECT Revo (Collinson Rise)

LEVEL 3 PLAN

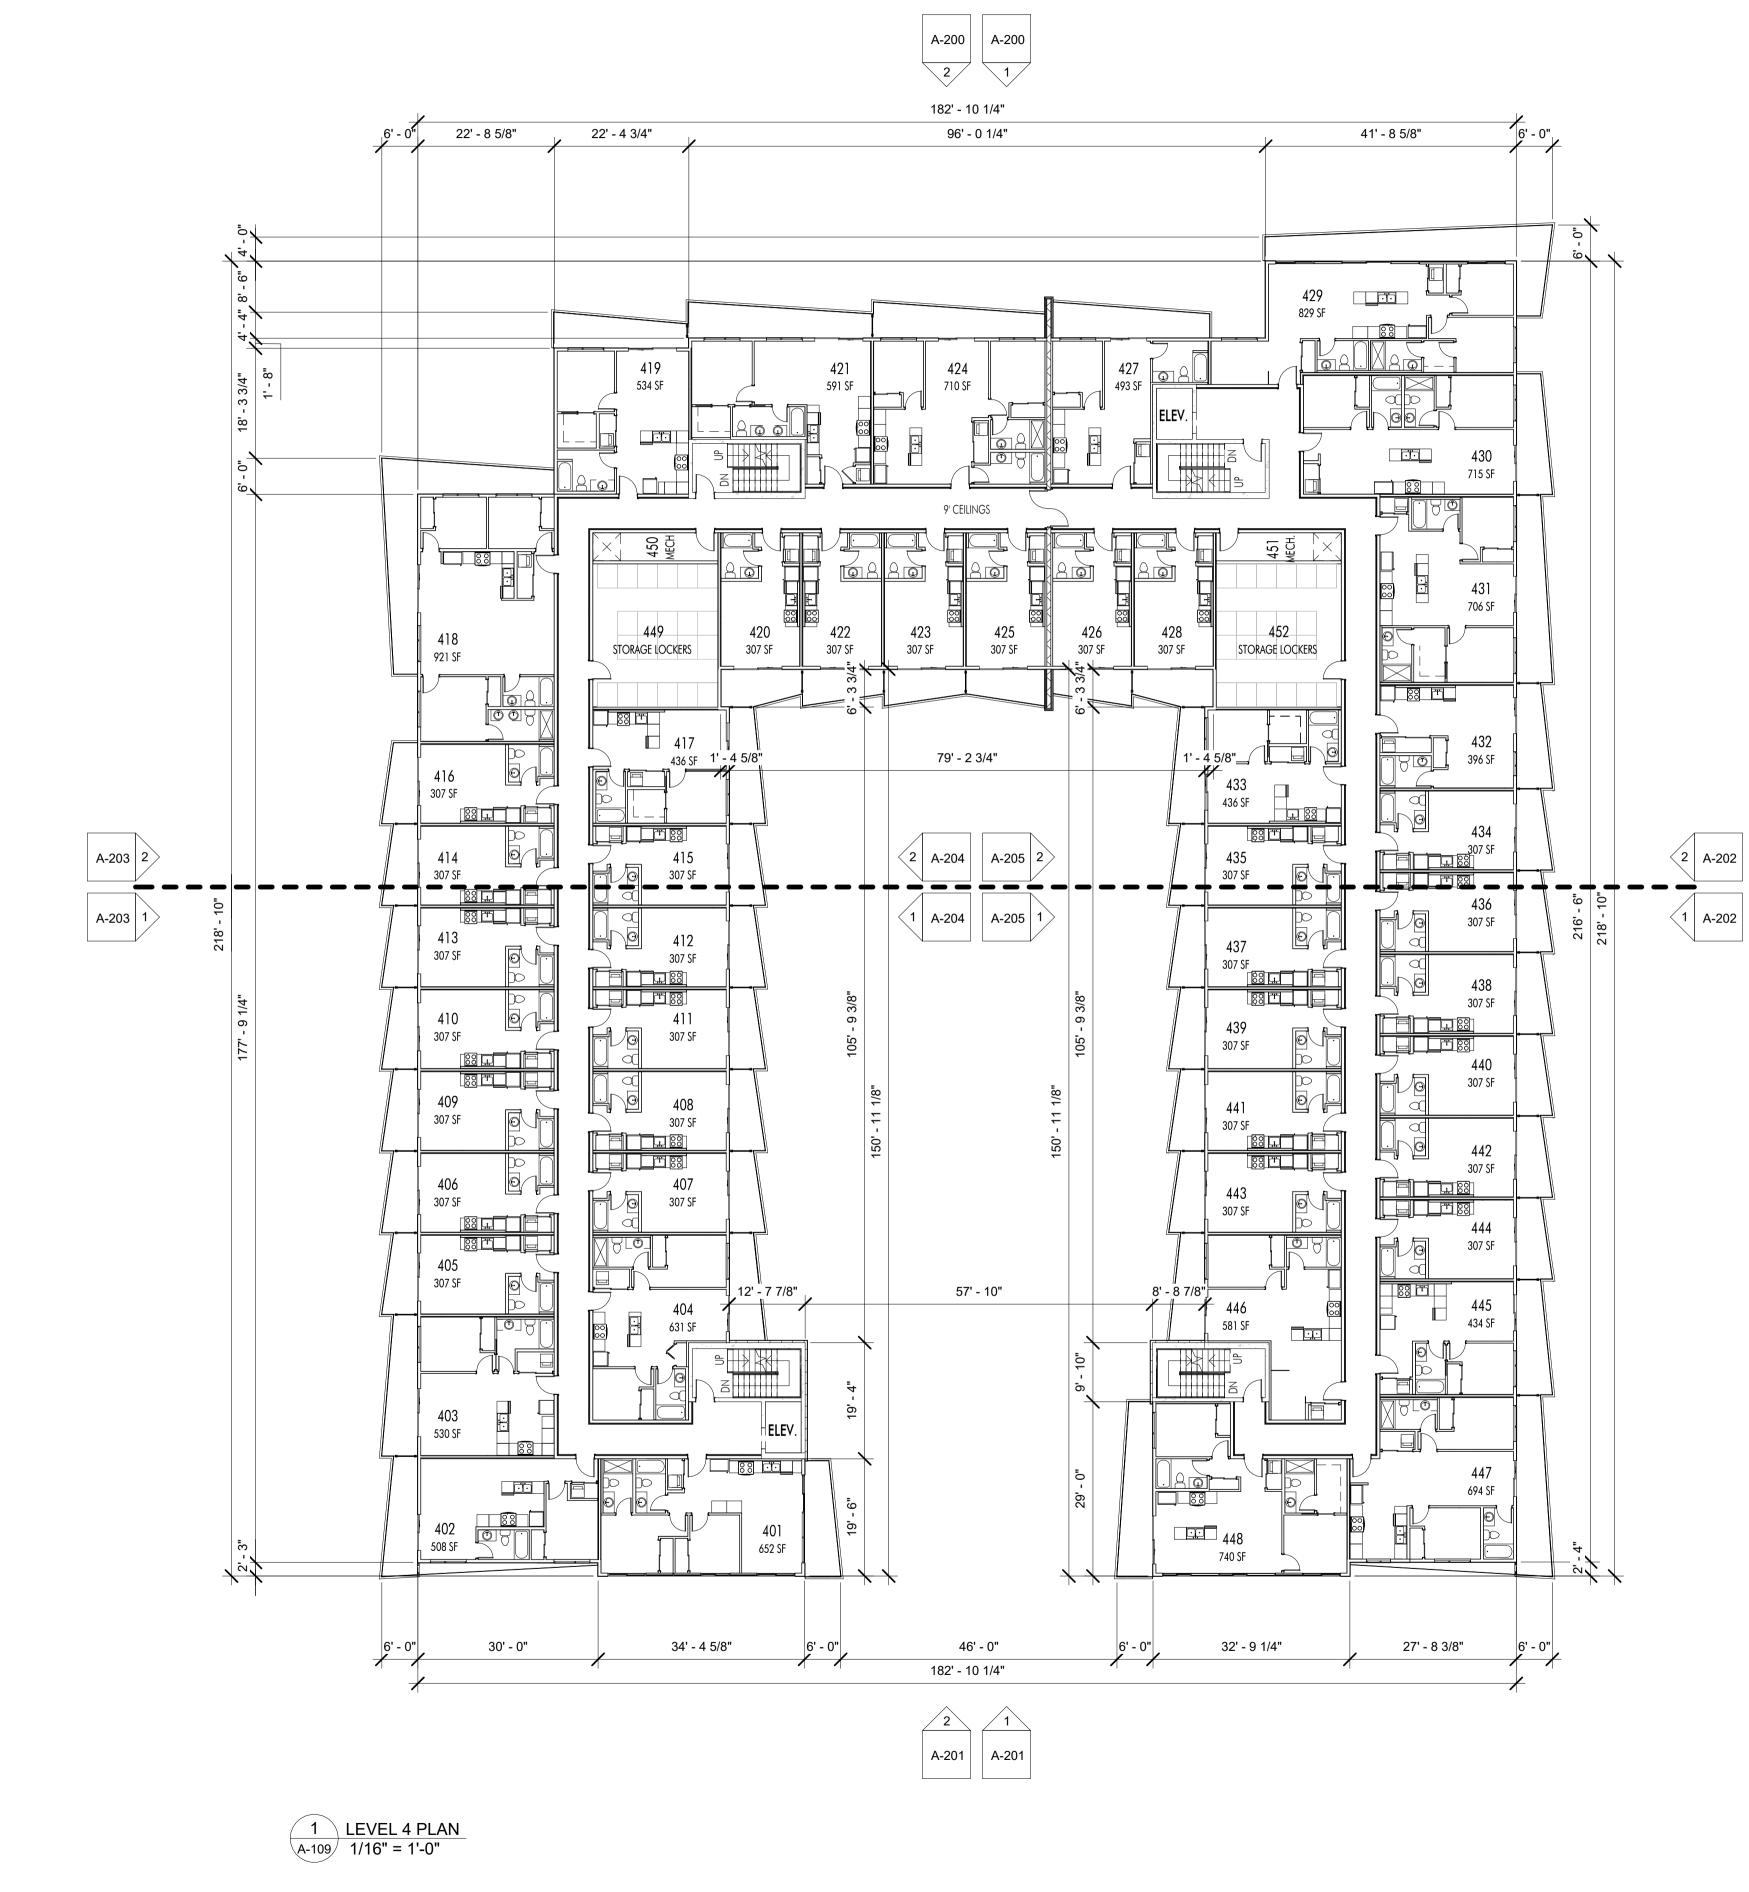



PHONE:250-448-7801

#### 205-1626 Richter Street, Kelowna, BC V1Y 2M3 www.limearchitecture.com


#### COPYRIGHT. ALL RIGHTS RESERVED

All ideas, designs, drawings and specifications are the exclusive property of LIME Architecture Inc. As instruments of service, they may not be used or reproduced in any manner without the expressed written consent of LIME Architecture Inc. All Contracting Trades shall check and verify all levels, dimensions, data and conditions on the site prior to commencement of any work. Any discrepancies are to be reported immediately to LIME Architecture Inc. Do not Scale any dimensions from this drawing. All trades are to execute the work in accordance with the current municipality

building by-laws and requirements of other local authorities having jurisdiction as well as the british columbia building code -(most recent edition) including all published revisions and addenda. All trades shall assume full responsiblity for the locations and protection of all under and above ground utilities, wires and conduit connections, including (but not limited to) water, sewer, gas, hydro and telephone.

#### **Revision No., Date** and Description

02.17.23 FOR COORDINATION 02.25.23 FOR DP 03.06.23 FOR DP 03.17.21 FOR DP

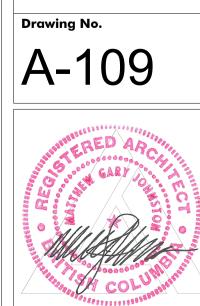


LEVEL 4 PLAN

Revo (Collinson Rise) DRAWING TITLE

PROJECT

Plot Date

04.14.23

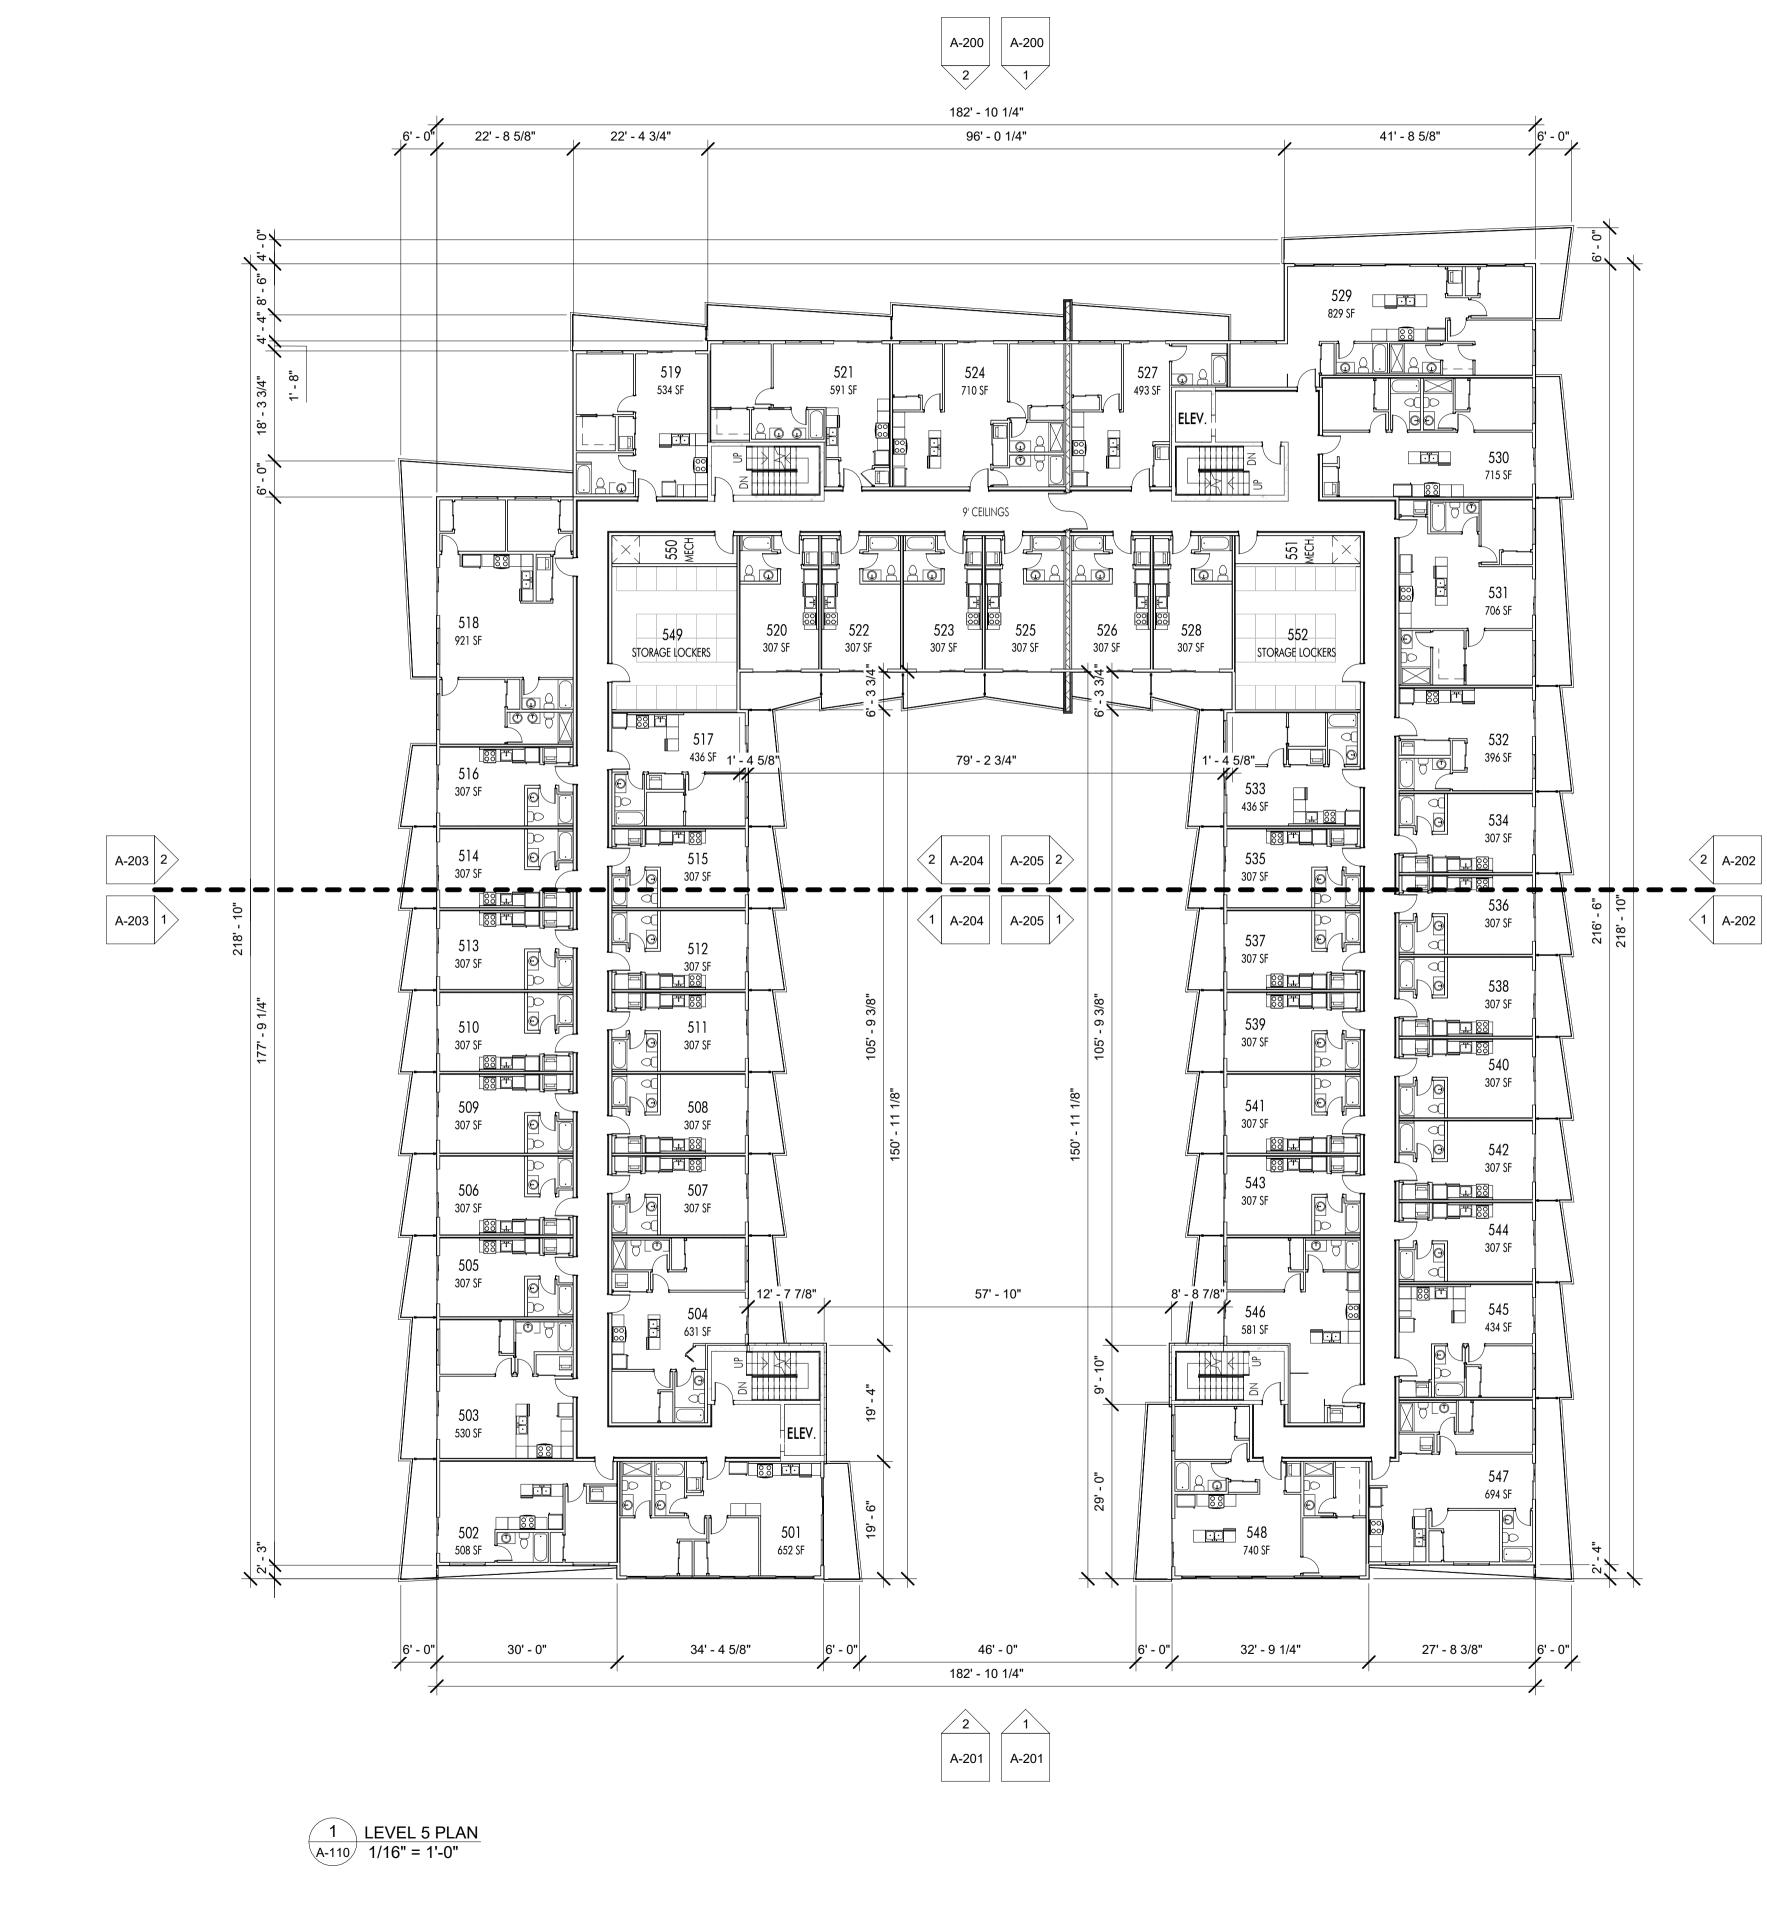



PHONE:250-448-7801

#### 205-1626 Richter Street, Kelowna, BC V1Y 2M3 www.limearchitecture.com


#### COPYRIGHT. ALL RIGHTS RESERVED

All ideas, designs, drawings and specifications are the exclusive property of LIME Architecture Inc. As instruments of service, they may not be used or reproduced in any manner without the expressed written consent of LIME Architecture Inc. All Contracting Trades shall check and verify all levels, dimensions, data and conditions on the site prior to commencement of any work. Any discrepancies are to be reported immediately to LIME Architecture Inc. Do not Scale any dimensions from this drawing. All trades are to execute the work in

accordance with the current municipality building by-laws and requirements of other local authorities having jurisdiction as well as the british columbia building code -(most recent edition) including all published revisions and addenda. All trades shall assume full responsiblity for the locations and protection of all under and above ground utilities, wires and conduit connections, including (but not limited to) water, sewer, gas, hydro and telephone.

#### **Revision No., Date** and Description

02.25.23 FOR DP 03.06.23 FOR DP 03.17.21 FOR DP

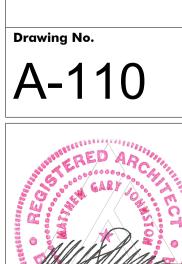

Plot Date


04.14.23


PROJECT

Revo (Collinson Rise)

LEVEL 5 PLAN

DRAWING TITLE

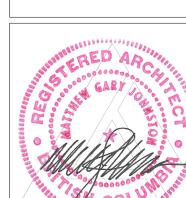

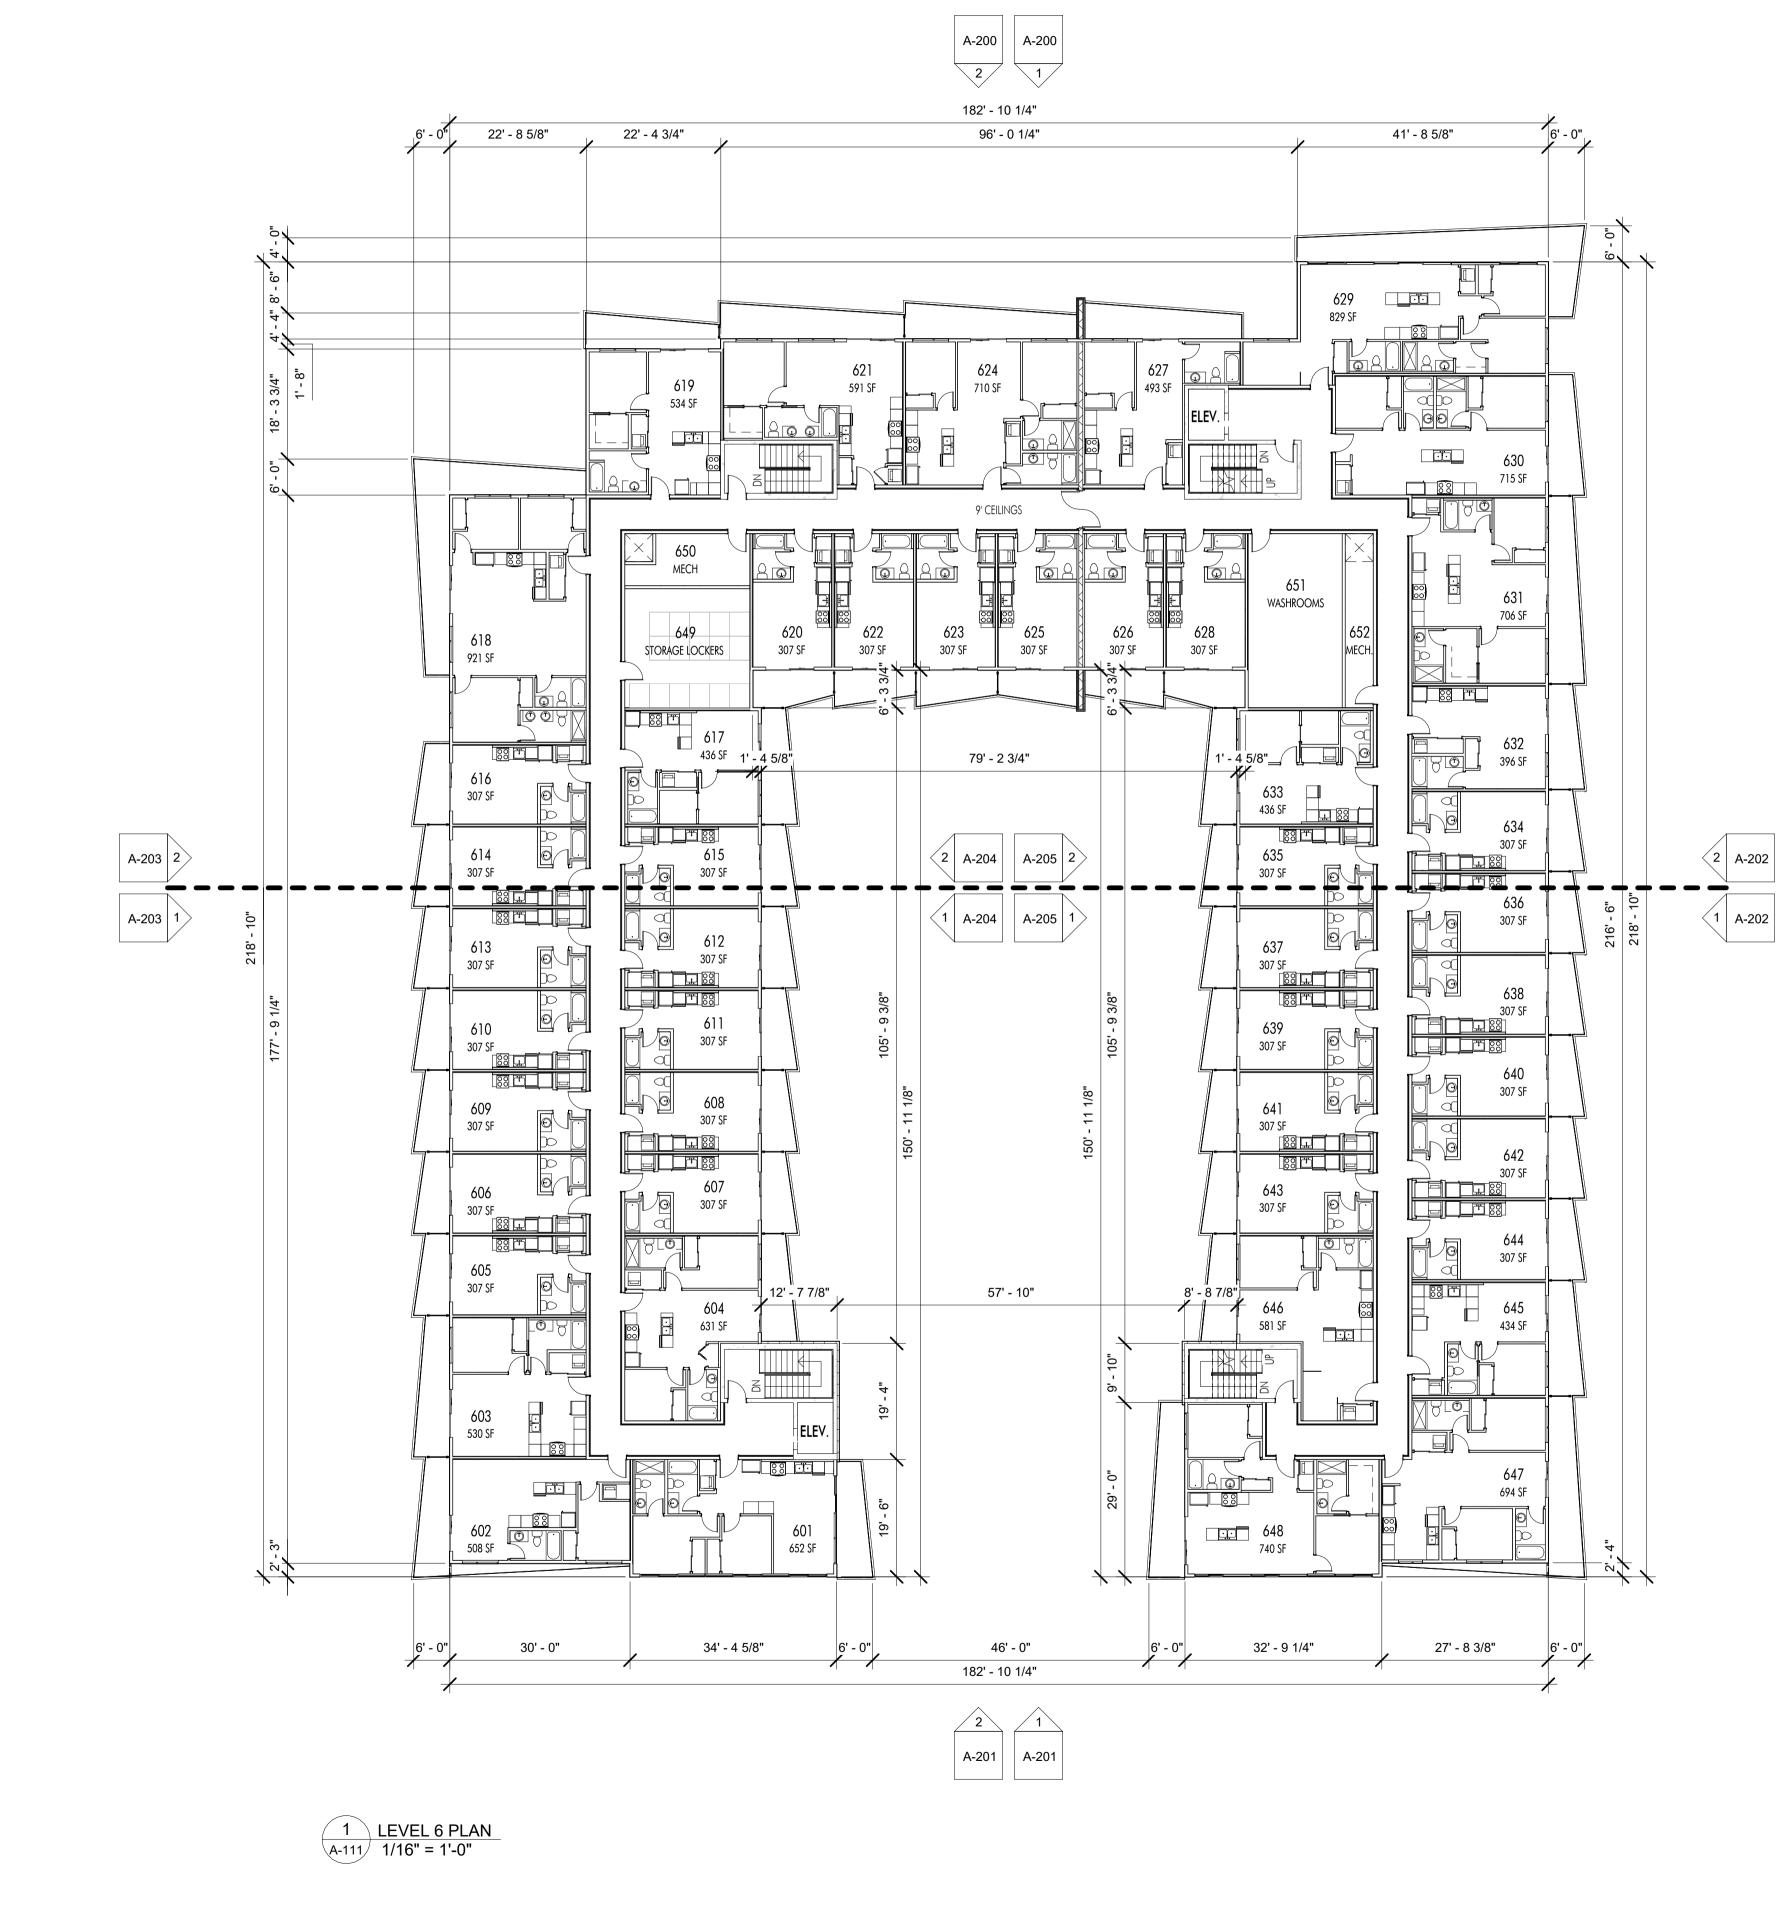



PHONE:250-448-7801

#### 205-1626 Richter Street, Kelowna, BC V1Y 2M3 www.limearchitecture.com


#### COPYRIGHT. ALL RIGHTS RESERVED

All ideas, designs, drawings and specifications are the exclusive property of LIME Architecture Inc. As instruments of service, they may not be used or reproduced in any manner without the expressed written consent of LIME Architecture Inc. All Contracting Trades shall check and verify all levels, dimensions, data and conditions on the site prior to commencement of any work. Any discrepancies are to be reported immediately to LIME Architecture Inc. Do not Scale any dimensions from this drawing. All trades are to execute the work in accordance with the current municipality

building by-laws and requirements of other local authorities having jurisdiction as well as the british columbia building code -(most recent edition) including all published revisions and addenda. All trades shall assume full responsiblity for the locations and protection of all under and above ground utilities, wires and conduit connections, including (but not limited to) water, sewer, gas, hydro and telephone.

#### **Revision No., Date** and Description

02.17.23 FOR COORDINATION 02.25.23 FOR DP 03.06.23 FOR DP 03.17.21 FOR DP

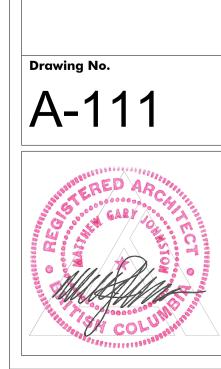

Plot Date


04.14.23

PROJECT

Revo (Collinson Rise)

LEVEL 6 PLAN

DRAWING TITLE

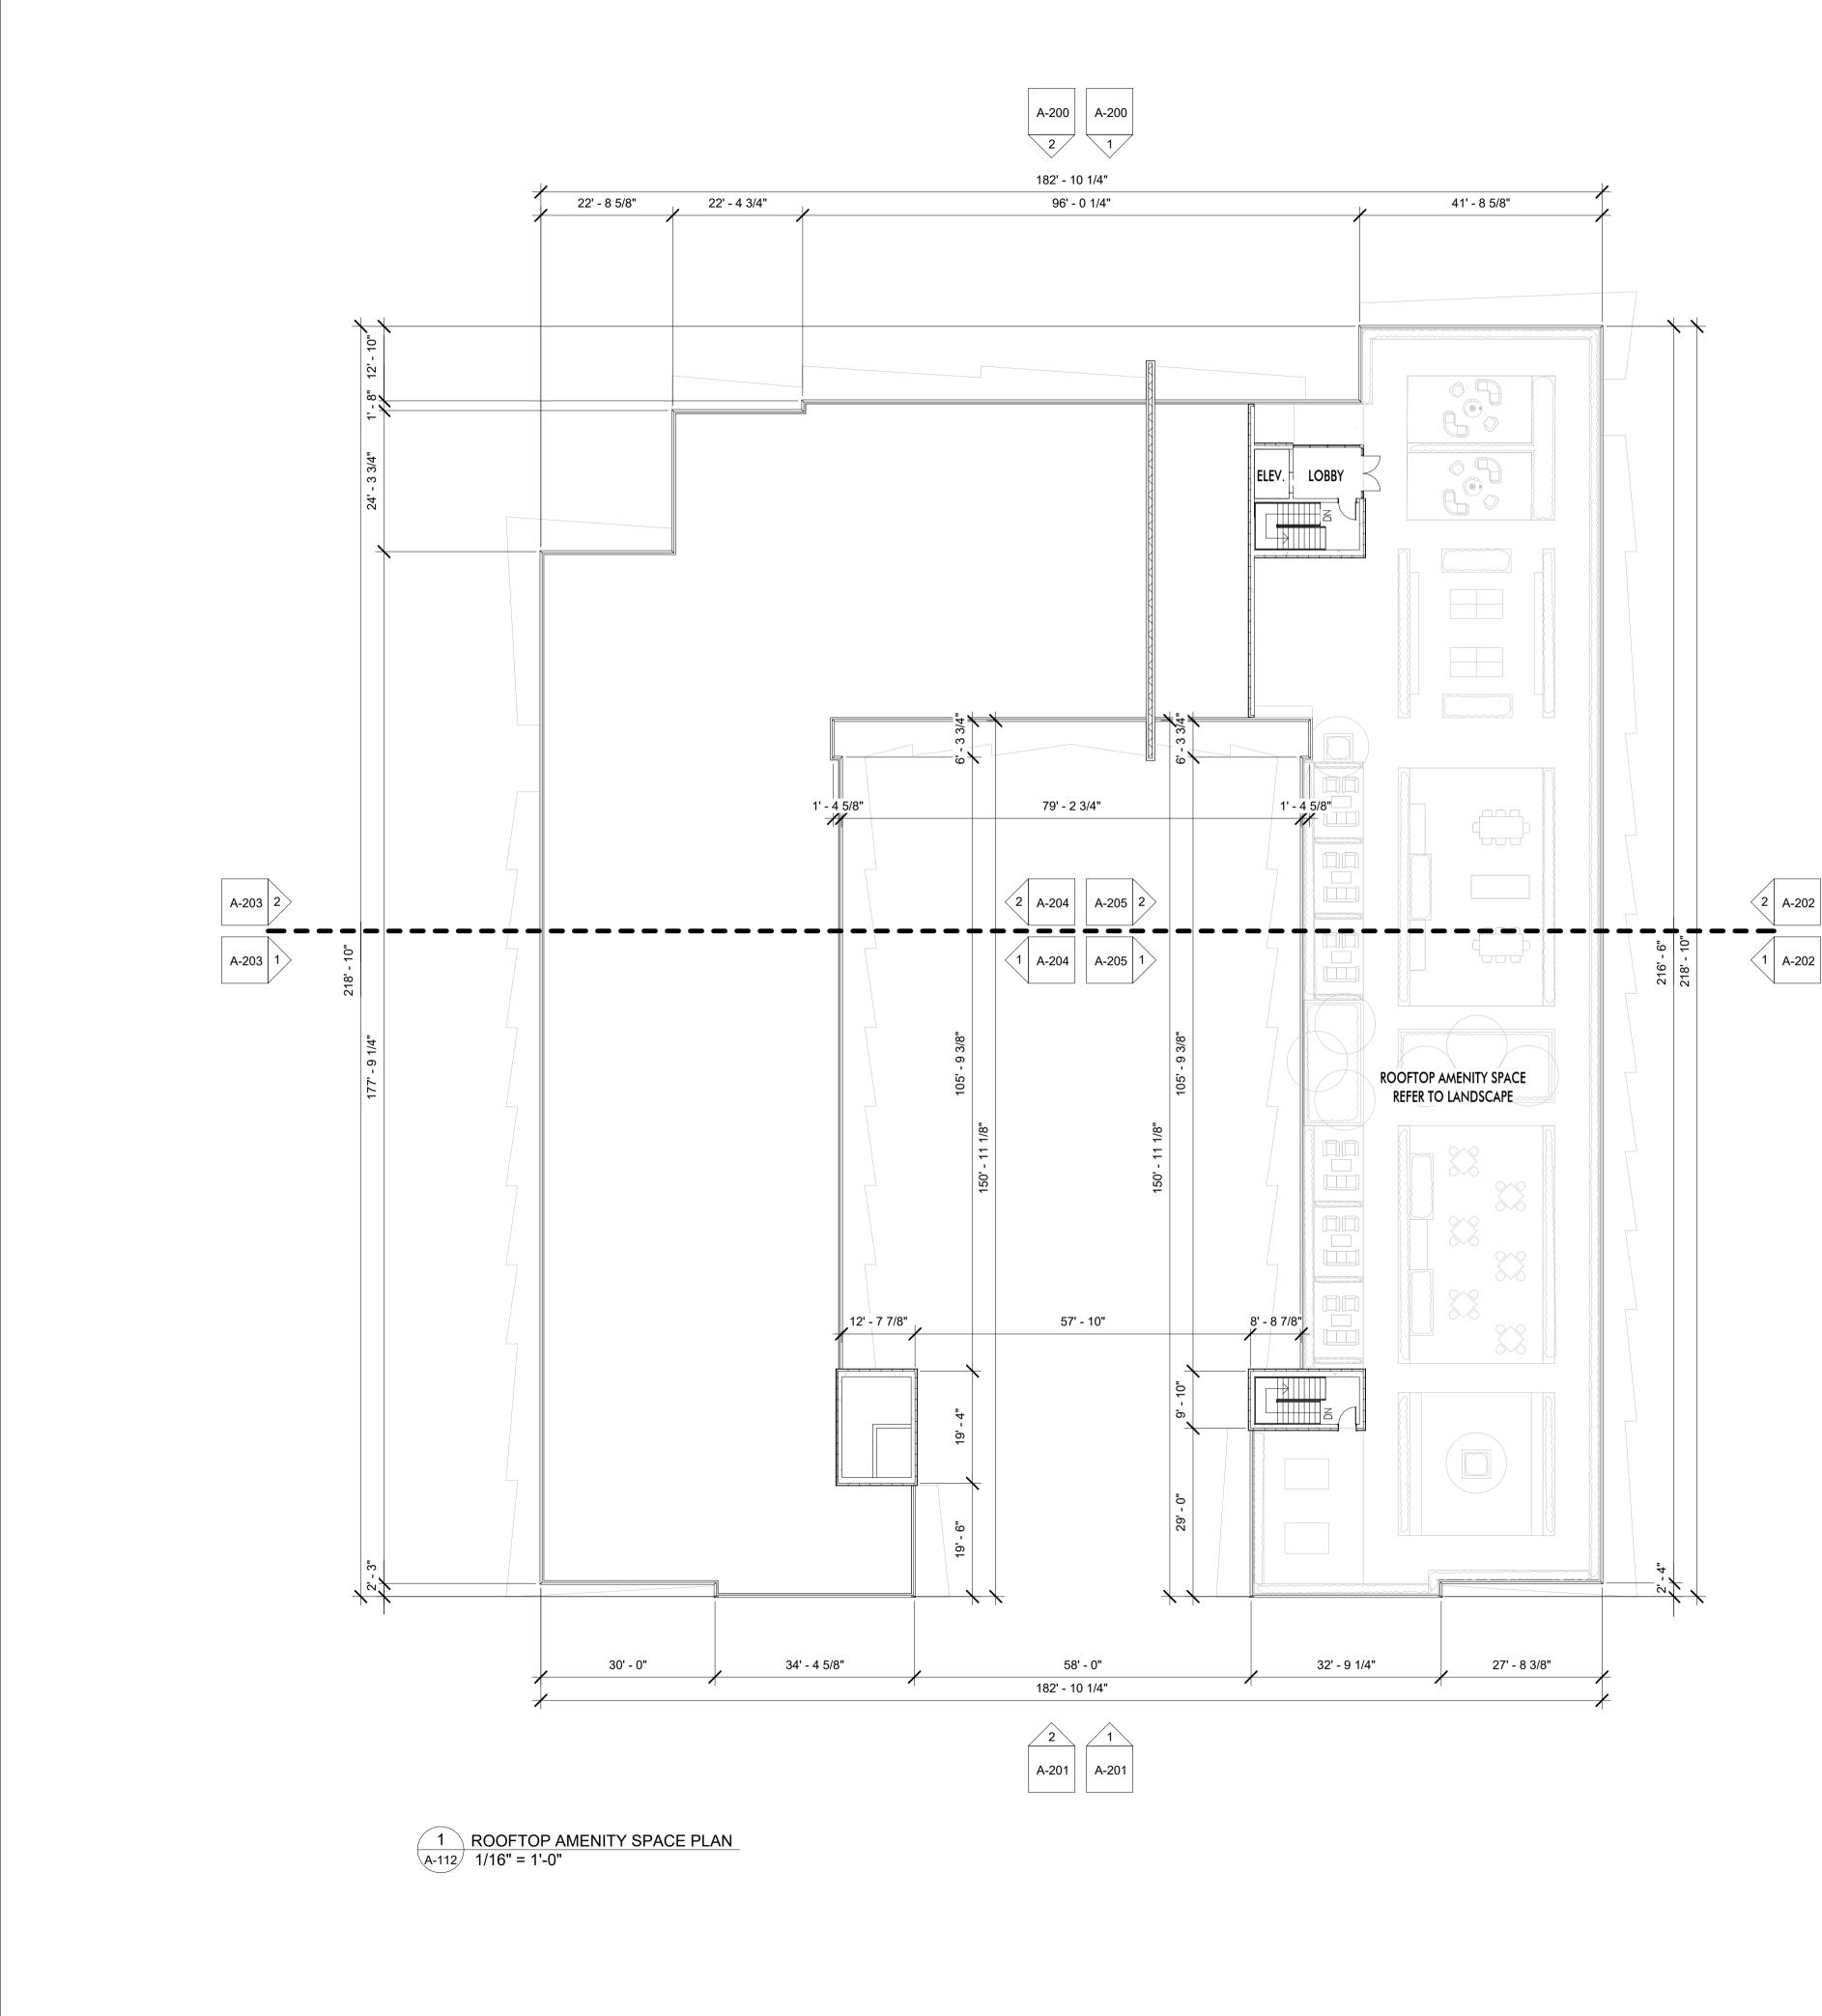



PHONE:250-448-7801

#### 205-1626 Richter Street, Kelowna, BC V1Y 2M3 www.limearchitecture.com

#### COPYRIGHT. ALL RIGHTS RESERVED

All ideas, designs, drawings and specifications are the exclusive property of LIME Architecture Inc. As instruments of service, they may not be used or reproduced in any manner without the expressed written consent of LIME Architecture Inc. All Contracting Trades shall check and verify all levels, dimensions, data and conditions on the site prior to commencement of any work. Any discrepancies are to be reported immediately to LIME Architecture Inc. Do not Scale any dimensions from this drawing. All trades are to execute the work in

accordance with the current municipality building by-laws and requirements of other local authorities having jurisdiction as well as the british columbia building code -(most recent edition) including all published revisions and addenda. All trades shall assume full responsiblity for the locations and protection of all under and above ground utilities, wires and conduit connections, including (but not limited to) water, sewer, gas, hydro and telephone.

#### **Revision No., Date** and Description

02.17.23 FOR COORDINATION 02.25.23 FOR DP 03.06.23 FOR DP 03.17.21 FOR DP

#### Plot Date

04.14.23

PROJECT

Revo (Collinson Rise)


DRAWING TITLE


ROOFTOP

AMENITY

Drawing No.


A-112

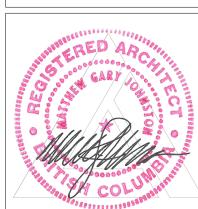

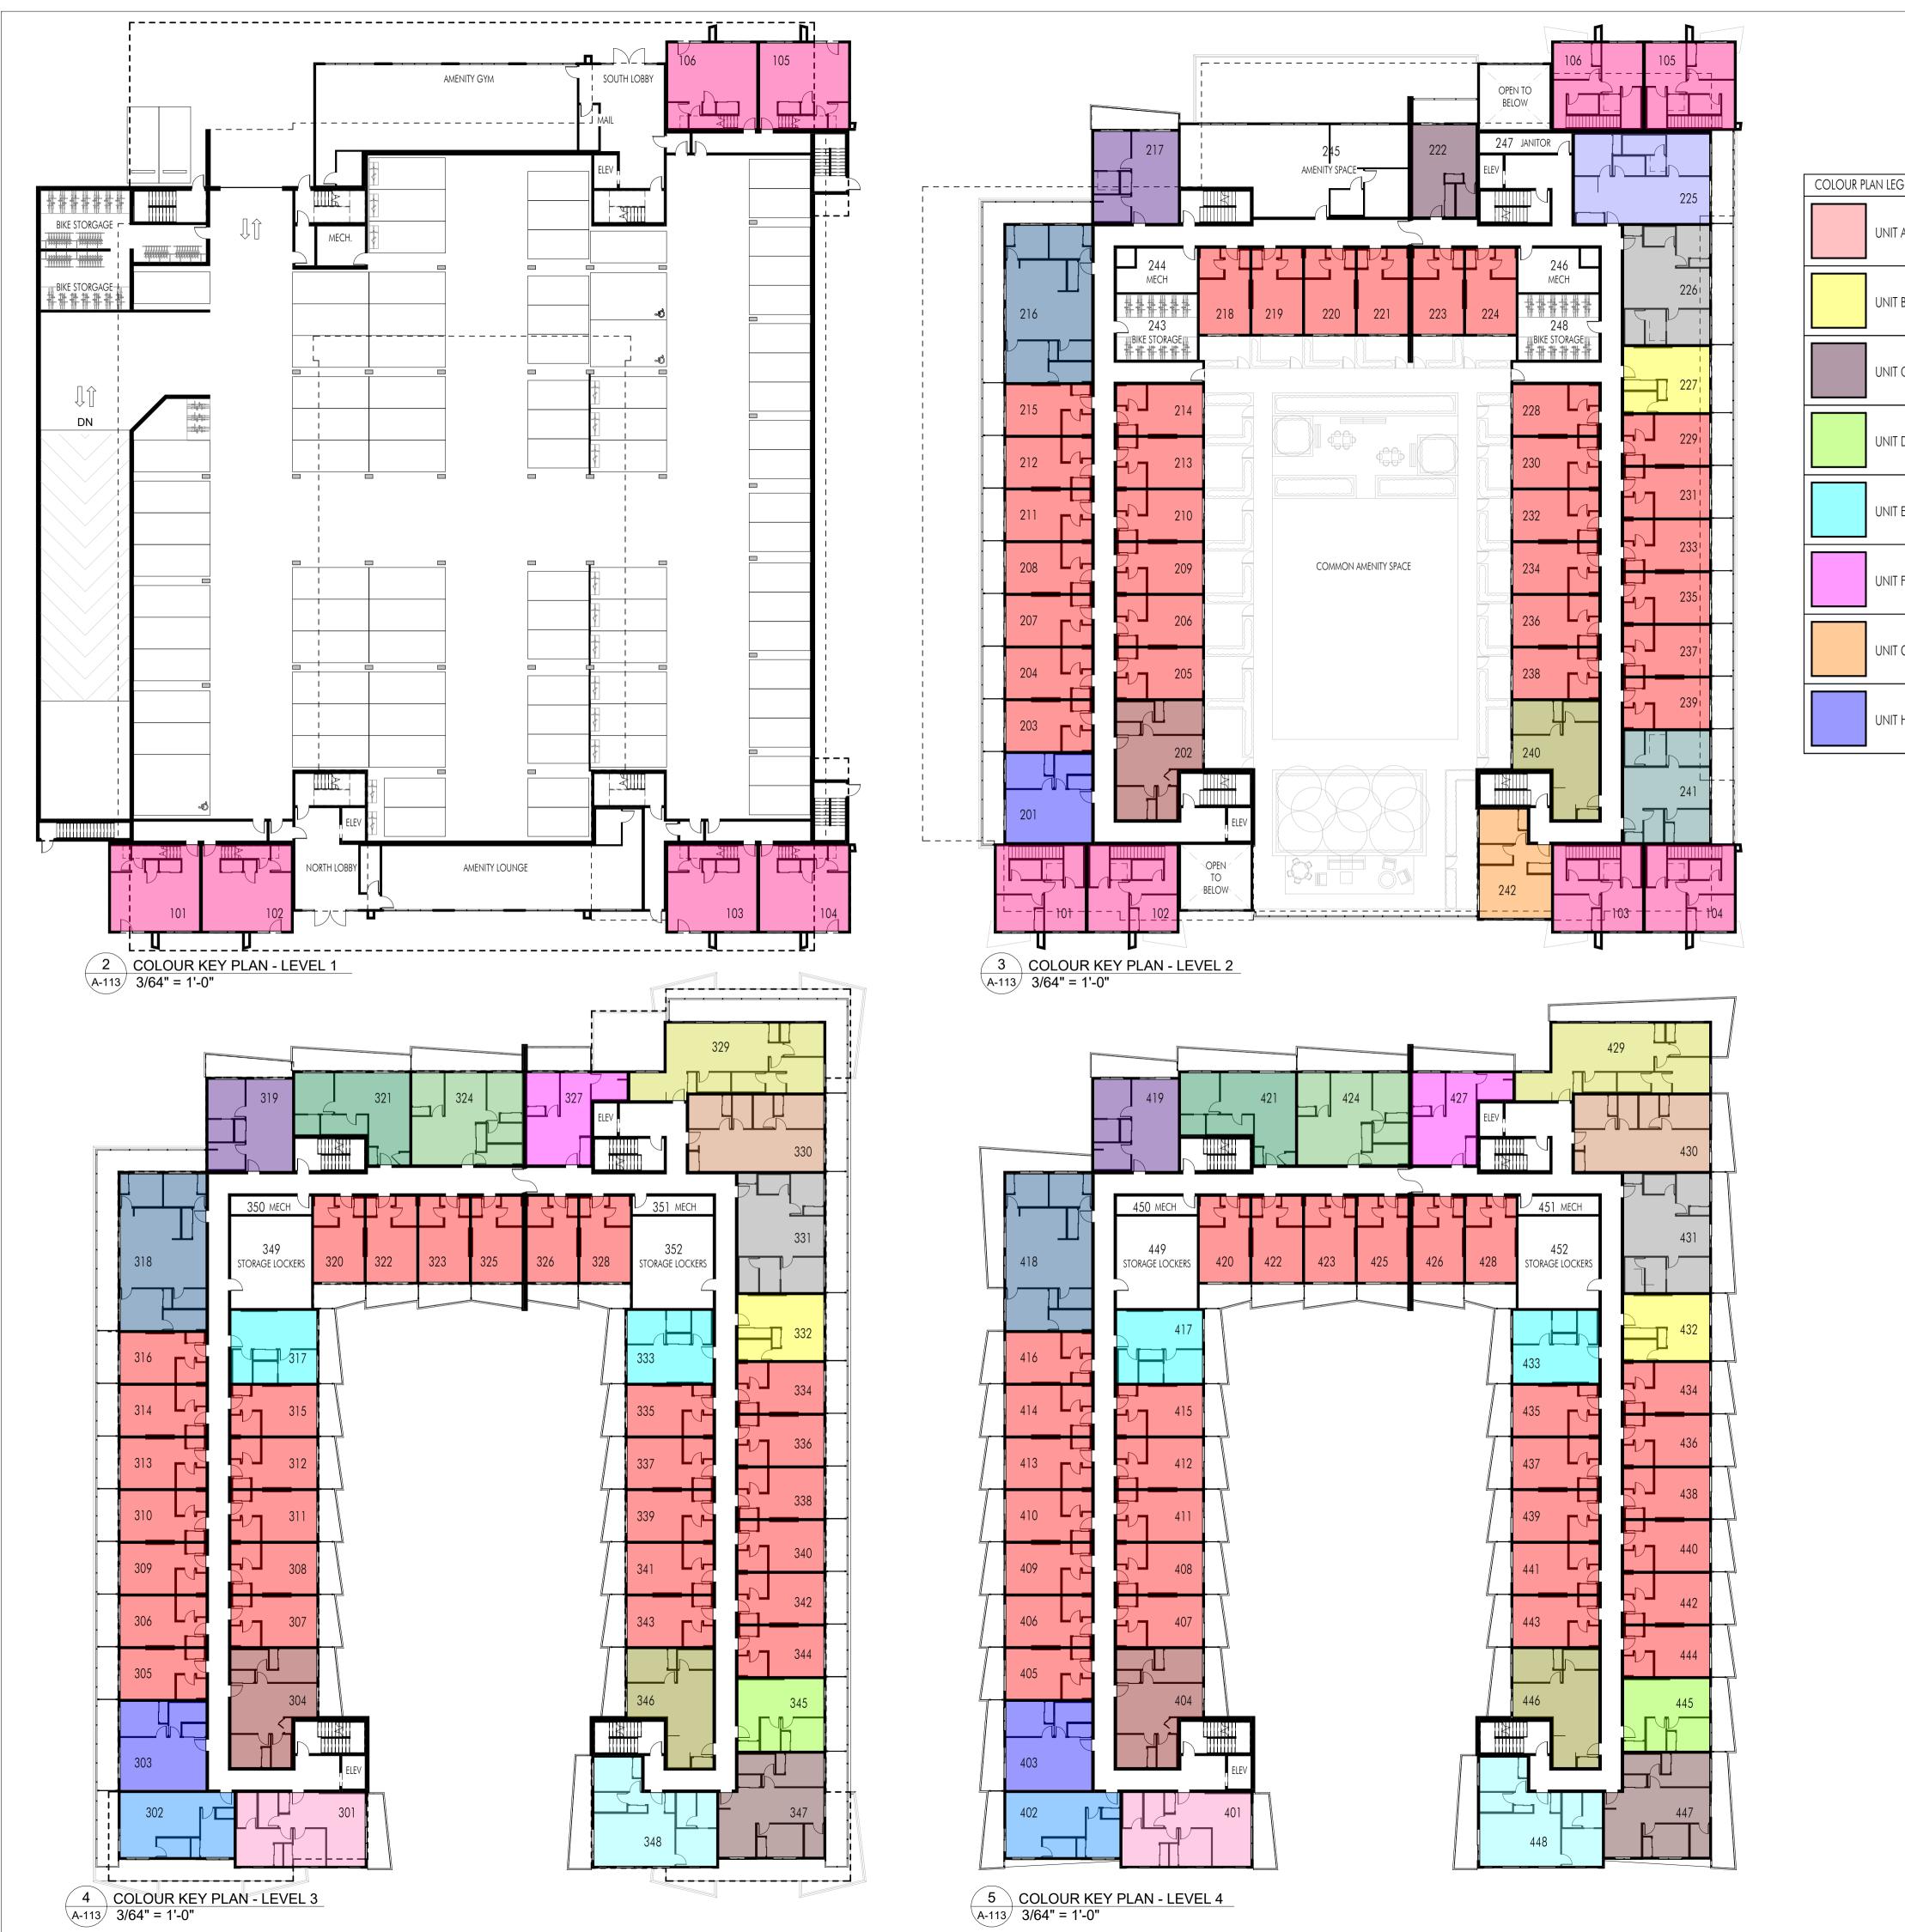



ADDENDUM NO.3
---------------


PLAN LEGEND		
UNIT A - MICRO SUITE	UNIT I - 1-BED (2)	UNIT Q - 2-BED (2)
unit b - studio	UNIT J - 1-BED (3)	UNIT R - 2-BED (3)
UNIT C - STUDIO (2)	UNIT K - 1-BED (4)	UNIT S - 2-BED (4)
UNIT D - JUNIOR 1-BED (1)	UNIT L - 1-BED + DEN	UNIT T - 2-BED (5)
UNIT E - JUNIOR 1-BED (2)	UNIT M - JUNIOR 2-BED (1)	UNIT U - 2-BED + DEN (1)
UNIT F - JUNIOR 1-BED (3)	UNIT N - JUNIOR 2-BED (2)	UNIT V - 2-BED + DEN (2)
UNIT G - JUNIOR 1-BED (4)	UNIT O - JUNIOR 2-BED (3)	UNIT W - 3-BED
UNIT H - 1-BED (1)	UNIT P - 2-BED (1)	UNIT X - TOWNHOMES

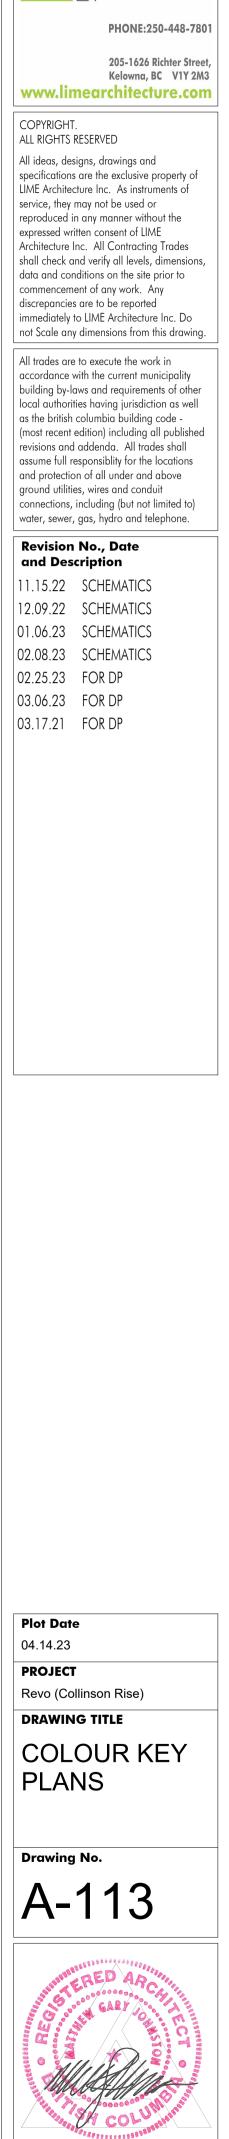


ARCHITECTURE INC.

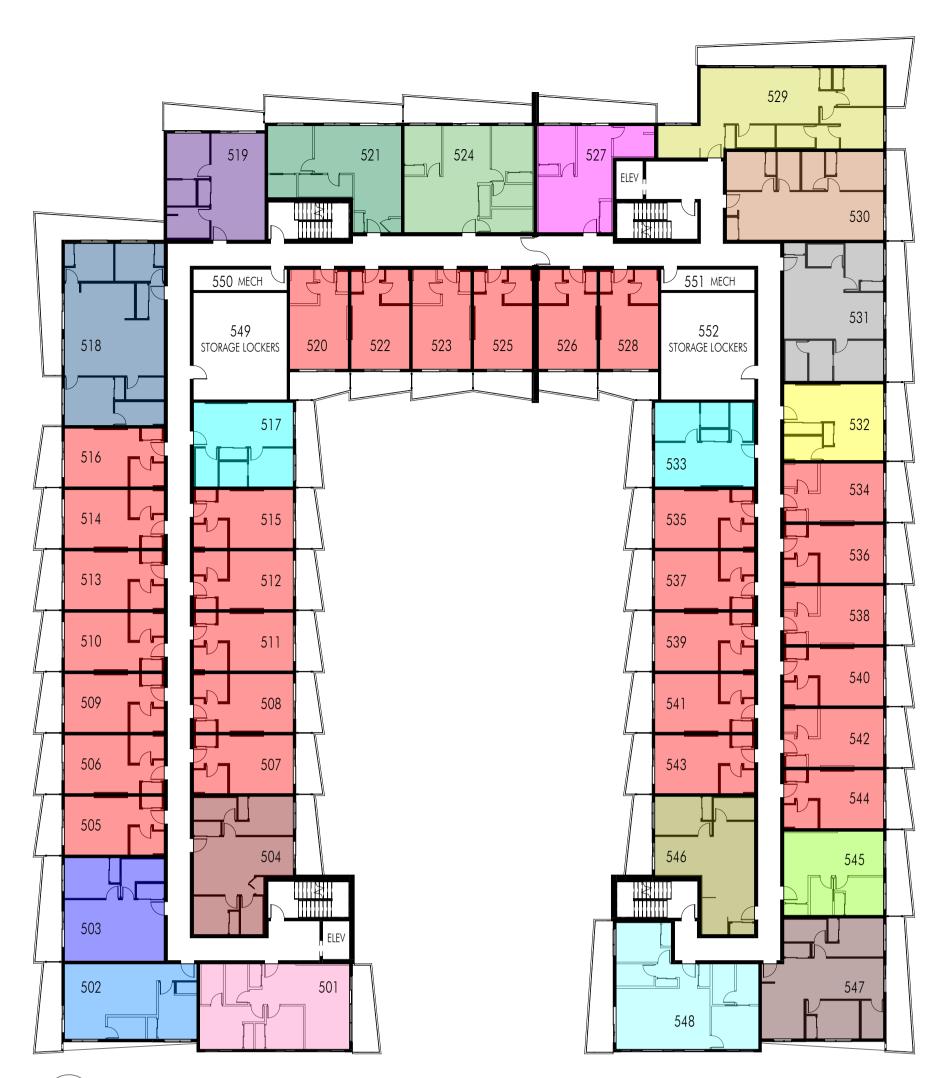

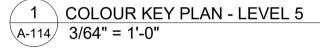


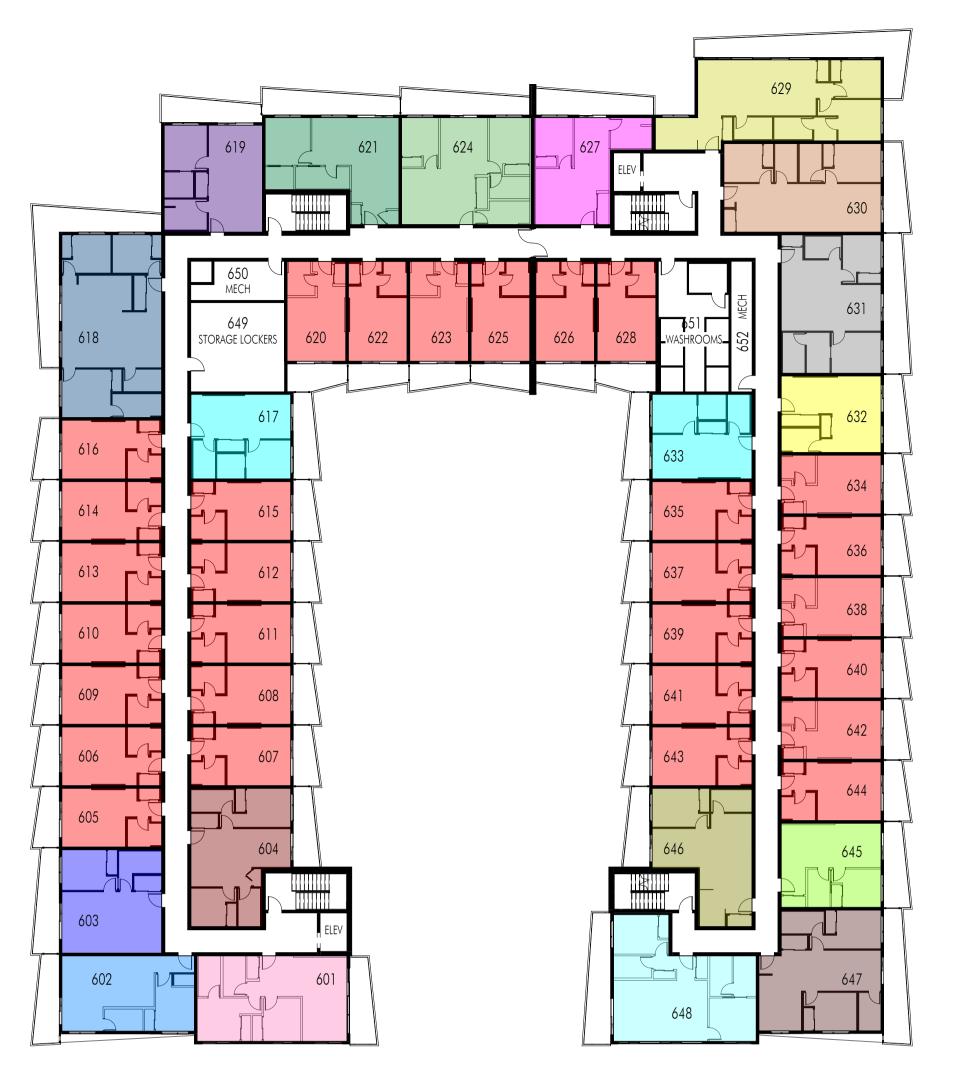


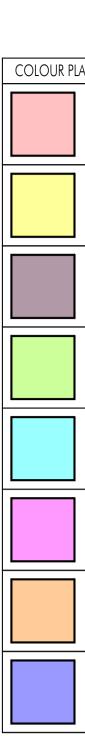


2 COLOUR KEY PLAN - LEVEL 6 A-114 3/64" = 1'-0"

LAN LEGEND		
UNIT A - MICRO SUITE	UNIT I - 1-BED (2)	UNIT Q - 2-BED (2)
unit b - studio	UNIT J - 1-BED (3)	UNIT R - 2-BED (3)
unit C - Studio (2)	UNIT K - 1-BED (4)	UNIT S - 2-BED (4)
UNIT D - JUNIOR 1-BED (1)	UNIT L - 1-BED + DEN	UNIT T - 2-BED (5)
UNIT E - JUNIOR 1-BED (2)	UNIT M - JUNIOR 2-BED (1)	UNIT U - 2-BED + DEN (1)
UNIT F - JUNIOR 1-BED (3)	UNIT N - JUNIOR 2-BED (2)	UNIT V - 2-BED + DEN (2)
UNIT G - JUNIOR 1-BED (4)	UNIT O - JUNIOR 2-BED (3)	UNIT W - 3-BED
UNIT H - 1-BED (1)	UNIT P - 2-BED (1)	UNIT X - TOWNHOMES

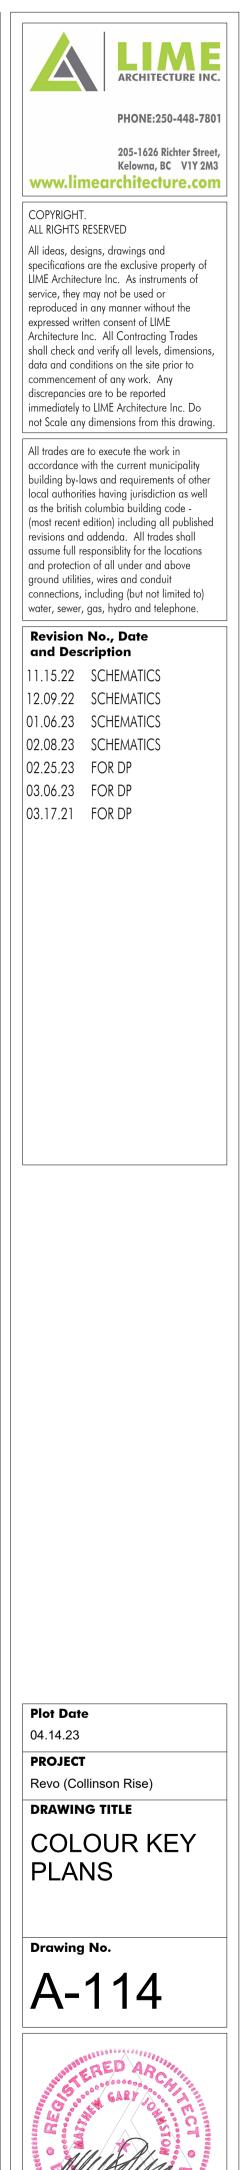

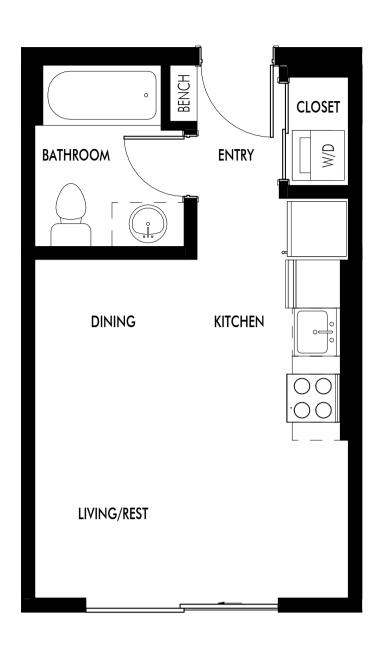


1 UNIT A - MICRO - 307 SF A-115 1/4" = 1'-0"

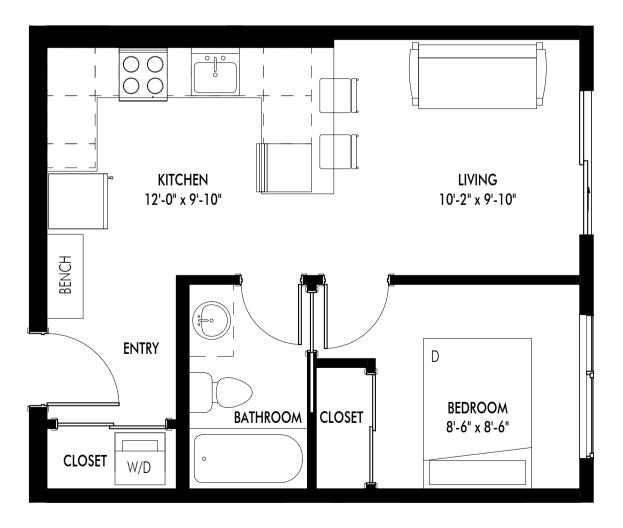

4 UNIT D - JUINIOR 1-BED (1) - 434 SF A-115 1/4" = 1'-0"



2 UNIT B - STUDIO (1) - 396 SF A-115 1/4" = 1'-0"

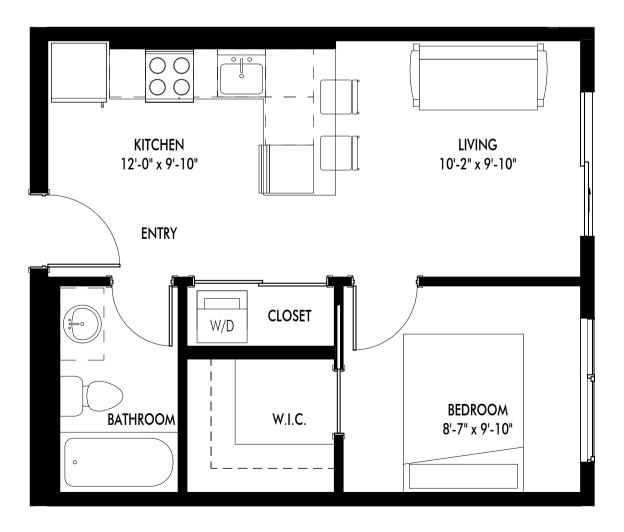


5 UNIT E - JUNIOR 1-BED (2) - 436 SF A-115 1/4" = 1'-0"

## ADDENDUM NO.3





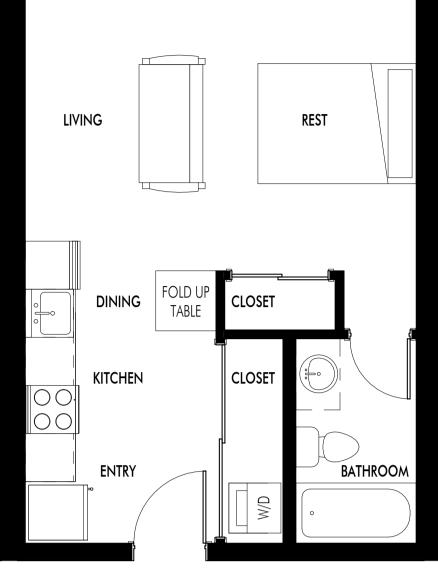


₽<u>\_\_\_\_</u>q,\_\_\_\_t


Kelowna, BC VIY2 M3 www.limearchitecture.com COPYRIGHT. All ideas, designs, drawings and specifications are the exclusive property of LIME Architecture Inc. As instruments of service, they may not be used or reproduced in any manner without the expressed witten consent of LIME Architecture Inc. All Contracting Trades shall check and verify all levels, dimensions, data and conditions on the site prior to commencement of any work. Any discrepancies are to be reported immediately to LIME Architecture Inc. Do not Scale any dimensions from this drawing. All trades are to execute the work in accordance with the current municipality building by-laws and requirements of other local authorities having jurisdiction as well as the british columbia building code - (most recent edition) including all published revisions and addenda. All trades shall assume full responsibility for the locations and protection of all under and above ground utilities, wires and conduit connections, including (but not limited to) water, sewer, gas, hydro and telephone. <b>Revision No., Date and Description</b> 11.15.22 SCHEMATICS 12.09.22 SCHEMATICS 12.09.23 SCHEMATICS 02.08.23 SCHEMATICS 02.08.23 FOR DP 03.06.23 FOR DP 03.06.23 FOR DP 03.06.23 FOR DP 03.17.21 FOR DP	Kelowna, BC V1Y 2M3 www.limearchitecture.com	Kelowna, BC V1Y 2M3 www.limearchitecture.com		205-1626 Richter Street
ALL RIGHTS RESERVED All ideas, designs, drawings and specifications are the exclusive property of LIME Architecture Inc. As instruments of service, they may not be used or reproduced in any manner without the expressed written consent of LIME Architecture Inc. All Contracting Trades shall check and verify all levels, dimensions, data and conditions on the site prior to commencement of any work. Any discrepancies are to be reported immediately to LIME Architecture Inc. Do not Scale any dimensions from this drawing. All trades are to execute the work in accordance with the current municipality building by-laws and requirements of other local authorities having jurisdiction as well as the british columbia building code - (most recent edition) including all published revisions and addenda. All trades shall assume full responsiblity for the locations and protection of all under and above ground utilities, wires and conduit connections, including (but not limited to) water, sewer, gas, hydro and telephone. <b>Revision No., Date</b> and Description 11.15.22 SCHEMATICS 12.09.22 SCHEMATICS 12.09.23 SCHEMATICS 02.08.23 SCHEMATICS 02.08.23 SCHEMATICS 02.25.23 FOR DP 03.06.23 FOR DP	ALL RIGHTS RESERVED All ideas, designs, drawings and specifications are the exclusive property of LIME Architecture Inc. As instruments of service, they may not be used or reproduced in any manner without the expressed written consent of LIME Architecture Inc. All Contracting Trades shall check and verify all levels, dimensions, data and conditions on the site prior to commencement of any work. Any discrepancies are to be reported immediately to LIME Architecture Inc. Do not Scale any dimensions from this drawing. All trades are to execute the work in accordance with the current municipality building by-laws and requirements of other local authorities having jurisdiction as well as the british columbia building code - (most recent edition) including all published revisions and addenda. All trades shall assume full responsibility for the locations and protection of all under and above ground utilities, wires and conduit connections, including (but not limited to) water, sewer, gas, hydro and telephone. <b>Revision No., Date</b> and Description 11.15.22 SCHEMATICS 12.09.22 SCHEMATICS 12.09.23 SCHEMATICS 01.06.23 SCHEMATICS 02.08.23 SCHEMATICS 02.25.23 FOR DP 03.06.23 FOR DP	ALL RIGHTS RESERVED All ideas, designs, drawings and specifications are the exclusive property of LIME Architecture Inc. As introments of service, they may not be used or reproduced in any manner without the expressed withen consent of LIME Architecture Inc. All Contracting Trades shall check and verify all levels, dimensions, data and conditions on the sile prior to commencement of any work. Any discrepancies are to be reported immediately to LIME Architecture Inc. Do not Scale any dimensions from this drawing. All trades are to execute the work in accordance with the current municipality building bylaws and requirements of other local authorities having jurisdiction as well as the british columbia building code - work er, seet difficient of all under and above ground utilities, wires and conduit connections, including (but not limited to) water, sever, gas, hydro and telephone. <b>Revision No., Date</b> <b>Int Job 21</b> SCHEMATICS 12.09.22 SCHEMATICS 12.09.23 SCHEMATICS 12.09.23 SCHEMATICS 12.09.23 FOR DP 03.06.23 FOR DP 03.17.21 FOR DP 03.17.21 FOR DP 13.17.21 FOR DP <b>DRAWING TITLE</b> <b>TYPICAL UNIT</b> <b>LAYPICAL UNIT</b> <b>LAYOUTS</b>	www.lim	Kelowna, BC V1Y 2M3
water, sewer, gas, hydro and telephone.Revision No., Date and Description11.15.22SCHEMATICS12.09.22SCHEMATICS01.06.23SCHEMATICS02.08.23SCHEMATICS02.25.23FOR DP03.06.23FOR DP	water, sewer, gas, hydro and telephone.Revision No., Date and Description11.15.22SCHEMATICS12.09.22SCHEMATICS01.06.23SCHEMATICS02.08.23SCHEMATICS02.25.23FOR DP03.06.23FOR DP	Plot Date         03.06.23       FOR DP         03.17.21       FOR DP         PROJECT       Revo         Revo       Reve         PROJECT       Revo         Revo       Revo         01.06.23       SCHEMATICS         02.08.23       SCHEMATICS         02.25.23       FOR DP         03.06.23       FOR DP         03.17.21       FOR DP         SCHEMATICS       Revo (Collinson Rise)         DRAWING TITLE       TYPICAL UNIT         LAYOUTS       SCHEMATICS	ALL RIGHTS R All ideas, desi specifications LIME Architect service, they m reproduced in expressed writ Architecture In shall check an data and cond commenceme discrepancies immediately to not Scale any All trades are accordance w building by-lar local authoritii as the british c (most recent e revisions and assume full re- and protection ground utilities	gns, drawings and are the exclusive property of ure Inc. As instruments of nay not be used or any manner without the ten consent of LIME ten. All Contracting Trades and verify all levels, dimensions, ditions on the site prior to nt of any work. Any are to be reported be LIME Architecture Inc. Do dimensions from this drawing.
and Description11.15.22SCHEMATICS12.09.22SCHEMATICS01.06.23SCHEMATICS02.08.23SCHEMATICS02.25.23FOR DP03.06.23FOR DP	and Description11.15.22SCHEMATICS12.09.22SCHEMATICS01.06.23SCHEMATICS02.08.23SCHEMATICS02.25.23FOR DP03.06.23FOR DP	and Description         11.15.22       SCHEMATICS         12.09.22       SCHEMATICS         02.08.23       SCHEMATICS         02.25.23       FOR DP         03.06.23       FOR DP         03.17.21       FOR DP         97.01       FOR DP         04.14.23       FOR JP         PROJECT       Revo (Collinson Rise)         DAWING TITLE       TYPICALI UNIT         LAYOUTS       SCHEMINIT		
		04.14.23 <b>PROJECT</b> Revo (Collinson Rise) <b>DRAWING TITLE</b> <b>TYPICAL UNIT</b> <b>LAYOUTS</b>	11.15.22 12.09.22 01.06.23 02.08.23 02.25.23 03.06.23	SCHEMATICS SCHEMATICS SCHEMATICS SCHEMATICS FOR DP FOR DP
		04.14.23 <b>PROJECT</b> Revo (Collinson Rise) <b>DRAWING TITLE</b> <b>TYPICAL UNIT</b> <b>LAYOUTS</b>		
		04.14.23 <b>PROJECT</b> Revo (Collinson Rise) <b>DRAWING TITLE</b> <b>TYPICAL UNIT</b> <b>LAYOUTS</b>		
04.14.23 PROJECT Revo (Collinson Rise) DRAWING TITLE TYPICAL UNIT			04.14.23 <b>PROJECT</b> Revo (Coll <b>DRAWING</b> <b>TYPI</b>	linson Rise) G TITLE CAL UNIT


LIME ARCHITECTURE INC.

A

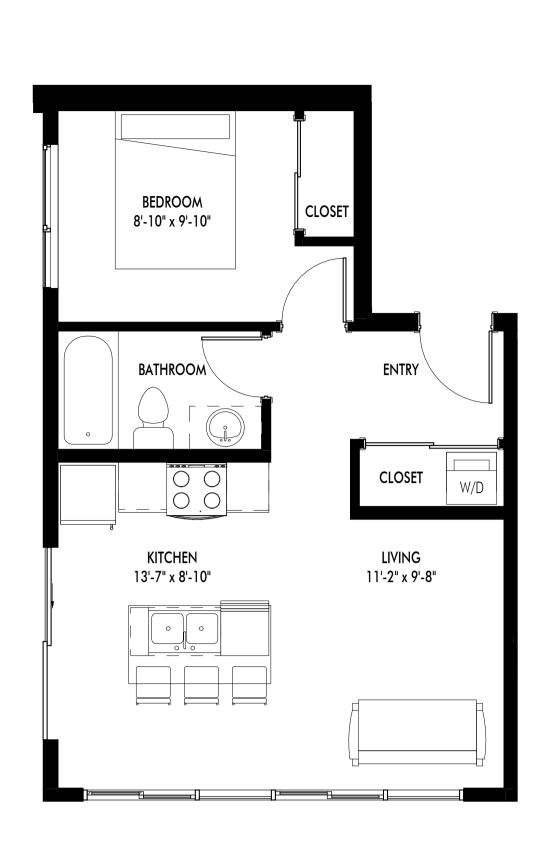


1 UNIT G - JUNIOR 1-BED (4) - 486 SF A-116 1/4" = 1'-0"

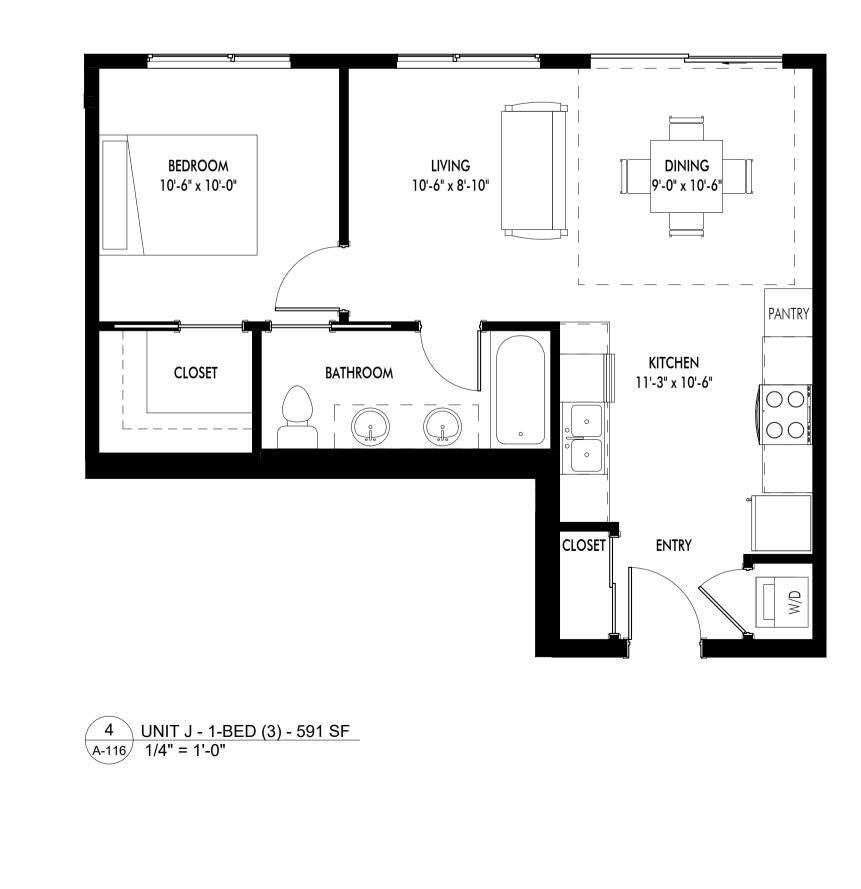


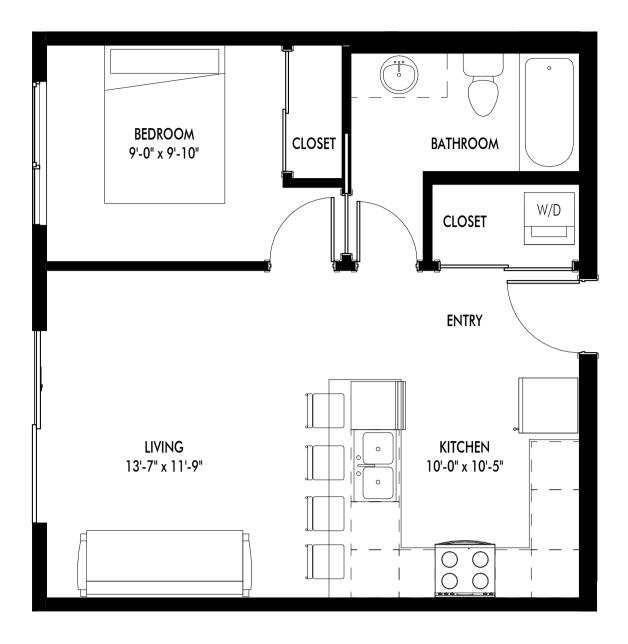



2 UNIT H - 1-BED (1) - 530 SF A-116 1/4" = 1'-0"

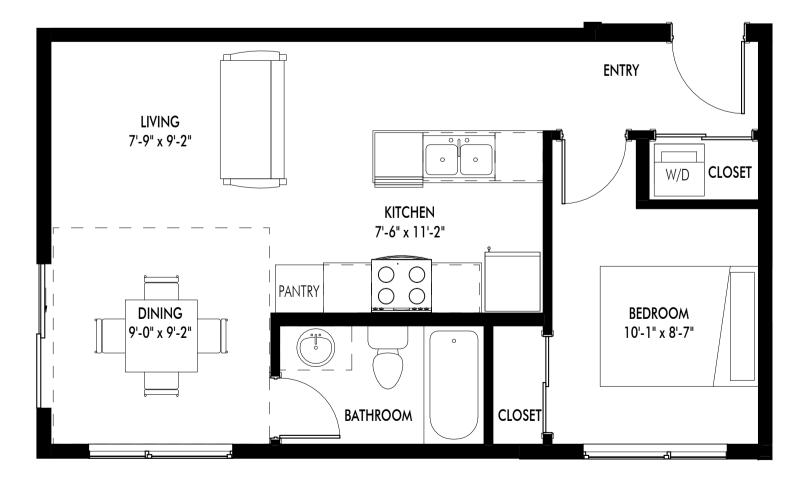

5 UNIT K - 1-BED (4)- 508 SF A-116 1/4" = 1'-0"

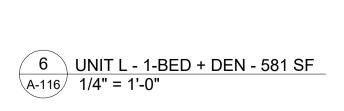


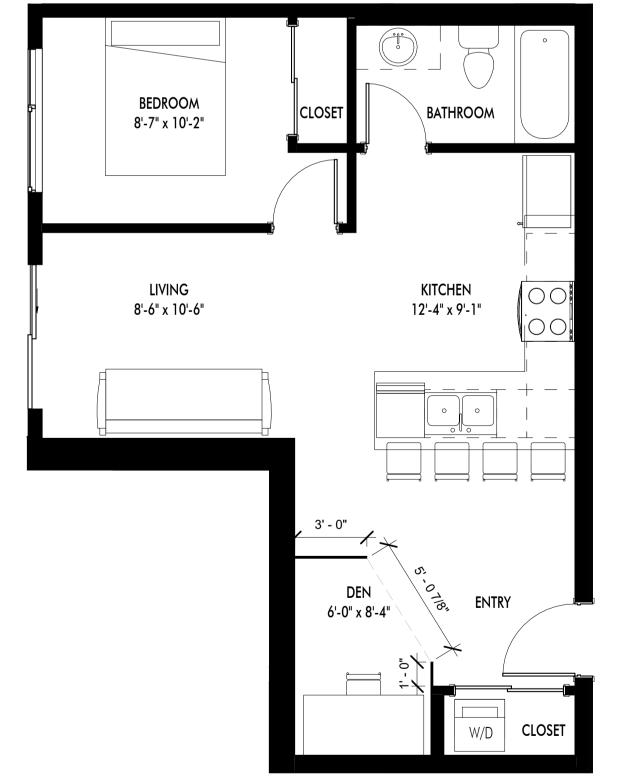

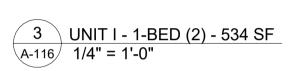





	<b>LIME</b> ARCHITECTURE INC.
www.limec	PHONE:250-448-7801 205-1626 Richter Street, Kelowna, BC V1Y 2M3 rchitecture.com
COPYRIGHT. ALL RIGHTS RESER All ideas, designs, specifications are t LIME Architecture I service, they may r reproduced in any expressed written of Architecture Inc. A shall check and ve data and condition commencement of discrepancies are t immediately to LIM not Scale any dime All trades are to ex accordance with th building by-laws an	VED drawings and he exclusive property of nc. As instruments of ot be used or manner without the onsent of LIME II Contracting Trades rify all levels, dimensions, as on the site prior to any work. Any o be reported IE Architecture Inc. Do ensions from this drawing. ecute the work in the current municipality and requirements of other
as the british colun (most recent editio revisions and adde assume full respon and protection of a ground utilities, win connections, includ water, sewer, gas, <b>Revision No</b> and Descrip	ding (but not limited to) hydro and telephone. -, Date tion
11.15.22         SCI           12.09.22         SCI           01.06.23         SCI           02.08.23         SCI           02.25.23         FO           03.06.23         FO           03.17.21         FO           03.29.23         FO	HEMATICS HEMATICS HEMATICS R DP R DP R DP
03.30.23 AD 04.14.23 AD	DENDUM NO.1 DENDUM NO.2
Plot Date 04.14.23 PROJECT Revo (Collinse DRAWING T TYPIC, LAYOU	AL UNIT JTS
A-1	16

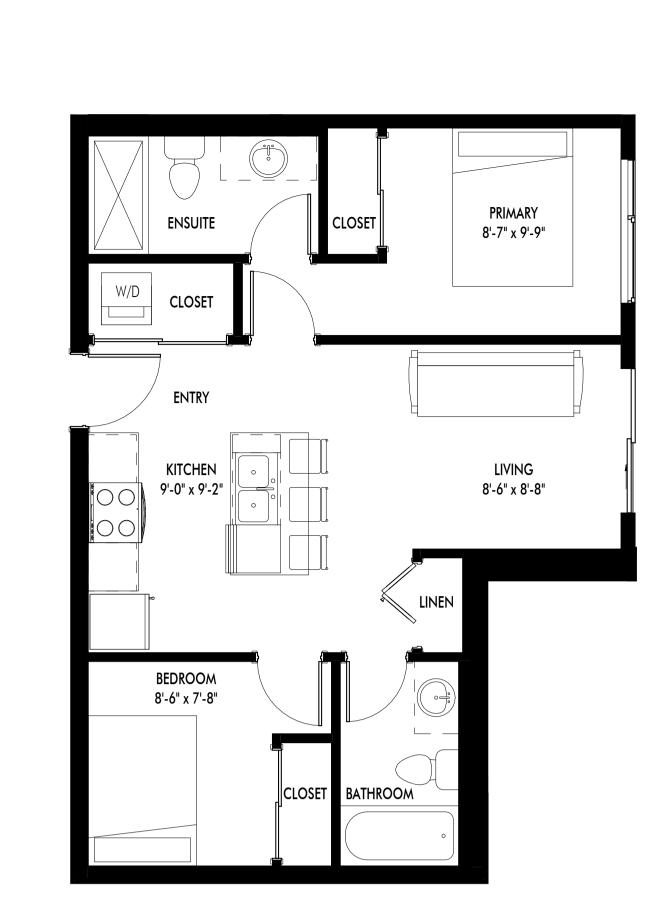


1 UNIT M - JUNIOR 2-BED (1) - 631 SF A-117 1/4" = 1'-0"

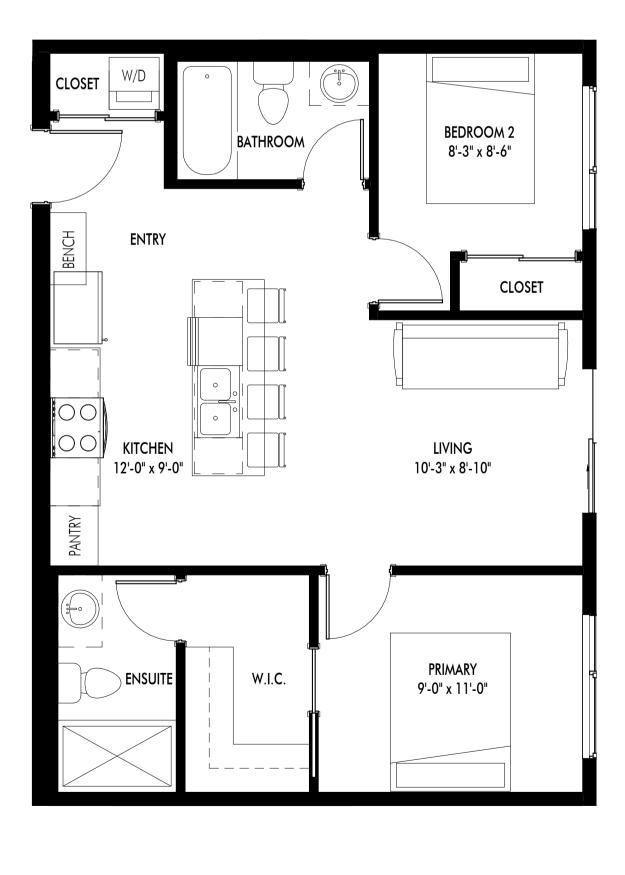



4 UNIT P - 2-BED (1) - 706 SF A-117 1/4" = 1'-0"

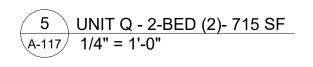


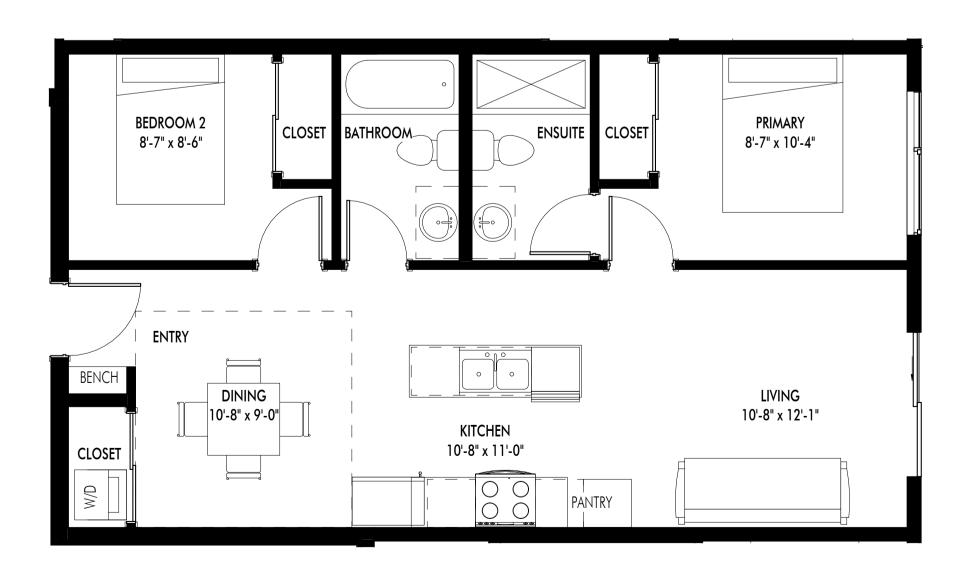


2 UNIT N - JUNIOR 2-BED (2) - 652 SF A-117 1/4" = 1'-0"

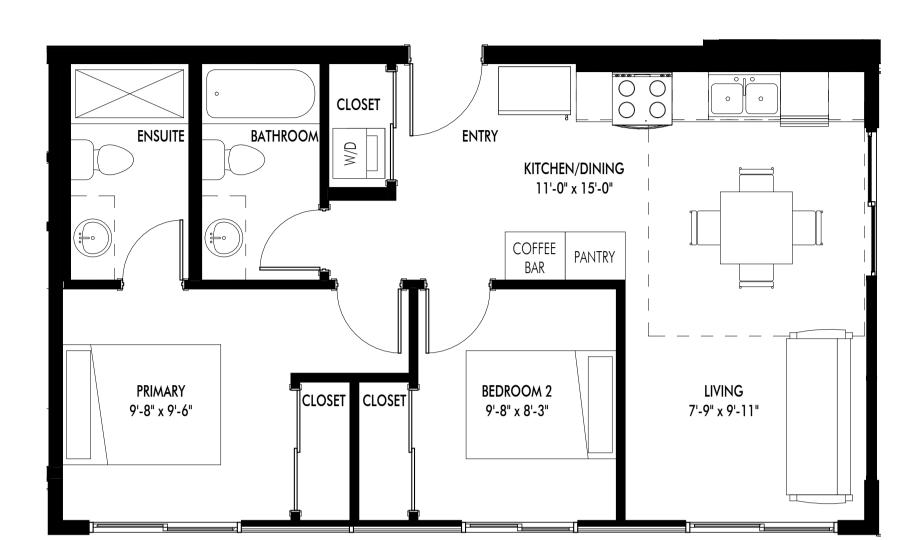

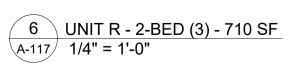

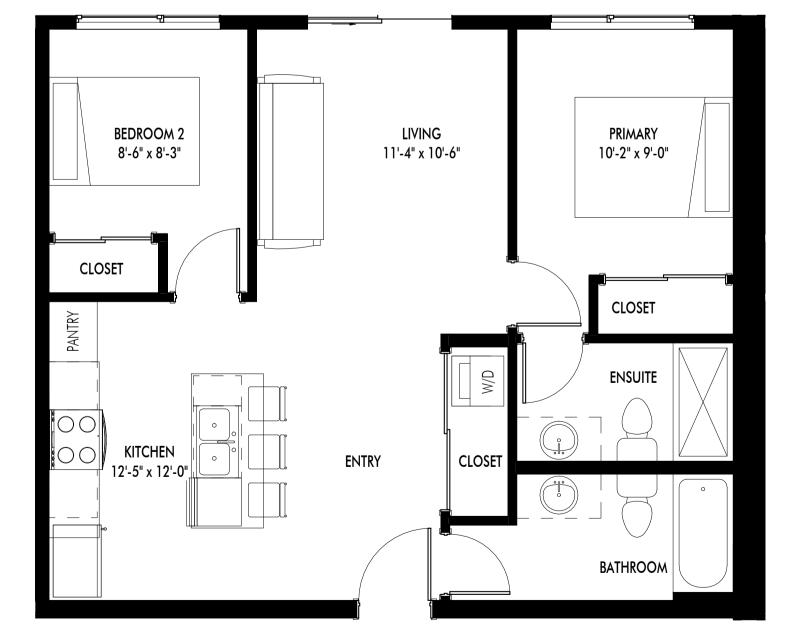




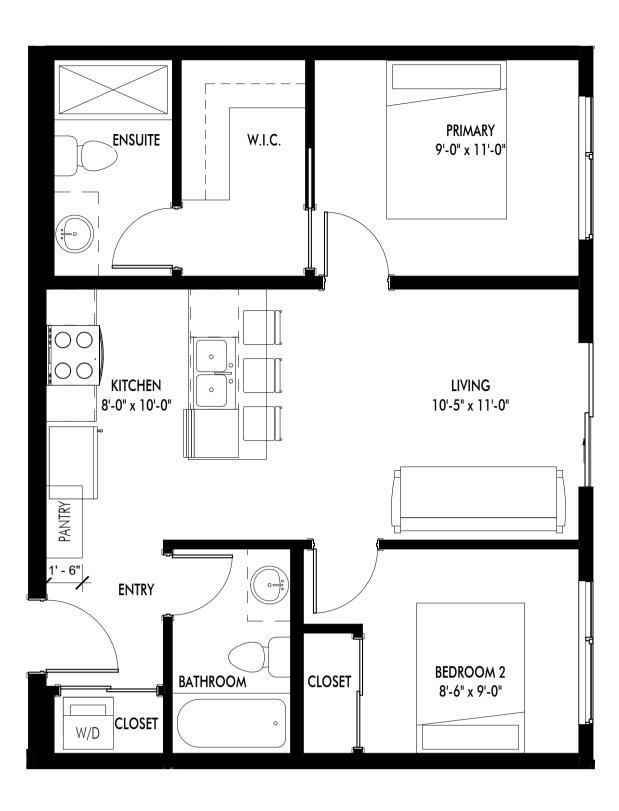

	PHONE:250-448-780
	205-1626 Richter Street Kelowna, BC V1Y 2M3
COPYRIGHT. ALL RIGHTS RESE	architecture.com
All ideas, designs specifications are	
expressed written	y manner without the consent of LIME
shall check and v	All Contracting Trades erify all levels, dimensions, ons on the site prior to of any work. Any
	to be reported ME Architecture Inc. Do nensions from this drawing.
accordance with t building by-laws a	execute the work in the current municipality and requirements of other
as the british colu (most recent edition	naving jurisdiction as well mbia building code - on) including all published lenda. All trades shall
and protection of ground utilities, w	
vater, sewer, gas Revision No	-
and Descrip 11.15.22 SC	CHEMATICS
12.09.22 SC 01.06.23 SC 02.08.23 SC	CHEMATICS
02.25.23 FC 03.06.23 FC	OR DP
03.17.21 FC	
<b>Plot Date</b> 04.14.23	
04.14.23 <b>PROJECT</b> Revo (Collins	•
04.14.23 PROJECT Revo (Collins DRAWING 1	•
04.14.23 PROJECT Revo (Collins DRAWING 1	AL UNIT
04.14.23 <b>PROJECT</b> Revo (Colling <b>DRAWING</b> <b>TYPIC</b>	AL UNIT UTS
04.14.23 PROJECT Revo (Collins DRAWING TYPIC LAYO	AL UNIT UTS
04.14.23 PROJECT Revo (Collins DRAWING TYPIC LAYO Drawing No	nitle AL UNIT UTS <b>17</b>
04.14.23 PROJECT Revo (Collins DRAWING TYPIC LAYO	AL UNIT UTS
04.14.23 PROJECT Revo (Collins DRAWING TYPIC LAYO	nitle AL UNIT UTS <b>17</b>




1 UNIT S - 2-BED (4) - 740 SF A-118 1/4" = 1'-0"

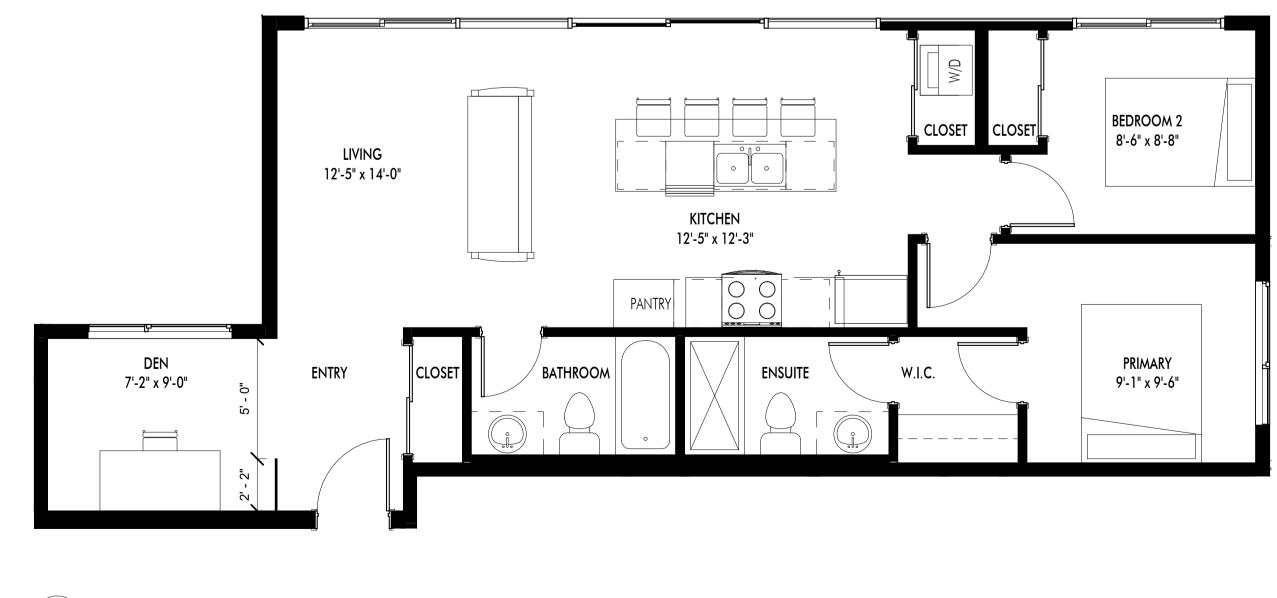

3 UNIT U - 2-BED + DEN (1) - 829 SF A-118 1/4" = 1'-0"



2 UNIT T - 2-BED (5) - 695 SF A-118 1/4" = 1'-0"

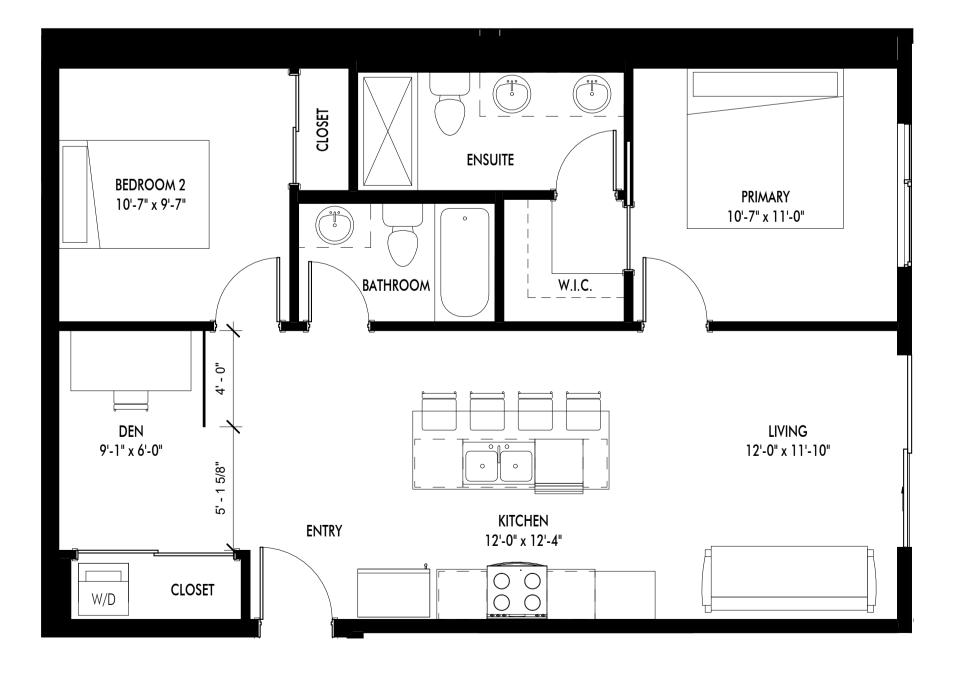

4 UNIT V - 2-BED + DEN (2) - 854 SF A-118 1/4" = 1'-0"

## ADDENDUM NO.3



PHONE:250-448-7801

#### 205-1626 Richter Street, Kelowna, BC V1Y 2M3 www.limearchitecture.com

#### COPYRIGHT.

ALL RIGHTS RESERVED All ideas, designs, drawings and specifications are the exclusive property of LIME Architecture Inc. As instruments of service, they may not be used or reproduced in any manner without the expressed written consent of LIME Architecture Inc. All Contracting Trades shall check and verify all levels, dimensions, data and conditions on the site prior to commencement of any work. Any discrepancies are to be reported immediately to LIME Architecture Inc. Do not Scale any dimensions from this drawing.

All trades are to execute the work in accordance with the current municipality building by-laws and requirements of other local authorities having jurisdiction as well as the british columbia building code -(most recent edition) including all published revisions and addenda. All trades shall assume full responsiblity for the locations and protection of all under and above ground utilities, wires and conduit connections, including (but not limited to) water, sewer, gas, hydro and telephone.

#### **Revision No., Date** and Description

1.15.22	SCHEMATICS
2.09.22	SCHEMATICS
1.06.23	SCHEMATICS
2.08.23	SCHEMATICS
2.25.23	FOR DP
3.06.23	FOR DP
3.17.21	FOR DP
3.29.23	FOR REVIEW
3.30.23	ADDENDUM NO.
4.14.23	ADDENDUM NO.2

#### Plot Date

04.14.23

LAYOUTS

A-118


Drawing No.

TYPICAL UNIT


PROJECT

Revo (Collinson Rise)

DRAWING TITLE

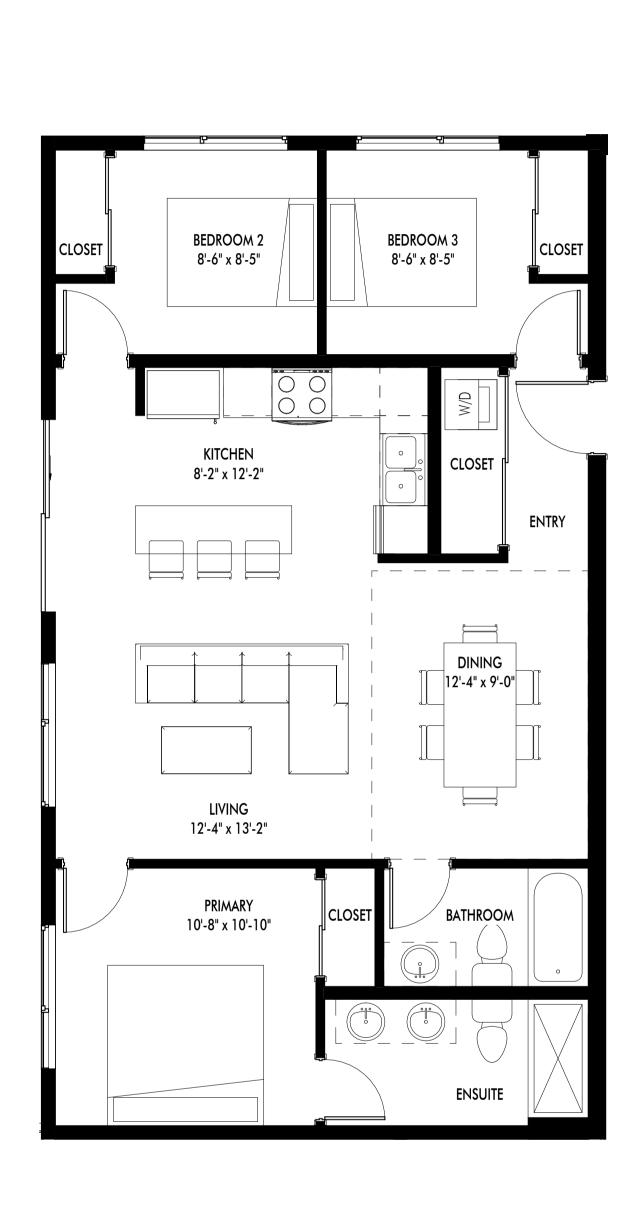

1 UNIT W - 3-BED - 921 SF A-119 1/4" = 1'-0"

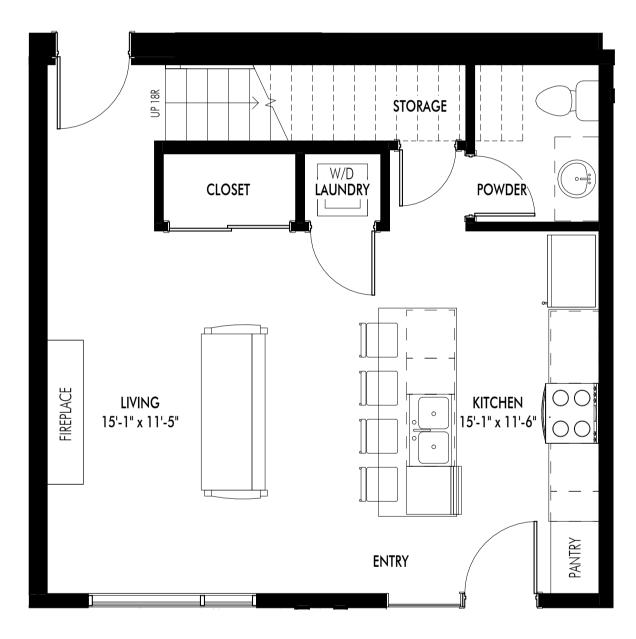

2 UNIT X - TOWNHOUSE - ENTRY - 529 SF A-119 1/4" = 1'-0"

## ADDENDUM NO.3



PHONE:250-448-7801

#### 205-1626 Richter Street, Kelowna, BC V1Y 2M3 www.limearchitecture.com

#### COPYRIGHT. ALL RIGHTS RESERVED

All ideas, designs, drawings and specifications are the exclusive property of LIME Architecture Inc. As instruments of service, they may not be used or reproduced in any manner without the expressed written consent of LIME Architecture Inc. All Contracting Trades shall check and verify all levels, dimensions, data and conditions on the site prior to commencement of any work. Any discrepancies are to be reported immediately to LIME Architecture Inc. Do not Scale any dimensions from this drawing.


accordance with the current municipality building by-laws and requirements of other local authorities having jurisdiction as well as the british columbia building code -(most recent edition) including all published revisions and addenda. All trades shall assume full responsibility for the locations and protection of all under and above ground utilities, wires and conduit connections, including (but not limited to) water, sewer, gas, hydro and telephone.


#### Revision No., Date and Description

02.08.23 SCHEMATICS 02.25.23 FOR DP 03.06.23 FOR DP 03.17.21 FOR DP



3 UNIT X - TOWNHOUSE - SECOND LEVEL - 475 SF A-119 1/4" = 1'-0"

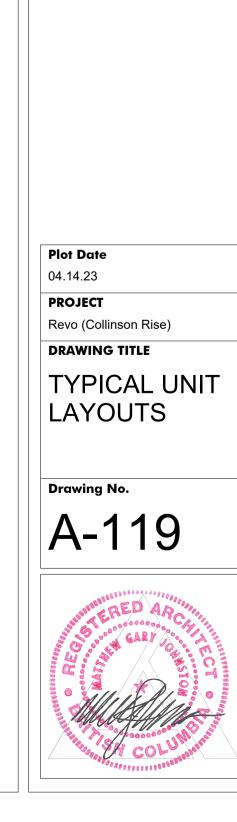


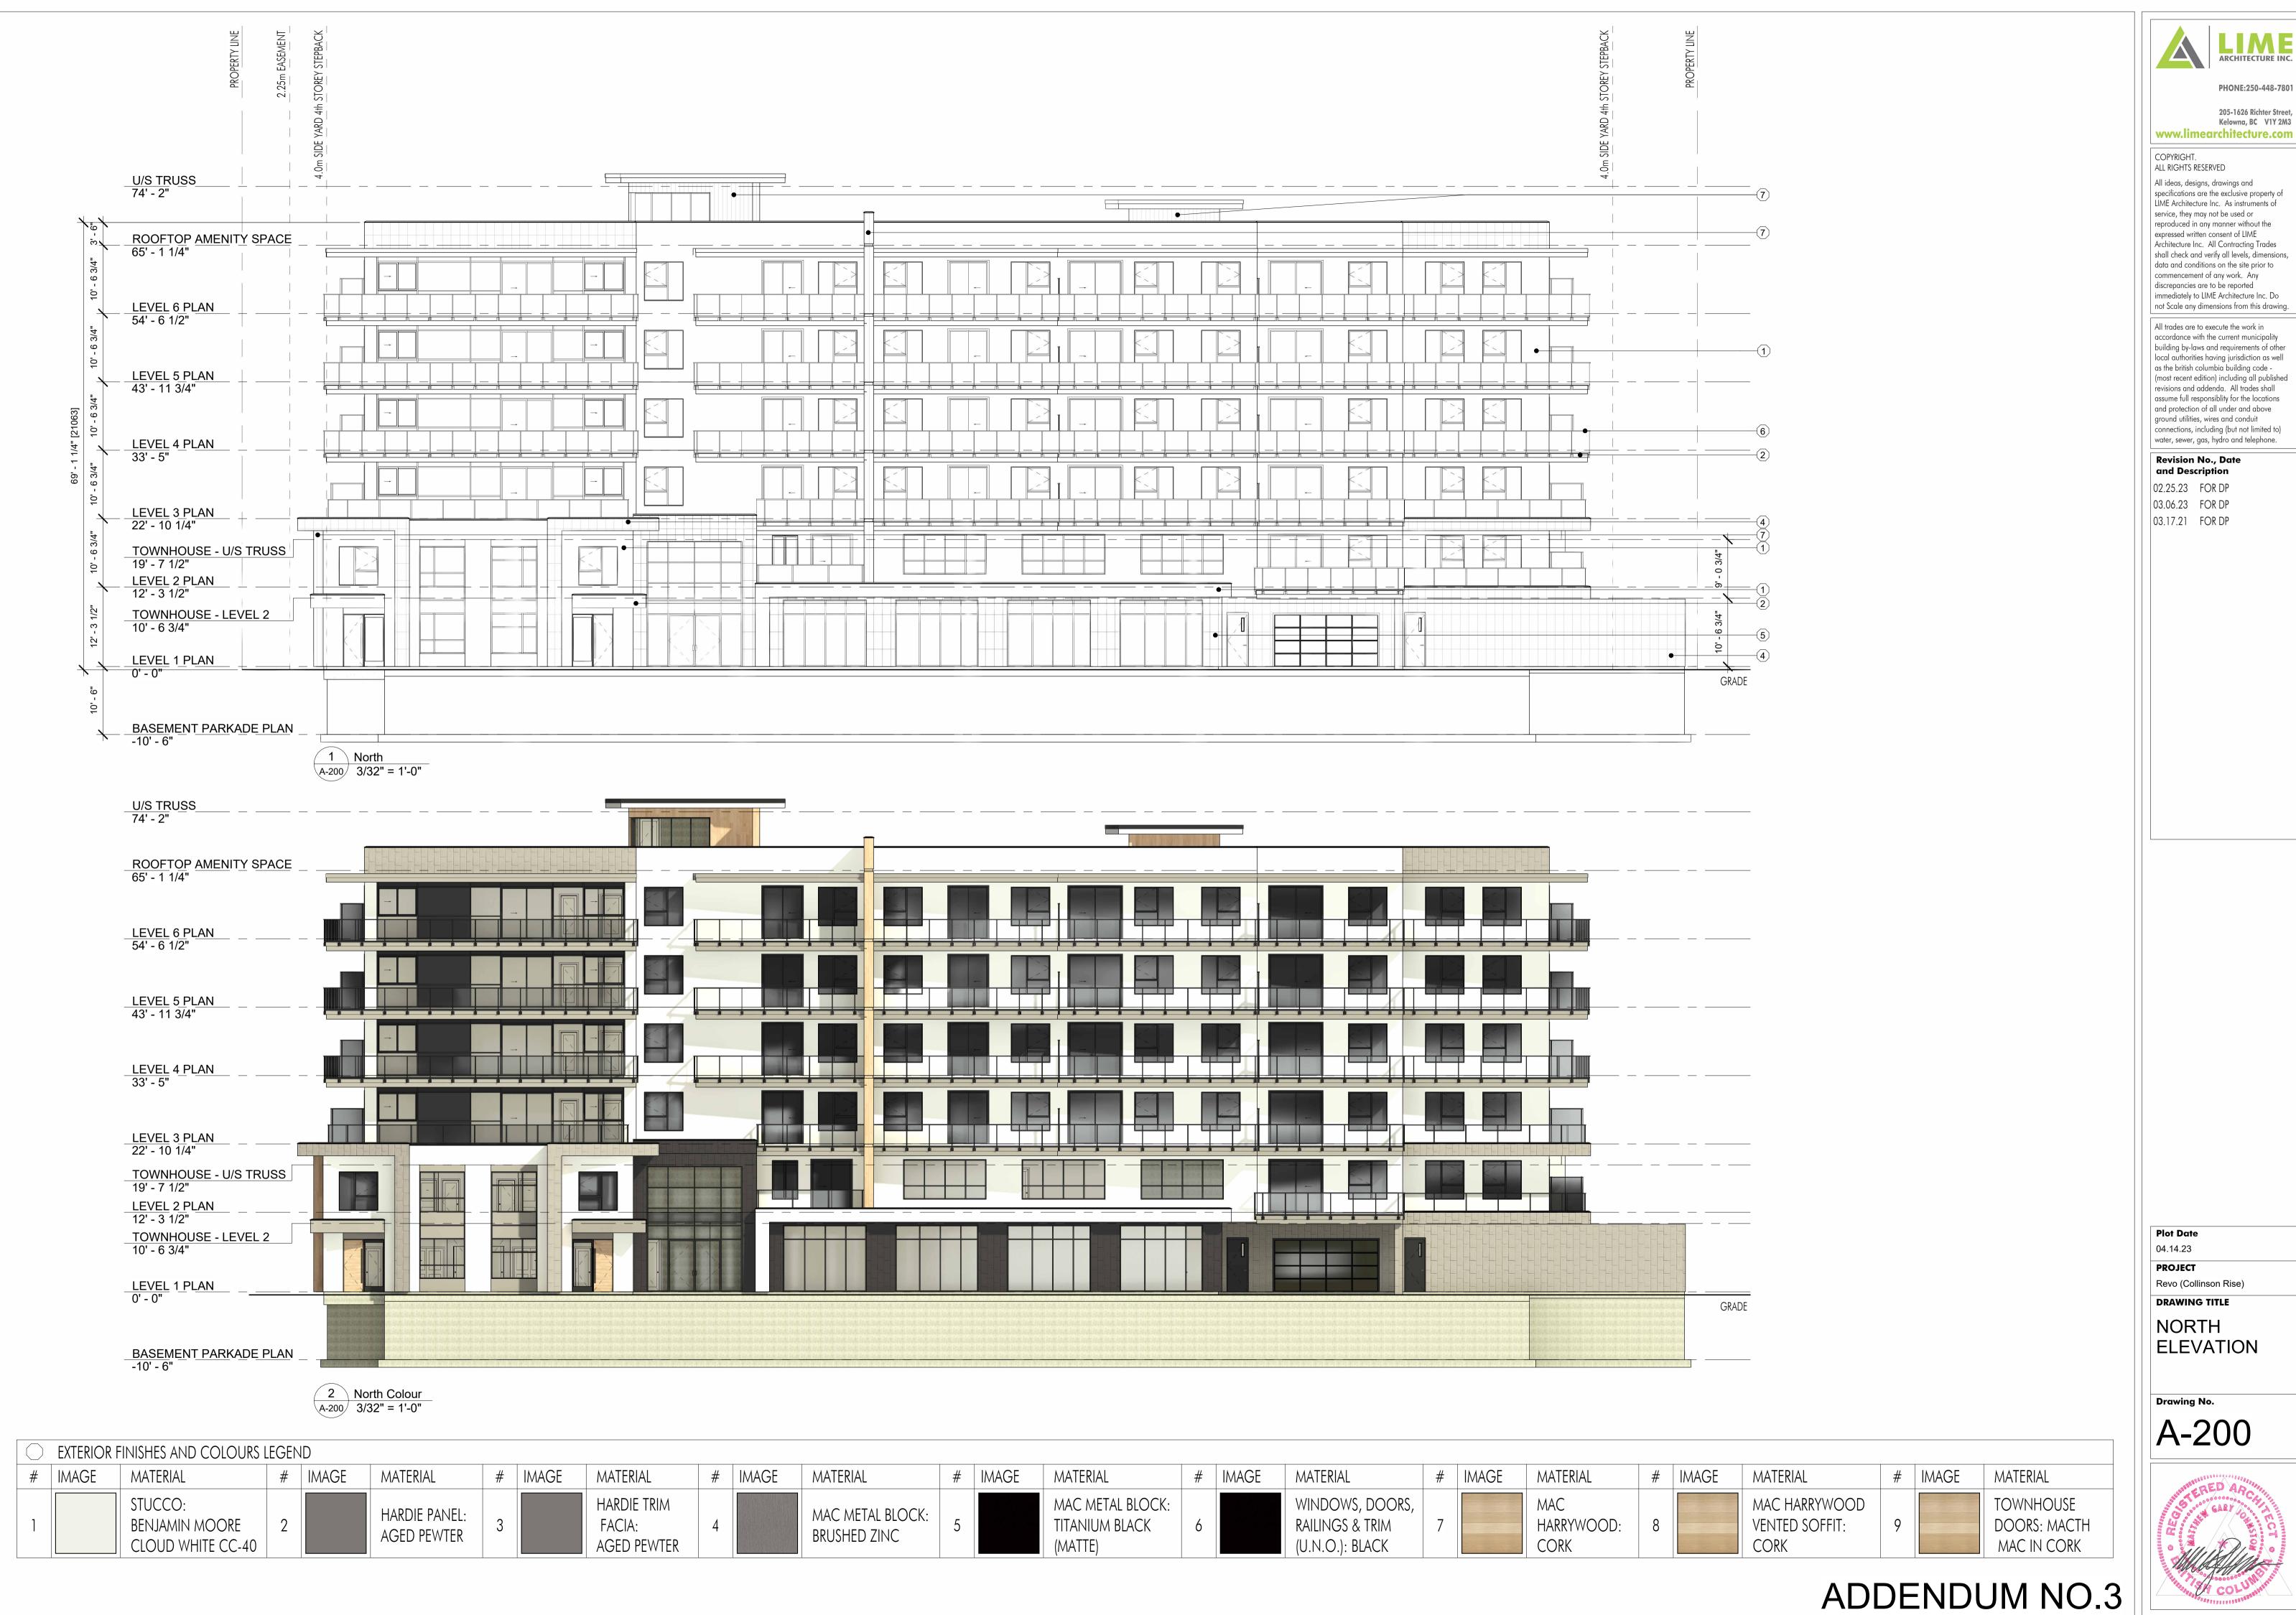

#	IMAGE	MATERIAL	#	IMAGE	MATERIAL	#	IMAGE	MATERIAL	#	IMAGE	MATER
4		MAC METAL BLOCK: BRUSHED ZINC	5		MAC METAL BLOCK: TITANIUM BLACK (MATTE)	6		WINDOWS, DOORS, RAILINGS & TRIM (U.N.O.): BLACK	7		MAC HARRY CORK
										·	



	<text><text><text><section-header><text><text><text><text></text></text></text></text></section-header></text></text></text>
<complex-block></complex-block>	Plot Date 04.14.23 PROJECT Revo (Collinson Rise) DRAWING TITLE SOUTH ELEVATION Drawing No. Drawing No.

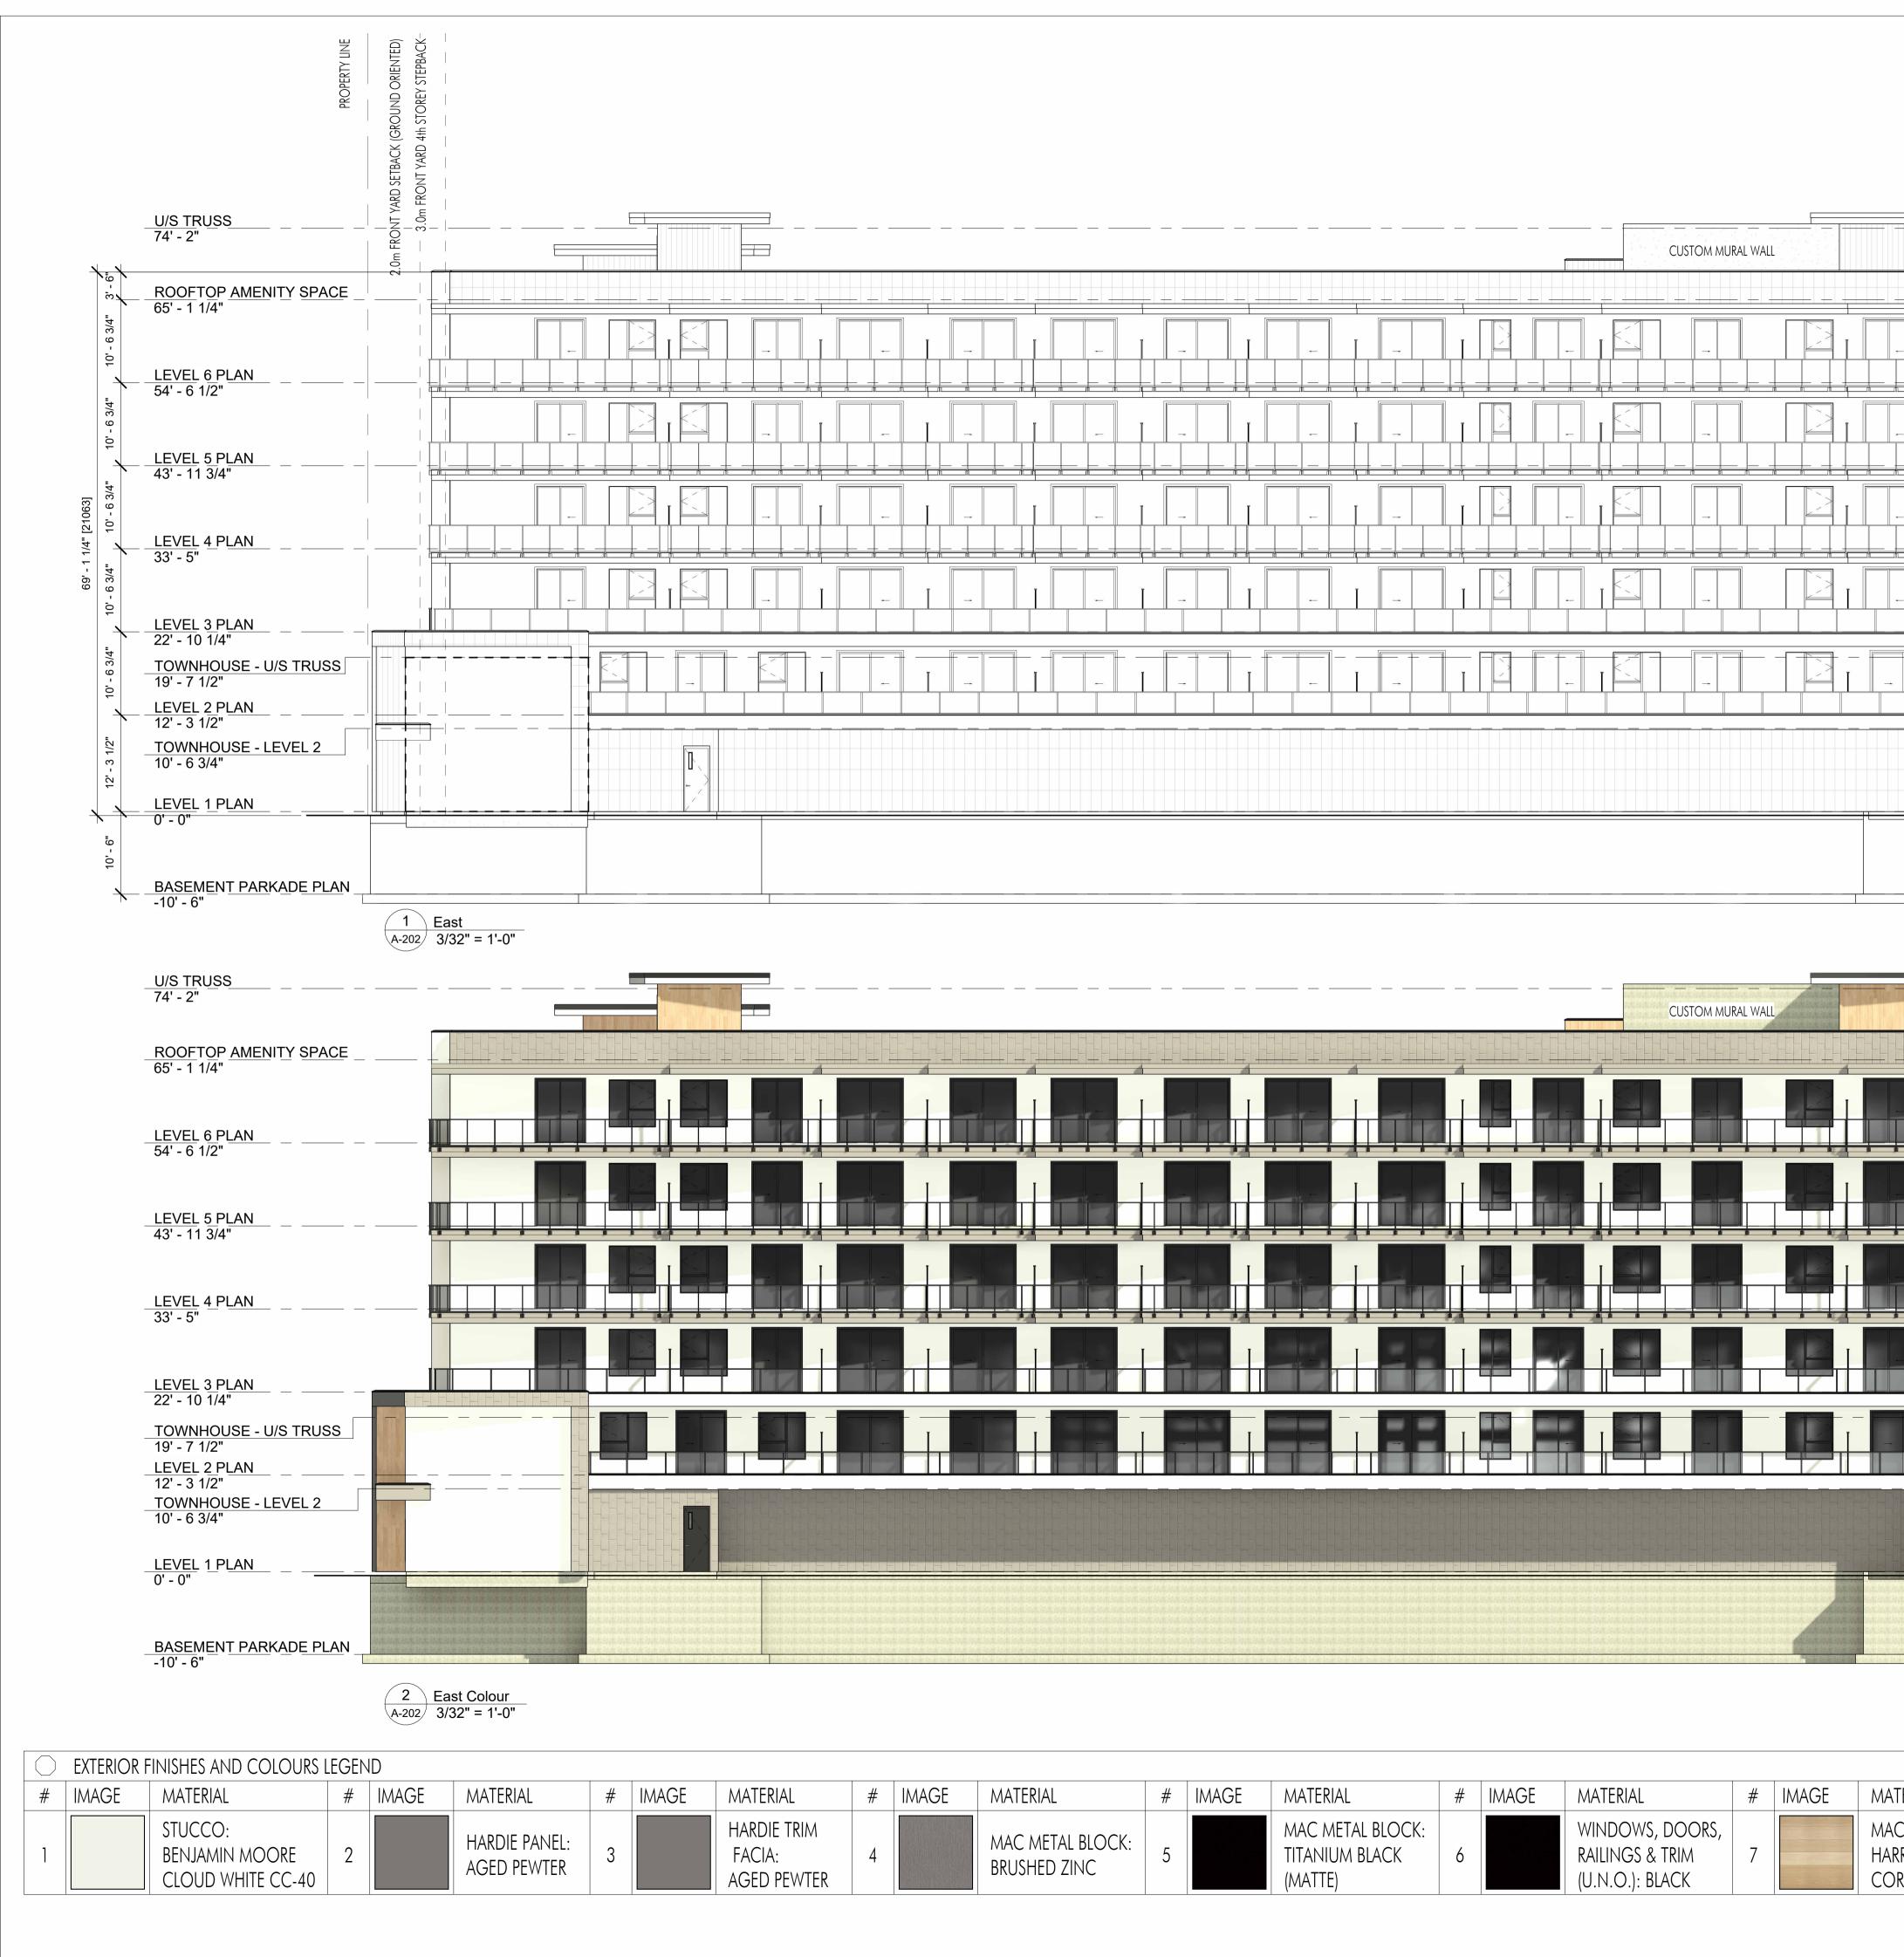

	3.0m FRONT YARD 4th STOREY STEPBACK 3.0m FRONT YARD 4th STOREY STEPBACK 1.85M ROAD DEDICATION			<image/> <text><text><text><section-header><text><text></text></text></section-header></text></text></text>
		    GRADE		Plot Date 04.14.23 PROJECT Revo (Collinson Rise) DRAWING TITLE EAST ELEVATION Drawing No. A-202
ATERIAL # IMAGE AC ARRYWOOD: 8 ORK	MATERIAL MAC HARRYWOOD VENTED SOFFIT: CORK	# IMAGE 9	MATERIAL TOWNHOUSE DOORS: MACTH MAC IN CORK	GRATING CARTON C


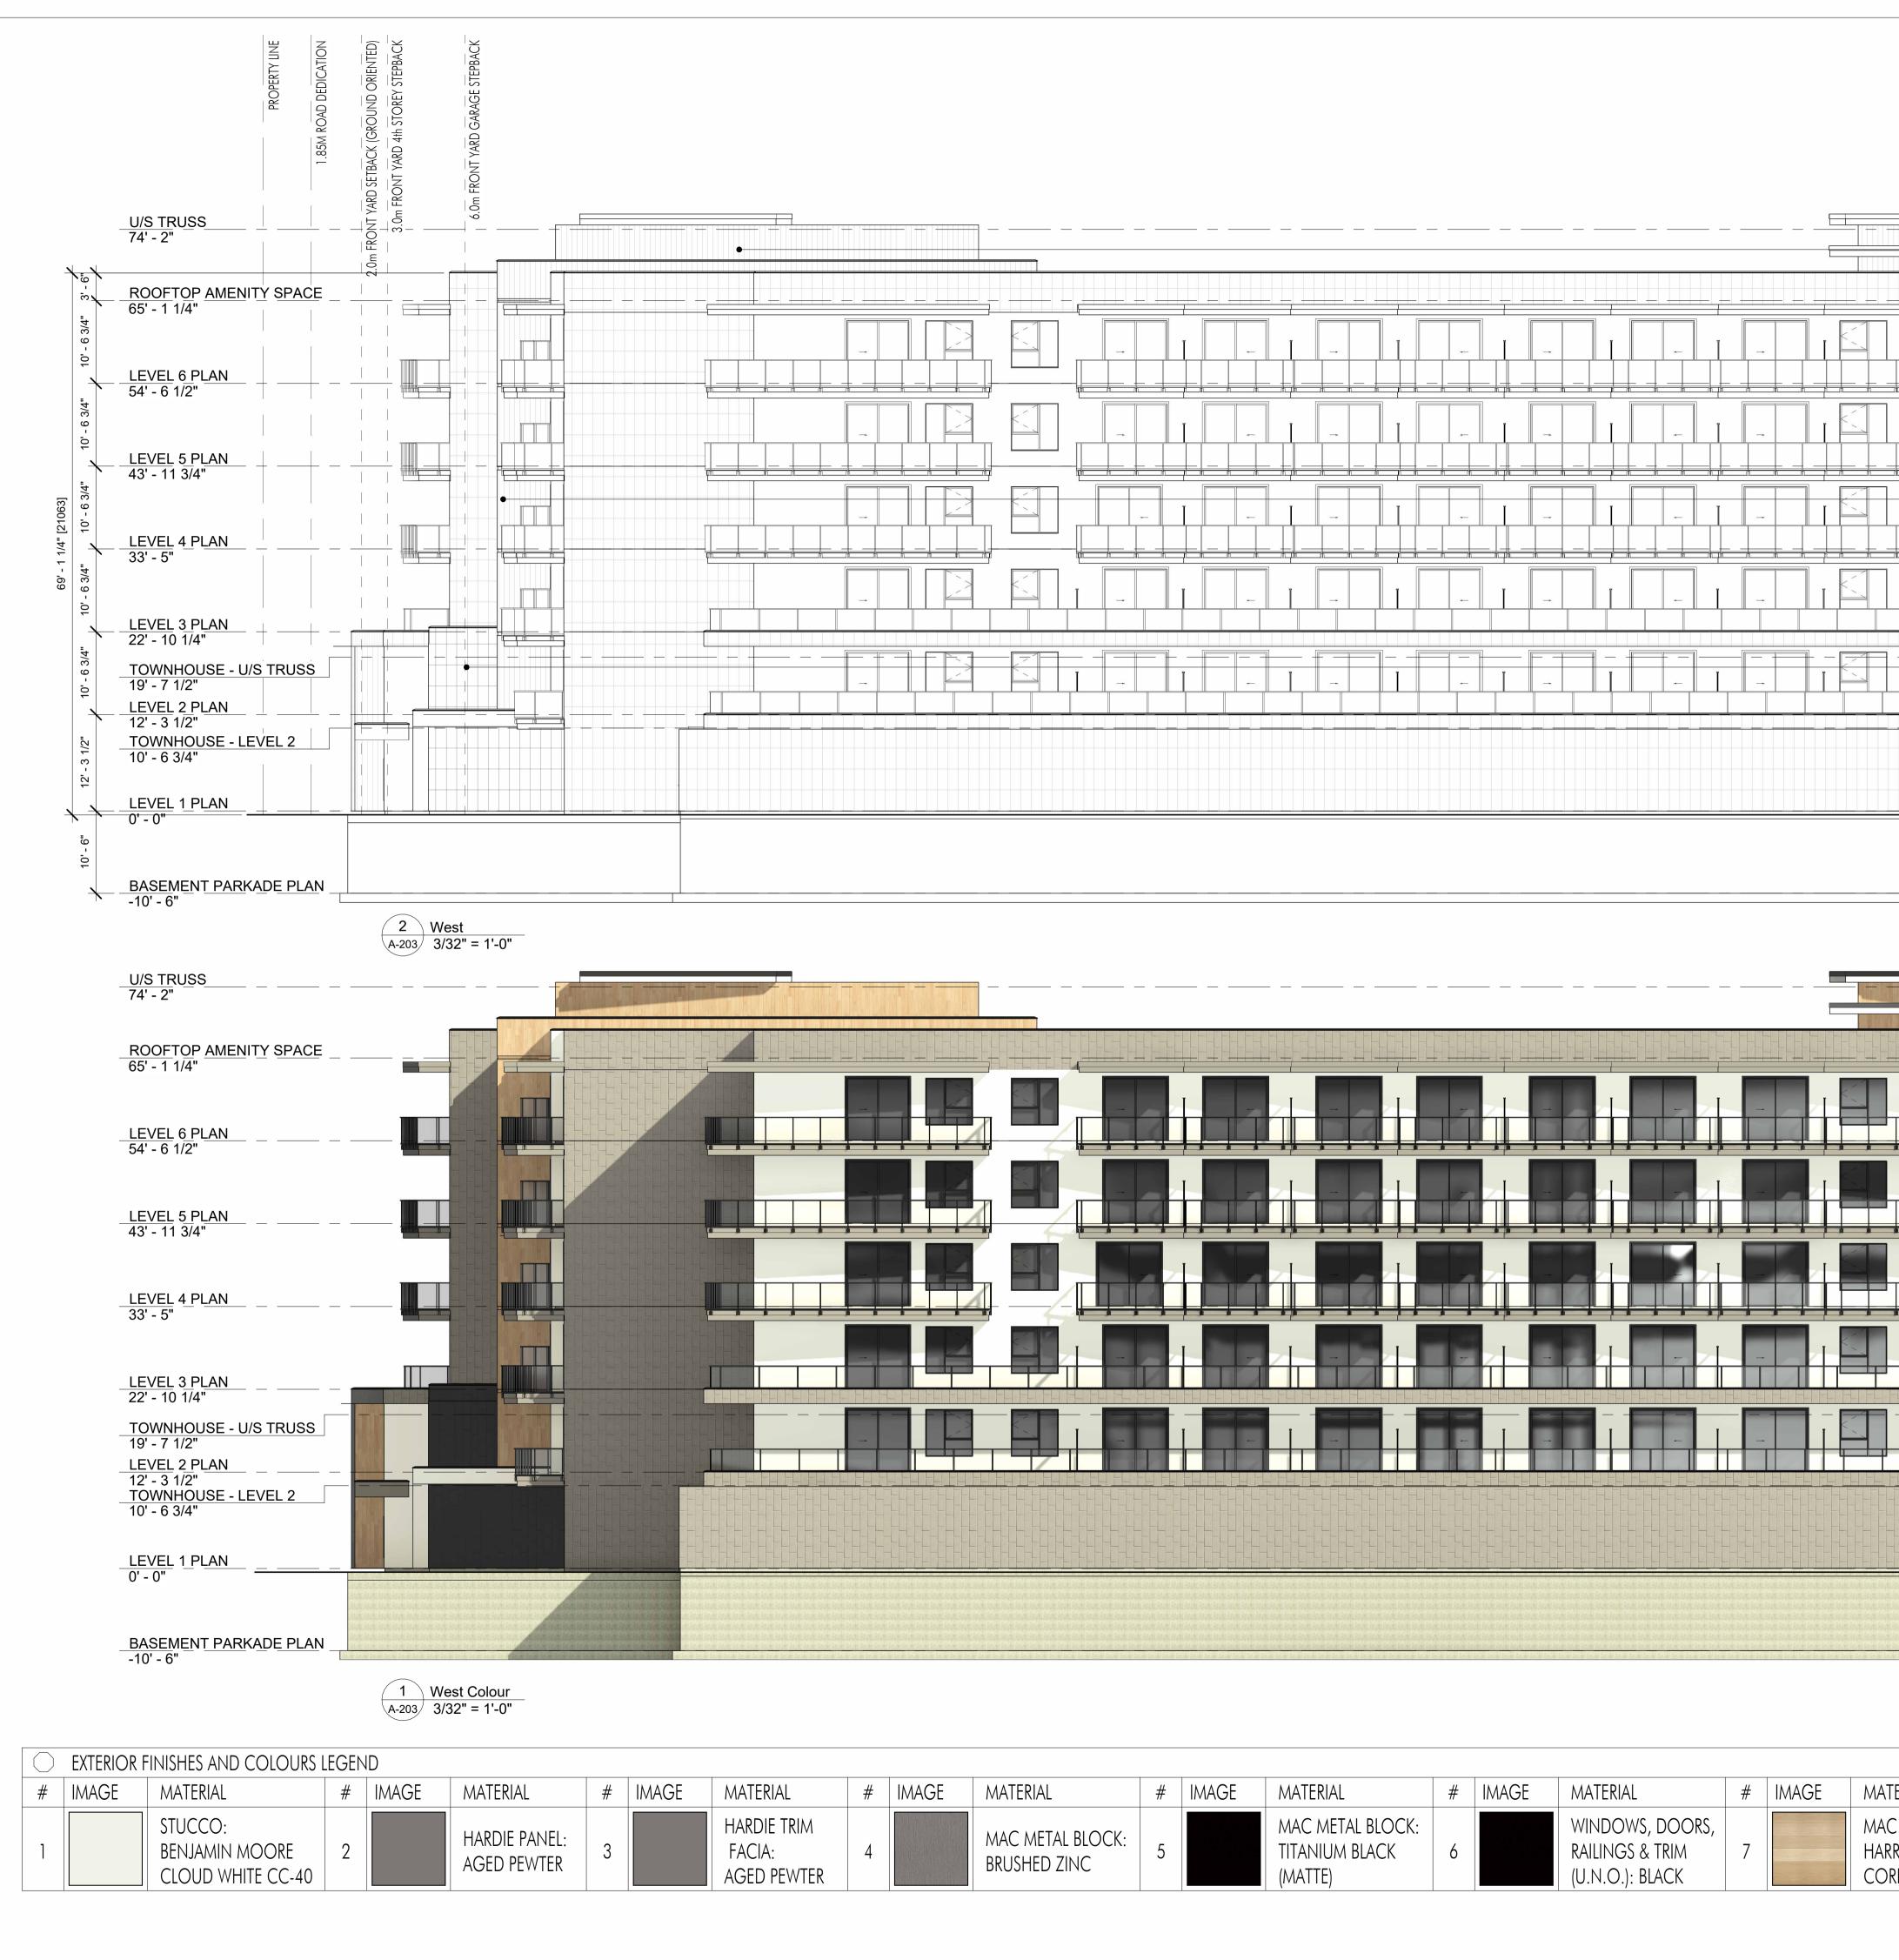


	Image: control of the control of th
*       MAGE       MIERAL       MIERAL <td>Plot Date   04.14.23   PROJECT   Revo (Collinson Rise)   DRAWING TITLE   VEST   ELEVATION   Drawing No.  A-203</td>	Plot Date   04.14.23   PROJECT   Revo (Collinson Rise)   DRAWING TITLE   VEST   ELEVATION   Drawing No.  A-203

	205-1626 Richter Street Kelowna, BC VIY 2M3 www.limearchitecture.com All ideas, designs, drawings and specifications are the exclusive property of LIME Architecture Inc. As instruments of service, they may not be used or reproduced in any manner without the expressed written consent of LIME Architecture Inc. All Contracting Trades shall check and verify all levels, dimensions, data and conditions on the site prior to commencement of any work. Any discrepancies are to be reported immediately to LIME Architecture Inc. Do not Scale any dimensions from this drawing. All trades are to execute the work in accordance with the current municipality building by-laws and requirements of other local authorities having jurisdiction as well as the british columbia building code - (most recent edition) including all published revisions and addenda. All trades shall assume full responsibility for the locations and protection of all under and above ground utilities, wires and conduit connections, including (but not limited to) water, sewer, gas, hydro and telephone. <b>Revision No., Date and Description</b> 02.25.23 FOR DP 03.06.23 FOR DP 03.17.21 FOR DP
	Plot Date 04.14.23 PROJECT Revo (Collinson Rise) DRAWING TITLE WEST ELEVATION
#       IMAGE       MATERIAL       #       IMAGE       IMAGE       IMAGE       IOWNHOUSE       IOWNHOUSE       IOWNHOUSE       IOWNHOUSE       IOWNHOUSE       IOWNHOUSE <td>Drawing No. A-203</td>	Drawing No. A-203

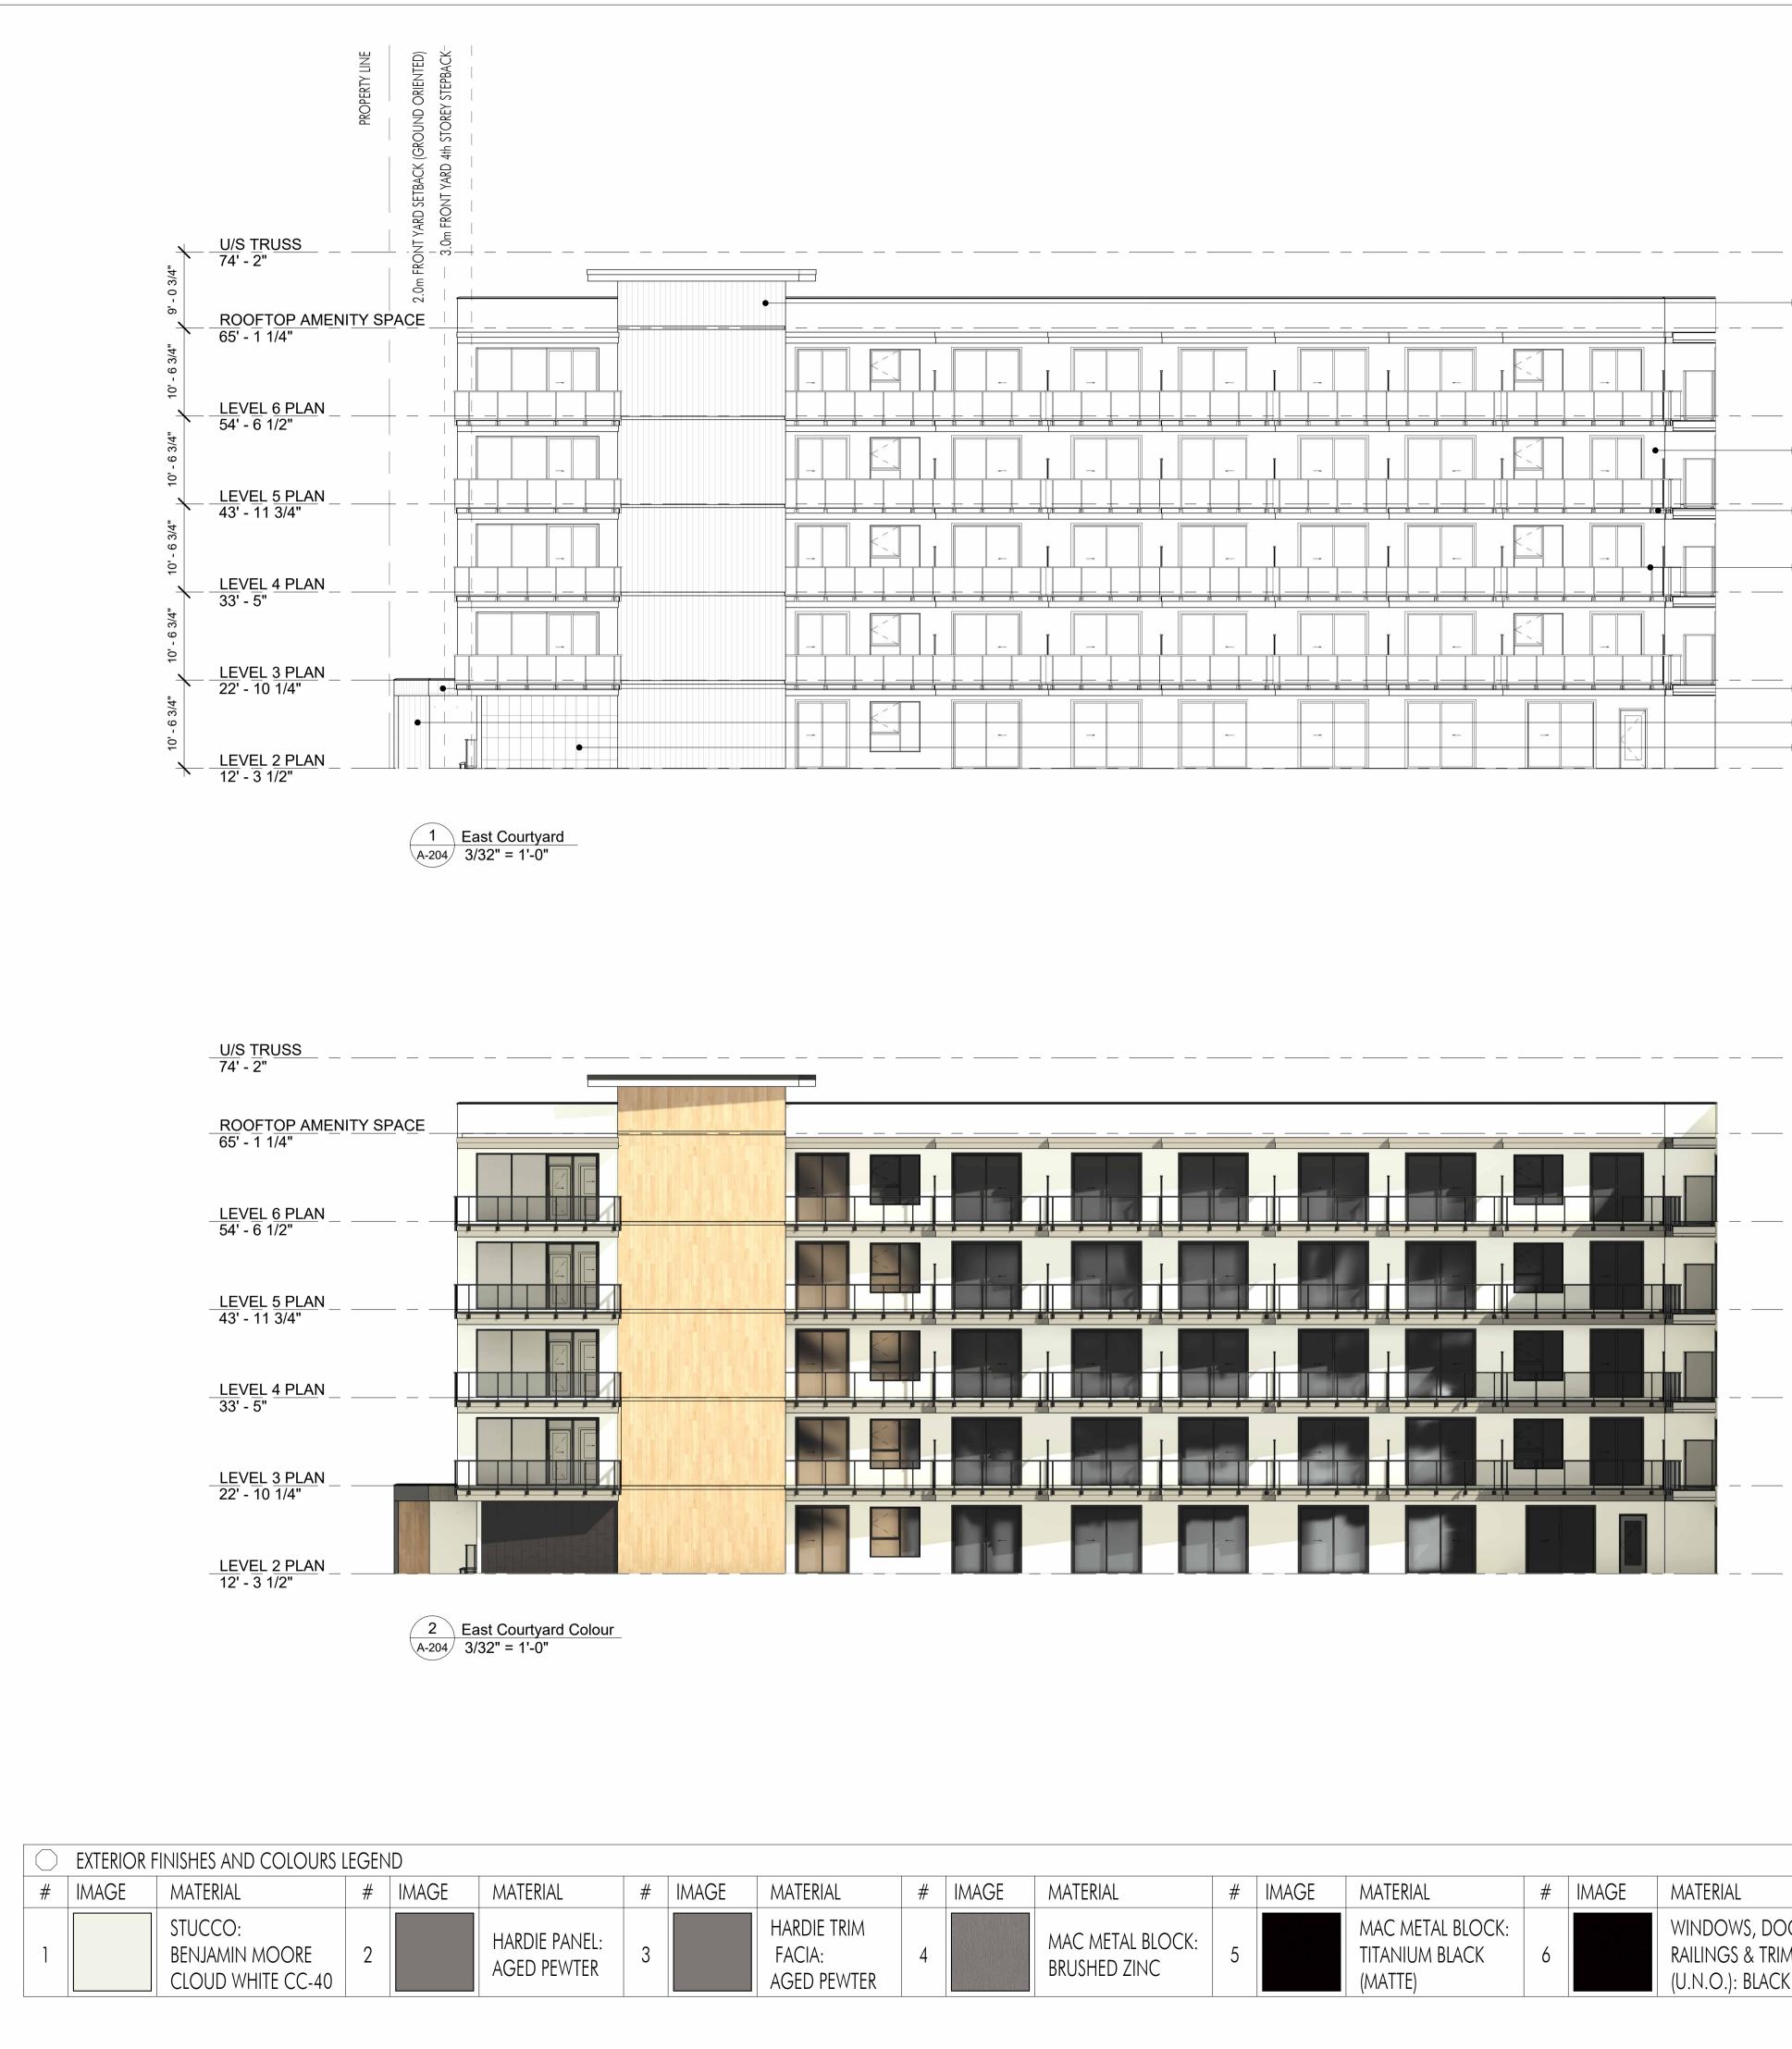

	 	 (7)
		( <u>)</u>
		(1)
		2
		6
		0
		(4) (7)
•	 · · · ·	5

4 MAC METAL BLOCK: 5 TITANIUM BLACK 6 RAILINGS & TRIM 7 HARRYWOOD: 8 VENTED SOFFIT: 9 DOORS: MAC												_						
4 MAC METAL BLOCK: 5 TITANIUM BLACK 6 RAILINGS & TRIM 7 HARRYWOOD: 8 VENTED SOFFIT: 9 DOORS: MAC	#	IMAGE	MATERIAL	#	IMAGE	MATERIAL	#	IMAGE	MATERIAL									
	4			5			6			7		HARRYWOOD:	8		VENTED SOFFIT:	9		TOWNHOUSE DOORS: MACTH MAC IN CORK



#### PHONE:250-448-7801

#### 205-1626 Richter Street, Kelowna, BC V1Y 2M3 www.limearchitecture.com

#### COPYRIGHT. ALL RIGHTS RESERVED

All ideas, designs, drawings and specifications are the exclusive property of LIME Architecture Inc. As instruments of service, they may not be used or reproduced in any manner without the expressed written consent of LIME Architecture Inc. All Contracting Trades shall check and verify all levels, dimensions, data and conditions on the site prior to commencement of any work. Any discrepancies are to be reported immediately to LIME Architecture Inc. Do not Scale any dimensions from this drawing. All trades are to execute the work in

accordance with the current municipality building by-laws and requirements of other local authorities having jurisdiction as well as the british columbia building code -(most recent edition) including all published revisions and addenda. All trades shall assume full responsiblity for the locations and protection of all under and above ground utilities, wires and conduit connections, including (but not limited to) water, sewer, gas, hydro and telephone.

#### **Revision No., Date** and Description

02.25.23 FOR DP 03.06.23 FOR DP 03.17.21 FOR DP


#### Plot Date 04.14.23

PROJECT

Revo (Collinson Rise) DRAWING TITLE

COURTYARD ELEVATION



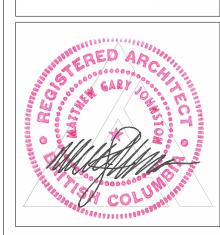



#	IMAGE	MATERIAL	#	IMAGE	MATERIAL	#	IMAGE	MATERIAL	#	IMAGE	MATERIAL
4		MAC METAL BLOCK: BRUSHED ZINC	5		MAC METAL BLOCK: TITANIUM BLACK (MATTE)	6		WINDOWS, DOORS, RAILINGS & TRIM (U.N.O.): BLACK	7		MAC HARRYWOOD: CORK
	<u> </u>				1				1		



#### PHONE:250-448-7801

#### 205-1626 Richter Street, Kelowna, BC V1Y 2M3 www.limearchitecture.com

#### COPYRIGHT. ALL RIGHTS RESERVED

All ideas, designs, drawings and specifications are the exclusive property of LIME Architecture Inc. As instruments of service, they may not be used or reproduced in any manner without the expressed written consent of LIME Architecture Inc. All Contracting Trades shall check and verify all levels, dimensions, data and conditions on the site prior to commencement of any work. Any discrepancies are to be reported immediately to LIME Architecture Inc. Do not Scale any dimensions from this drawing. All trades are to execute the work in

accordance with the current municipality building by-laws and requirements of other local authorities having jurisdiction as well as the british columbia building code -(most recent edition) including all published revisions and addenda. All trades shall assume full responsiblity for the locations and protection of all under and above ground utilities, wires and conduit connections, including (but not limited to) water, sewer, gas, hydro and telephone.

#### **Revision No., Date** and Description

02.25.23 FOR DP 03.06.23 FOR DP 03.17.21 FOR DP

#### Plot Date 04.14.23

PROJECT

Revo (Collinson Rise) DRAWING TITLE

COURTYARD ELEVATION





#### CORK MAC IN CORK ADDENDUM NO.3

9

# IMAGE

# IMAGE

8

MATERIAL

MAC HARRYWOOD

VENTED SOFFIT:

MATERIAL

TOWNHOUSE

DOORS: MACTH



15

20

25 M

DOG RUN



COMMUNITY GARDEN PLOT

#### NOTES

1. PLANT MATERIAL AND CONSTRUCTION METHODS SHALL MEET OR EXCEED CANDAIAN LANDSCAPE STANDARDS. ALL OFFSITE LANDSCAPE WORKS TO MEET CITY OF KELOWNA BYLAW 12375 STANDARDS.

2. ALL SOFT LANDSCAPE AREAS SHALL BE WATERED BY A FULLY AUTOMATIC TIMED UNDERGROUND IRRIGATION SYSTEM.

3. TREE AND SHRUB BEDS TO BE DRESSED IN A MINIMUM 75mm NATURAL WOOD MULCH AS SHOWN IN PLANS. DO NOT PLACE WEED MAT UNDERNEATH TREE AND SHRUB BEDS.

4. SHRUB BEDS TO RECEIVE A MINIMUM 300mm DEPTH TOPSOIL PLACEMENT. TREE BEDS TO RECEIVE A MINIMUM 1000mm DEPTH TOPSOIL PLACEMENT. SMALL TREE BEDS TO RECEIVE 1500mm DEPTH TOPSOIL PLACEMENT TO ACHIEVE SOIL VOLUME PER TREE REQUIREMENTS.

5. TURF AREA FROM SOD SHALL BE NO.1 GRADE GROWN FROM CERTIFIED SEED OF IMPROVED CULTIVARS REGISTERED FOR SALE IN B.C. AND SHALL BE TOLERANT OF DROUGHT CONDITIONS. A MINIMUM OF 150mm DEPTH OF GROWING MEDIUM IS REQUIRED BENEATH TURF AREAS. TURF AREAS SHALL MEET EXISTING GRADES AND HARD SURFACES FLUSH.

6. SITE GRADING AND DRAINAGE WILL ENSURE THAT ALL STRUCTURES HAVE POSITIVE DRAINAGE AND THAT NO WATER OR LOOSE IMPEDIMENTS WILL BE DISCHARGED FROM THE LOT ONTO ADJACENT PUBLIC, COMMON, OR PRIVATE PROPERTIES.

7. Soil Cells with full depth growing medium under all hardscape and Crusher fines paving in setback.

#### **PLANT LIST**


BOTANICAL NAME	COMMON NAME	QTY	SIZE/SPACING & REMARKS
TREES			
ACER RUBRUM 'ARMSTRONG'	ARMSTRONG MAPLE	4	5cm CAL.
AMELANCHIER X GRANDIFLORA 'AUTUMN BRILLIANCE'	AUTUMN BRILLIANCE SERVICEBERRY	4	3cm CAL
BETULA OCCIDENTALIS	RIVER BIRCH	9	4cm CAL
CARPINUS CAROLINIANA	AMERICAN HORNBEAM	4	4cm CAL
CERCIDIPHYLLUM JAPONICUM	Katsura tree	3	5cm CAL
SYRINGA RETICULATA 'IVORY SILK'	IVORY SILK TREE LILAC	10	3cm CAL.
SHRUBS			
ARCTOSTAPHYLOS UVA-URSI	KINNIKINNICK	196	#02 CONT. /0.6M O.C. SPACING
BUXUS 'GREEN VELVET'	GREEN VELVET BOXWOOD	149	#02 CONT. /1.2M O.C. SPACING
MAHONIA AQUIFOLIUM	OREGON GRAPE HOLLY	43	#02 CONT. /1.3M O.C. SPACING
rosa 'radcon'	RAINBOW KNOCKOUT ROSE	71	#02 CONT. /1.0M O.C. SPACING
TAXUS MEDIA 'TAUTONII'	TAUTON YEW	279	#02 CONT. /1.0M O.C. SPACING
VIBURNUM TRILOBUM 'COMPACTUM'	COMPACT CRANBERRY	31	#02 CONT. /1.5M O.C. SPACING
PERENNIALS, GRASSES & GROUNDCOVERS			
Achillea Millefolium 'terracotta'	TERRACOTTA YARROW	114	#01 CONT. /0.6M O.C. SPACING
ATHYRIUM FILIX-FEMINA 'LADY IN RED'	LADY IN RED FERN	51	#01 CONT. /0.9M O.C. SPACING
CALAMAGROSTIS ACUTIFLORA 'KARL FOERSTER'	KARL FOESTER FEATHER REED GRASS	41	#01 CONT. /1.0M O.C. SPACING
ECHINACEA PURPUREA 'SOLAR FLARE'	SOLAR FLARE CONEFLOWER	114	#01 CONT. /0.6M O.C. SPACING
RUDBECKIA FULGIDA 'GOLDSTURM'	GOLDSTURM CONEFLOWER	114	-
SEDUM SPECTABILE 'AUTUMN JOY'	AUTUMN JOY STONECROP	114	
SPOROBOLUS HETEROLEPIS	PRAIRIE DROPSEED	41	#01 CONT. /1.0M O.C. SPACING
TIARELLA CORDIFOLIA	FOAMFLOWER	114	#01 CONT. /0.6M O.C. SPACING

 $\bigcirc$ 



SUTHERLAND AVENUE



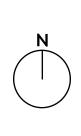

PROJECT TITLE

#### **COLLINSON RISE**

Kelowna, BC

DRAWING TITLE

#### CONCEPTUAL LANDSCAPE PLAN - AT GRADE

#### ISSUED FOR / REVISION

1000							
1	23.02.24	Review					
2	23.03.02	Review					
З	23.03.17	Review					
4							
5							

project no	22-1201
DESIGN BY	AM
dravvn by	TR
CHECKED BY	AM
DATE	MAR. 17, 2023
SCALE	1:150
PAGE SIZE	24"x36"

SEAL



DRAWING NUMBER

LS-101

#### **ISSUED FOR REVIEW ONLY**

Copyright Reserved. This drawing is the property of Ecora Engineering &Resource Group Ltd. and shall not be reproduced, resold, or tendered without permission.



**ROOFTOP SEATING AREAS** 



#### **RIVER BIRCH BOSQUE**

#### NOTES

1. PLANT MATERIAL AND CONSTRUCTION METHODS SHALL MEET OR EXCEED CANDAIAN LANDSCAPE STANDARDS. ALL OFFSITE LANDSCAPE WORKS TO MEET CITY OF KELOWNA BYLAW 12375 STANDARDS.

2. All soft landscape areas shall be watered by a fully automatic timed underground irrigation system.

3. TREE AND SHRUB BEDS TO BE DRESSED IN A MINIMUM 75mm NATURAL WOOD MULCH AS SHOWN IN PLANS. DO NOT PLACE WEED MAT UNDERNEATH TREE AND SHRUB BEDS.

4. Shrub Beds to receive a minimum 300mm depth topsoil placement. Tree Beds to receive a minimum 1000mm depth topsoil placement. Small tree Beds to receive 1*5*00mm depth topsoil placement to achieve soil volume per tree Requirements.

5. TURF AREA FROM SOD SHALL BE NO.1 GRADE GROWN FROM CERTIFIED SEED OF IMPROVED CULTIVARS REGISTERED FOR SALE IN B.C. AND SHALL BE TOLERANT OF DROUGHT CONDITIONS. A MINIMUM OF 150mm DEPTH OF GROWING MEDIUM IS REQUIRED BENEATH TURF AREAS. TURF AREAS SHALL MEET EXISTING GRADES AND HARD SURFACES FLUSH.

6. SITE GRADING AND DRAINAGE WILL ENSURE THAT ALL STRUCTURES HAVE POSITIVE DRAINAGE AND THAT NO WATER OR LOOSE IMPEDIMENTS WILL BE DISCHARGED FROM THE LOT ONTO ADJACENT PUBLIC, COMMON, OR PRIVATE PROPERTIES.


7. Soil cells with full depth growing medium under all hardscape and crusher fines paving in setback.

#### PLANT LIST

BOTANICAL NAME	COMMON NAME	QTY	SIZE/SPACING & REMARKS
TREES			
ACER RUBRUM 'ARMSTRONG'	ARMSTRONG MAPLE	4	5cm CAL.
AMELANCHIER X GRANDIFLORA 'AUTUMN BRILLIANCE'	AUTUMN BRILLIANCE SERVICEBERRY	4	3cm CAL.
BETULA OCCIDENTALIS	RIVER BIRCH	9	4cm CAL.
CARPINUS CAROLINIANA	AMERICAN HORNBEAM	4	4cm CAL
CERCIDIPHYLLUM JAPONICUM	Katsura tree	3	5cm CAL.
SYRINGA RETICULATA 'IVORY SILK'	IVORY SILK TREE LILAC	10	3cm CAL.
SHRUBS			
ARCTOSTAPHYLOS UVA-URSI	KINNIKINNICK	196	#02 CONT. /0.6M O.C. SPACINO
BUXUS 'GREEN VELVET'	GREEN VELVET BOXWOOD	149	#02 CONT. /1.2M O.C. SPACINO
MAHONIA AQUIFOLIUM	OREGON GRAPE HOLLY	43	#02 CONT. /1.3M O.C. SPACINO
rosa 'radcon'	RAINBOW KNOCKOUT ROSE	71	#02 CONT. /1.0M O.C. SPACING
Taxus media 'tautonii'	TAUTON YEW	279	#02 CONT. /1.0M O.C. SPACING
VIBURNUM TRILOBUM 'COMPACTUM'	COMPACT CRANBERRY	31	#02 CONT. /1.5M O.C. SPACING
PERENNIALS, GRASSES & GROUNDCOVERS			
ACHILLEA MILLEFOLIUM 'TERRACOTTA'	TERRACOTTA YARROW	114	#01 CONT. /0.6M O.C. SPACINO
ATHYRIUM FILIX-FEMINA 'LADY IN RED'	LADY IN RED FERN	51	#01 CONT. /0.9M O.C. SPACINO
CALAMAGROSTIS ACUTIFLORA 'KARL FOERSTER'	Karl Foester Feather Reed Grass	41	#01 CONT. /1.0M O.C. SPACINO
ECHINACEA PURPUREA 'SOLAR FLARE'	SOLAR FLARE CONEFLOWER	114	#01 CONT. /0.6M O.C. SPACINO
Rudbeckia fulgida 'goldsturm'	GOLDSTURM CONEFLOWER	114	#01 CONT. /0.6M O.C. SPACINO
SEDUM SPECTABILE 'AUTUMN JOY'	AUTUMN JOY STONECROP	114	#01 CONT. /0.6M O.C. SPACING
SPOROBOLUS HETEROLEPIS	PRAIRIE DROPSEED	41	#01 CONT. /1.0M O.C. SPACING
TIARELLA CORDIFOLIA	FOAMFLOWER	114	#01 CONT. /0.6M O.C. SPACING





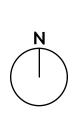

PROJECT TITLE

#### **COLLINSON RISE**

Kelowna, BC

DRAWING TITLE

#### Conceptual Landscape Plan - Roof

ISSUED FOR / REVISION

1	23.02.24	Review
2	23.03.02	Review
3	23.03.17	Review
4		
5		

project no	22-1201
DESIGN BY	AM
dravvn by	TR
CHECKED BY	AM
DATE	MAR. 17, 2023
SCALE	1:150
PAGE SIZE	24"x36"

SEAL



drawing number

LS-102

#### ISSUED FOR REVIEW ONLY

Copyright Reserved. This drawing is the property of Ecora Engineering & Resource Group Ltd. and shall not be reproduced, resold, or tendered without permission.




## LEGEND


GROWING MEDIUM COLUMN, EXPRESSED AT FINISH GRADE, WITH SHRUBS, PERENNIALS AND TREE PLANTINGS AT SURFACE GROWING MEDIUM COLUMN CONTAINED IN SOIL CELLS AND HORIZONTALLY IN CONTACT WITH ADJACENT MEDIUM WITH PAVED FINISH AT SURFACE

GROWING MEDIUM BEYOND 2M SETBACK/LANDSCAPE ZONE

-----

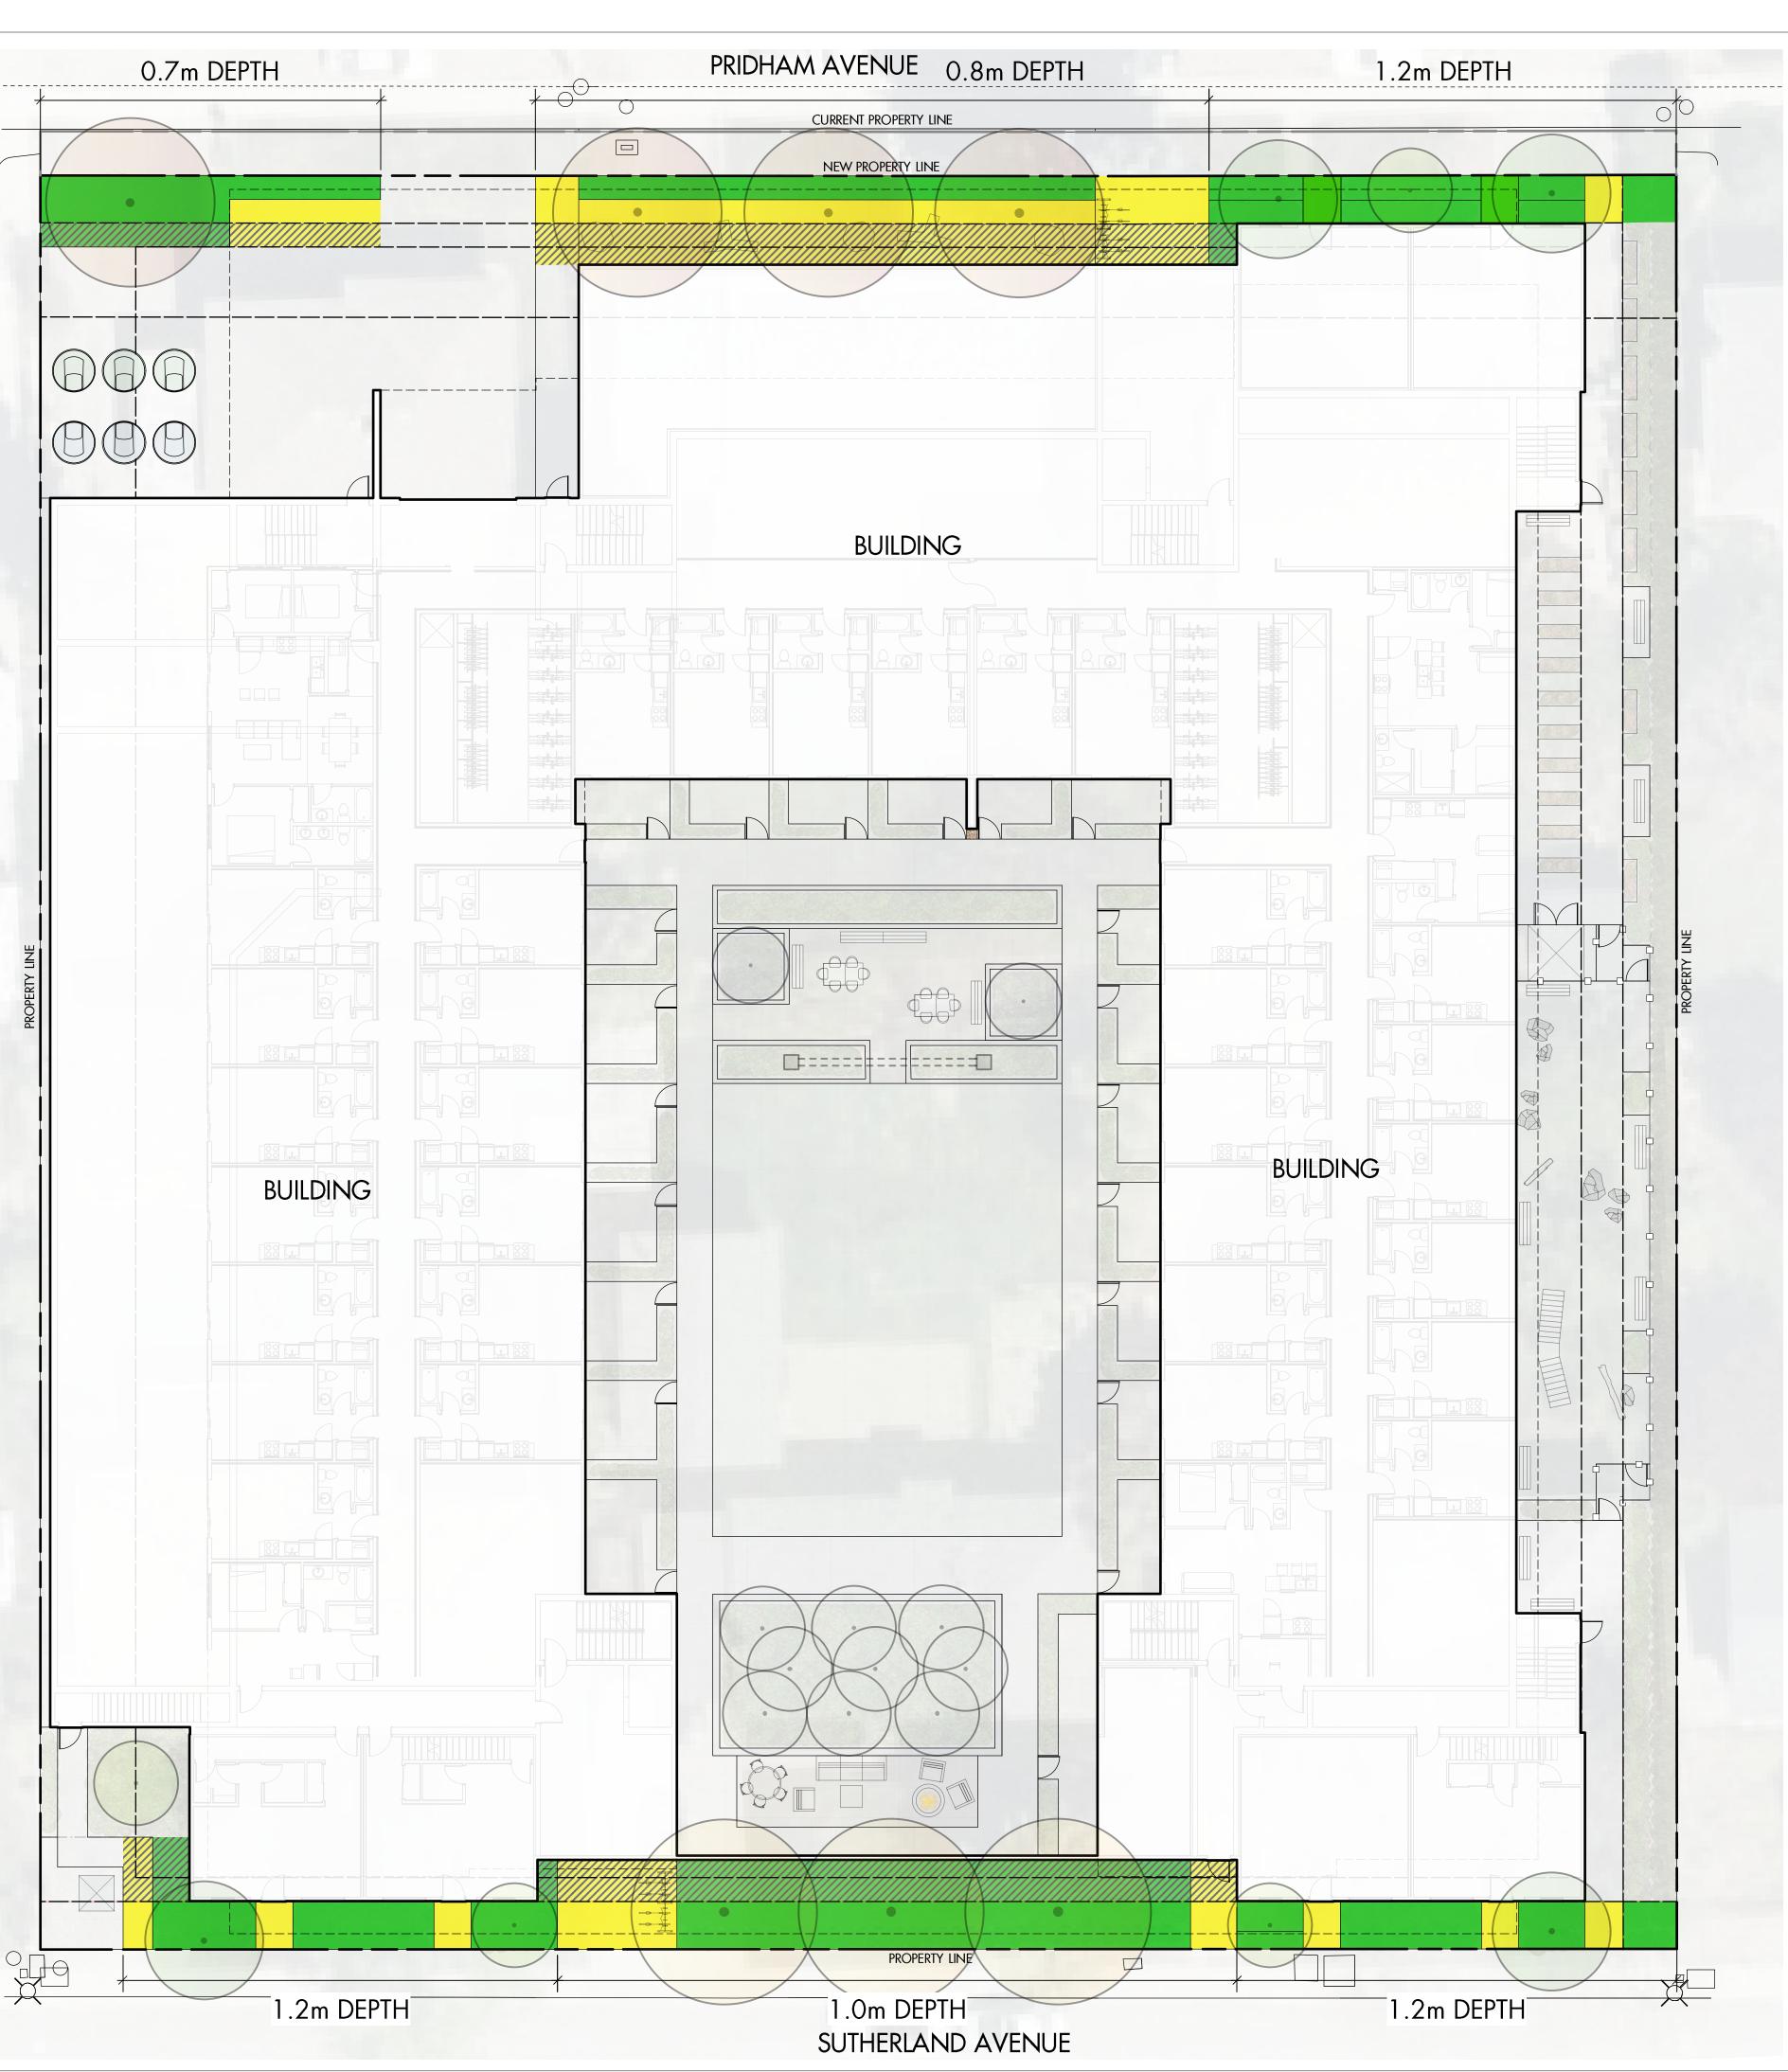



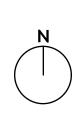

PROJECT TITLE

#### **COLLINSON RISE**

Kelowna, BC

DRAWING TITLE

#### **GROWING MEDIUM DISTRIBUTION PLAN**

ISSUED FOR / REVISION

.000						
1	23.02.24	Review				
2	23.03.02	Review				
3	23.03.17	Review				
4	23.04.13	Review				
5						

project no	22-1201	
design by	AM	
dravvn by	TR	
CHECKED BY	AM	
DATE	APR. 13, 2023	
SCALE	1:150	
PAGE SIZE	24"x36"	

SEAL



DRAWING NUMBER

LS-103

#### ISSUED FOR REVIEW ONLY

Copyright Reserved. This drawing is the property of Ecora Engineering & Resource Group Ltd. and shall not be reproduced, resold, or tendered without permission.



1. IRRIGATION PRODUCTS AND INSTALLATION METHODS SHALL MEET OR EXCEED THE REQUIREMENTS OF THE WATER USE REGULATION BYLAW NO. 10480.

2. THE IRRIGATION SYSTEM SHALL MEET THE REQUIREMENTS, REGULATIONS, AND BYLAWS OF THE WATER PURVEYOR.

15

10

20

25 M

3. THE IRRIGATION SYSTEM SHALL BE EQUIPPED WITH AN APPROVED BACKFLOW PREVENTION DEVICE, WATER METER, AND SHUT OFF VALVE LOCATED OUTSIDE THE BUILDING ACCESSIBLE TO THE CITY.

4. AN APPROVED SMART CONTROLLER SHALL BE INSTALLED. THE IRRIGATION SCHEDULING TIMES SHALL UTILIZE A MAXIMUM ET VALUE OF 7" / MONTH (KELOWNA JULY ET), TAKING INTO CONSIDERATION SOIL TYPE, SLOPE, AND MICROCLIMATE.

5. DRIP LINE AND EMITTERS SHALL INCORPORATE TECHNOLOGY TO LIMIT ROOT INTRUSION.


6. IRRIGATION SLEEVES SHALL BE INSTALLED TO ROUTE IRRIGATION LINES UNDER HARD SURFACES AND FEATURES.

7. IRRIGATION PIPE SHALL BE SIZED TO ALLOW FOR A MAXIMUM FLOW OF 1.5m /SEC.

8. A FLOW SENSOR AND MASTER VALVE SHALL BE CONNECTED TO THE CONTROLLER AND PROGRAMMED TO STOP FLOW TO THE SYSTEM IN CASE OF AN IRRIGATION WATER LEAK.


#### **IRRIGATION LEGEND**

[]]]	Zone #1: High Efficiency Subsurface drip Irrigation for moderate water use Planting Areas Total Area: 224 sq.m. Microclimate: Southeast exposure, partially shaded by trees & Building Estimated Annual water use: 75 cu.m.
[]]]	ZONE #2: HIGH EFFICIENCY SUBSURFACE DRIP IRRIGATION FOR MODERATE WATER USE PLANTING AREAS TOTAL AREA: 136 sq.m. MICROCLIMATE: NORTHEAST EXPOSURE, PARTIALLY SHADED BY TREES & BUILDING ESTIMATED ANNUAL WATER USE: 45 cu.m.
[]]]]	ZONE #3: HIGH EFFICIENCY SUBSURFACE DRIP IRRIGATION FOR MODERATE WATER USE PLANTING AREAS TOTAL AREA: 75 sq.m. MICROCLIMATE: SOUTHEAST EXPOSURE, PARTIALLY SHADED BY TREES & BUILDING ESTIMATED ANNUAL WATER USE: 25 cu.m.
[]]]]	ZONE #4: HIGH EFFICIENCY SUBSURFACE DRIP IRRIGATION FOR MODERATE WATER USE PLANTING AREAS TOTAL AREA: 160 sq.m. MICROCLIMATE: SOUTHWEST EXPOSURE, PARTIALLY SHADED BY TREES & BUILDING ESTIMATED ANNUAL WATER USE: 53 cu.m.
[]]]]	Zone #5: High Efficiency subsurface drip irrigation for moderate water use Planting areas Total area: 203 sq.m. Microclimate: Southeast exposure, partially shaded by trees Estimated annual water use: 68 cu.m.
[]	ZONE #6: LOW VOLUME POP-UP SPRAYHEADS FOR TURF AREAS TOTAL AREA: 139 sq.m. MICROCLIMATE: SOUTHEAST EXPOSURE, PARTIALLY SHADED BY TREES AND BUILDING ESTIMATED ANNUAL WATER USE: 119 cu.m.
(2222)	ZONE #7: LOW VOLUME POP-UP SPRAYHEADS FOR TURF AREAS TOTAL AREA: 139 sq.m. MICROCLIMATE: SOUTHEAST EXPOSURE, PARTIALLY SHADED BY TREES AND BUILDING ESTIMATED ANNUAL WATER USE: 119 cu.m.

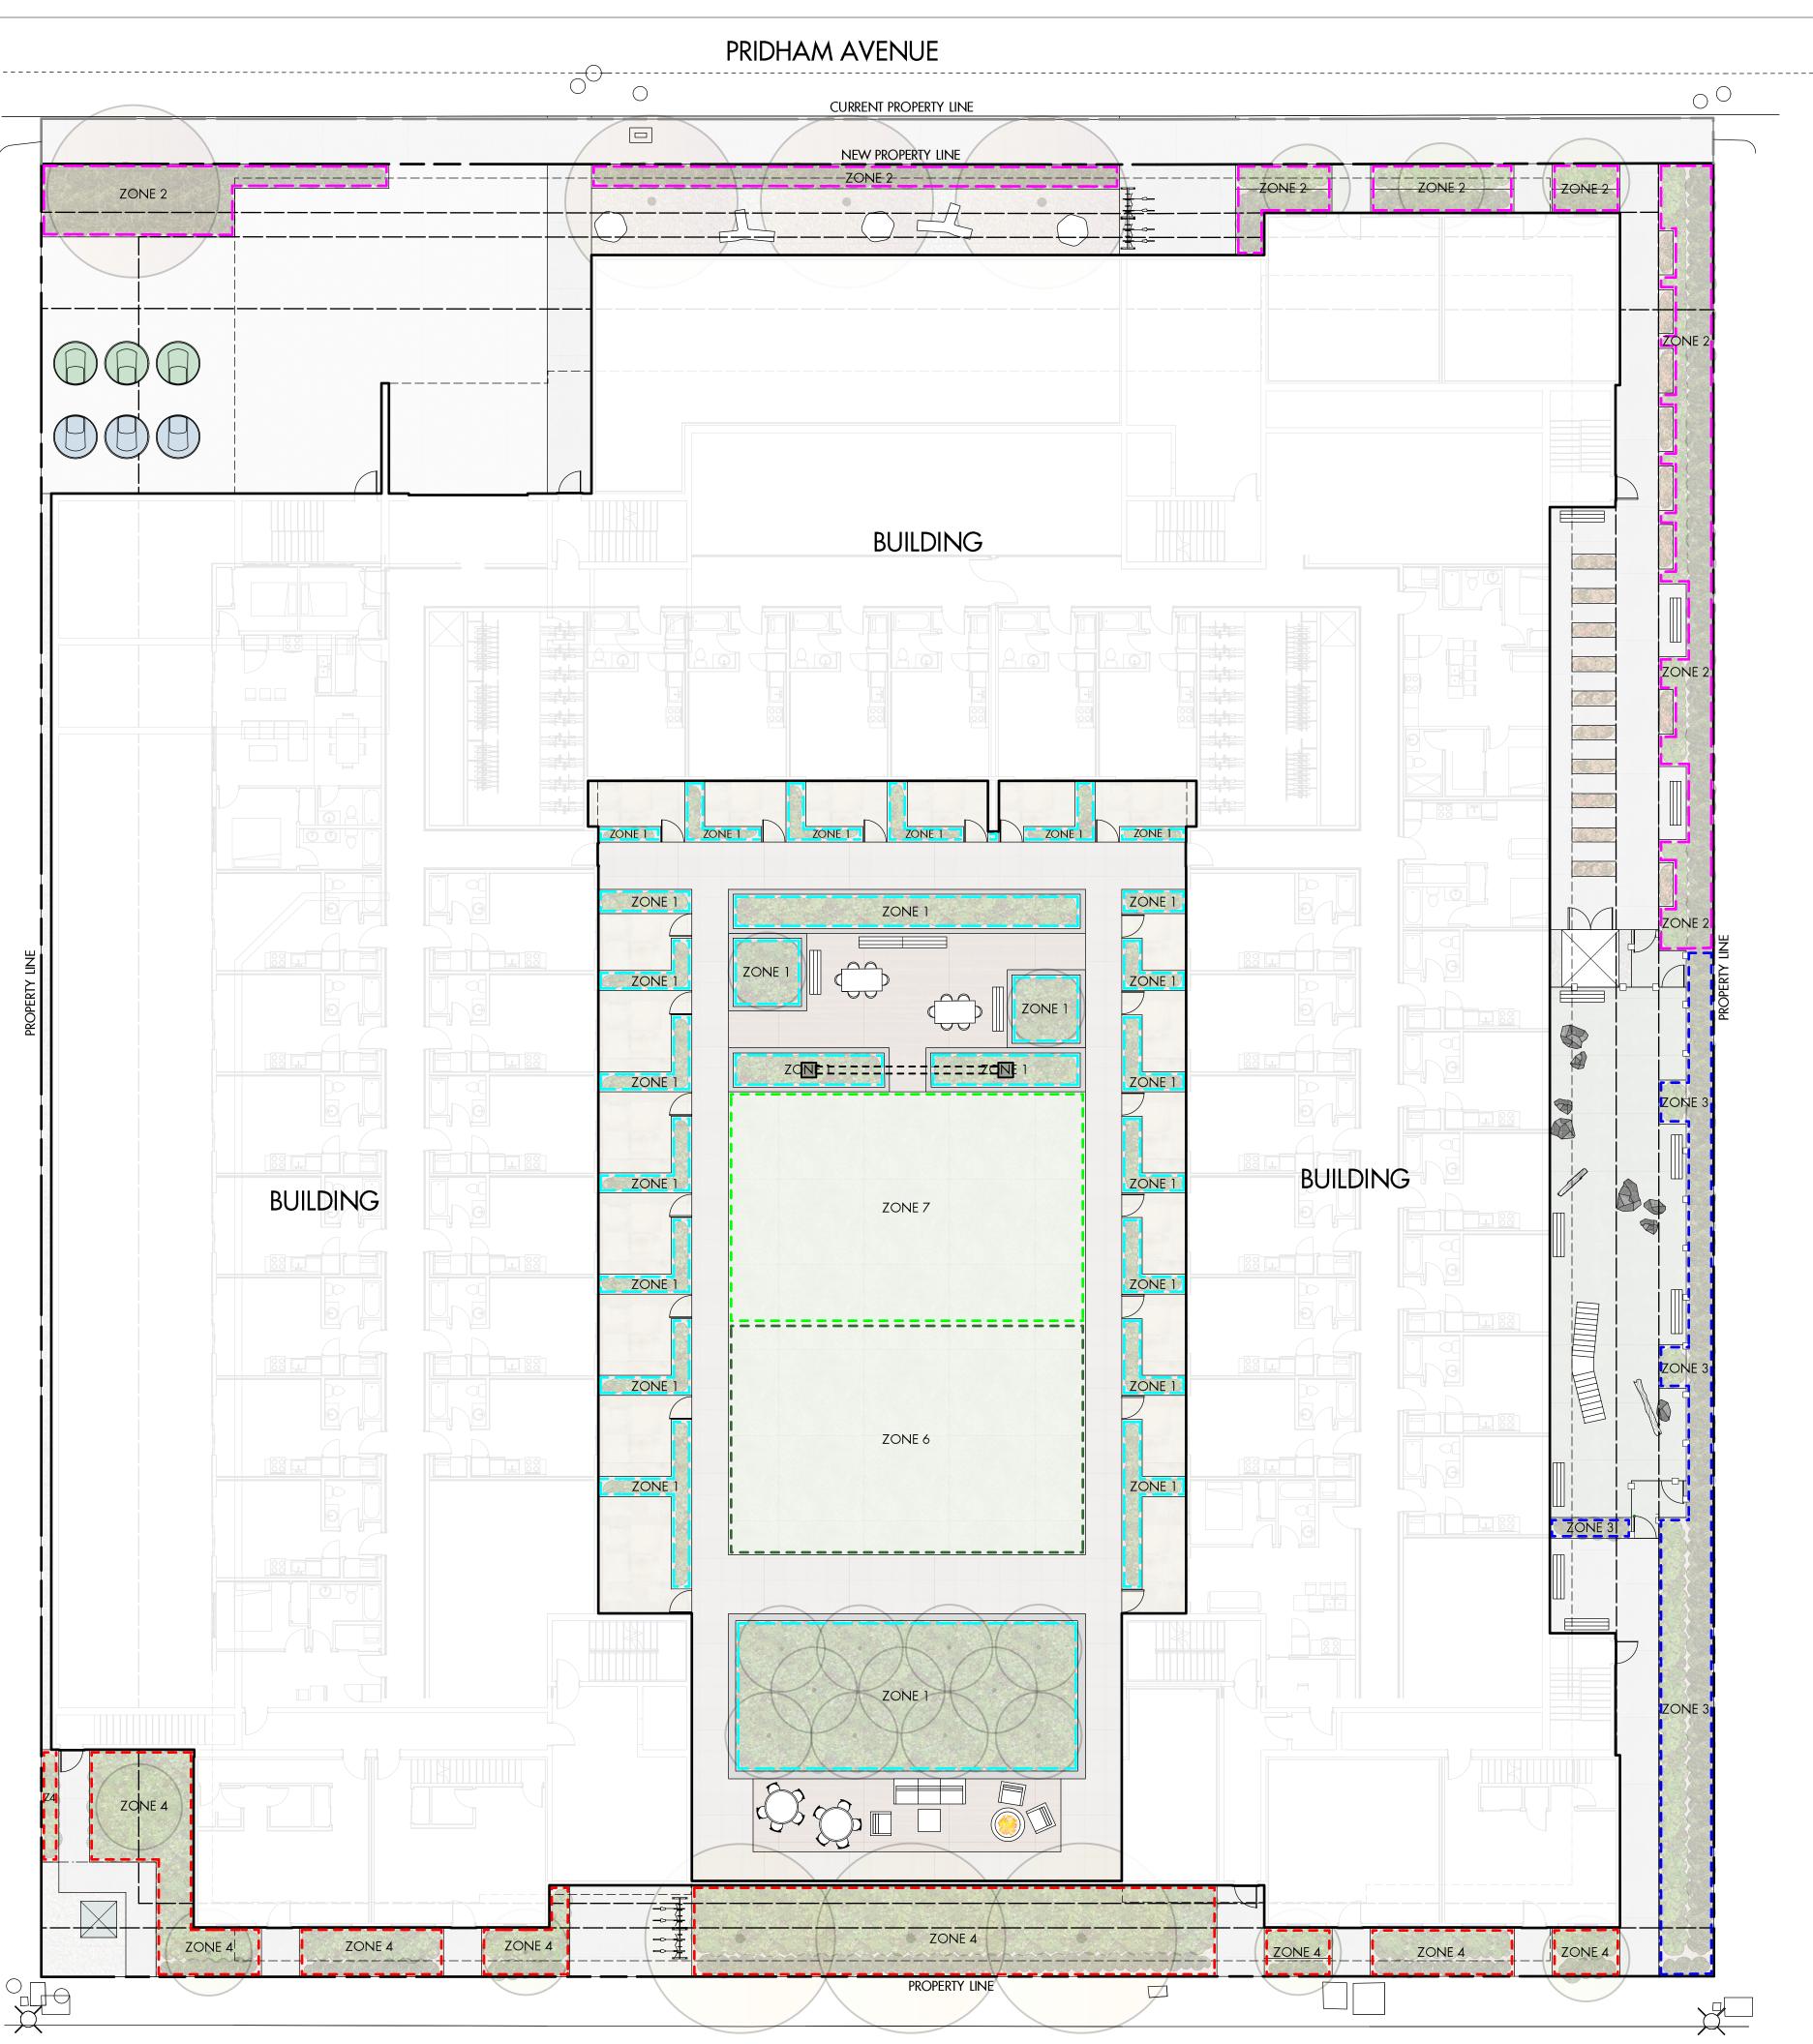

SUTHERLAND AVENUE



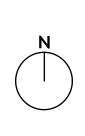

PROJECT TITLE

#### **COLLINSON RISE**

Kelowna, BC

DRAWING TITLE

#### WATER CONSERVATION/ **IRRIGATION PLAN**

#### ISSUED FOR / REVISION

1	23.02.24	Review
2		
3		
4		
5		

project no	22-1201
DESIGN BY	AM
dravvn by	TR
CHECKED BY	AM
DATE	FEB. 24, 2023
SCALE	1:150
PAGE SIZE	24"×36"

SEAL



DRAWING NUMBER

LS-103

#### **ISSUED FOR REVIEW ONLY**

Copyright Reserved. This drawing is the property of Ecora Engineering & Resource Group Ltd. and shall not be reproduced, resold, or tendered without permission.



10

0

- 5

15

20

25 M

#### **IRRIGATION NOTES**

1. IRRIGATION PRODUCTS AND INSTALLATION METHODS SHALL MEET OR EXCEED THE REQUIREMENTS OF THE WATER USE REGULATION BYLAW NO. 10480.

2. THE IRRIGATION SYSTEM SHALL MEET THE REQUIREMENTS, REGULATIONS, AND BYLAWS OF THE WATER PURVEYOR.

3. THE IRRIGATION SYSTEM SHALL BE EQUIPPED WITH AN APPROVED BACKFLOW PREVENTION DEVICE, WATER METER, AND SHUT OFF VALVE LOCATED OUTSIDE THE BUILDING ACCESSIBLE TO THE CITY.

4. An Approved smart controller shall be installed. The irrigation scheduling times shall utilize a maximum et value of 7" / Month (Kelowna July et), taking into consideration soil type, slope, and microclimate.

5. DRIP LINE AND EMITTERS SHALL INCORPORATE TECHNOLOGY TO LIMIT ROOT INTRUSION.

6. IRRIGATION SLEEVES SHALL BE INSTALLED TO ROUTE IRRIGATION LINES UNDER HARD SURFACES AND FEATURES.

7. IRRIGATION PIPE SHALL BE SIZED TO ALLOW FOR A MAXIMUM FLOW OF  $1.5 \mbox{m}$  /Sec.


8. A FLOW SENSOR AND MASTER VALVE SHALL BE CONNECTED TO THE CONTROLLER AND PROGRAMMED TO STOP FLOW TO THE SYSTEM IN CASE OF AN IRRIGATION WATER LEAK.

#### **IRRIGATION LEGEND**

[]]]	ZONE #1: HIGH EFFICIENCY SUBSURFACE DRIP IRRIGATION FOR MODERATE WATER USE PLANTING AREAS TOTAL AREA: 224 sq.m. MICROCLIMATE: SOUTHEAST EXPOSURE, PARTIALLY SHADED BY TREES & BUILDING ESTIMATED ANNUAL WATER USE: 75 cu.m.
[]]]	ZONE #2: HIGH EFFICIENCY SUBSURFACE DRIP IRRIGATION FOR MODERATE WATER USE PLANTING AREAS TOTAL AREA: 136 sq.m. MICROCLIMATE: NORTHEAST EXPOSURE, PARTIALLY SHADED BY TREES & BUILDING ESTIMATED ANNUAL WATER USE: 45 cu.m.
[]]]]	ZONE #3: HIGH EFFICIENCY SUBSURFACE DRIP IRRIGATION FOR MODERATE WATER USE PLANTING AREAS TOTAL AREA: 75 sq.m. MICROCLIMATE: SOUTHEAST EXPOSURE, PARTIALLY SHADED BY TREES & BUILDING ESTIMATED ANNUAL WATER USE: 25 cu.m.
[]]]]	ZONE #4: HIGH EFFICIENCY SUBSURFACE DRIP IRRIGATION FOR MODERATE WATER USE PLANTING AREAS TOTAL AREA: 160 sq.m. MICROCLIMATE: SOUTHWEST EXPOSURE, PARTIALLY SHADED BY TREES & BUILDING ESTIMATED ANNUAL WATER USE: 53 cu.m.
[]]]]	Zone #5: High Efficiency Subsurface DRIP Irrigation for moderate water use Planting Areas Total Area: 203 sq.m. Microclimate: Southeast Exposure, Partially Shaded by Trees Estimated Annual Water USE: 68 cu.m.
[]	ZONE #6: LOW VOLUME POP-UP SPRAYHEADS FOR TURF AREAS TOTAL AREA: 139 sq.m. MICROCLIMATE: SOUTHEAST EXPOSURE, PARTIALLY SHADED BY TREES AND BUILDING ESTIMATED ANNUAL WATER USE: 119 cu.m.
[]]]]	ZONE #7: LOW VOLUME POP-UP SPRAYHEADS FOR TURF AREAS TOTAL AREA: 139 sq.m. MICROCLIMATE: SOUTHEAST EXPOSURE, PARTIALLY SHADED BY TREES AND BUILDING ESTIMATED ANNUAL WATER USE: 119 cu.m.





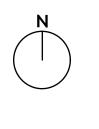

PROJECT TITLE

#### **COLLINSON RISE**

#### Kelowna, BC

DRAWING TITLE

#### WATER CONSERVATION/ IRRIGATION PLAN - ROOF

#### ISSUED FOR / REVISION

1	23.02.24	Review
2		
3		
4		
5		

PROJECT NO	22-1201
design by	AM
dravvn by	TR
CHECKED BY	AM
DATE	FEB. 24, 2023
SCALE	1:150
PAGE SIZE	24"x36"

SEAL



DRAWING NUMBER

LS-104

#### ISSUED FOR REVIEW ONLY

Copyright Reserved. This drawing is the property of Ecora Engineering & Resource Group Ltd. and shall not be reproduced, resold, or tendered without permission.



Friday February 24<sup>th</sup>, 2023

Collinson Rise Millennial Developments Corporation 1100-1631 Dickson Avenue Attn: Ryan Tamblyn Via email to: rtamblyn@millennialdev.ca

Re: Collinson Rise – Preliminary Cost Estimate for Bonding

Dear Ryan:

Please be advised of the following preliminary cost estimate for bonding of the proposed landscape works shown in the **Collinson Rise** conceptual landscape plan dated 23.02.24;

• Landscape Improvements: 2,519 square metres (27,114 square feet) = 265,127.50

This preliminary cost estimate is inclusive of trees, shrubs, turf, artificial turf, hardscape, site furnishings, mulch, topsoil & irrigation.

You will be required to submit a performance bond to the City of Kelowna in the amount of 125% of the preliminary cost estimate. Please do not hesitate to contact me with any questions about the landscape plan.

Best regards,

Fiona Barton, MBCSLA, CSLA *as per* Ecora Engineering & Resource Group Ltd.



April 13, 2023

Ecora File No.: 221201

City of Kelowna Planning Department per Millennial Development Corporation 2755 Tutt Street Kelowna, BC V1Y 0G1

#### Attention: Kimberly Brunet - City of Kelowna Collinson Rise File Manager

#### Reference: Collinson Rise (1255, 1267 & 1277 Pridham Avenue, 1254, 1266 & 1276 Sutherland Avenue) Landscape Zoning Bylaw Deviations Clarifications

Dear Kimberly,

Trees are proposed along the two frontages of the project (Sutherland along the south, and Pridham Avenue along the north) per the standards set by the City of Kelowna Zoning Bylaw 12375 as shown on the plans (LS-101) and outlined in the zoning bylaw summary table.

Growing medium volumes are provided for the trees per the requirements set by the City of Kelowna Zoning Bylaw 12375.

A continuous laterally connected trench of growing medium is provided along the width of the fronting property and within the setback areas. Soil cells are used to provide growing medium underneath all proposed paved areas of different finishes crossing the 2m setback landscape zone.

The growing medium extends, where possible, into areas adjacent to and beyond the 2m setback landscape zone within the private development area, either as open grade medium or contained in soil cells underneath paved surface areas. These areas are figured into the total growing medium volume requirements.

Based on the surface area available, the depth of the growing medium trench varies between 700mm to 1200mm. This satisfies the Canadian Landscape Standards (CLS) minimum depth requirement of growing medium for trees of 600mm.

See sheet LS-103 for an overview of the proposed growing medium distribution and depths.

Sincerely,

Ecora Engineering & Resource Group Ltd.

Achim Muller, AALA, CSLA Creative Director – Landscape Architecture Telephone: 250.300.8750 achim.muller@ecora.ca



1435 Water Street Kelowna, BC V1Y 1J4 250 469-8500 kelowna.ca

#### Landscape Water Conservation Report

#### APPLICANT INFORMATION

Owner	Millennial Developments Corporation	Contractor co. name	Ecora Engineering & Resource Group Ltd.
1255, 1267 & 1277 Pridham Avenue, 1254, Project address 1266 & 1276 Sutherland Avenue		Contractor contact name	Fiona Barton
City	Kelowna	Contractor phone #	250-469-9757
Owner phone #	250-212-6743	Contractor email	fiona.barton@ecora.ca
Owner email	rtamblyn@millennialdev.ca		
Province	BC Postal Code: V1Y 6B3	Preferred contact	Owner 🛛 Contractor 🗖

#### NOTE: ALL 3 PAGES OF THE APPLICATION MUST BE COMPLETED AND SUBMITTED

#### LANDSCAPE AND IRRIGATION CHECKLIST

The Applicant in submitting this application, has adhered to:

- Applicable elctrical standards, plumbing standards, and backflow prevention standards
- Bylaw 7900 Schedule 4 and 5



 $\square$ 

Requirements of Water Regulation Bylaw

Where an exemption is required (e.g. golf course or large school field), contact the Water Smart program directly.

Note that checklists for selecting an irrigation contractor are available through the IIABC or the IA. Below is the link to the IIABC checklist.

https://www.irrigationbc.com/page/selecting-a-contractor

Applicant notes pertaining to the application:

Page 1 of 3



1435 Water Street Kelowna, BC V1Y 1J4 250 469-8500 kelowna.ca

#### Landscape V Conservation F

1255, 1267 & 1277 Pridham Avenue, 1254,

Sutherland Avenue

#### LANDSCAPE WATER USE AREA

Applicant: Millennial Developments Corporation

#### Step 1: Measure Total Landscape Area (LA)

Area of site that will absorb water:

1302 sq.m.

Address:

(over 100 square meters)

Note: Include boulevard, and proposed lawn, plants, mulch, pervious decks or paving stones. Do not include areas that are not pervious such as buildings, pa concrete patios etc.

Step 2: Divide Into Landscape Treatments*		Plant Factor	Irrig Efficiency	Hydrozone Area (Sq.m.)	% of Total LA
Note: each of the areas below are a 'HYDROZONE'		(PF)	(IE)	(HA)	
Unwatered Pervious Areas (	not impervious paving	g)			
Mulch (Stone, bark or sand)		N/A	N/A	116	99
Pervious deck (Spaced wood deck)		N/A	N/A		0%
Pervious paving (ie: AquaPave, Rima	a Pave)	N/A	N/A		0%
Naturalized meadow (wildflowers)		N/A	N/A		0%
Naturalized area (Existing natural a	rea)	N/A	N/A		0%
Other:		N/A	N/A	110	8%
Swimming or ornamental pool		1	1		0%
Watered Planting Beds (shru	bs or groundcover)				
Planting Type	Irrig Efficiency				
Low water use plants	High (Drip or Bubbler)	0.3	0.9		0%
Low water use plants	Moderate (Spray orRotor)	0.3	0.7		0%
Moderate water use plants	High (Drip or Bubbler)	0.5	0.9	798	61%
Moderate water use plants	Moderate (Spray orRotor)	0.5	0.7		0%
High water use plants	High (Drip or Bubbler)	0.7	0.9		0%
High water use plants	Moderate (Spray orRotor)	0.7	0.7		0%
Watered Mown Lawn Areas	Moderate (Spray orRotor)	1	0.7	278	219
Special Landscape Areas (SLA	A)				
Vegetable Garden	High (Drip or Bubbler)	1	0.9		0%
Vegetable Garden	Moderate (Spray orRotor)	1	0.7		0%
Commercial sportsfield turf	Moderate (Spray orRotor)	1	0.7		0%
Rainwater or Recycled Water Use		0.3	1		09
Totals				1302	100%
Special Landscape Area (SLA) Sub to	tal			0	

\*If proposed design conditions are not shown on the form please contact Water Smart 250-469-8502

#### Vater leport

1266
ved driveways,
Estimated Water
(WU)
N/A
0
0
0
266
0
0
0
238
0
0
0
0
504
-

Page 2 of 3



1435 Water Street Kelowna, BC V1Y 1J4 250 469-8500 kelowna.ca

### Landscape Water Conservation Report

Applicant:

Millennial Developments Corpora

Address:

Sutherland Avenue, 1254, 1

#### CALCULATE & COMPARE WATER BUDGET TO ESTIMATED WATER USE

Total Landscape Area	1302	sq.m.
Landscape Water Budget (WB)	781	cu.m./yr.
Estimated Landscape Water Use (WU)	504	cu.m./yr.
Under (-OVER) Budget (Must be under Water Budget WB)	277	cu.m./yr.
	OK	

I confirm by completing the attached Landscape Water Conservation Report, that the project will conform to industry best practices for landscape and irrigation installation in Kelowna. I also acknowledge that the landscape treatments of the project will conform to the Hydrozone areas as identified in the Landscape Area Water Use Area table.

Name of Applicant (person submitting the form)

#### FOR CITY OF KELOWNA OFFICE USE ONLY

The calculations above satisfy the requirements of the Water Regulation Bylaw 10480 Section 4.4.2 and 4.4.3.and the application is hereby APPROVED with the signature of the Water Manager or designate.

Name of Kelowna Water Smart designate For Water Manager Date:

Page 3 of 3

Date:



#### Collinson Rise - Zoning Bylaw 12375 Landscape Summary

Landscaping Standards (7.2)	Zone (MF3)		Proposed		
Min. tree amount	14		14		
Min. deciduous tree caliper	L: 5cm		L: 5cm		
	M: 4cm		M: 4 cm		
	S: 3cm		S: 3cm		
Min. coniferous tree height	250cm		N/A		
Min. ratio between tree size	L: 50% minimum (min.)		L: 50%		
	M: no min. or max.		M: 29%		
	S: 25% maximum (max.)		S: 21%		
Min. growing medium area	75% soil based landscaping		80% soil based landscaping		
Min. growing medium volumes per tree	L: 30 cu.m or 25 cu.m if		L: 30 cu.m & 25 cu.m where		
	connected trench/cluster		connected trench/cluster and		
	M: 20 cu.m or 18 cu.m if		adjacent growing medium on		
	connected trench/cluster		private development site		
	S: 15 cu.m or 12 cu.m if		M: 18 cu.m (soil cells creating		
	connected trench/cluster		trench and adjacent growing		
			medium on private		
			development site)		
			S: 12 cu.m (soil cells creating		
			trench and adjacent growing		
			medium on private		
			development site)		
Landscape graded area (7.2.7)	Max. 1:3 (33%) lawn areas,		Max. 1:3 (33%) lawn areas,		
	Max. 1:2 (50%) planting areas,		Max. 1:2 (50%) planting areas,		
	Min. 1:50 (2%) cross slopes		Min. 1:50 (2%) cross slopes		
Fence Height	1.2m		1.2m		
Riparian management area?	N	y/n	N		
Retention of existing trees on site?	Ν	y/n	N		
Surface parking lot (7.2.10)?	Ν	y/n	Ν		
Refuse & recycle bins screened?	N	y/n	Bins are located within		
			interior room in parkade		
Other:					