Capri Tower 1 1835 Gordon Dr Kelowna, BC











Design Rationale & Zoning Booklet

December 14, 2023 DP0.00

Executive Summary

Application Overview 1.1

GSL Group is pleased to submit to the City of Kelowna a Development Permit application for the site at 1835 Gordon Dr. The site is centrally located and an ideal location to introduce infill density and activate Kelowna's Capri-Landmark.

The proposed redevelopment of 1835 Gordon Dr. will create a compact and central residential development within a short walk to several amenities, parks and the Gordon Dr & Harvey Ave mixed-use corridor.

Zoning: CD26 - Capri Centre and UC2 - Capri-Landmark Urban Centre

The subject site is addressed under CD26 - Capri Centre in Zoning Bylaw 12375 which permits a podium up to 16m height. This scheme proposes two levels of parking podium above grade, and steps back with 3 floors of residential podium on levels 3-5.

Project Description 1.2

The proposal includes one 23-storey tower atop a 5-storey podium that includes above-ground parking and one level of below grade parking. The site redevelopment will not change or influence connectivity patterns, and will retain the existing laneway on the east edge of the site. The development will provide 269 new housing units:

- 6 Town houses,
- 38 Two-bedroom + den apartments,
- 63 Two-bedroom apartments,
- 64 One -bedroom + den apartments,
- 95 One-bedroom apartments, and
- 3 studio apartments.













Figure 1-2: Axonometric View NW Corner

1.3 Project Amenities and Public Realm

Streetscape, Landscape, Public Realm Design

- Trees and plantings maintain appropriate sight lines and circulation
- Corner plaza cutout for engaging the public realm and neighboring projects
- Attractive, engaging, functional on-site open spaces with high quality, durable and contemporary materials, colours, lighting, furniture, and signage (refer to Landscape Plan for details)
- Favourable microclimate includes outdoor spaces with ample sunlight year-round, minimal heat absorption, mix of evergreen and deciduous trees, wind buffering
- Native, durable, drought-tolerant trees for local climate and site conditions
- Stormwater management maintains pre-development flows through water capture and infiltration
- Minimal water use for irrigation
- Trees, shrubs, and plantings maintain appropriate sight lines and circulation
- Low maintenance, sustainable, recycled materials and furnishings
- Exterior lighting is directional, cuts off light pollution, and maintains safety and visibility at night

Building Articulation, Features, and Materials

- Architectural podium cutout to lighten massing at grade
- Unified architectural concept with varied facade treatments
- Architectural character reflects residential use
- Building address is identified through signage
- Durable building design for the local climate and region











Figure 1-3: SE Corner Rendering

2 Location and Context

2.1 Site Description

The site is located in 1835 Gordon Dr SE corner, bounded on the east by Capri St, on the south by Sutherland Avenue, to the north by another site at 1171 Capri St. This block is central to the development of Capri-Landmark Urban Centre, and is a strategic place to accommodate population and economic growth. All sides of the site are experiencing future redevelopment, streetscape improvements, and intensification.

Legal Address:

Plan KAP52246 LOT 1 DISTRICT LOT 137

2.2 Current Site Condition

The current condition of the site is a parking lot that is part of the Capri-Centre Mall, and important hub for many residents in the Capri area, offering key day-to-day services and amenities. Surrounding development ranges from low to mid-rise commercial and residential buildings. Goodlife Fitness and Peter's Independent Grocery is located directly west of the subject site.











Figure 1-4: Site Location


100m Fi



View facing West along Sutherland Ave.with Capri St.



View facing South from surface parking lot

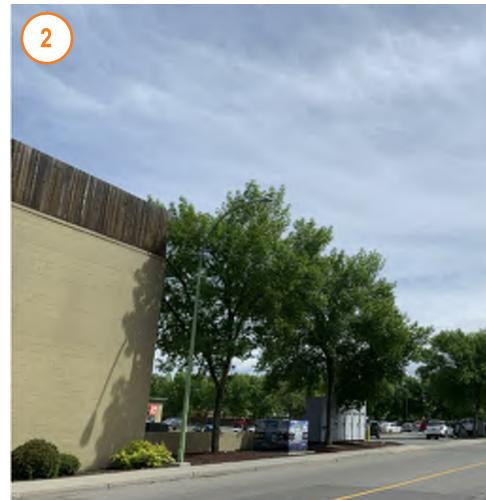

View facing East along Sutherland Avenue



View of the site from the northeast corner of the site, facing southeast onto the current site condition

Figure 1-5: Site Condition Key Map

70m



View facing East from the surface parking lot.

View of the current site condition - surface parking lot and lowrise commercial spaces from the south edge of the site facing north

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2.3 Surrounding Land Uses

The subject site is surrounded by commercial uses to the north and west, and residential uses to the east. The Capri-Centre Mall provides key amenities to the area's residents including a fitness centre, a pharmacy, and banking services. It is the peak mix of uses and heights, as it transitions down to low-rise residential to the east and low-rise commercial and mixed uses to the south.

Between the Landmark District and the Capri-Centre Mall, the lands consist primarily of multi-unit residential developments. The lands fronting Sutherland Avenue and Pacific Court are dominated by three- and four-storey apartment buildings with a mix of surface and covered parking.

The OCP aims to transform Capri-Landmark into a vibrant live-work urban centre, to acieve it the number of people living in the urban centre will need to be increased substantially to rebalance the residential and employment densities. That will require shifting much of the Landmark District's land from varied low-density commercial uses to mixed-use residential buildings and apartment housing.

2.4 Connectivity Network

The Capri-Landmark road network is underdeveloped and suffers from limited internal and external road connections. Within the Landmark area the transportation network was not designed to accommodate high-density office development, resulting in high levels of congestion during the morning and afternoon as commuters leave the area.

The active transportation network in Capri-Landmark is focused along Sutherland Avenue, which connects the urban centre to the Rails-with-Trails cycling corridor via a pedestrian bridge across Highway 97. Additional active transportation corridor (ATC) work is planned in the coming years, eventually resulting in the completion of corridors along Sutherland Avenue and Burtch Road.

The OCP envisions road network improvements to strengthen the road network, increasing connectivity and redundancy within the urban centre. Providing more opportunities to travel east-west within the urban centre for pedestrians, cyclists, transit users, and drivers. Making active modes of transportation a safe and convenient option.










ec008c

Legend

Open Space / Park UC - Urban Centre Education / Institutional RCOM - Regional Commercial Corridor C-NHD Core Area Neighbourhood R-AGR Rural - Agricultural & Resourse Subject Site 400m Radius (approx 5. minute walk)

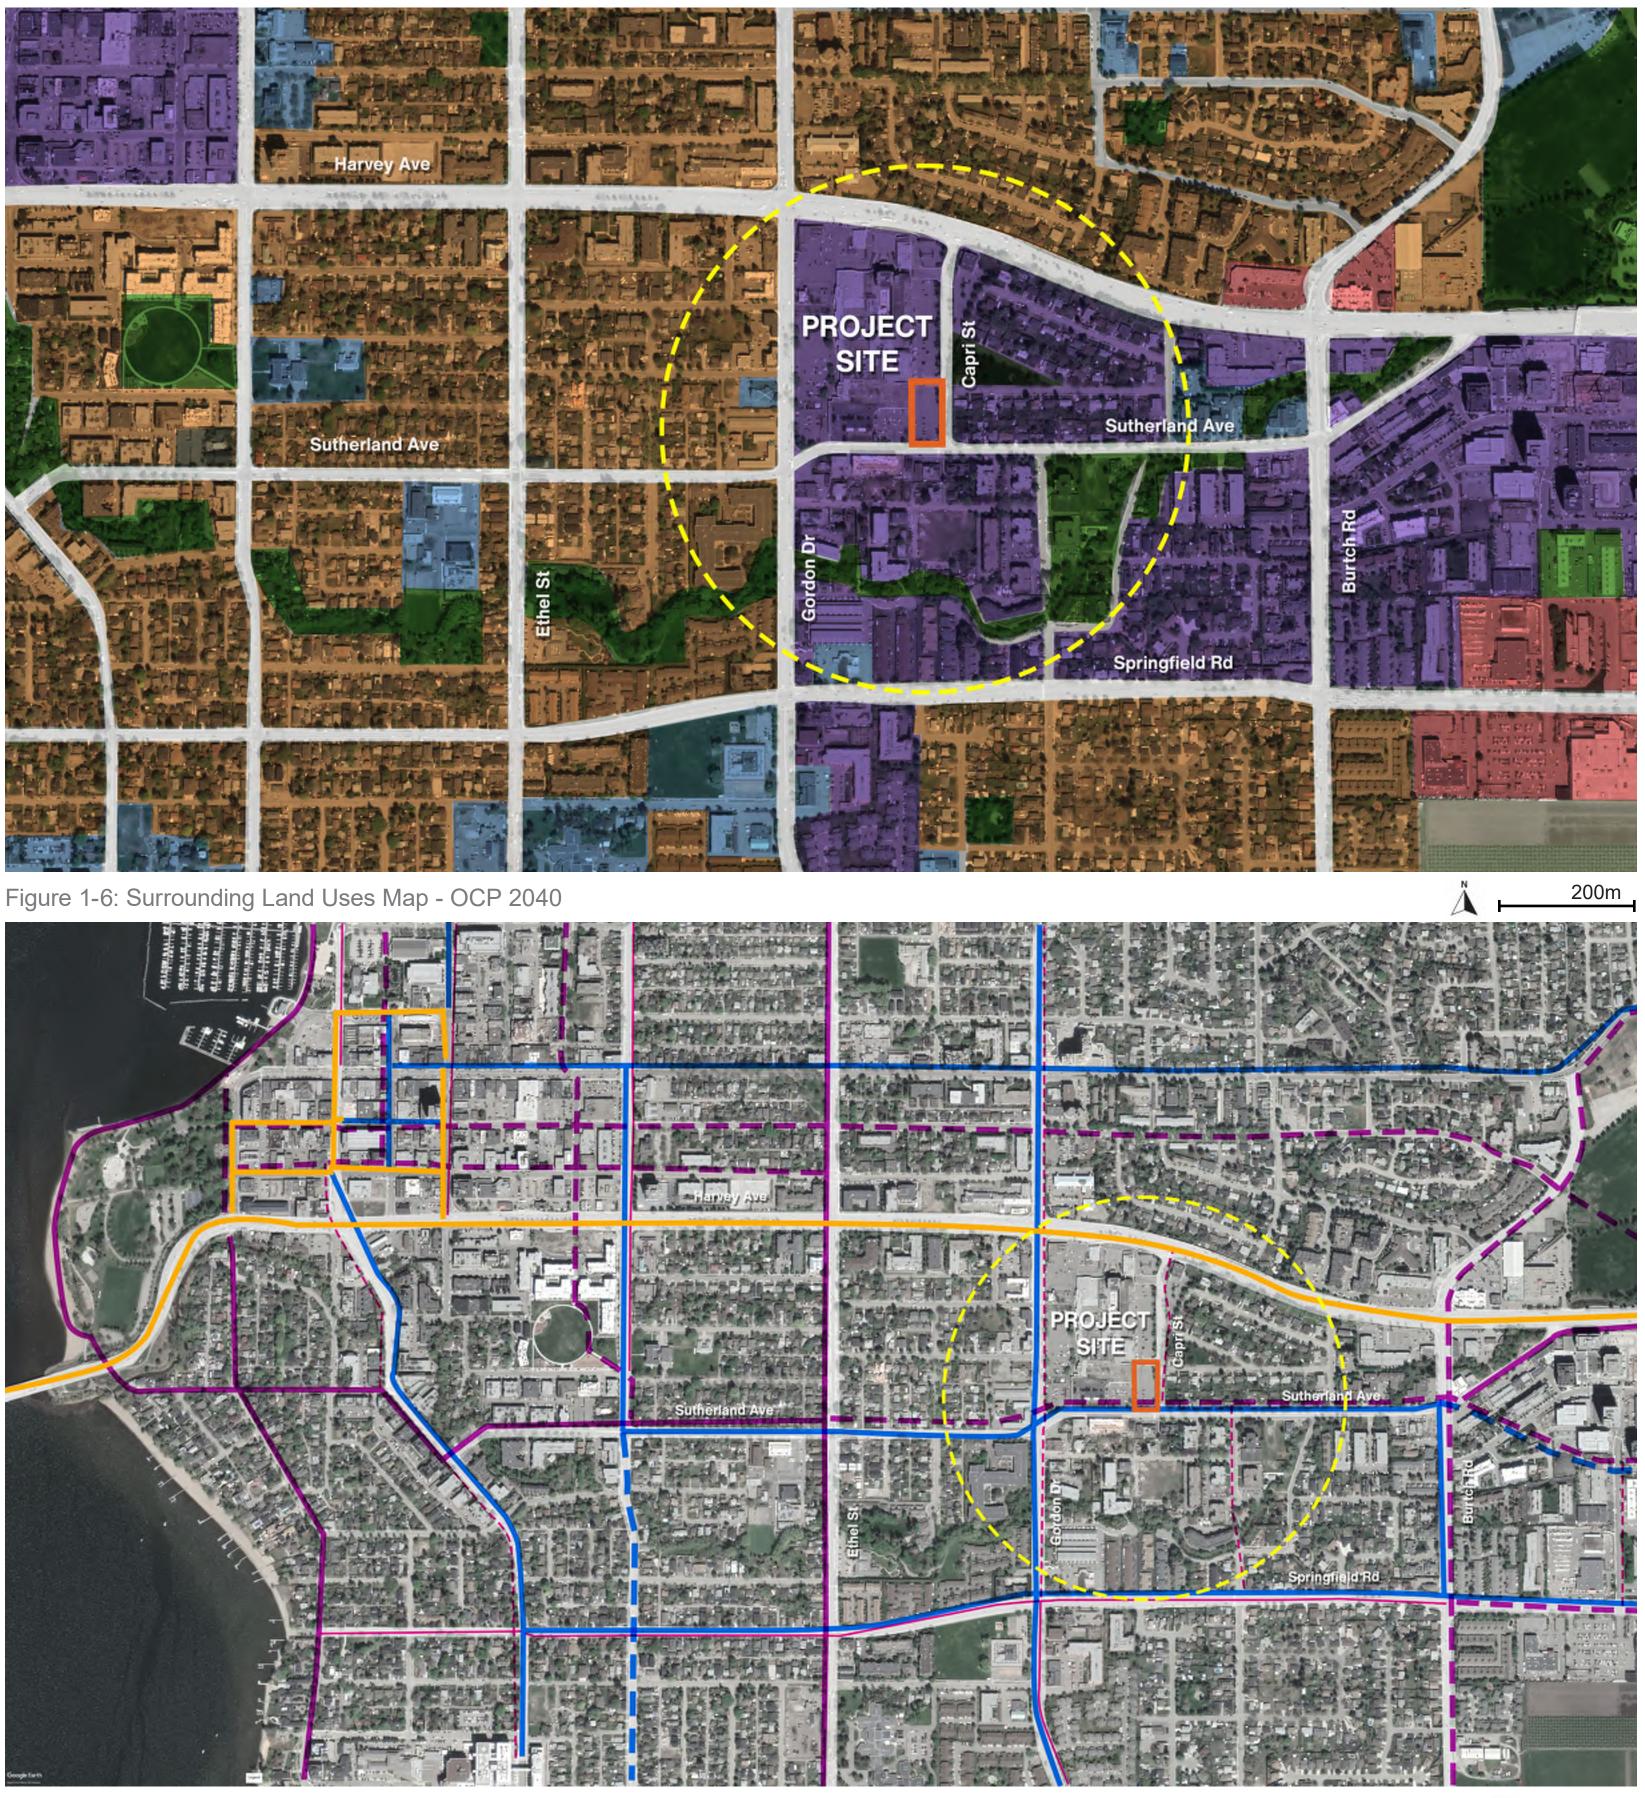

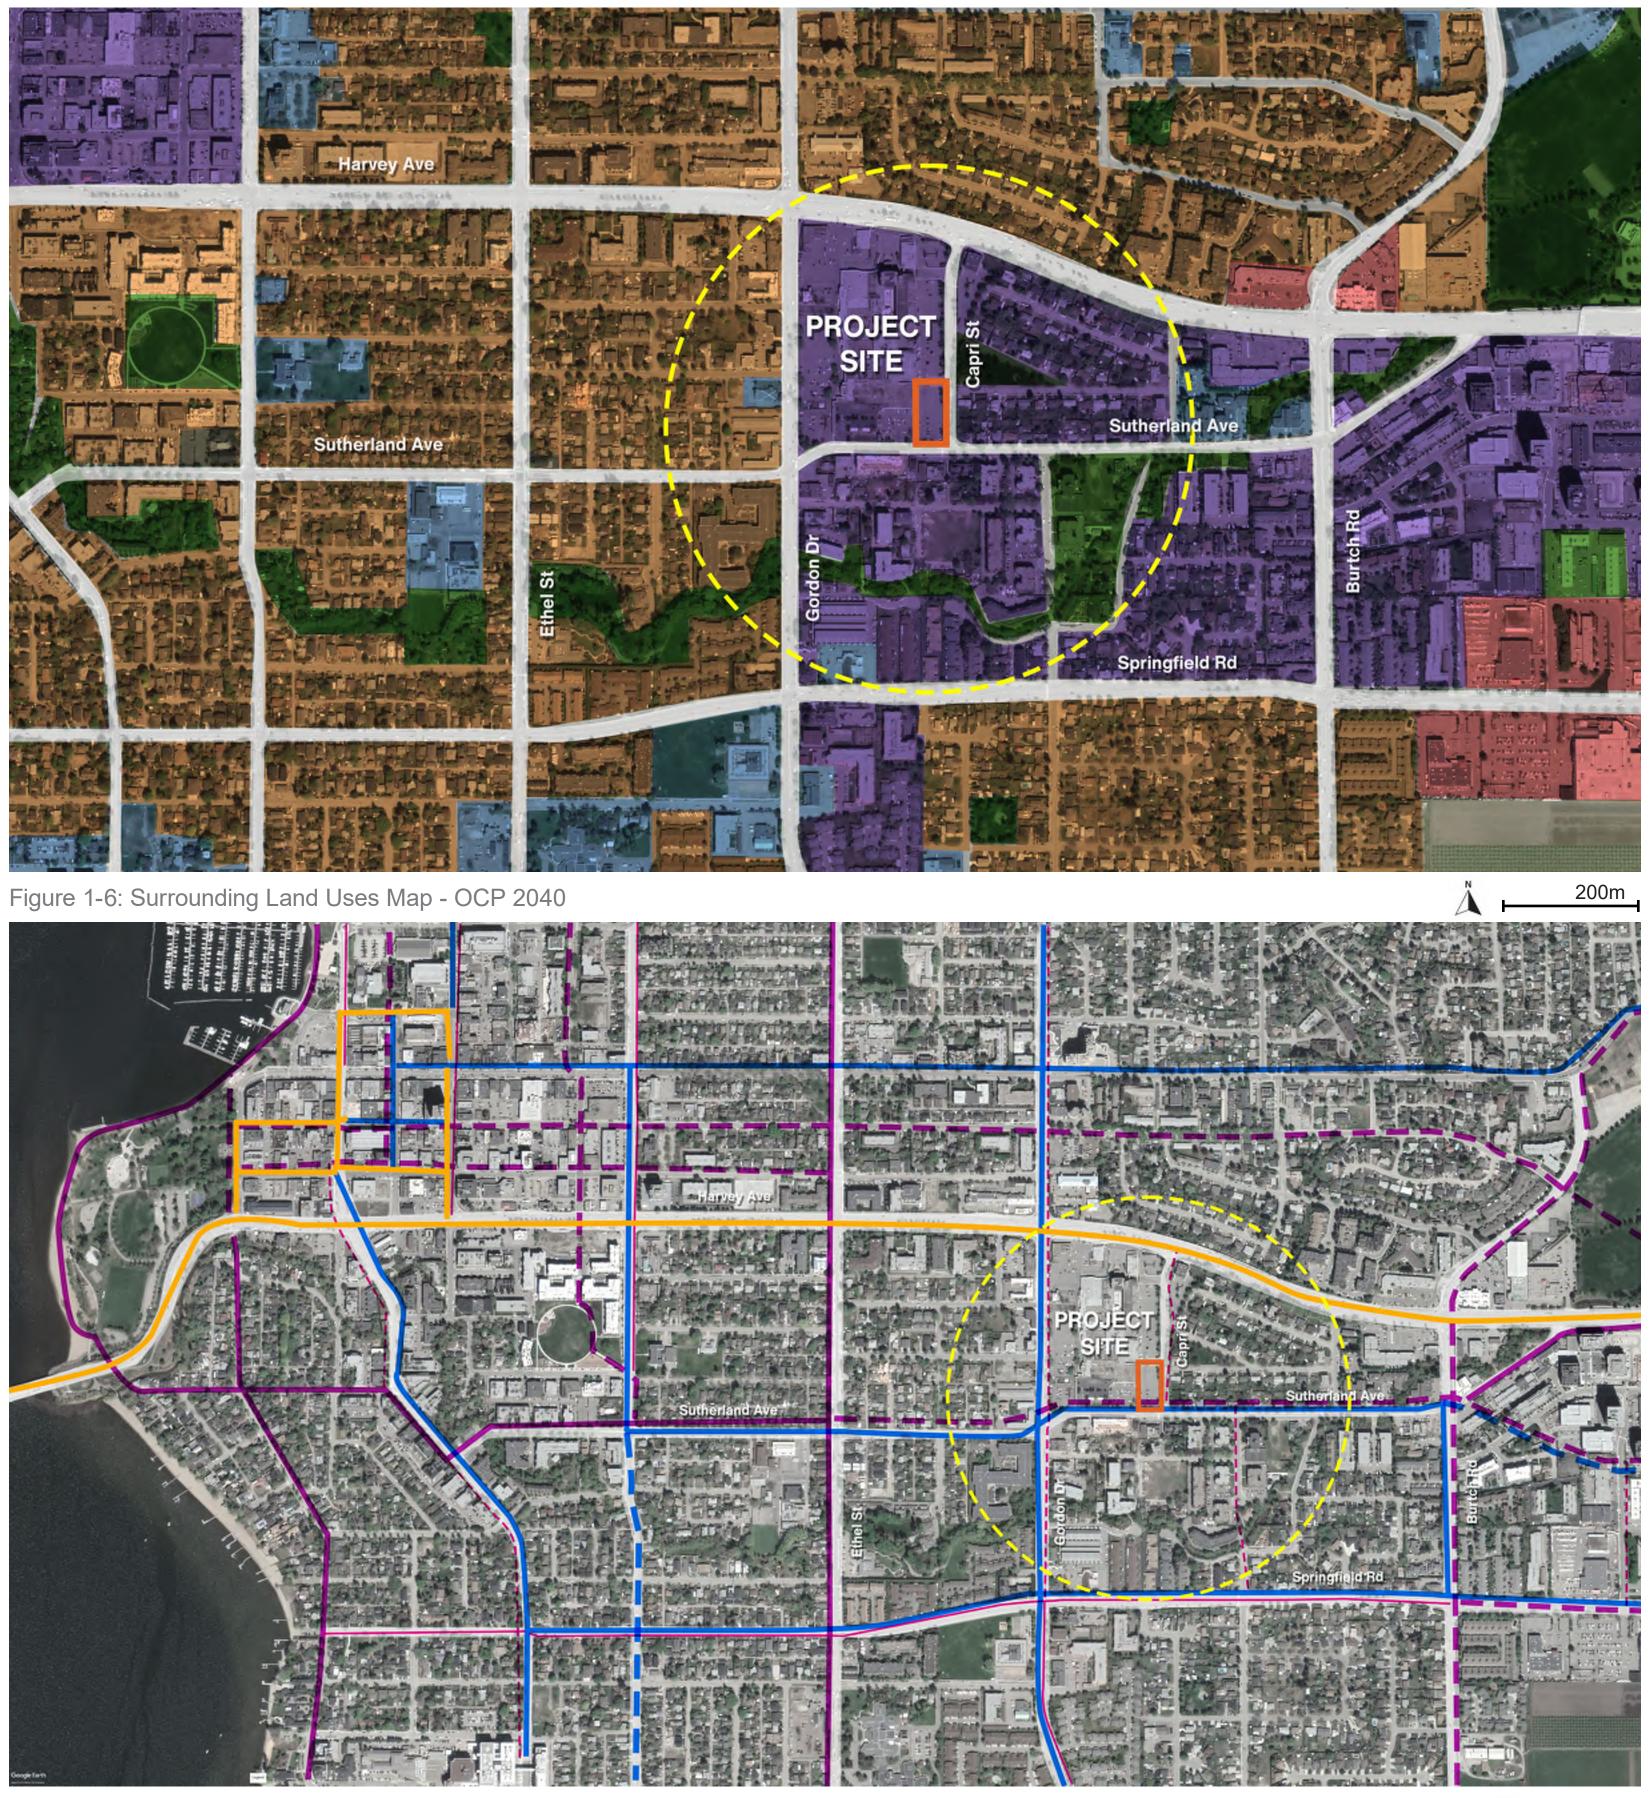


Figure 1-7: Connectivity Network Map - OCP 2040

Legend

	Rapid Transit
	Frequent Transit Network
-	Future Frequent Transit Netwo
	Bike - Existing Primary
-	Bike - Future Primary
	Bike - Existing Secondary
	Bike - Future Secondary
	Subject Site
	400m Radius
_	(approx. 5-minute walk)

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200m

2.5 Surrounding Building Heights

The area surrounding 1835 Gordon Dr currently has a mix of low and medium height buildings. Additional building heights will be supported in key areas of the urban centre to achieve the proposed densities and build out for Capri-Landmark.

The OCP objective is to respect the hierarchy of building height citywide and gradually reduce maximum building heights from 26 storeys in the Capri Centre to 18 storeys in the Landmark District.

Local Amenities 2.6

The Capri-Centre Mall provides key amenities like fitness centre, a pharmacy, and banking services to the area. Several creeks run through the area. For example, Mill Creek, one of Okanagan Lake's main tributaries. Also, other smaller watercourses connect to Mill Creek, including Ritchie Brook.


Two parks are located within the Capri-Landmark urban centre: Pacific Park, which is host to a successful community garden, and Mary Ann Collinson Memorial park. Both parks contain play structures and open green spaces. No community centres, plazas, or public squares are currently located within Capri-Landmark, but Parkinson Recreation Centre is located just north of the Landmark District across Harvey Avenue.










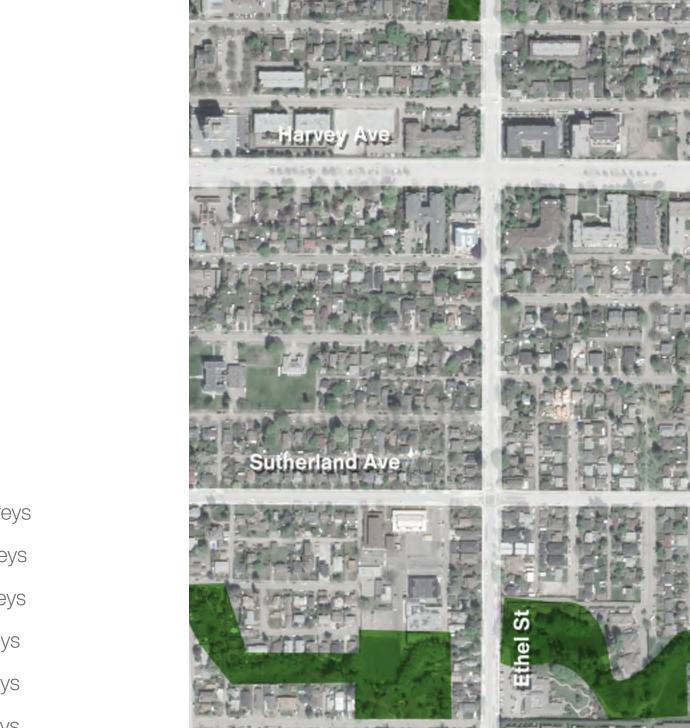


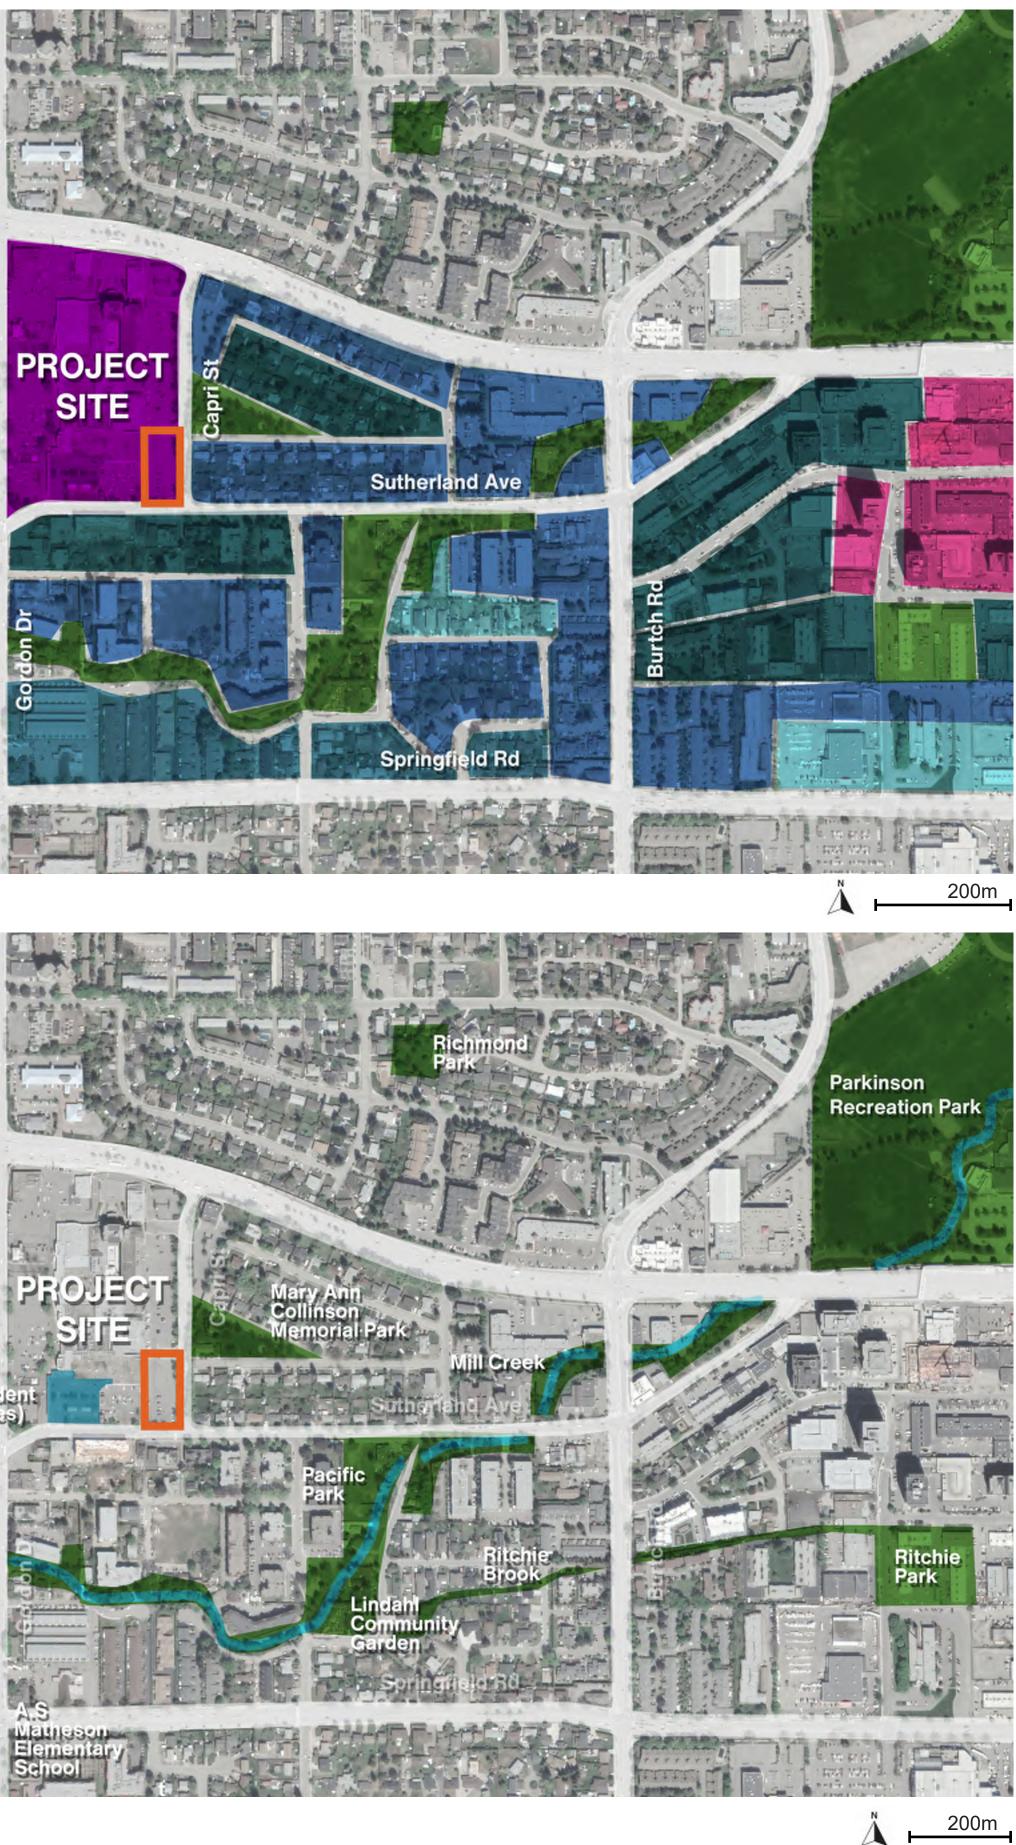

Legend

26 storeys 18 storeys 12 storeys 6 storeys 4 storeys 3 storeys Park Subject Site



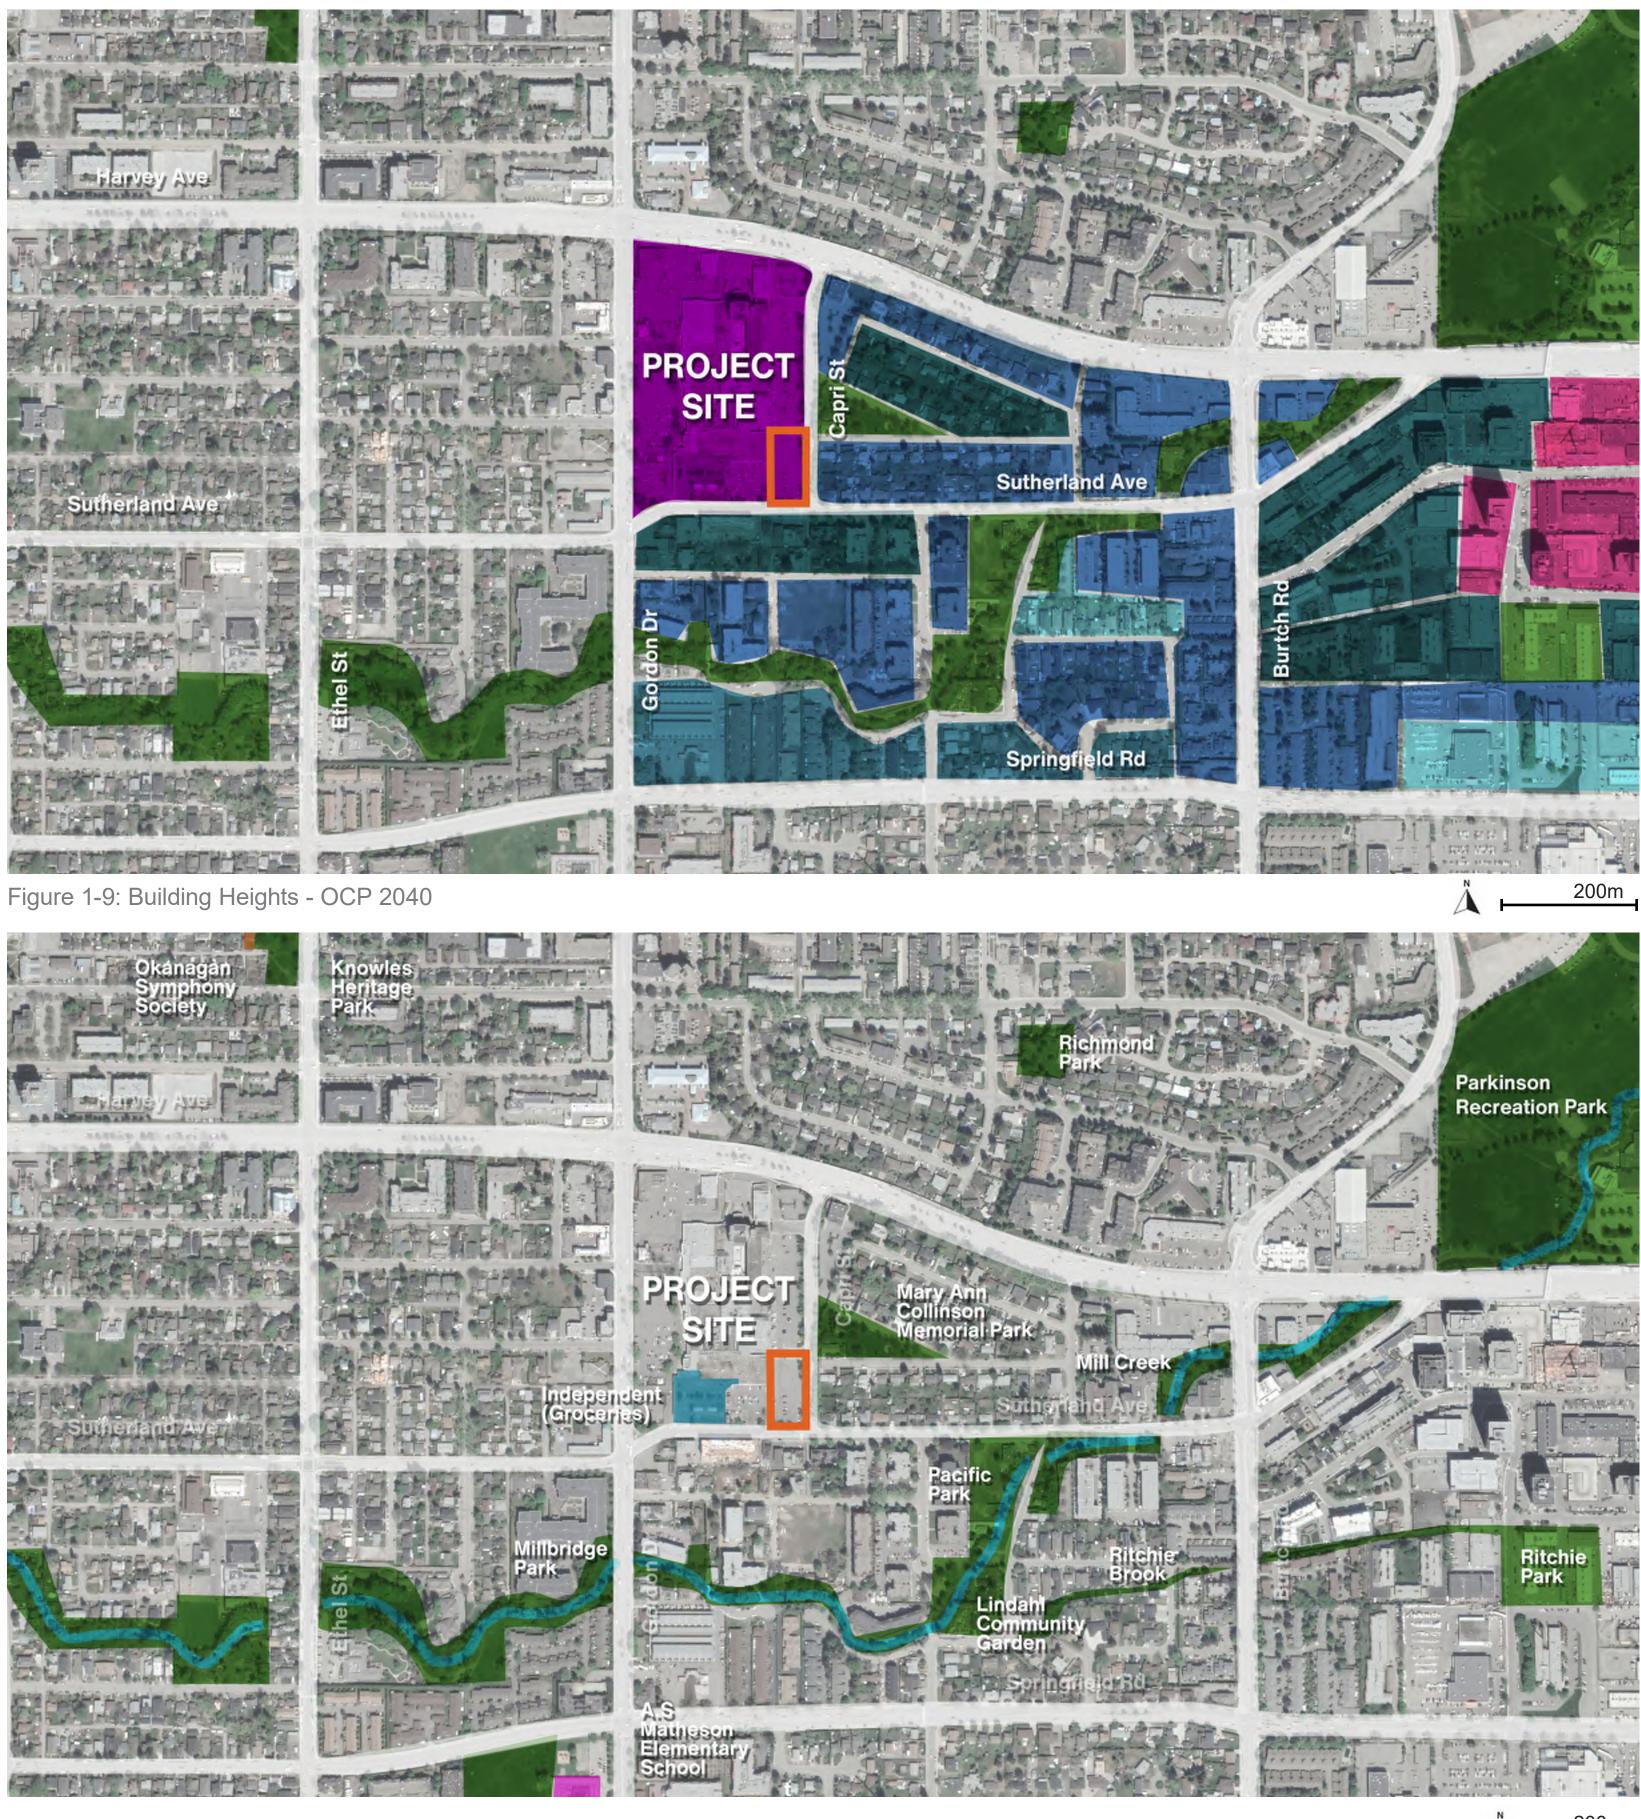

Legend

Parks

Cultural Amenities

Groceries

Schools


Figure 1-8: Local Amenities

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2.7 Compact Communities

Intensifying urban development patterns is the most efficient way to responsibly use land, accommodate regional growth, mitigate the impacts of climate change, and foster a high quality of life in Urban Centres.



Social Benefits:

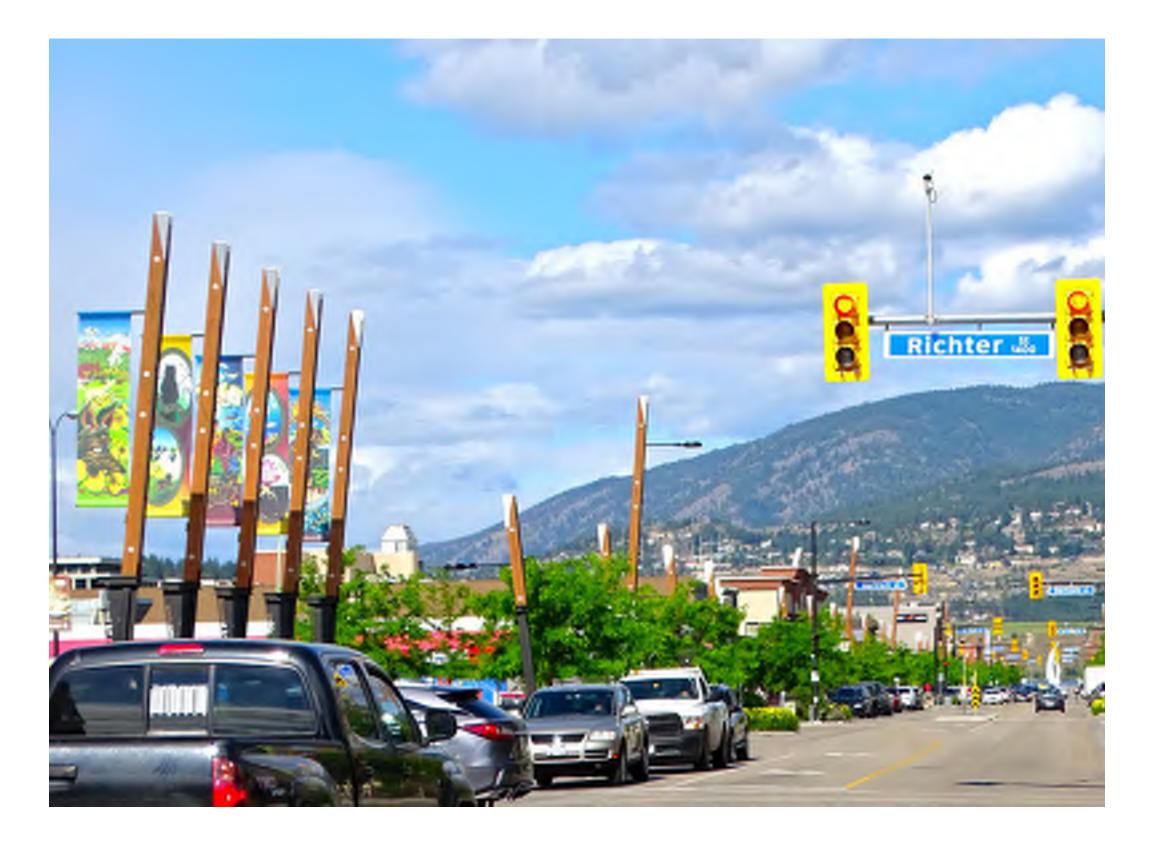- A concentrated tax base provides new or renewed services to the area, benefiting all residents.
- Social networks and gathering places including parks, trails, cafes, community services - are within walking distance for more people.
- A smaller development footprint allows for larger, more open common outdoor spaces.











Environmental Benefits:

- Opportunity for lower emissions, energy-efficient buildings allow for a smaller ecological footprint for residents.
- Reduced reliance on carbon-emitting individual cars due to increased walkability in a compact neighbourhood.
- Local businesses gain customers in their community.
- Urban sprawl is curbed, protecting valuable ALR land and regenerating brownfield or infill sites.

Economic Benefits:



• Increases investment value of urban infrastructure, serving more people with less hardscape and servicing costs.

• Makes efficient use of the transit network by concentrating housing and jobs along transit routes.

• Smaller development footprint shared among more residents results in lower housing costs, providing attainable affordable housing for more households.

Policy Context 3

Official Plan 3.1

Kelowna 2040 Official Community Plan

In January 2022, Kelowna's 2040 Official Plan was adopted. This plan is designed for the growth scenario for 2040, which will see a projected 25,000 new units built in the city in the next two decades. Of that growth, 15% is intended for the Capri Landmark Urban Centre Area, with 76% expected to be multi-unit housing development.

The plan outlines the role of Urban Centres as the activity hubs characterized by the largest concentration of commercial uses, cultural services, and mix of high density residential development with a high quality public realm.

Per this plan, the site is located within the Capri Landmark Urban Centre. It is also subject to the Form and Character Development Permit Guidelines - Comprehensive Development Zone 26.

Response to OCP Policies

1835 Gordon Dr. is a forward-thinking proposal that responds to the future intentions and objectives of the 2040 Plan. The intensification of residential and commercial uses in this area is supported by the direction for Urban Centres in the new Official Plan.

Capri Street and Sutherland Ave are both designated "Mixed streets" in the Capri Landmark street character plan, but given the commercial focus at Gordon Drive and Harvey Avenue and the surrounding residential uses, these streets are proposed as having a strong residential quality though ground oriented town houses.


Given the direction in the 2040 Plan, the proposal for 1835 Gordon Dr. has a 23 storeys (up to 70 m) Tower and a 5 storey podium. The site also offers enhanced streetscaping, access to transit, and has a slender tower shape to mitigate view impacts and shadowing.









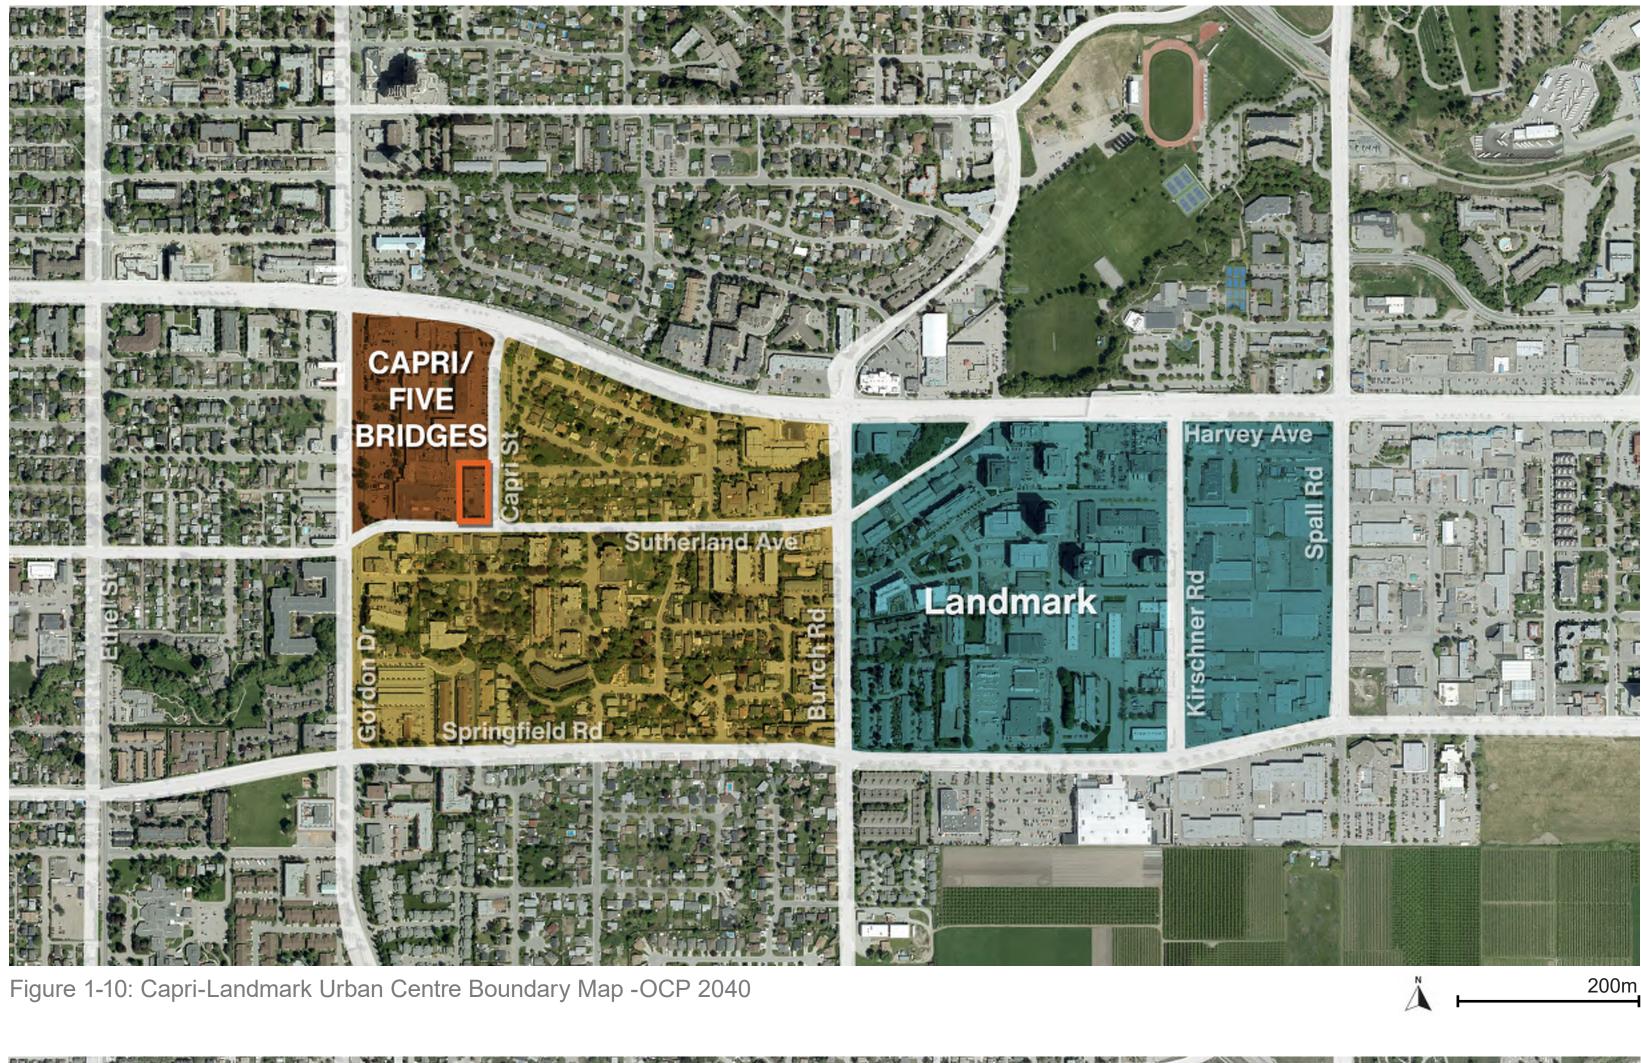

Legend



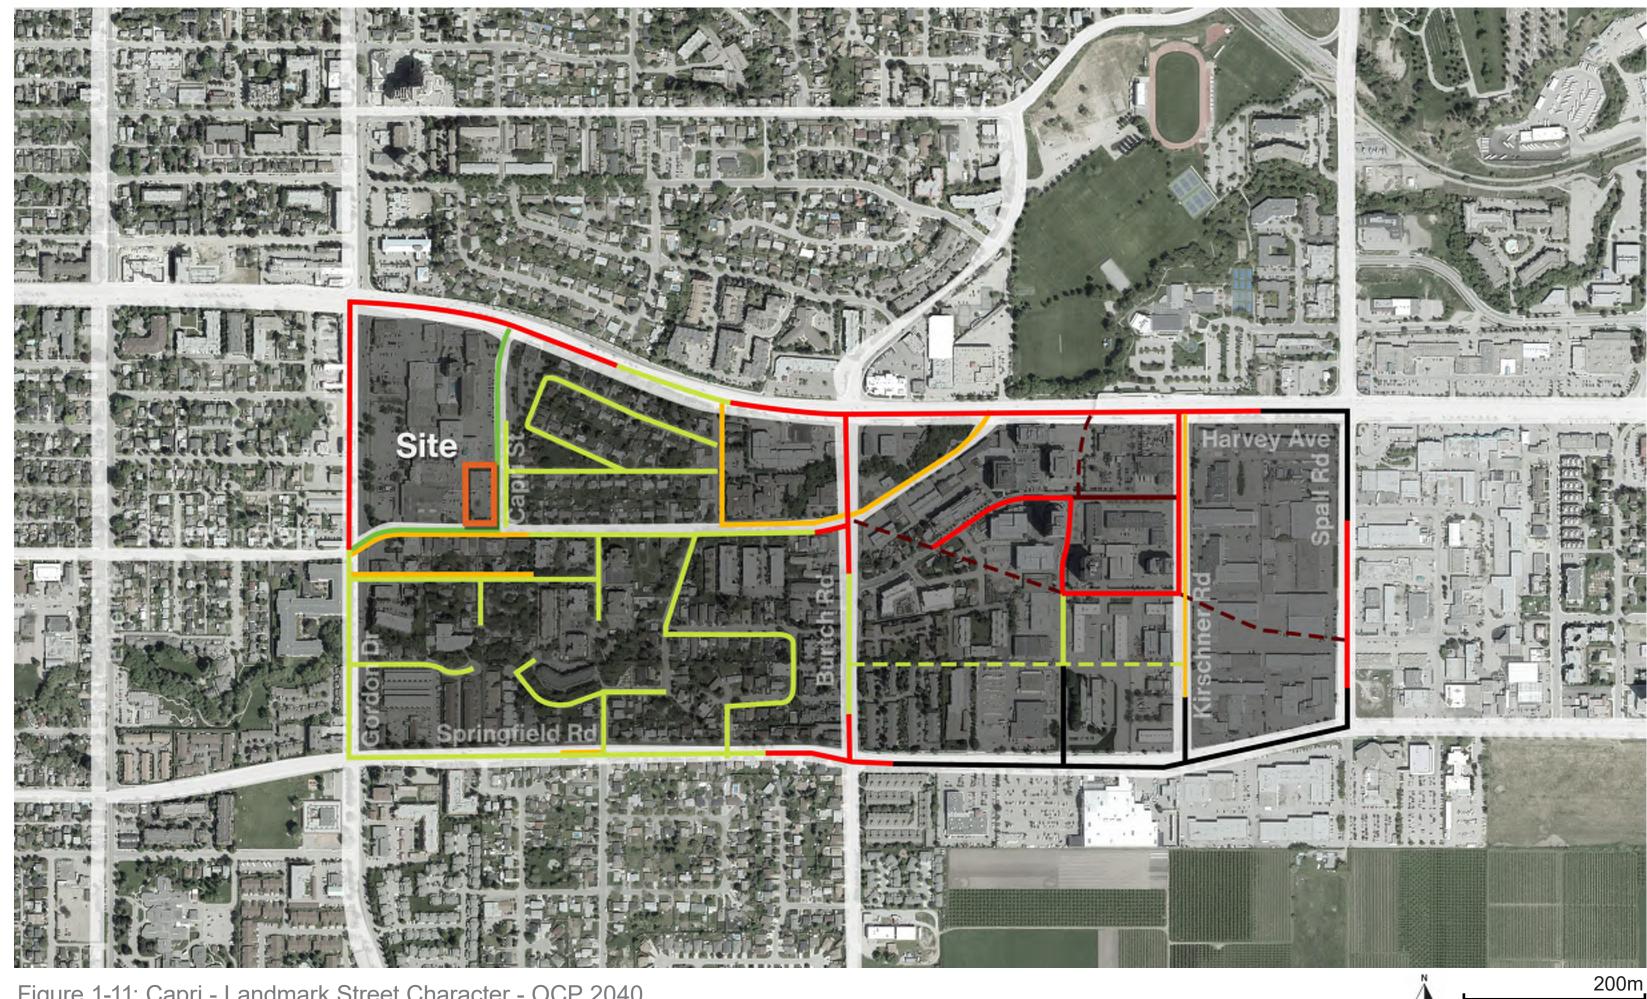


Figure 1-11: Capri - Landmark Street Character - OCP 2040

Legend



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3.2 Form & Character Guidelines

1835 Gordon Dr. falls under Kelowna's "Form and Character Development Permit Area." The 2040 OCP provides details about the foundations and guidelines for this area to ensure high quality urban design in buildings, streets, and open spaces. The Capri Centre area would have a "Residential Focus" character, but in all cases commercial uses are permitted as part of a mixed-use development, but given the commercial focus at Gordon Drive and Harvey Avenue and the surrounding residential uses, this character area is envisioned as having a strong residential quality. The Form and Character foundations are:

1. Continuous street tree planting and landscaped boulevards should characterize the public realm

2. Additional landscape areas between the sidewalk and building faces shall be provided

5. The majority of space in this area will be for residential uses including street-level "townhouse" style housing and condominium use in podium and tower forms. Allowance for small-scale neighbourhood serving retail along Sutherland Avenue is acceptable

6. All buildings should emphasize a high level of transparency at ground level

7. Weather protection shall be provided along the face of buildings where retail is present

8. Buildings should be oriented towards the street

9. Smaller-scaled figurative elements shall be used at lower-levels to break up the massing of the building

10. Rooftop spaces of podium elements (less than 14 storeys) shall not be left bare but should be utilized as amenity space for residents of each building or should incorporate a green roof

11. Landscape design in this area should employ a narrow range of species in order to unify the character area as a whole.

The concept for 1835 Gordon Dr. implements the guidelines for High-rise Residential & Mixed Use.

- Minimum 4.5m first floor height
- Transparent ground-floor frontages









- Minimized shadow and view impacts
- Comfortable, human-scaled pedestrian experience
- Balanced blocks and skyline
- Privacy for residents
- A healthy, successful row of street trees
- Logical and cohesive streetscape portable, human-scaled pedestrian experience

- Structured parking located away from street frontages
- Parking screened to mitigate visual impact
- Podium frames street
- Slender, simple tower form to maximize sunlight to street
- Cohesive, balanced built form and architecture
- Distinct podium, tower, and top
- Break-up podium mass with facade articulation
- Corner plaza

By implementing the Form and Character Development Permit Area guidelines, the relationship between the building, the street, and the public realm improve. The results will be:

Relationship to Street


- Clear zones of activity along the surrounding sidewalks for frontages, pedestrians, plantings, and street edges
- Building entrances that are clearly defined and easy to find
- Weather protection

Scale and Massing, Site Planning

Private Open Spaces

- Maximize access to sunlight
- Minimize noise, smell and/or visual impacts from site servicing or mechanical equipment
- Provide seating, lighting, trees, shade structures, and weather protection.



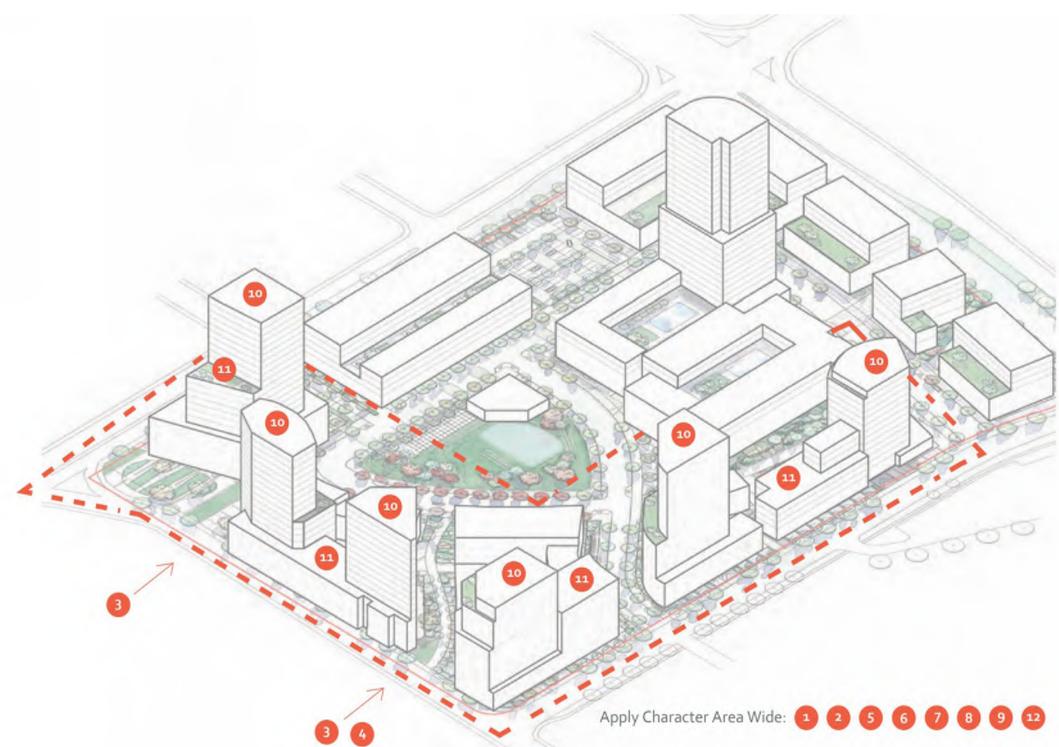

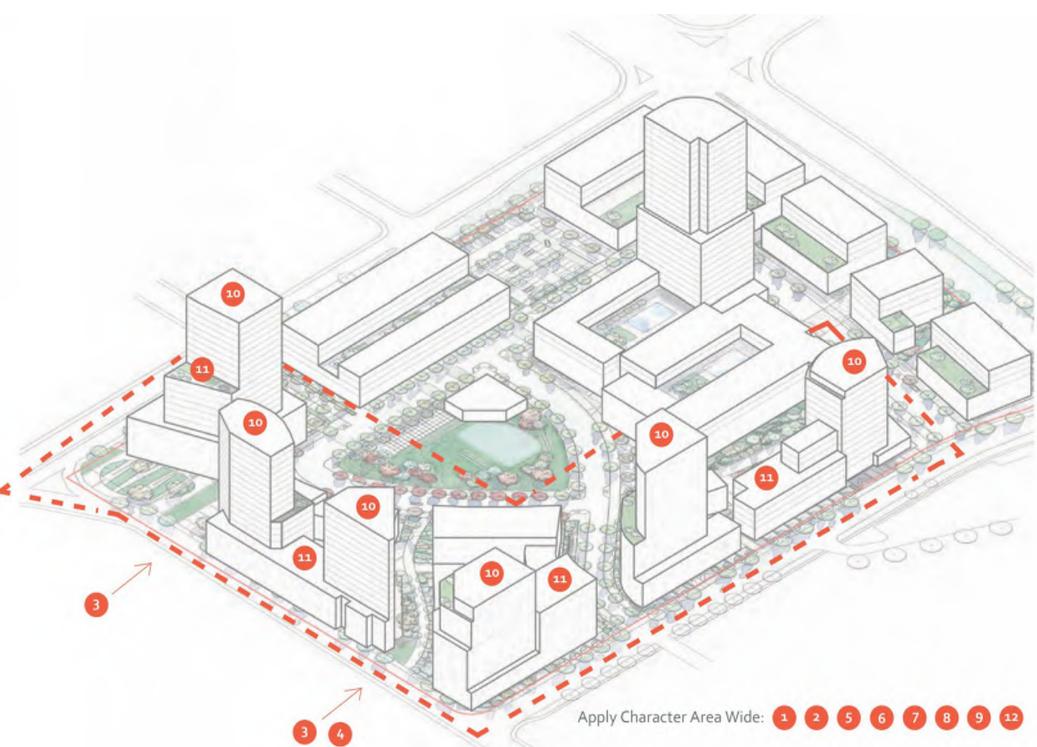


Figure 1-12: Capri Centre Concept Plan - Comprehensive Zone 26 - OCP 2040

Figure 1-13: Capri Centre Concept 3d - Comprehensive Zone 26 - OCP 2040

3.4 Response to Zoning By-law

Zoning Bylaw No.: 12375 (2022)/8000 (2014)

A site wide rezoning was completed and adopted by the City of Kelowna in 2016: CD25 - Capri Centre Comprehensive Development Zone.

In September 2022, the City of Kelowna adopted Zoning Bylaw 12375 which included a revised CD26 Capri Centre Zoning.

As this project was in development prior to adoption of the new Zoning Bylaw a summary of both Section 14 (UC2), Section 15.7 CD 26 and CD25 is provided to clairfy the zonings requirements negotiated with planning staff.

	Legend		
Zoning		Superseded by CD26	
Bylaw		Section Name Parking and Loading	Reg Residential Visitor
CD25			Commercial Hotel Commercial Uses, excluding reta
		Purpose	Grocery store exceeding 1,858m 15.1.1 The purpose is to provide on a specific site within the City inadequate, having regard to exi public.
		15.7.1 - Zone Purpose	The purpose is to provide the fra stages, over time, with a mixture
		14.7.2 Sub-Zone Purpose 15.7.3 Permitted land Uses 15.7.4 Subdivision Regulations	N/A Refer to bylaw, long list Minimum lot width Minimum lot depth Minimum lot area
		15.7.5 Development Regulations	Maximum FAR Maximum height
Section 15.7: CD26	15.1		Maximum site coverage - all buil Maximum site coverage building Minimum commercial areas Minimum common & private am
			Minimum public open space Minimum balconies Minimum & maximum commerc
			Tall Buildings Minimum setbacks
		Categories Purpose	UC2-Capri-Landmark Urban Cent The purpose is to provide a mixe
			Centre that is consistent with an
		Land Uses - UC2 Subdivision Regulation (UC2)	Refer to Policy 15.7.3 CD26 Perm Minimum lot width Minimum lot depth Minimum lot area Maximum site coverage Maximum site coverage building Maximum density/height Minimum front yard & flanking s
Section 14:	14.11	Commercial and Urban Centre Zone Redevelopment Regulations (UC2)	Minimum front yard & flanking s Minimum front yard & flanking s Minimum building stepback from Minimum side yard setback Minimum rear yard setback
UC2			Minimum common & private am Minimum accessory building or s
			Upper floor setbacks Corner lot
			Urban plaza
			Tall buildings Minimum/ maximum commercia

Figure 1-16: Summary of Policy Analysis









13.0m 30.0m 460m² 2.6 FAR Height requirements are as indicated in figure 15.7.5 and as described as below: (a) In the area located within 40 m of the lot line abutting Harvey Avenue and in all areas east of Capri Street the maximum height of all buildings and structures shall be 6 storeys or 22 (b) As described in the area located beyond 40 m of Harvey Avenue the maximum height of all buildings and structures shall be 22 storeys or 70 meters except one building or structure shall be a maximum of 26 storeys or 82 m. 75% uildings ngs, structures, impermeable surfaces 100% 18,581m²(2000,000ft²) net floor area 6.0m² per bachelor dwelling unit imenity space 10.m² per 1 bedroom dwelling unit 15.0m² per dwelling unit with more than 1 bedroom 1.5 Acres of public accessible open space shall be provided A minimum of 75% of the dwelling units (that are not ground-oriented) shall have a balcony. The minimum balcony area is 5% of the dwelling unit size. rcial or residential floor area based on fronting street type Any building fronting onto Gordon Drive or Harvey Avenue shall provide ground-floor commercial units, which must occupy a minimum of 90% of the street frontages. Access driveways or other portions of the street frontage not used as a building will not be considered for the purpose of this calculation. Any combination of commercial and residential uses is permitted above the ground-floor units. Any building fronting onto Capri Street or Sutherland Avenue can provide any combination of commercial and residential uses at the ground floor and above. For tower & podium regulations refer to Section 9.11 Tall Building Regulations (a) the minimum setback to Harvey Avenue is 4.5 m. (b) the minimum setback to Gordon Drive for all buildings or portions of the building located within 40 m of Harvey Avenue is 0.0 m (c) the minimum setback to Gordon Drive for all buildings or portions of the building located beyond 40 m of Harvey Avenue is 3.0 m, excluding decks and patios. (d) the minimum setback to Capri Street for all buildings or portions of the building located within 40 m of Harvey Avenue is 0.0 m. (e) the minimum setback to Capri Street for all buildings or portions of the building located beyond 40 m of Harvey Avenue is 3.0 m, excluding decks and patios. (f) the minimum setback to Sutherland Drive is 3.0 m, excluding decks and patios. (g) all portions of buildings above 6 storeys shall be setback a minimum of 6 m from Gordon Drive, Sutherland Avenue, and Capri Street. (h) the minimum setback to lands abutting the Capri Centre Lands is 7.5 m ntre xed commercial and residential zone for developments within the Capri-Landmark Urban and follows the Capri-Landmark Urban Centre Plan. mitted Land Uses 40.0m except 13.0m if site abuts a lane 30.0m 1,200m² except 460m² if site abuts a lane 100% or 85% 100% or 90% igs, structures, impermeable surfaces Refer to 14.14 side yards setbacks for all portions of a building that are not ground-oriented 3.0m 3.0m g side yards setbacks for ground-oriented, residential 2.0m g side yards setbacks for ground-oriented, commercial om front yard and flanking side yard n/a 0.0m 0.0m 6.0m² per bachelor dwelling unit 10.m² per 1 bedroom dwelling unit menity space 15.0m² per dwelling unit with more than 1 bedroom 1.6m when abutting an urban residential or rural residential zone structures setback 3.0m for portion of a building abutting a street above 16m or 4 storeys Buildings greater than 18.0m or 4.5 storeys on a corner, triangular setback 4.5m along lot lines at the first storey

Residential streets can contain one hundred precent (100%) of the floor area as principal use.

ial or residential floor based on fronting street type

2.0 spaces per grocery store exceeding 20,000 ft2

tail liquor sales establishments and grocery stores exceeding 1,858m2 (20,000 ft2) m2 (20,000 ft2)

te a zone which will allow for the creation of comprehensive site specific land use regulations y where the circumstances are such that control by other zones would be inappropriate or existing or future surrounding developments and to the interest of the applicant and the

ramework for the existing uses and for the re - development and use of the Capri Centre in re of commercial and residential uses that serve more than one neighbourhood

Reg

1.0 space per 1 dwelling unit Of the required parking for residential uses, 1.0 space per 7 dwelling units 1.75 parking spaces per 100m2 GFA

1.0 space per 1 sleeping unit

Refer to section 9.11 Tall Buildings Regulations

shall be residential principal use

floor.

1.0 space per building with a commercial use

Mixed Streets can contain any combination of ground-floor commercial or residential principal uses at the ground-floor. Mixed Residential Streets can contain any combination of ground-floor commercial or residential principal uses. One hundred precent (100%) of the floor area above the ground-floor

High Streets or Retail Streets shall provide a ground commercial principal uses, which must occupy a minimum of 90% of the street frontage. Access driveways or other portions of the street frontage not used as a building will not be considered for the purpose of this calculation. Any Combination of commercial and residential principal uses is permitted above ground-

The commercial and residential principal use floor area restriction is based on street type as defined in the City of Kelowna official Community Plan (See Maps 4.2 Downtown Streets, 4.4 Capri-Landmark Streets, 4.6 Pandosy Streets, 4.8 Rutland Streets, 4.10 Midtown Streets). Secondary uses are permitted in accordance with Section 14.9. Any building classified as a:

Any site within an urban entre larger than 1 acre with a building length larger than 100m shall provide an urban plaza at grade

Design Rationale 3.5

1835 Gordon Dr. will consist of a single tower and podium, addressing Sutherland Ave and Capri St. with a plaza on the southeast corner. Six types of residential units will provide a mix of housing types and levels of affordability.

The site will not change or influence connectivity patterns, and retain the existing laneway on the north edge of the site. Above-ground parking is required due to the water table, it will be wrapped in a modern design using vine planting in key locations to soften the parkade facade towards Capri St.



Figure 1-22: Proposed vine Planting over parkade Capri St Facade

The architectural design is based on a square grid that provides simplicity, flexibility and a modular design which can be easily adapted to different unit layouts. This simplicity allows for easier construction and maintenance, as well as greater adaptability to changing tenant needs over time

The grid helps to create a cohesive and visually appealing design that enhances the overall aesthetic of the building and helps to establish a sense of community among residents, as they share a common visual language that makes it easier to navigate and orient themselves within the building. The project offers an amenity on the podium roof for residents, as well as a opportunity for an "outdoor living room" lounge along the edge of the laneway as well.

The housing program will include 269 units. 6 Town houses, 38 twobedroom + den apartments, 63 two-bedroom apartments, 64 onebedroom + den apartments, 95 one-bedroom apartments and 3 studios. This mix provides a variety of levels of attainability, which will benefit the future residents of the Capri Landmark Urban Centre.











Figure 1-17: SE Corner Tower Rendering



Figure 1-18: North East Rendering





Figure 1-21: East Podium Rendering

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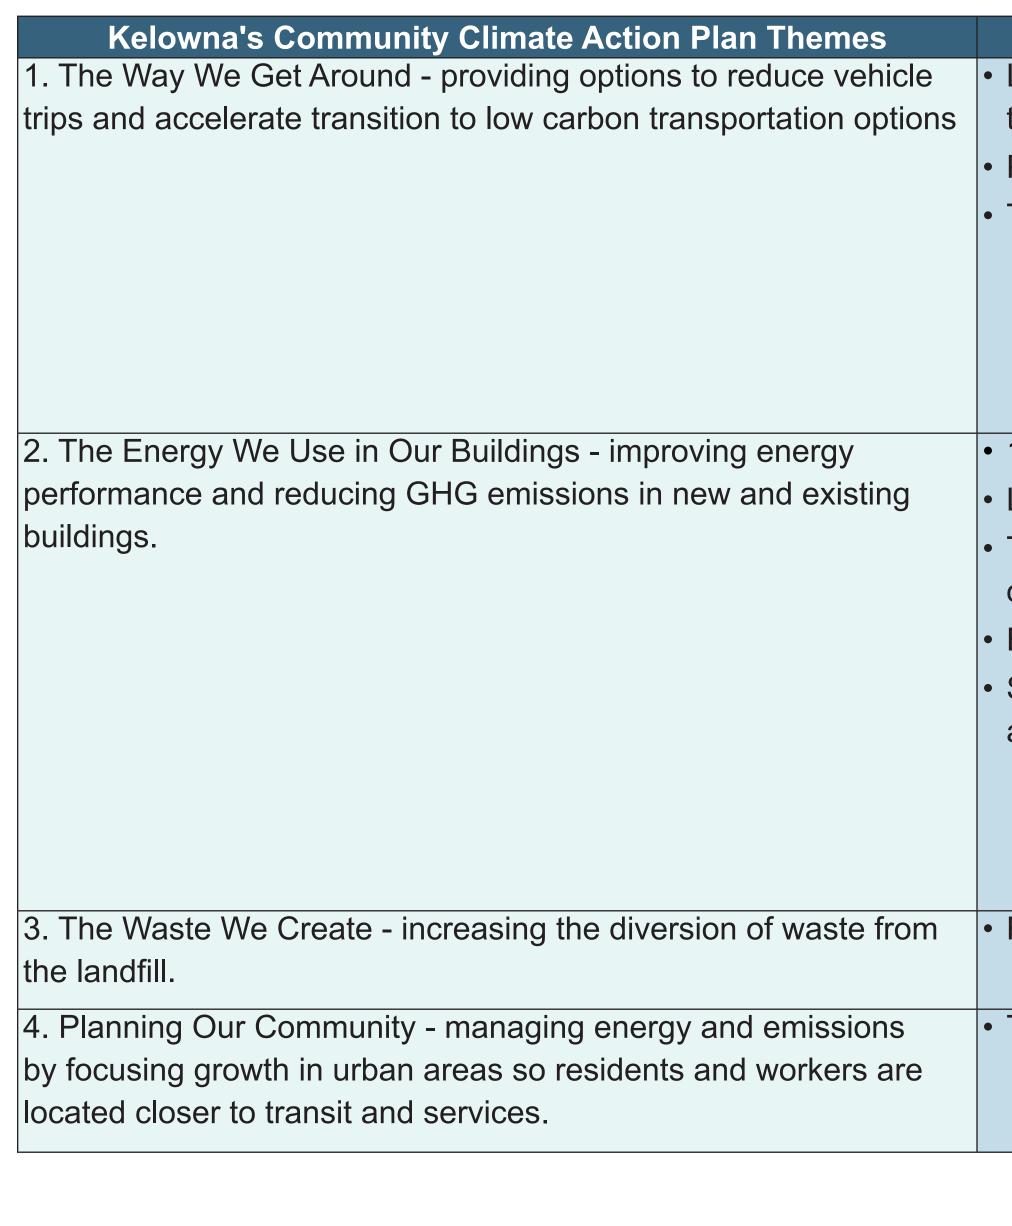
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Sustainability Plan 4

Green Building Design Principles 4.1

In 2018, the City of Kelowna published its Community Climate Action Plan. This includes actions for advancing towards climate targets that are led by the city, though implementation can also happen by developers and community members as the city grows and changes.

1835 Gordon Dr. will contribute to each of the themes through its siting, planning, design, and operations. The measures taken to address these theme areas are listed on the next table.











1835 Gordon Dr. Response

Located less than a 5-minute walk away from the Harvey Avenue, 1835 Gordon Drive will be accessible by multiple modes of transportation.

• Pedestrian and cyclist amenities such as bike parking and comfortable, convenient pathways will encourage active transportation. • The proximity to mixed use areas and commercial shops and services will reduce vehicle trips.

• 1835 Gordon Drive will meet or exceed the standards of Kelowna's Energy Step Code 2. Low-carbon building measures including locally manufactured materials and low-VOC emitting materials will be used where possible. • The buildings are designed to minimize air and heat transfer between units and the outside, and maximize daylight and views for regularly occupied spaces.

Energy efficient mechanical and electrical systems, including lighting and appliances, will be preferred in the building fit-out. • Specified common areas (stairwells and parking) will have occupancy sensors to limit the duration and/or intensity of operational lighting, and use LED bulbs. Outdoor lighting will be controlled by photocells and/or timers.

• Recycling facilities will be provided on site.

• This key infill site is a positive opportunity to accommodate population growth within Kelowna's urban area, close to transit and services.







COVER PAGE

Development Permit - Sheet List

Number	Sheet Name	Rev.
DP0.00	COVER PAGE	A
DP0.01	PROJECT STATISTICS	А
DP0.02	SITE PHOTOS	A
DP0.03	SURVEY	А
DP0.04	SETBACK PLAN	A
DP0.05	CAPRI MALL MASTERPLAN	A
DP0.06	CAPRI MALL OVERALL SITE PLAN	A
DP0.07	PROPOSED SITE PLAN	А
DP0.08	MATERIAL BOARD	A
DP0.09	CITY OF KELOWNA REQUIRMENTS	A
DP0.10	SITE COVERAGE	A
DP1.01	LEVEL P1 & MAIN FLOOR PLAN	A
DP1.02	LEVEL 02 & 03 FLOOR PLAN	A
DP1.03	LEVEL 04-05 & 06 FLOOR PLAN	A
DP1.04	LEVEL 07-22 & 23 PH FLOOR PLAN	A
DP1.05	MECHANICAL PH & ROOF PLAN	A
DP2.01	EAST ELEVATION	A
DP2.02	WEST ELEVATION	A
DP2.03	NORTH & SOUTH ELEVATIONS	A
DP3.01	BUILDING SECTIONS	A
DP3.02	BUILDING SECTIONS	A
DP4.00	3D MASSING	A
DP4.01	3D MASSING	A
DP4.02	3D MASSING	A
DP5.01	LEVEL P1 & MAIN FLOOR FAR PLANS	A
DP5.02	LEVEL 02 & 03 FAR PLANS	A
DP5.03	LEVEL 04-05 & 06 FAR PLANS	A
DP5.04	LEVEL 07-22 & 23 PH FAR PLANS	A
DP6.01	LEVEL 01 & 02 OPEN SPACE PLANS	A
DP6.02	LEVEL 03 & 04 OPEN SPACE PLANS	A
DP6.03	LEVEL 06 & 07-22 OPEN SPACE PLANS	A
DP6.04	LEVEL 23 OPEN SPACE PLAN	A

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MECHANICAL / ENERGY MODEL



FALCON ENGINEERING LTD. 1715 DICKSON AVE. #210 KELOWNA, BC V1Y 9G6 NAME: JUBAL WRIGHT EMAIL: JUBAL.WRIGHT@FALCON.CA PHONE: (250) 863-0178 CELL:

LANDSCAPE



ECORA ENGINEERING & 2045 ENTERPRISE WAY,. KELOWNA, BC V1Y 7S2 NAME: ACHIM MULLER EMAIL: ACHIM.MULLER@ECORA.CA PHONE: (250) 469-9757 CELL:








Capri Tower 1

1835 Gordon Dr, Kelowna, BC V1Y 3H5

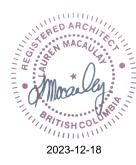

Issued For: Development Permit Project No: 125701 Date: Dec' 2023



January 11, 2024

PROJECT DESCRIPTION PROJECT NAME: PROJECT ADDRESS: LEGAL DESCRIPTION: ZONING: MAX ALLOWABLE FSR/FAR: PROPOSED FSR/FAR:

SITE

Site Area (m²) Max FAR

Total Area

Max Allowable FAR (m²)

Capri Tower 1 1835 Gordon Dr, Kelowna, BC V1Y 3H5

79,156

2.60

205,806

79,156

CD26

2.60

0.68

FSR/FAR Analysis

LOT A, B & C, DISTRICT LOT 137 O.D.Y.D PLAN KAP64836

NOTE: This calculation includes the existing building areas on Lot A, B & C

FT²

605*,*044

187,304

59,686

852*,*035

PROJECT SETBACKS

Setbacks	ks Required Min. at Grade		Proposed	l at Grade	Required Mi	n. at Storeys	Proposed at 6 Storeys		
	Imperial (ft)	Metric (m)	Imperial (ft)	Metric (m)	Imperial (ft)	Metric (m)	Imperial (ft)	Metric (m)	
Front Yard (Harvey Ave)	14.8	4.5	14.8	4.5	14.8	4.5	14.8	4.5	
Side Yard (Gordon Drive)	9.8	3.0	9.8	3.0	19.7	6.0	19.7	6.0	
Side Yard (Capri St.)	9.8	3.0	9.8	3.0	19.7	6.0	19.7	6.0	
Rear Yard Sutherland Drive)	9.8	3.0	9.8	3.0	19.7	6.0	19.7	6.0	

BUILDING HEIGHT

	Max Allowal	bl
	Imperial (ft)	
Building Height	229.7	
No. of Storeys		

Site Breakdown	M ²
Lot A	56,210
Lot B	17,401
Lot C	5,545

PROPOSED AREA BREAKDOWN

Level	Geodetic	Floor to Floor (m)	Number of Units			Gross	(m²)				Exclusio	ns (m²)		FSR/FAR Area	Floorplate	FSR/FAR	FSR/FAR
	Elevation (m)			Parking / Service	Common Areas	Commercial/ Retail	Residential	Amenity	Total Gross Floor Area	Parking and Services	Common Areas	Amenity	Total Exclusions		Efficiency	(Commercial / Retail)	(Residential)
Level 23	418.528	2.997	8	0.00	89.38	0.00	660.60	0.00	749.98	0.00	89.38	0.00	89.38	660.60	88.1%		
Level 22	415.531	2.997	11	0.00	90.53	0.00	659.46	0.00	749.99	0.00	90.53	0.00	90.53	659.46	87.9%		
Level 21	412.534	2.997	11	0.00	90.53	0.00	659.46	0.00	749.99	0.00	90.53	0.00	90.53	659.46	87.9%		
Level 20	409.537	2.997	11	0.00	90.53	0.00	659.46	0.00	749.99	0.00	90.53	0.00	90.53	659.46	87.9%		
Level 19	406.540	2.997	11	0.00	90.53	0.00	659.46	0.00	749.99	0.00	90.53	0.00	90.53	659.46	87.9%		
Level 18	403.542	2.997	11	0.00	90.53	0.00	659.46	0.00	749.99	0.00	90.53	0.00	90.53	659.46	87.9%		
Level 17	400.545	2.997	11	0.00	90.53	0.00	659.46	0.00	749.99	0.00	90.53	0.00	90.53	659.46	87.9%		
Level 16	397.548	2.997	11	0.00	90.53	0.00	659.46	0.00	749.99	0.00	90.53	0.00	90.53	659.46	87.9%		
Level 15	394.551	2.997	11	0.00	90.53	0.00	659.46	0.00	749.99	0.00	90.53	0.00	90.53	659.46	87.9%		
Level 14	391.554	2.997	11	0.00	90.53	0.00	659.46	0.00	749.99	0.00	90.53	0.00	90.53	659.46	87.9%		
Level 13	388.556	2.997	11	0.00	90.53	0.00	659.46	0.00	749.99	0.00	90.53	0.00	90.53	659.46	87.9%		
Level 12	385.559	2.997	11	0.00	90.53	0.00	659.46	0.00	749.99	0.00	90.53	0.00	90.53	659.46	87.9%	0.00	0.22
Level 11	382.562	2.997	11	0.00	90.53	0.00	659.46	0.00	749.99	0.00	90.53	0.00	90.53	659.46	87.9%	0.00	0.22
Level 10	379.565	2.997	11	0.00	90.53	0.00	659.46	0.00	749.99	0.00	90.53	0.00	90.53	659.46	87.9%		
Level 9	376.568	2.997	11	0.00	90.53	0.00	659.46	0.00	749.99	0.00	90.53	0.00	90.53	659.46	87.9%		
Level 8	373.570	2.997	11	0.00	90.53	0.00	659.46	0.00	749.99	0.00	90.53	0.00	90.53	659.46	87.9%		
Level 7	370.573	2.997	11	0.00	90.53	0.00	659.46	0.00	749.99	0.00	90.53	0.00	90.53	659.46	87.9%		
Level 6	367.576	2.997	10	0.00	124.66	0.00	641.69	0.00	766.35	0.00	124.66	0.00	124.66	641.69	83.7%		
Level 5	364.579	2.997	23	0.00	203.80	0.00	1610.01	0.00	1813.81	0.00	203.80	0.00	203.80	1610.01	88.8%		
Level 4	361.582	2.997	23	0.00	203.80	0.00	1610.01	0.00	1813.81	0.00	203.80	0.00	203.80	1610.01	88.8%		
Level 3	358.584	2.997	23	0.00	214.20	0.00	1599.67	0.00	1813.87	0.00	214.20	0.00	214.20	1599.67	88.2%		
Level 2	355.587	2.997	0	2352.92	116.20	0.00	368.45	0.00	2837.57	2352.92	116.20	0.00	2469.12	368.45	13.0%		
Main Floor	352.590	2.997	6	2180.16	327.33	0.00	358.58	0.00	2866.07	2180.16	327.33	0.00	2507.49	358.58	12.5%		
Level P1	349.593	2.997	0	3045.55	100.99	0.00	0.00	0.00	3146.54	3045.55	100.99	0.00	3146.54	0.00	0.0%		
			269	7578.63	2828.84	0.00	17400.37	0.00	27807.84	7578.63	2828.84	0.00	10407.47	17400.37			

Level				Suite Types				Total Number of Units
	Micro	Studio	1 Bed	1 Bed + Den	2 Bed	2 Bed + Den	3 Bed	
Level 23	0	0	0	0	4	4	0	8
Level 22	0	0	5	3	2	1	0	11
Level 21	0	0	5	3	2	1	0	11
Level 20	0	0	5	3	2	1	0	11
Level 19	0	0	5	3	2	1	0	11
Level 18	0	0	5	3	2	1	0	11
Level 17	0	0	5	3	2	1	0	11
Level 16	0	0	5	3	2	1	0	11
Level 15	0	0	5	3	2	1	0	11
Level 14	0	0	5	3	2	1	0	11
Level 13	0	0	5	3	2	1	0	11
Level 12	0	0	5	3	2	1	0	11
Level 11	0	0	5	3	2	1	0	11
Level 10	0	0	5	3	2	1	0	11
Level 9	0	0	5	3	2	1	0	11
Level 8	0	0	5	3	2	1	0	11
Level 7	0	0	5	3	2	1	0	11
Level 6	0	0	3	4	2	1	0	10
Level 5	0	1	4	4	8	6	0	23
Level 4	0	1	4	4	8	6	0	23
Level 3	0	1	4	4	9	5	0	23
Level 2	-	-	-	-	-	-	-	0
Main Floor	-	-	-	-	3	-	3	6
Level P1	-	-	-	-	-	-	-	0
	0	3	95	64	66	38	3	269
	0%	1%	35%	24%	25%	14%	1%	100%

Height	Proposed Height				
Metric (m)	Imperial (ft)	Metric (m)			
70.0	229.4	69.9			
22	-	23			

LEGEND	
FSR	Floor Space Ratio
FAR	Floor Area Ratio
	Residential
	Amenity
	Parkade
	Main Floor
	Existing Area

..... FSR/FAR Permitted 205805.60

	Totals Breakdown:
36,790	Existing Commercial Sq.m:
0	Proposed Commercial Sq.m:
17,400	Proposed Residential Sq.m:
0	Total Amenity Sq.m:
27,808	Proposed Total Gross Floor Area Sq.m:
0%	Total Commercial % of Project:
63%	Overall Building Efficiency
54,190	Total Net Saleable Sq.m:

VALUES FOR TABULATING PARKING &	LOADING COUNTS		
Commercial	Imperial (ft²)	Metric (m²) 0.00)
Residential Units		269	ur
ZONING BYLAW PARKING REQUIRME	NTS		
Required Parking	Micro	1	
	Studio	1	
	1 Bed	1	
	2 Bed	1	
	3 Bed	1	
	Visitor Parking	0.14	
	Commercial	1.75/100m ²	
	Hotel	1/Sleeping Unit	N
OVERALL SITE - PARKING			
Lot	Usa	ge	
Capri Mall Ground	Floor <i>(Retail)</i>		

Lot	Usage	Area (m²)	Parking Calc.	Req. Parking	
	Capri Mall Ground Floor (<i>Retail</i>)	17,527.00	1.75/100m ²	307	
Lot A	Capri Mall Second Floor (Retail)	3,159.00	1.75/100m ²	55	
	Bowling Lanes (Participant Recreation Services, Indoor)	1,338.00	1.75/100m ²	23	
	A&W (Food Primary Establishment)	278.00	1.75/100m ²	5	
	De Dutch/ Booster Juice/Fatburger (Food Primary Establishment)	829.00	1.75/100m ²	15	
	Phase 1 Tower	17,400.37	1/Dwelling Unit	269	
	Kelowna Care Centre (Health Service)	498.00	1.75/100m ²	9	
		41,029.37			_
	Capri Coast <i>(Hotel)</i>				
	Restaurant/Lounge - 66m ²				
Lot B	Spa/Retail - 192m²				
	Meeting Rooms - 389m ²	10,975.00	1/Sleeping Unit	185	
	Banquet Rooms - 409m ²				
	Gift Shop - 22m ²				
	Caps Liquor Store <i>(Retail)</i>	941.00	1.75/100m ²	16	
	Banquet Rooms (Food Primary Establishment)	780.00	N/A	0	
		12,696.00			
Lot C	Old Spaghetti Factory (Food Primary Establishment)	465.00	1.75/100m ²	8	7
		465.00	-	892	Parking Stalls Requ
	Lot A, B & C Combined =	54,190.37		1247	Parking Stalls on Sit

PHASE 1 - PARKING

Type of Unit	Parkin	Parking Calculation		
	# of Unit	# of Stalls		
Micro/Studio	3	3		
1 Bed	159	159		
2 Bed	104	104		
3 Bed	3	3		
Visitors	.14 / Unit	38		
Residential Total	269	269		
Commercial Total	-	0		
Total		269		

Accessible Parking Calculation No. of Parking Spaces On-Site.	201-300 Stalls	N
0 1		
Accessible Stalls	6 Stalls	Co
Van Accessible Stalls	2 Stalls	Co
Commercial Parking Calculation		

No Commercial in Phase 1

Total Parking Required for Phase 1:	269 Stalls
Total Parking Provided for Phase 1:	269 Stalls

PHASE 1 PARKING BREAKDOWN

	Residential		
	Regular	Small	
Level 02	27	40	Γ
Level 01	23	30	
Level P1	37	49	
Totals	87	119	
Parking Provided within Phase 1	214	Stalls	
Surface Parking On Overall Site	55	38 Visitor Stalls Sha	ire
Total Parking Provided	269	Stalls	

Loi	ng Term Residential Bikes	Required	
0.	75 Per 2 Bedroom or Less	186	
1.0) Per 3 Bedroom or More	3	
	 Total	189	

Short Term Residential Bikes	Required	
6 Per Entrance	6	
Long Term Commercial Bikes	Required	
GFA <20,000m ² .2 Per 100m ² , GFA	0	
>20,000m² .4 Per 100m²		
Short Term Commercial Bikes	Required	
2 Per Entrance	0	
CD26 ZONING		
PHASE 1 COMMON & PRIVATE AMENIT	Y SPACE	

Bylaw	Unit Count
	Per Section 15.7.5 -
Table 15.7.5	3
Studio / Micro	
	Per Section 15.7.5 -
Table 15.7.5	159
1 Bedroom	
	Per Section 15.7.5 -
Table 15.7.5	107
2 Or More Bedrooms	

CLIENT

Note: Per Table 8.3.1 Other Residential Parking

Note: Per Table 8.3.1 Other Residential Parking

Note: Per Table 8.2.17 Amount of Accessible Parking Spaces Counted in Table Above Counted in Table Above

Accessible	Van Accessible		
2	0		
1	2		
3	0		
6		- U-	
4 6% vith Commeric	Of Resident Car Parking are Small Cars St	talls	
Provided	- 75% of Stalls located on L01 & P1	Required	Provided
186 3	50% Bike Stall Ground Anchored	140 94.5	189 96
189		54.5	50
Provided			
6	•		
Provided	-		
0			
Provided			
Toviaca	-		
0			
0			
0			
	ed Area Per Unit Type (M²)	City Required	l Open Space
Requir		City Required	l Open Space
Requir	ed Area Per Unit Type (M ²) t Regualtions - Bachelor Dwelling Unit 6		d Open Space
Requir	t Regualtions - Bachelor Dwelling Unit		
Requir 5 Developmen	t Regualtions - Bachelor Dwelling Unit		
Requir Developmen	t Regualtions - Bachelor Dwelling Unit 6	1	
Requir Developmen Developmen	t Regualtions - Bachelor Dwelling Unit 6 t Regualtions - 1 Bedroom Dwelling Unit 10	1	8
Requir i Developmen i Developmen	t Regualtions - Bachelor Dwelling Unit 6 t Regualtions - 1 Bedroom Dwelling Unit 10 t Regualtions - Dweliing Unit With More t	1 15 :han 1 Bedroom	8 90
Requir i Developmen i Developmen	t Regualtions - Bachelor Dwelling Unit 6 t Regualtions - 1 Bedroom Dwelling Unit 10	1 15 :han 1 Bedroom	8
Requir i Developmen i Developmen	t Regualtions - Bachelor Dwelling Unit 6 t Regualtions - 1 Bedroom Dwelling Unit 10 t Regualtions - Dweliing Unit With More t	1 15 :han 1 Bedroom 16	8 90

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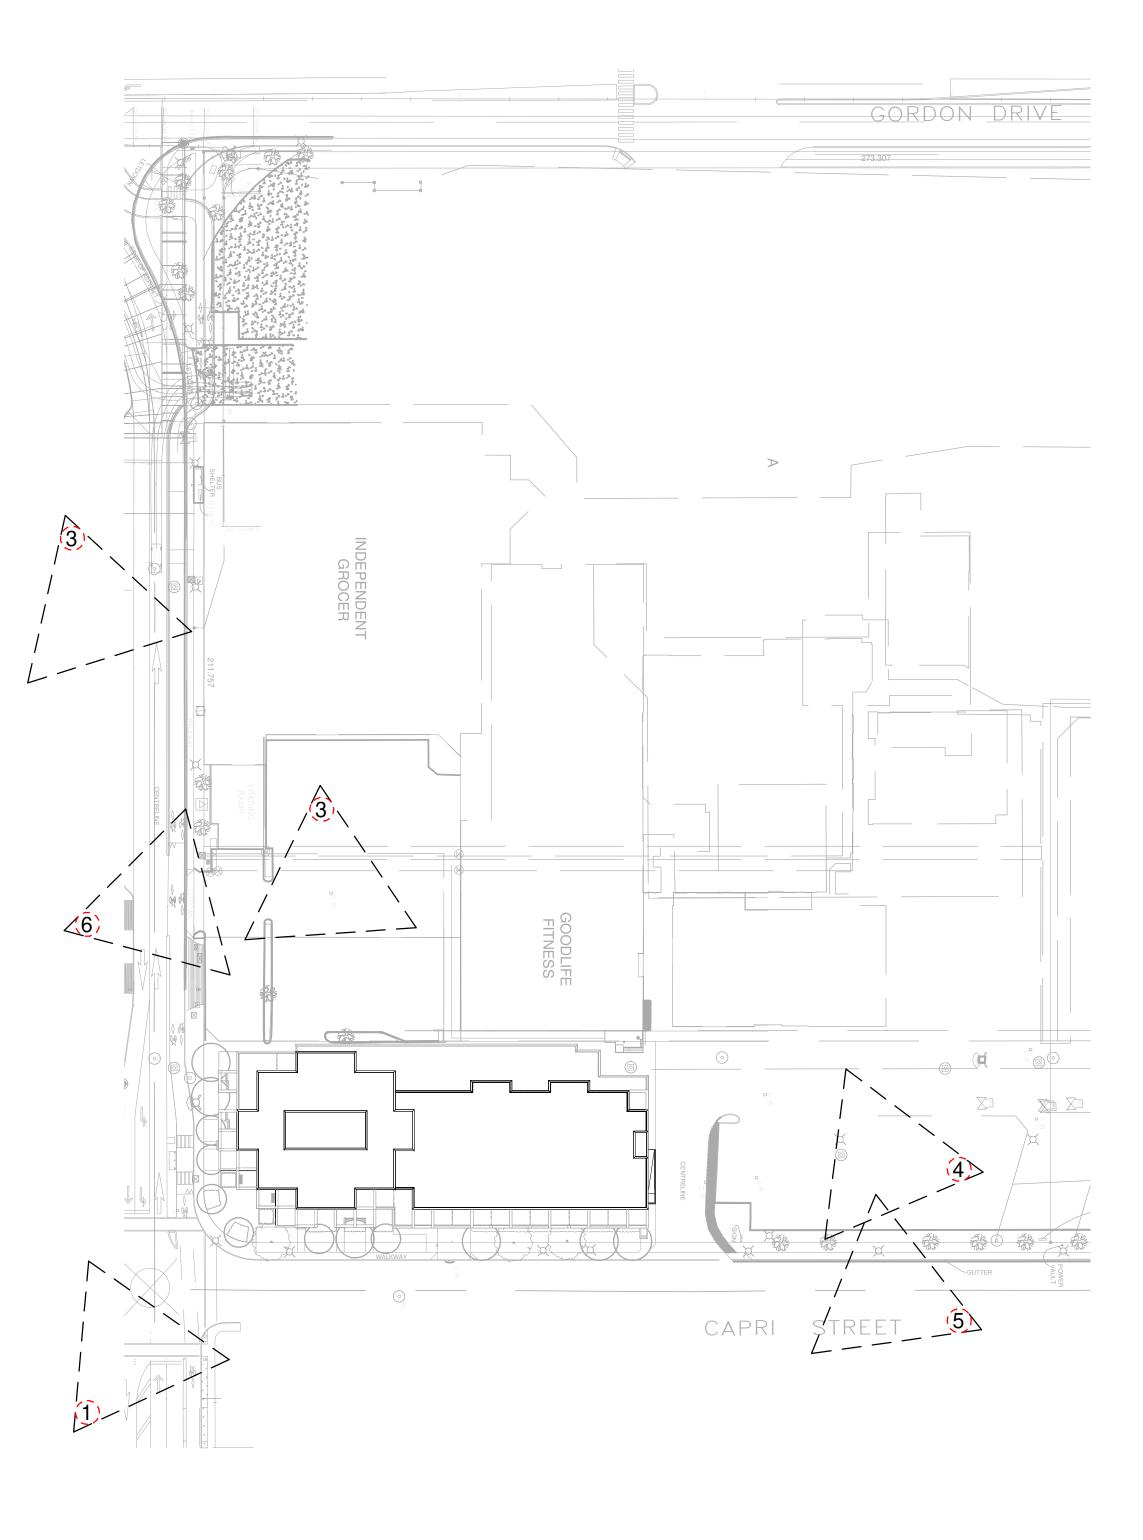


1. CORNER OF CAPRI ST & SUTHERLAND AVE. LOOKING NORTHWEST



2. LOOKING NORTHEAST DOWN SUTHERLAND AVE.





3. LOOKING EAST TOWARDS TOWER 1 SITE LOCATION











6. LOOKING NORTHWEST TOWARDS PROPOSED SERVICE ROAD ENTRANCE

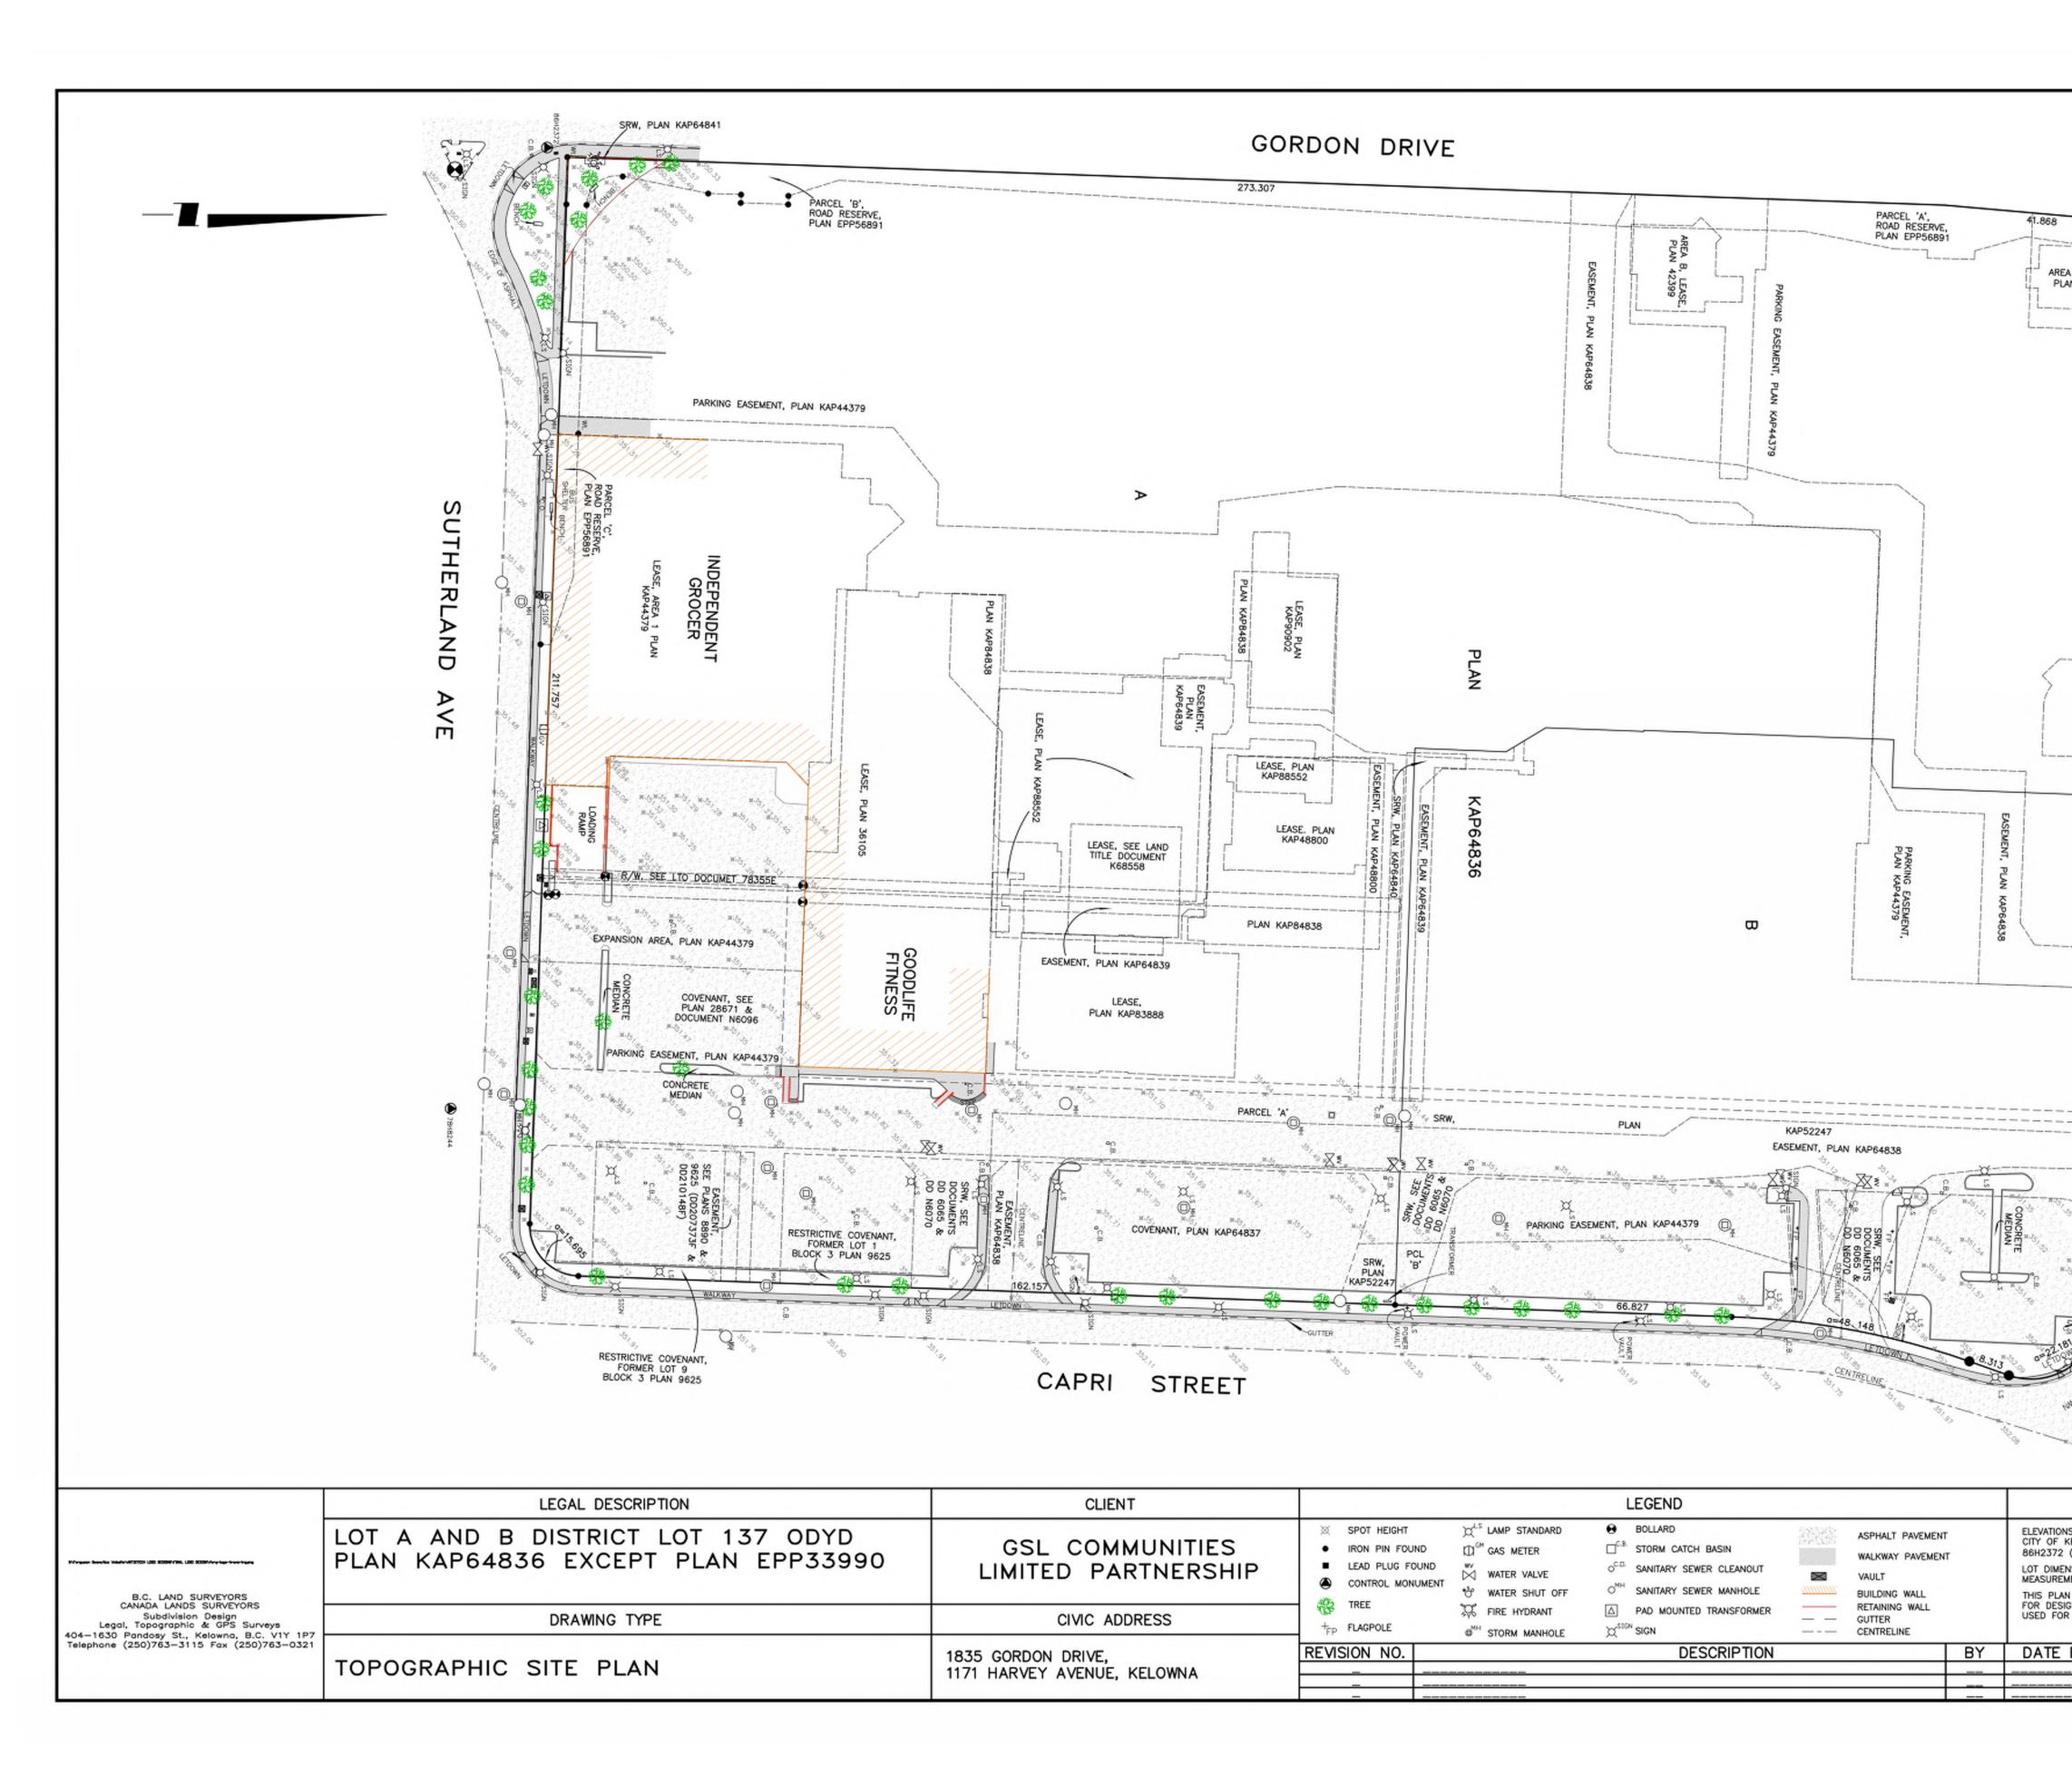

CLIENT	LEGEND		
GSL COMMUNITIES LIMITED PARTNERSHIP	☑ SPOT HEIGHT □ □ BOLLARD ■ BOLLARD ASPHALT PAVEMENT ● IRON PIN FOUND □ □ GAS METER □ C.B. STORM CATCH BASIN WALKWAY PAVEMENT ■ LEAD PLUG FOUND □ W WATER VALVE o C.D. SANITARY SEWER CLEANOUT WAULT ● CONTROL MONUMENT ● WATER SHUT OFF O NH SANITARY SEWER MANHOLE ■ BUILDING WALL ● TREE ○ FOR HORDING ● DAD HOLINTED TRANSFORMED ■ BETAINING WALL		ELEVATIONS CITY OF KI 86H2372 (LOT DIMEN MEASUREM THIS PLAN FOR DESIG
CIVIC ADDRESS	TREE TREE TREE HYDRANT AND PAD MOUNTED TRANSFORMER RETAINING WALL		USED FOR
35 GORDON DRIVE,	REVISION NO. DESCRIPTION	BY	DATE
71 HARVEY AVENUE, KELOWNA			

		GSL Group	
		GS	
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8.502 EA A LEASE, LAN 42399		COPYRIGHT This drawing has been prepared sintended use, thus any reproduct distribution for any purpose other the by Arcadis is forbidden. Written dimensions and conditions on the have precedence over scaled di Contractors shall verify and be respected in the dimensions and conditions on the Arcadis shall be informed of any vante dimensions and conditions shall be informed of any vante dimensions and conditions shall be informed of any vante dimensions and conditions shall be arcadis for general conformance proceeding with fabrication Arcadis for general conformance proceeding with fabrication Arcadis Architects (Canada formerly IBI Group Ar	action or an authorized mensions shall mensions. onsible for all e job, and triations from own on the submitted to be before on. a) Inc.
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		ARCAE	
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NOTES		PROJECT	
NS ARE GEODETIC AND ARE DERIVED FROM KELOWINA CONTROL MONUMENT NUMBER	JOB NO. 22706-TOPO DATE: JULY 10, 2021	Capri Tower 1 1835 Gordon Dr,	əvit202
ENSIONS ARE DERIVED FROM FIELD	SCALE: 1:900 METRES	Kelowna, BC V1Y 3	H5 2F
MENTS AND LAND THE RECORDS. AN IS FOR THE SOLE USE OF THE CLIENT SIGN PURPOSES ONLY AND IS NOT TO BE OR RE-ESTABLISHMENTS OF PROPERTY LINES.		PROJECT NO: 125701	Local\An
	FIELD BOOK: SEE FILE PAGE NO: N/A	DRAWN BY: CHECKE	D BA:
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6M SETBACK LINE PER TABLE 15.7.5 - (e)

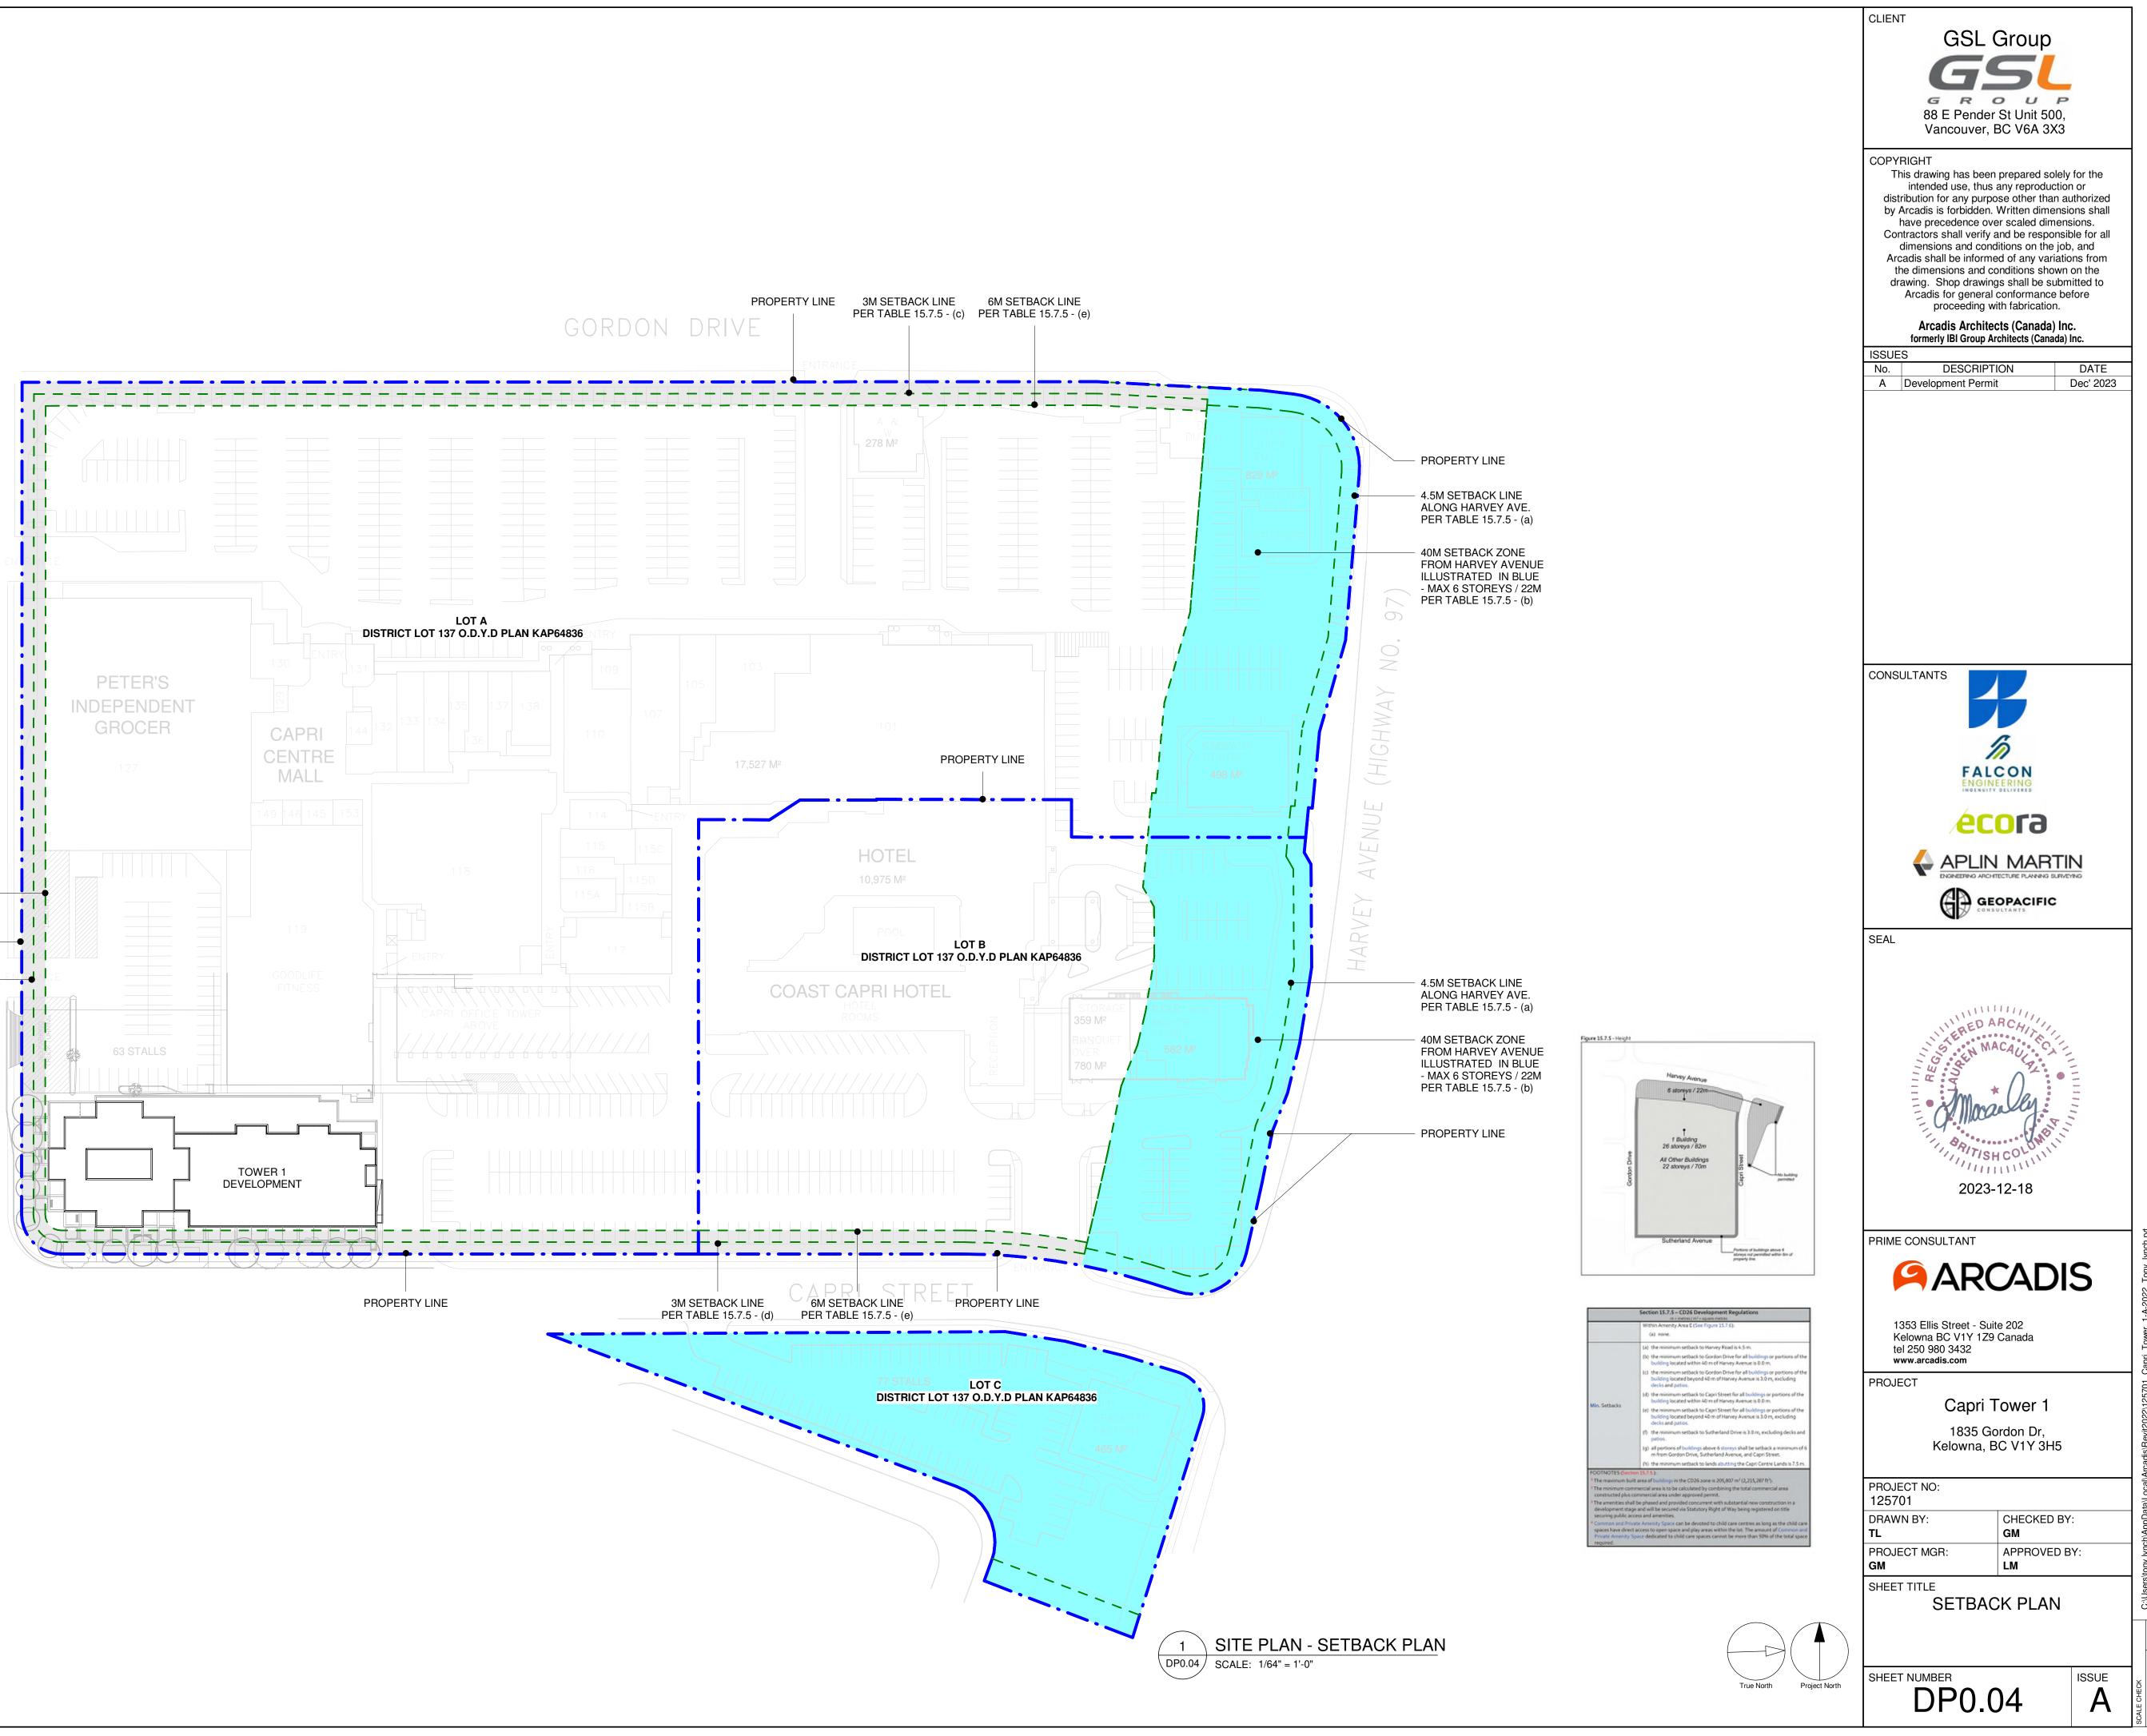PROPERTY LINE

3M SETBACK LINE _____ PER TABLE 15.7.5 - (f)

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GROCER

63 EXISTING


PARKING STALLS

CAPRI

CENTRE MALL




GORDON DRIVE

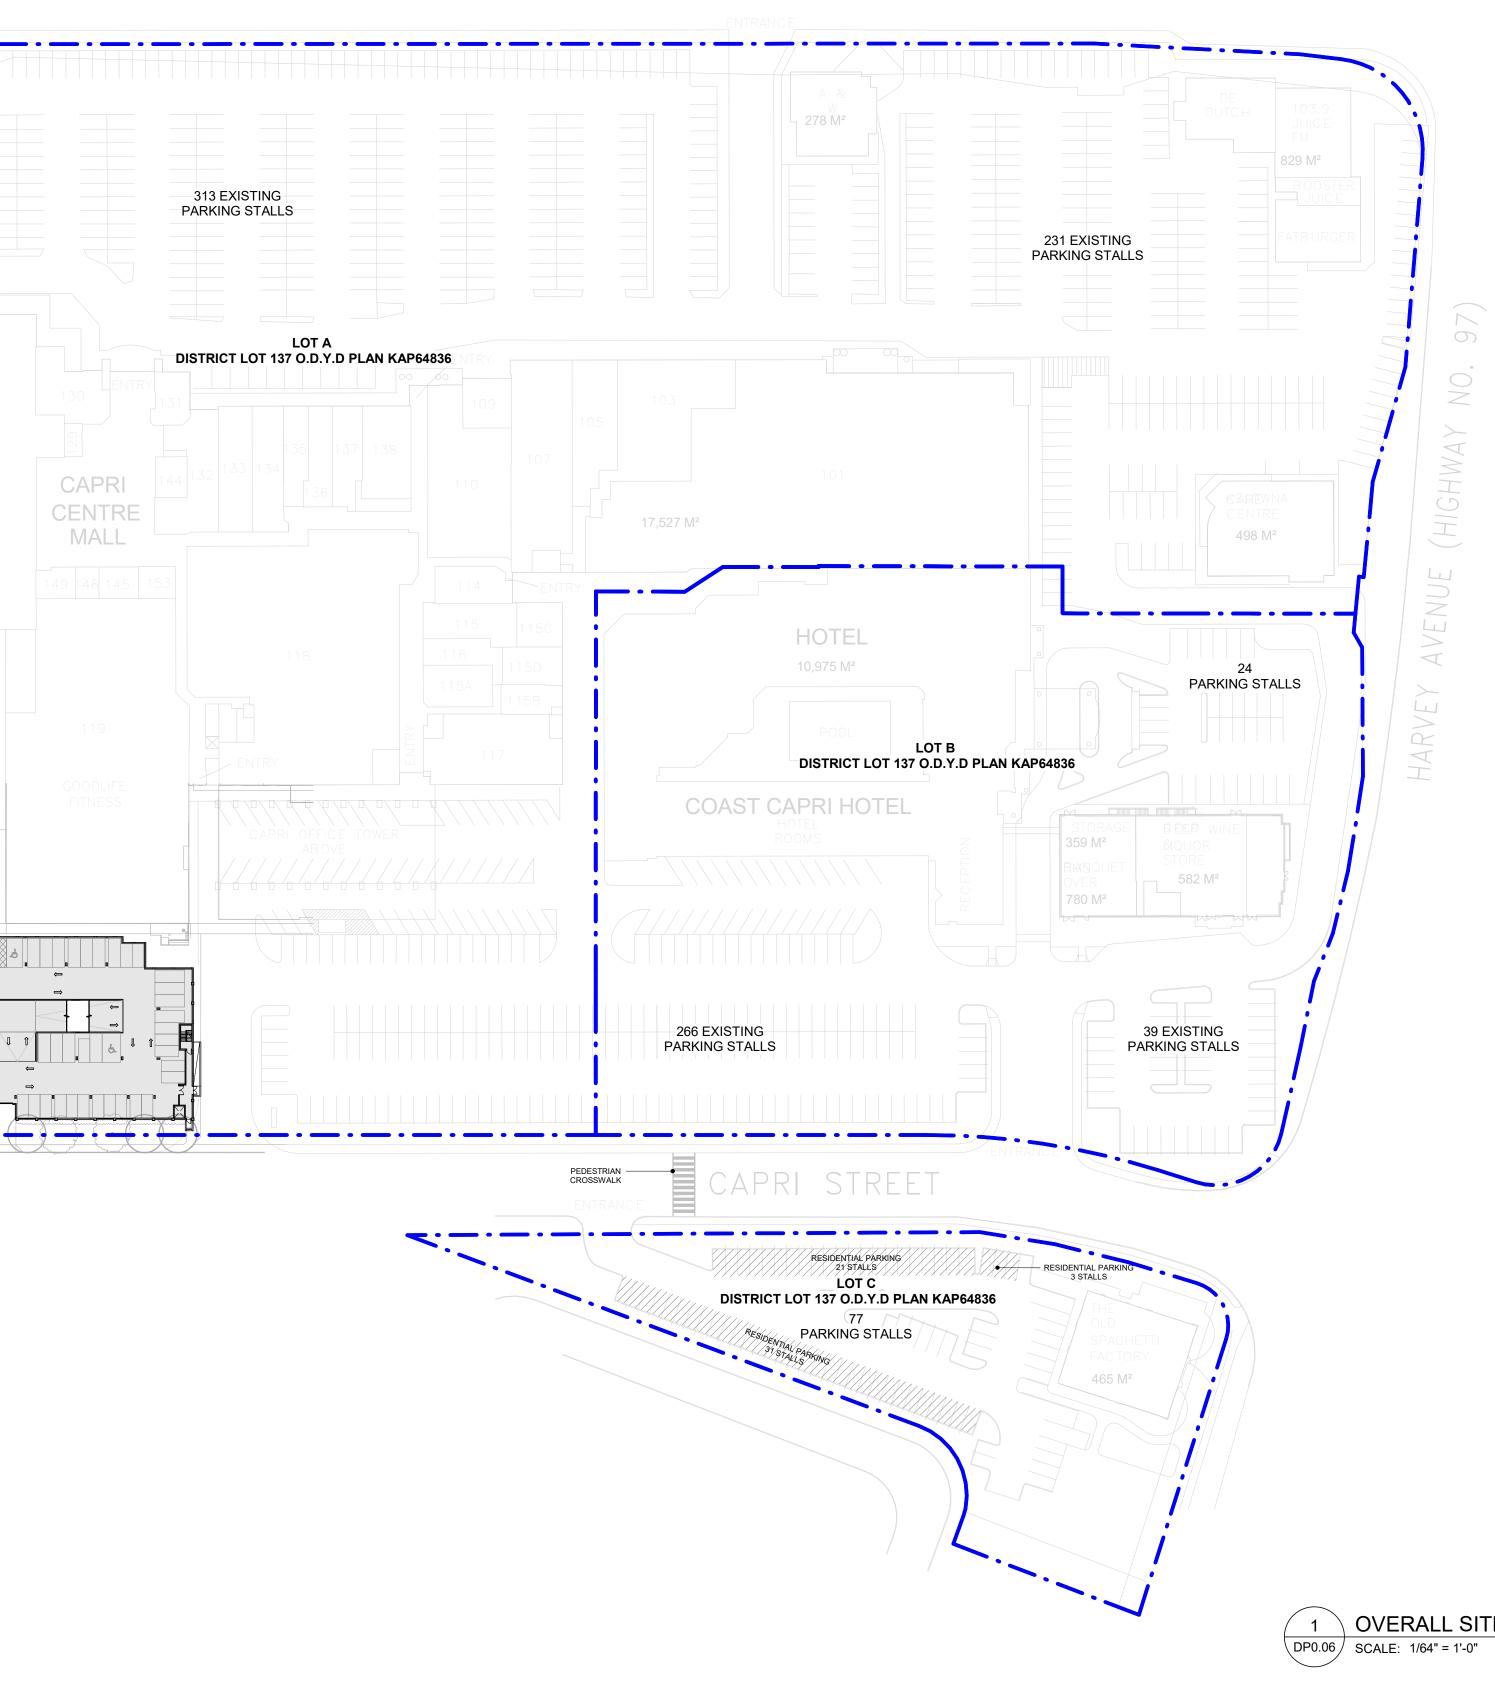


		G 88 E Pender	Group St Unit 500, BC V6A 3X3	
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		ISSUES No. DESCRIPT A Development Perm B Development Perm Re-Submission	it Dec' 2023	
		SEAL	ARCAUS ACAUS HCOLOUNIIII -01-12	
		1835 G	ite 202	cadis\Revit2022\125701_Capri_Tower_1-A-2022_Tony_lynch.rvt
			CHECKED BY: GM APPROVED BY: LM OVERALL SITE AN	C:\Users\tony.lynch\AppData\Local\Arca
<u>EPLAN</u>	True North Project North			SCALE CHECK 1 in 10mm

CLIENT

97 \geq

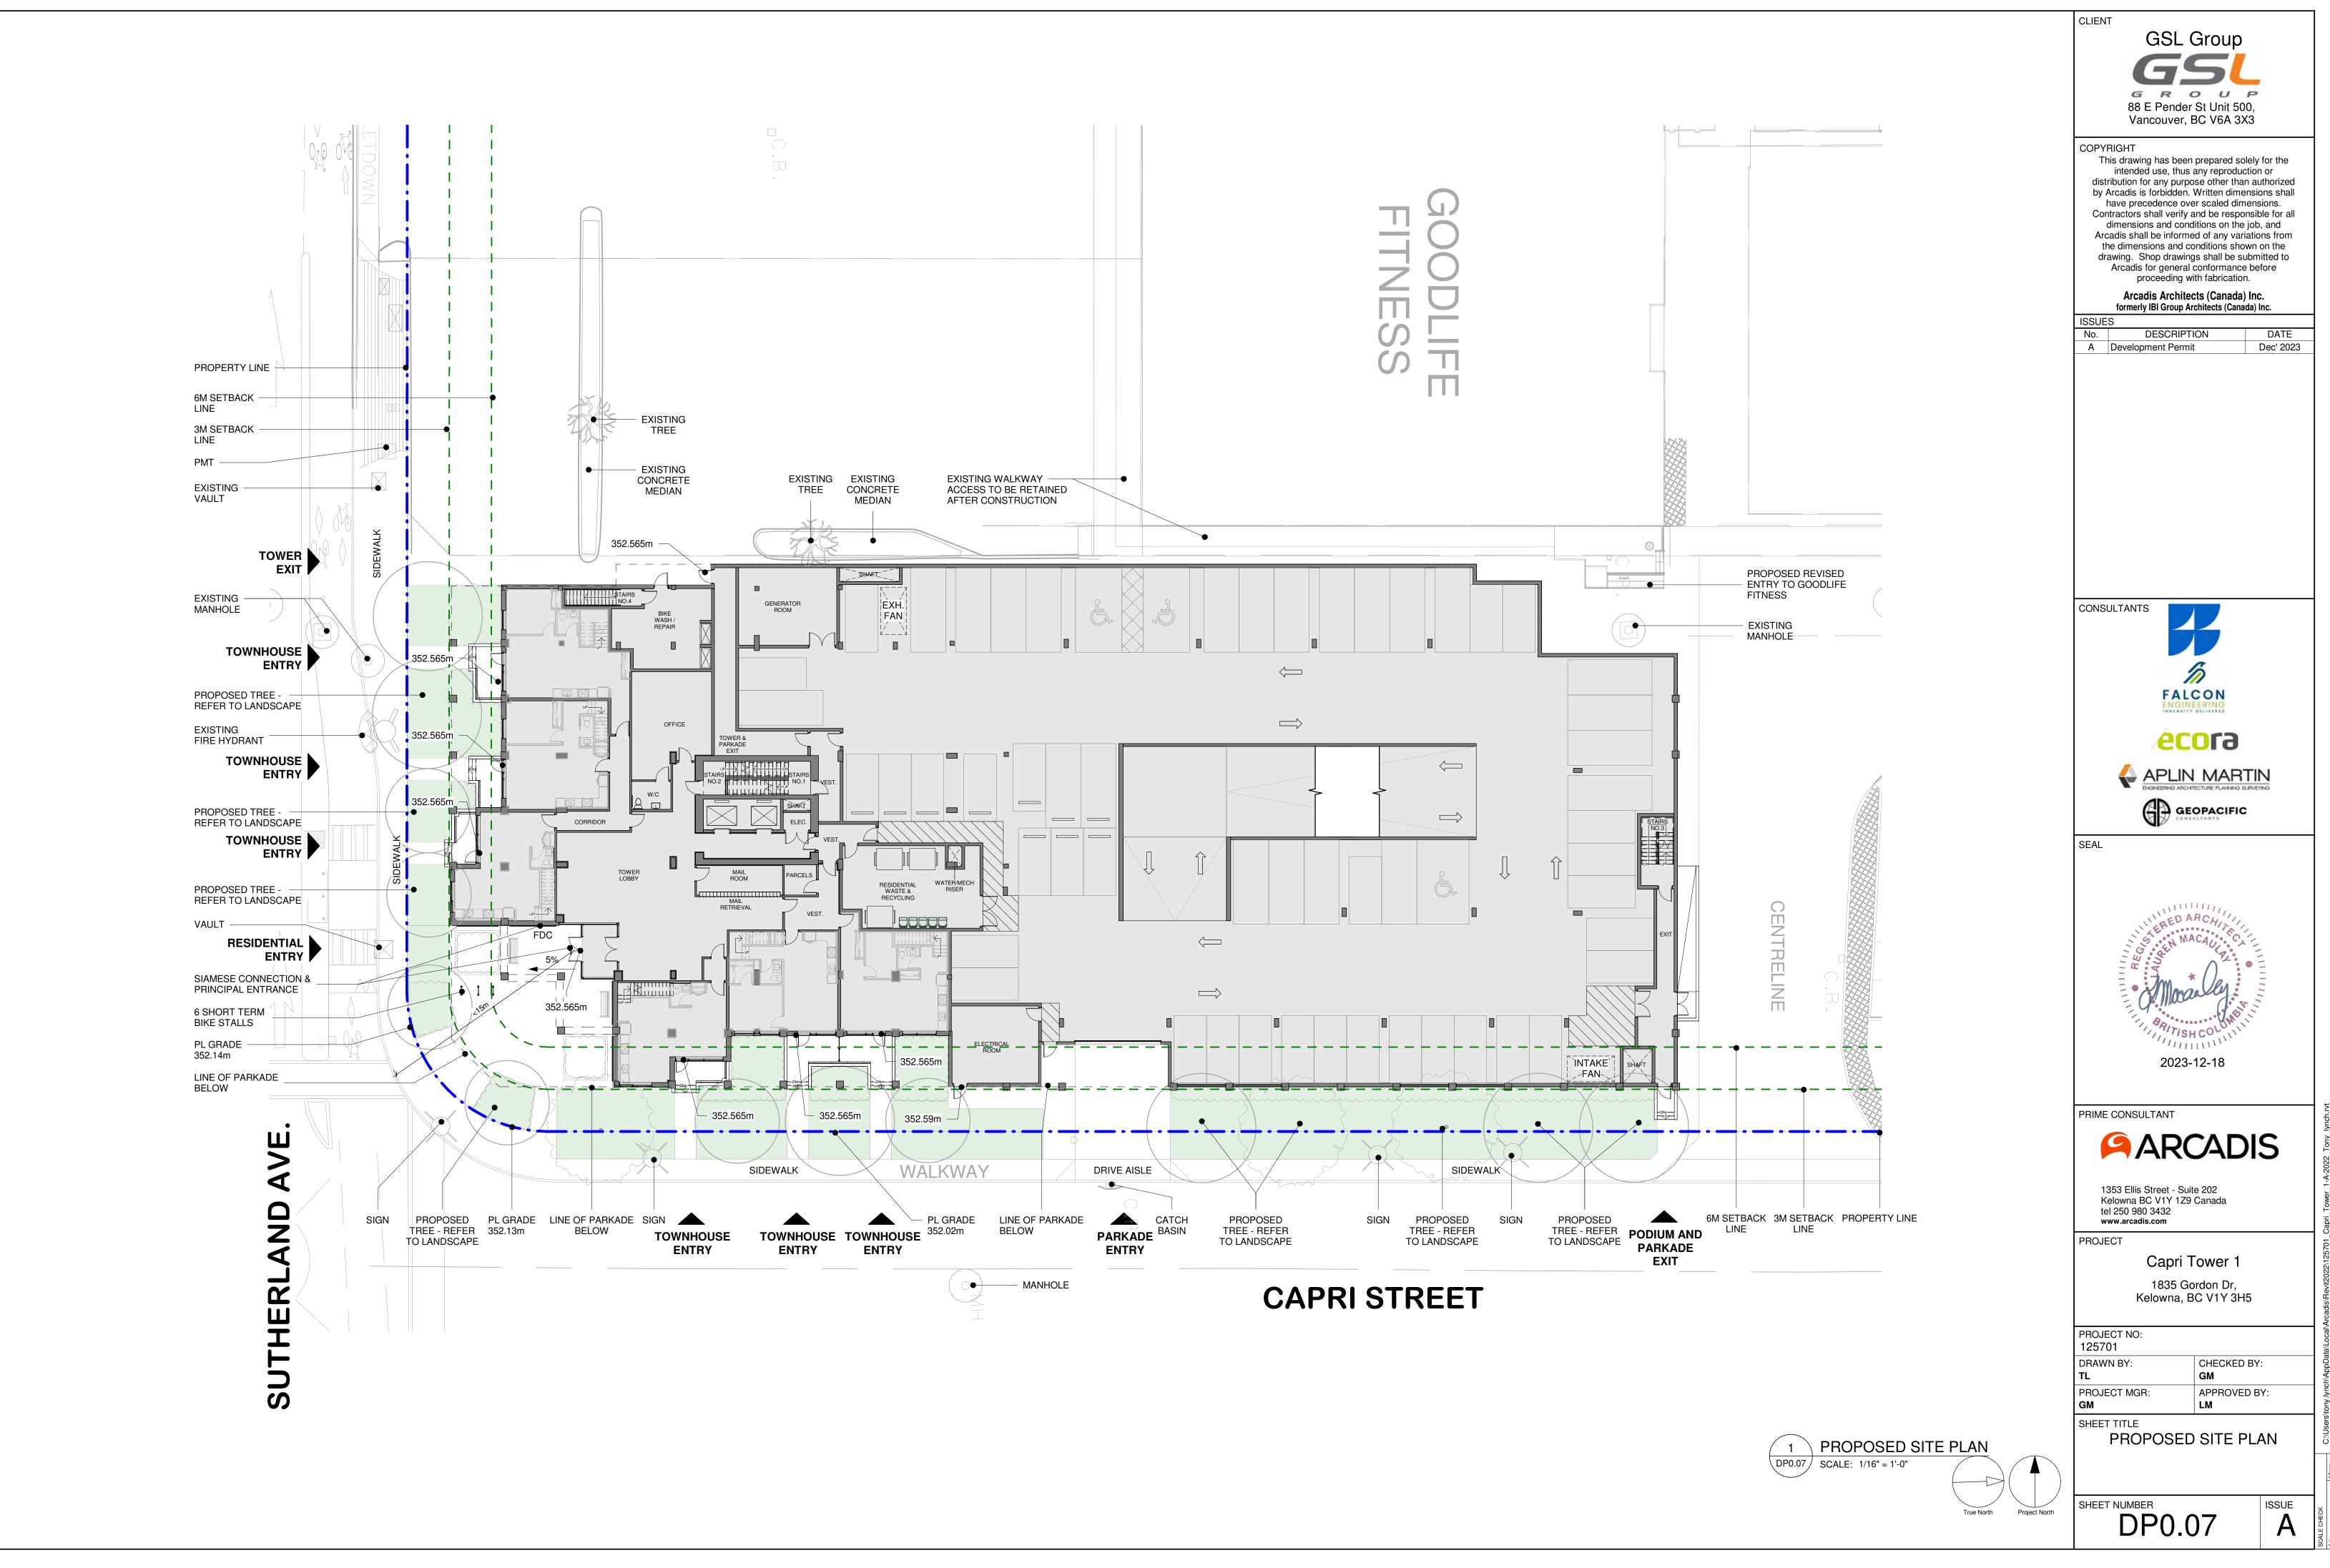




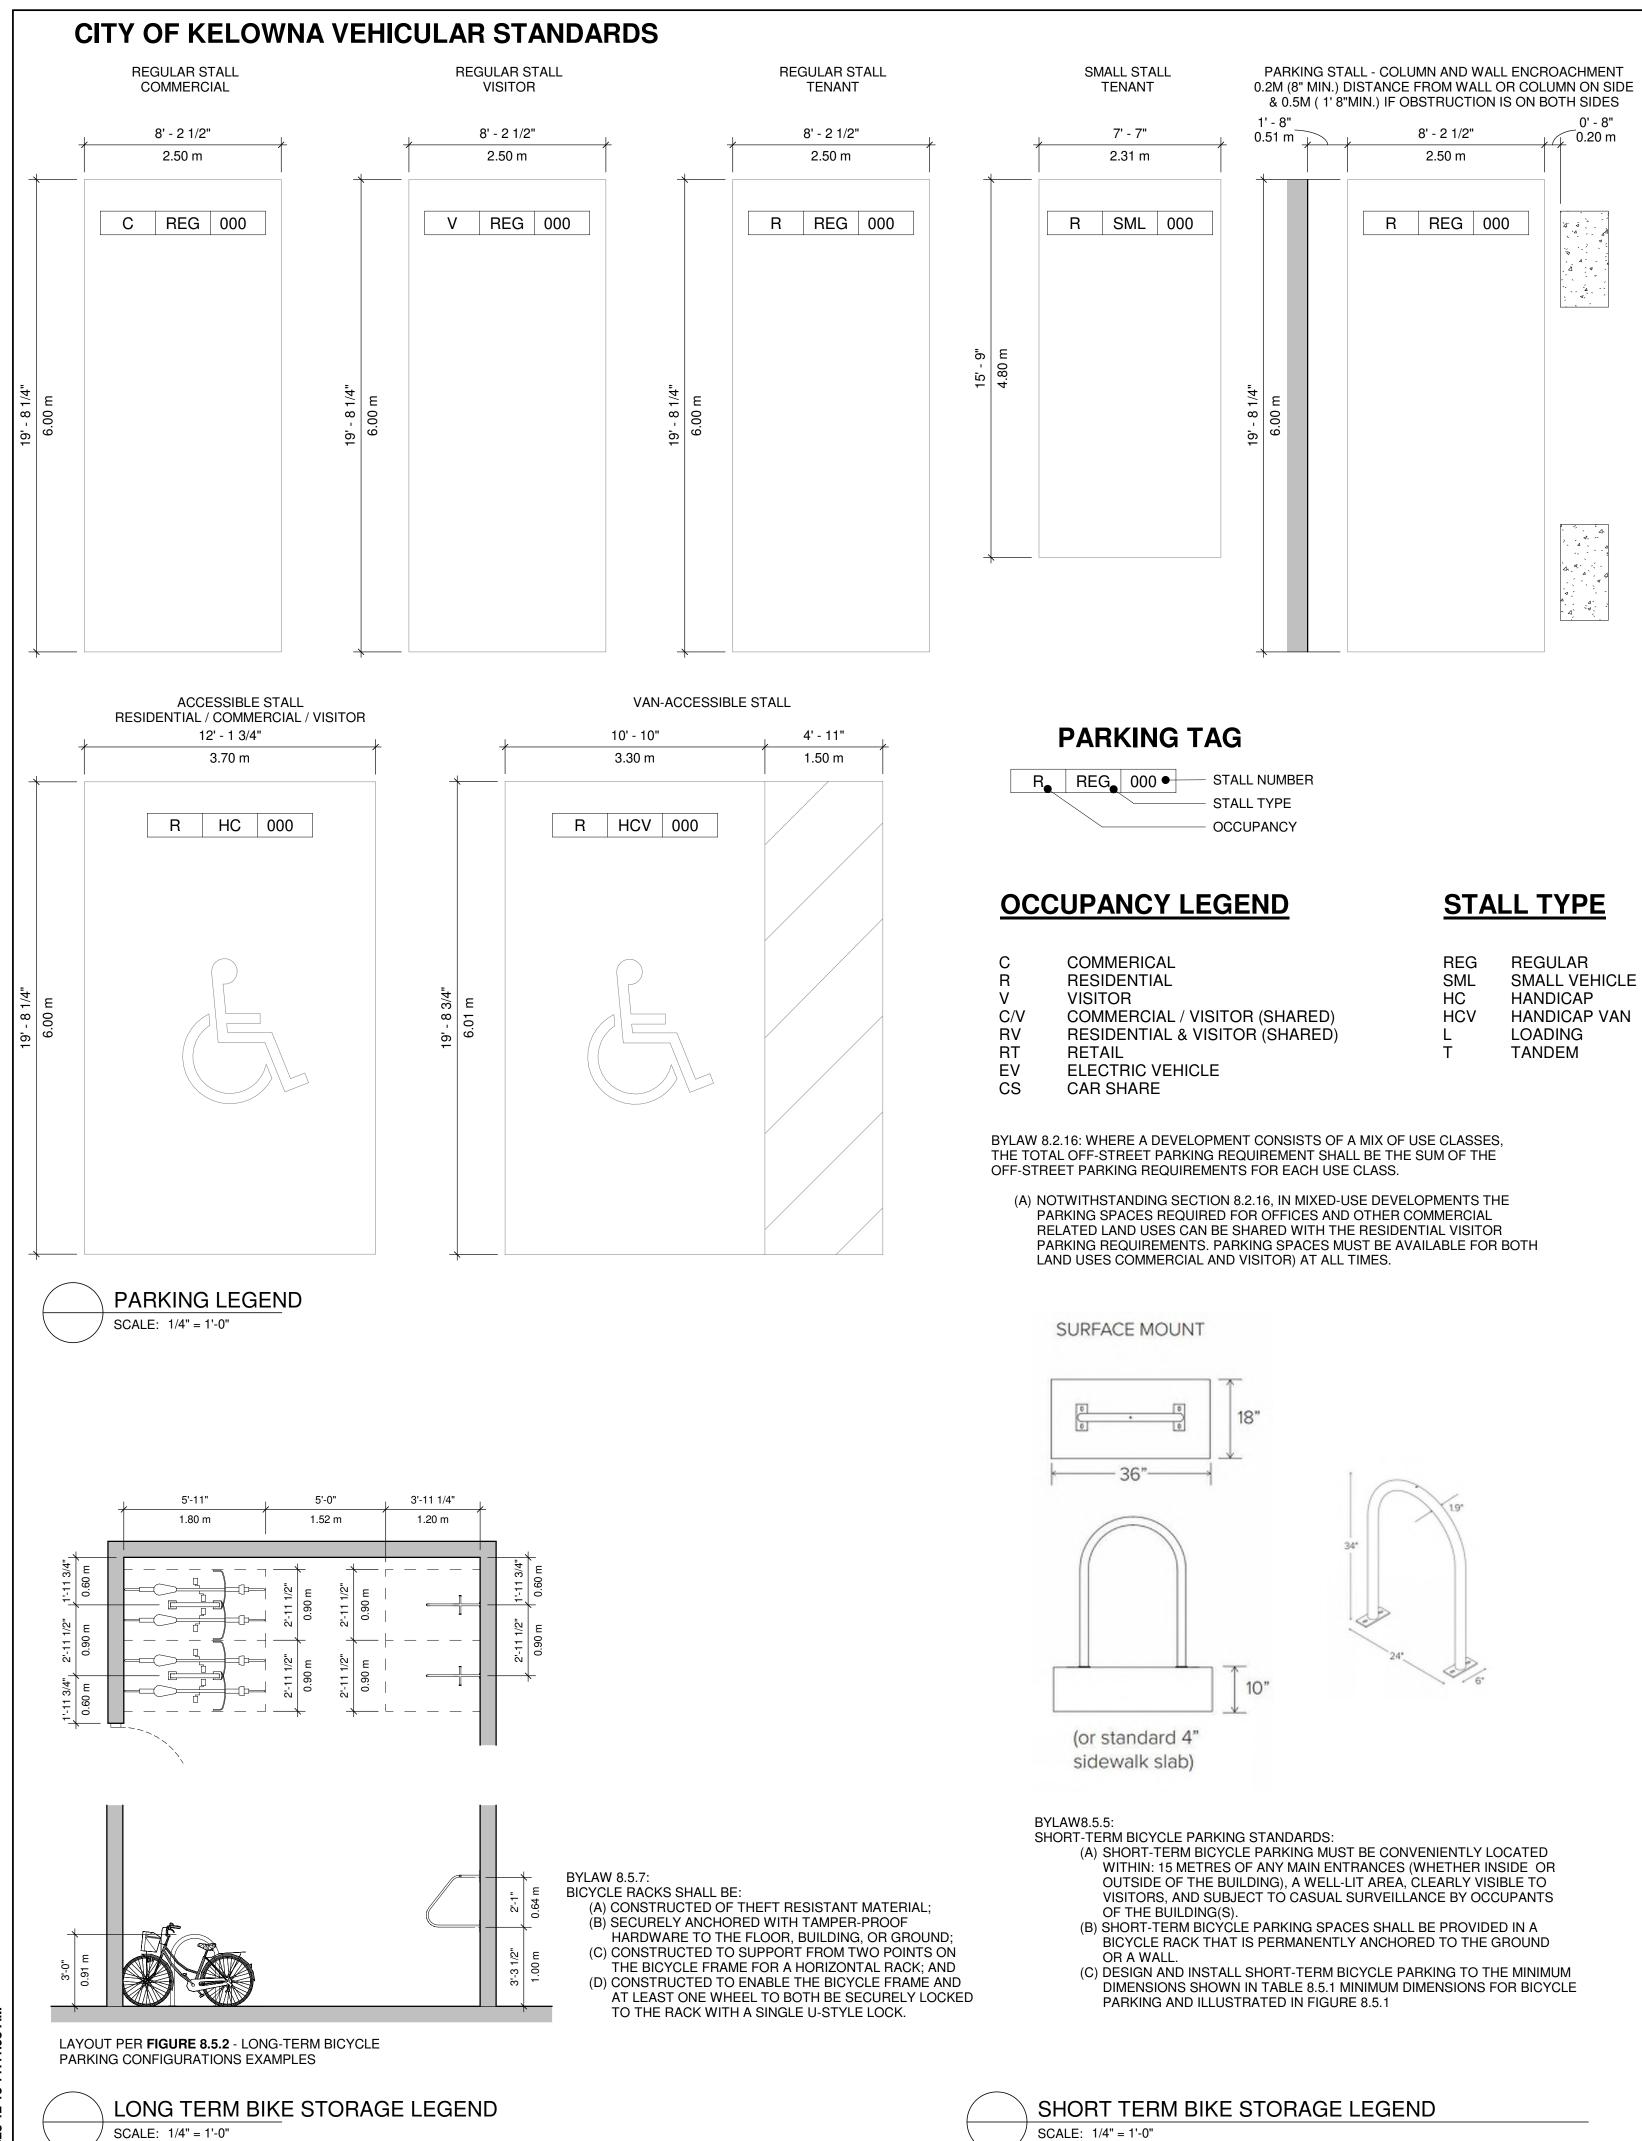

Public Work Stand

Recommended Setbacks

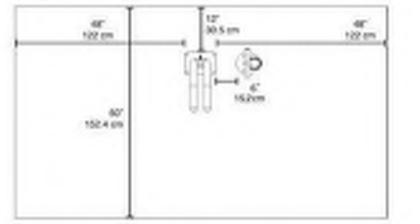


Sile Leyout:

- Minimum of 12" from back of Public Work Stand to wall
- Minimum of 6" between Public Work Stand and Pump
- Minimum of 96° from parallel street.


Bike Wash Station


Recommended Setbacks

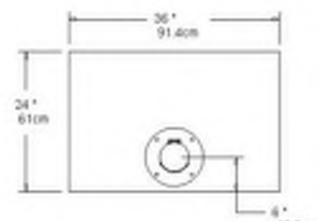

There is a Wheel Check, Public Work Stand, or Deluxe Public Work Stand installed.



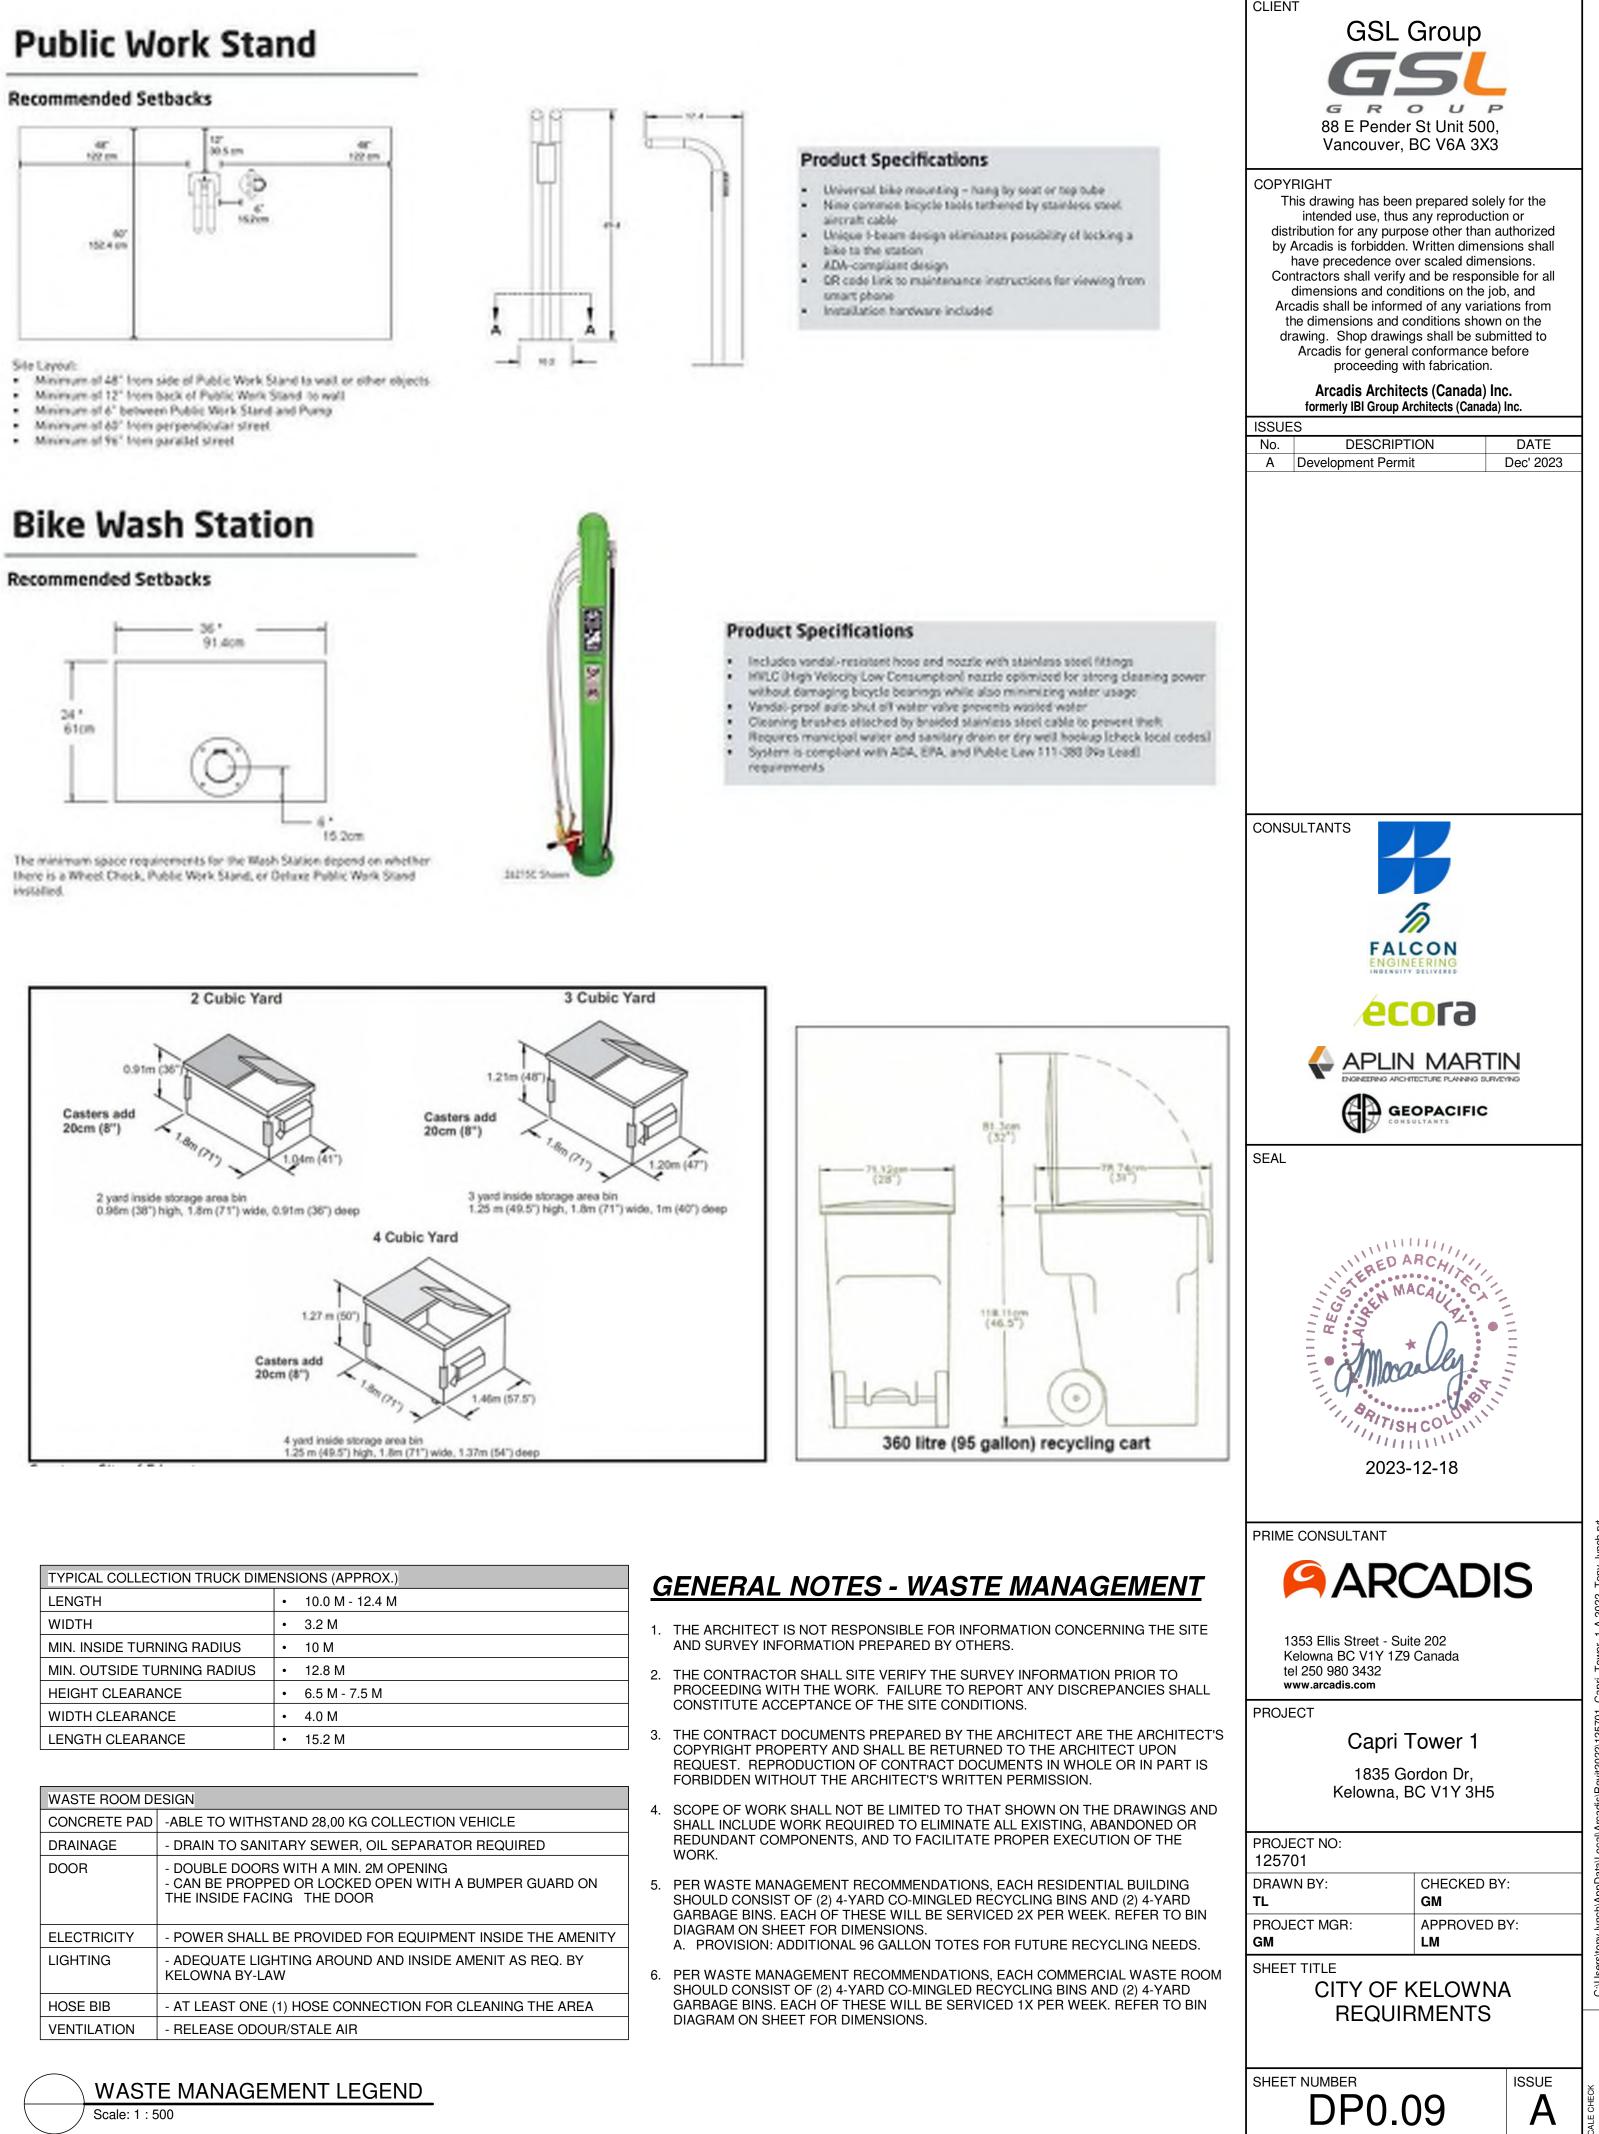

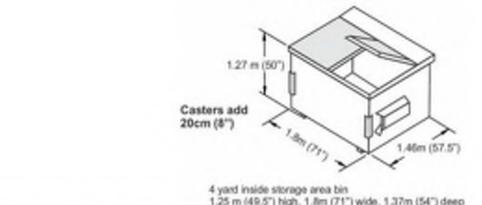


TYPICAL COLLECTION TRUCK DIME	NS	IONS (APPROX.)
LENGTH	•	10.0 M - 12.4 M
WIDTH	•	3.2 M
MIN. INSIDE TURNING RADIUS	•	10 M
MIN. OUTSIDE TURNING RADIUS	•	12.8 M
HEIGHT CLEARANCE	•	6.5 M - 7.5 M
WIDTH CLEARANCE	•	4.0 M
LENGTH CLEARANCE	•	15.2 M

WASTE ROOM DE	SIGN
CONCRETE PAD	-ABLE TO WITHSTAND 28,00 KG COLLECTION VEHICLE
DRAINAGE	- DRAIN TO SANITARY SEWER, OIL SEPARATOR REQUIRED
DOOR	- DOUBLE DOORS WITH A MIN. 2M OPENING - CAN BE PROPPED OR LOCKED OPEN WITH A BUMPER GUARD ON THE INSIDE FACING THE DOOR
ELECTRICITY	- POWER SHALL BE PROVIDED FOR EQUIPMENT INSIDE THE AMENITY
LIGHTING	- ADEQUATE LIGHTING AROUND AND INSIDE AMENIT AS REQ. BY KELOWNA BY-LAW
HOSE BIB	- AT LEAST ONE (1) HOSE CONNECTION FOR CLEANING THE AREA
VENTILATION	- RELEASE ODOUR/STALE AIR
DRAINAGE DOOR ELECTRICITY LIGHTING HOSE BIB	 DRAIN TO SANITARY SEWER, OIL SEPARATOR REQUIRED DOUBLE DOORS WITH A MIN. 2M OPENING CAN BE PROPPED OR LOCKED OPEN WITH A BUMPER GUARD OF THE INSIDE FACING THE DOOR POWER SHALL BE PROVIDED FOR EQUIPMENT INSIDE THE AME ADEQUATE LIGHTING AROUND AND INSIDE AMENIT AS REQ. BY KELOWNA BY-LAW AT LEAST ONE (1) HOSE CONNECTION FOR CLEANING THE ARE






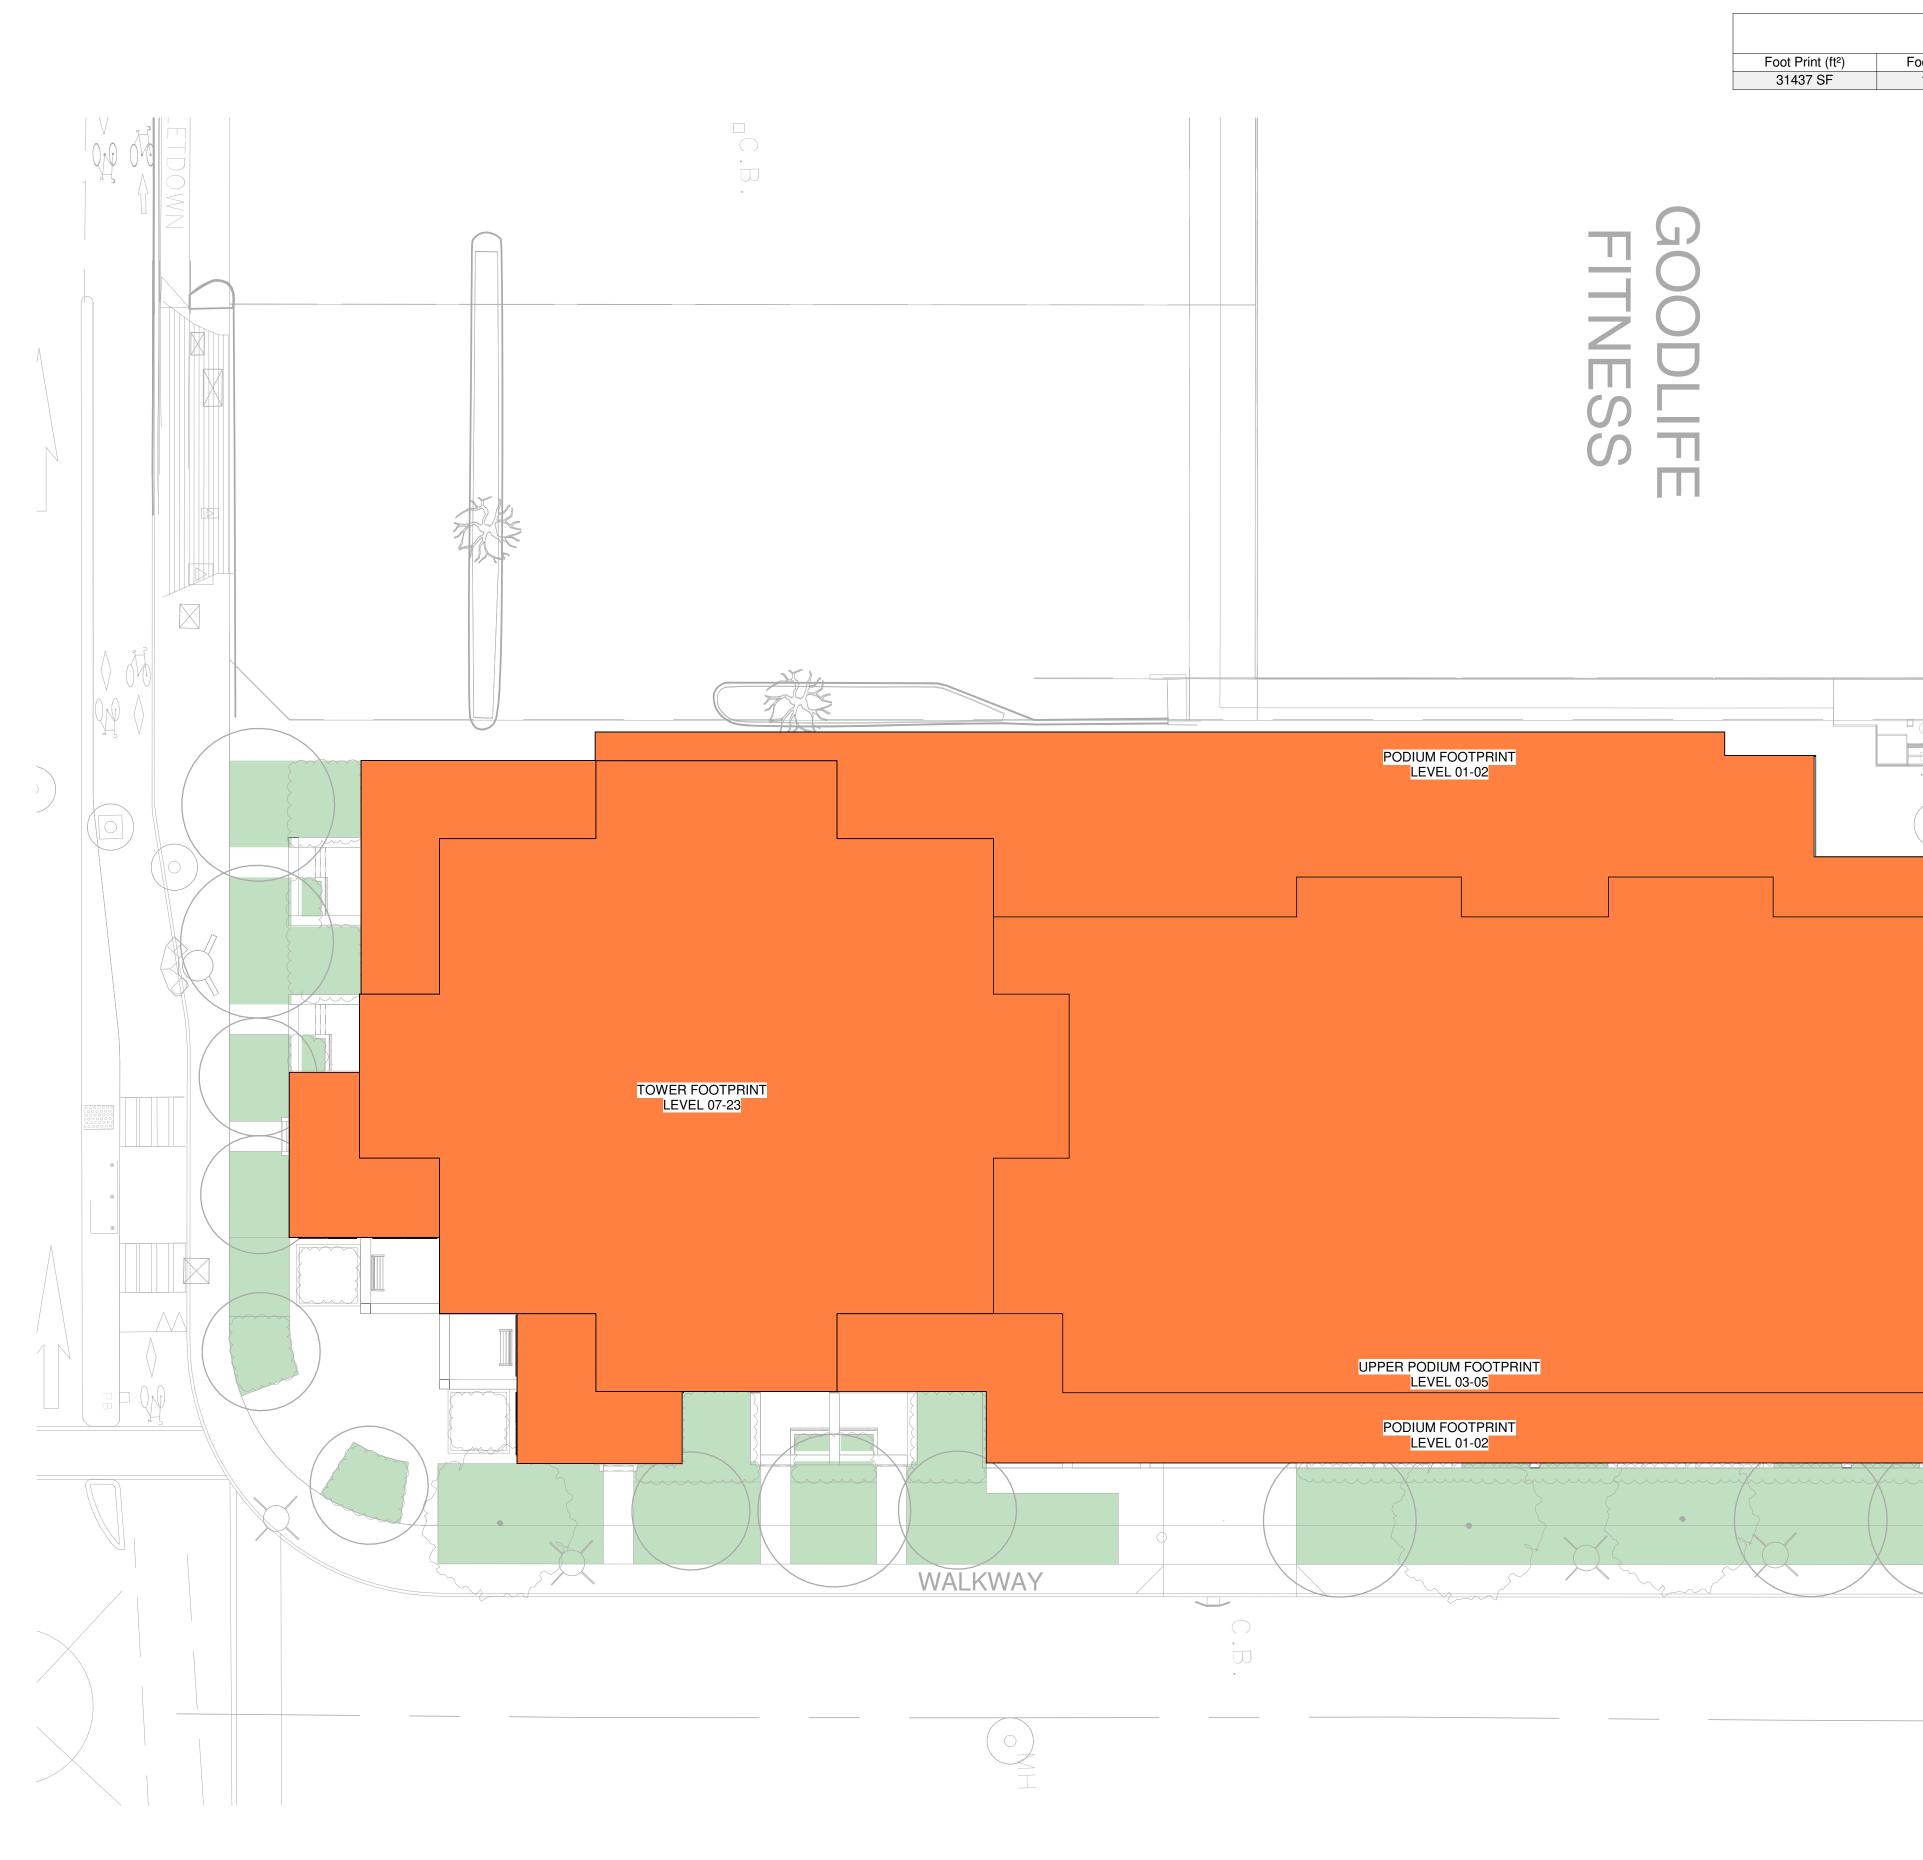

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Site Coverage Calculation Foot Print (m²) Gross Site Area (m²) Site Coverage % Max Lot Coverage % 17523 m² 79157 m² 22.1% 75%	
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	No. DESCRIPTION DATE A Development Permit Dec' 2023
CENTRELINE B.	SEAL
	PRIME CONSULTANT PRIME CONSULTANT 1353 Ellis Street - Suite 202 Kelowna BC V1Y 129 Canada tel 250 980 3432 www.arcadis.com PROJECT 1835 Gordon Dr, Kelowna, BC V1Y 3H5
1 SITE PLAN - SITE DP0.10 SCALE: 1/16" = 1'-0"	COVERAGE True North Project North

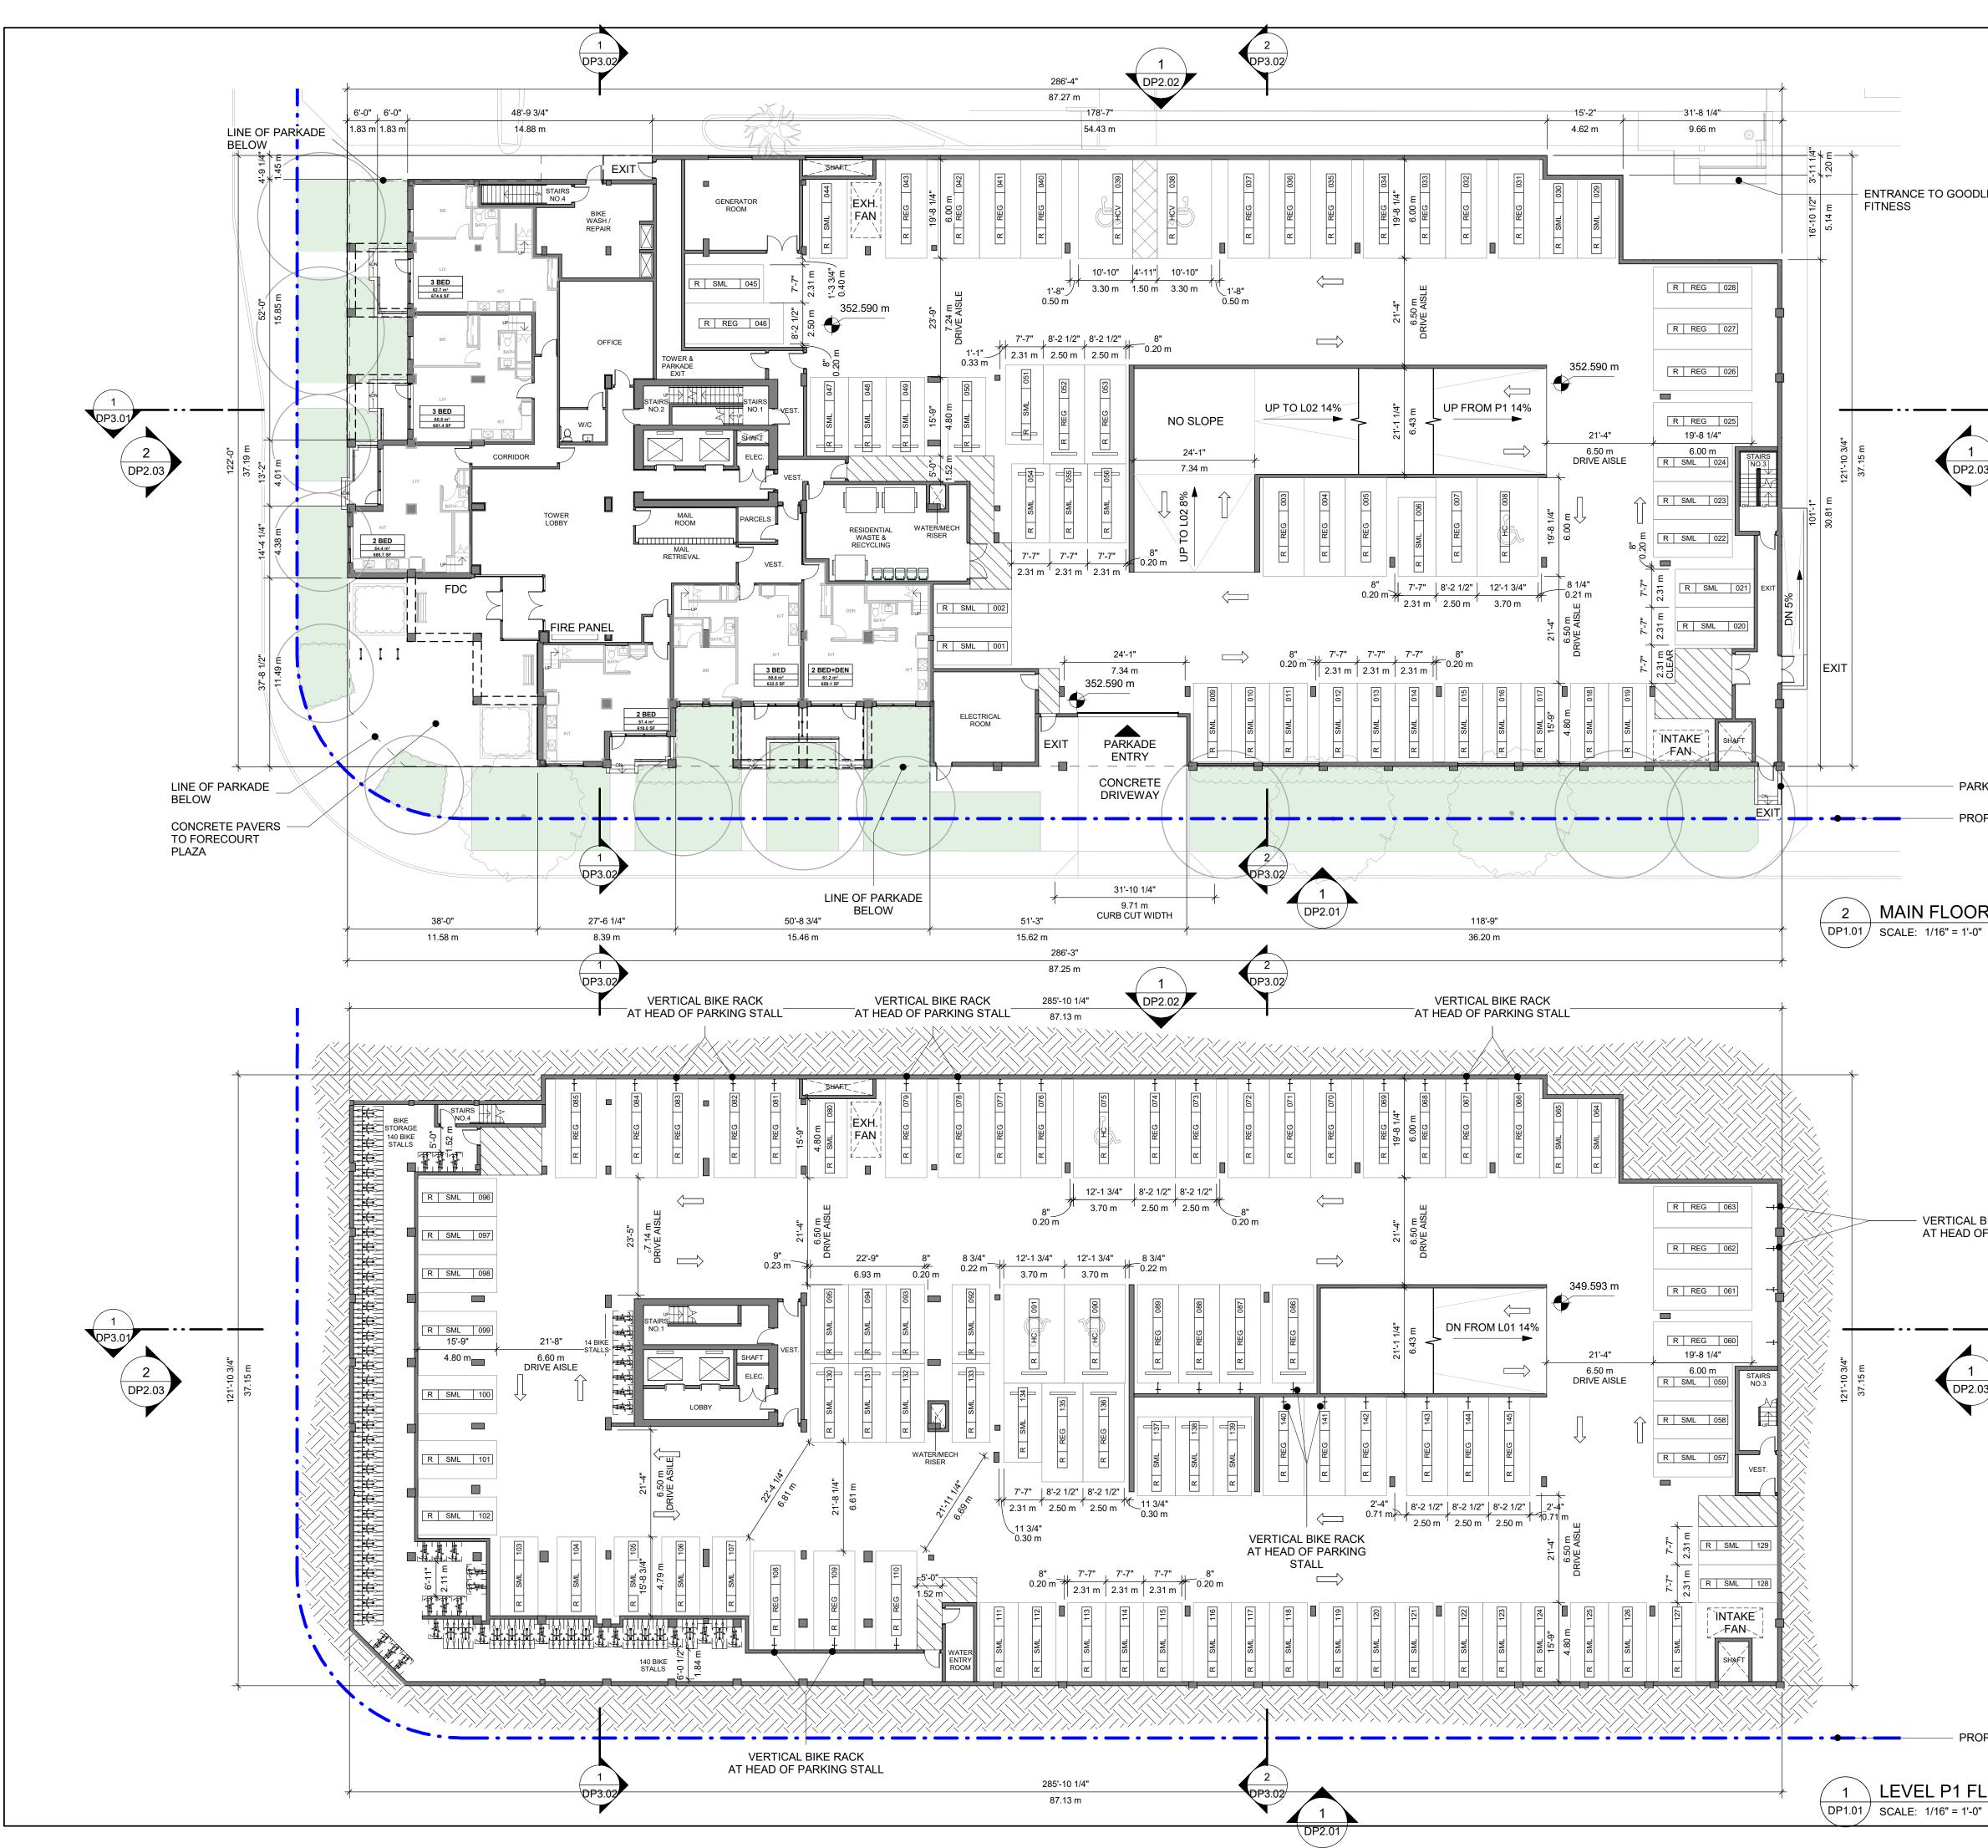

CE TO GOODLIFE	

Phase 1 Parking - L	evel 01
-	
Parking Stalls:	214
Van Accessible Stall	2
Small Stall	12′
Regular Stall	85

Parking Stall Type:


Accessible Stall

Parking Stall Type:	Count	
Accessible Stall	1	
Regular Stall	22	
Small Stall	31	
Van Accessible Stall	2	
Parking Stalls	56	

Phase 1 Parking - Overall

Count

CLIENT

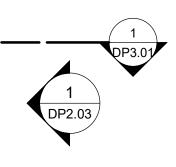


- PARKADE EXIT

PROPERTY LINE

2 MAIN FLOOR PLAN

Phase 1 Parking - Level P1	
Parking Stall Type:	Count
Accessible Stall	3
Regular Stall	37
Small Stall	49
Parking Stalls	89

VERTICAL BIKE RACK AT HEAD OF PARKING STALL

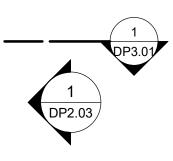

PROPERTY LINE	

GSL Group
GSL
G R O U P 88 E Pender St Unit 500, Vancouver, BC V6A 3X3
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A Development Permit Dec' 2023 B Development Permit Jan' 2024 Re-Submission Jan' 2024
SEAL
1353 Ellis Street - Suite 202 Kelowna BC V1Y 1Z9 Canada tel 250 980 3432 www.arcadis.com
PROJECT Capri Tower 1 1835 Gordon Dr, Kelowna, BC V1Y 3H5
PROJECT NO:

CHECKED BY:

APPROVED BY:

ISSUE

В

GM

LEVEL P1 & MAIN FLOOR PLAN

DP1.01

125701

GM

True North


Project North


DRAWN BY:

PROJECT MGR:

SHEET TITLE


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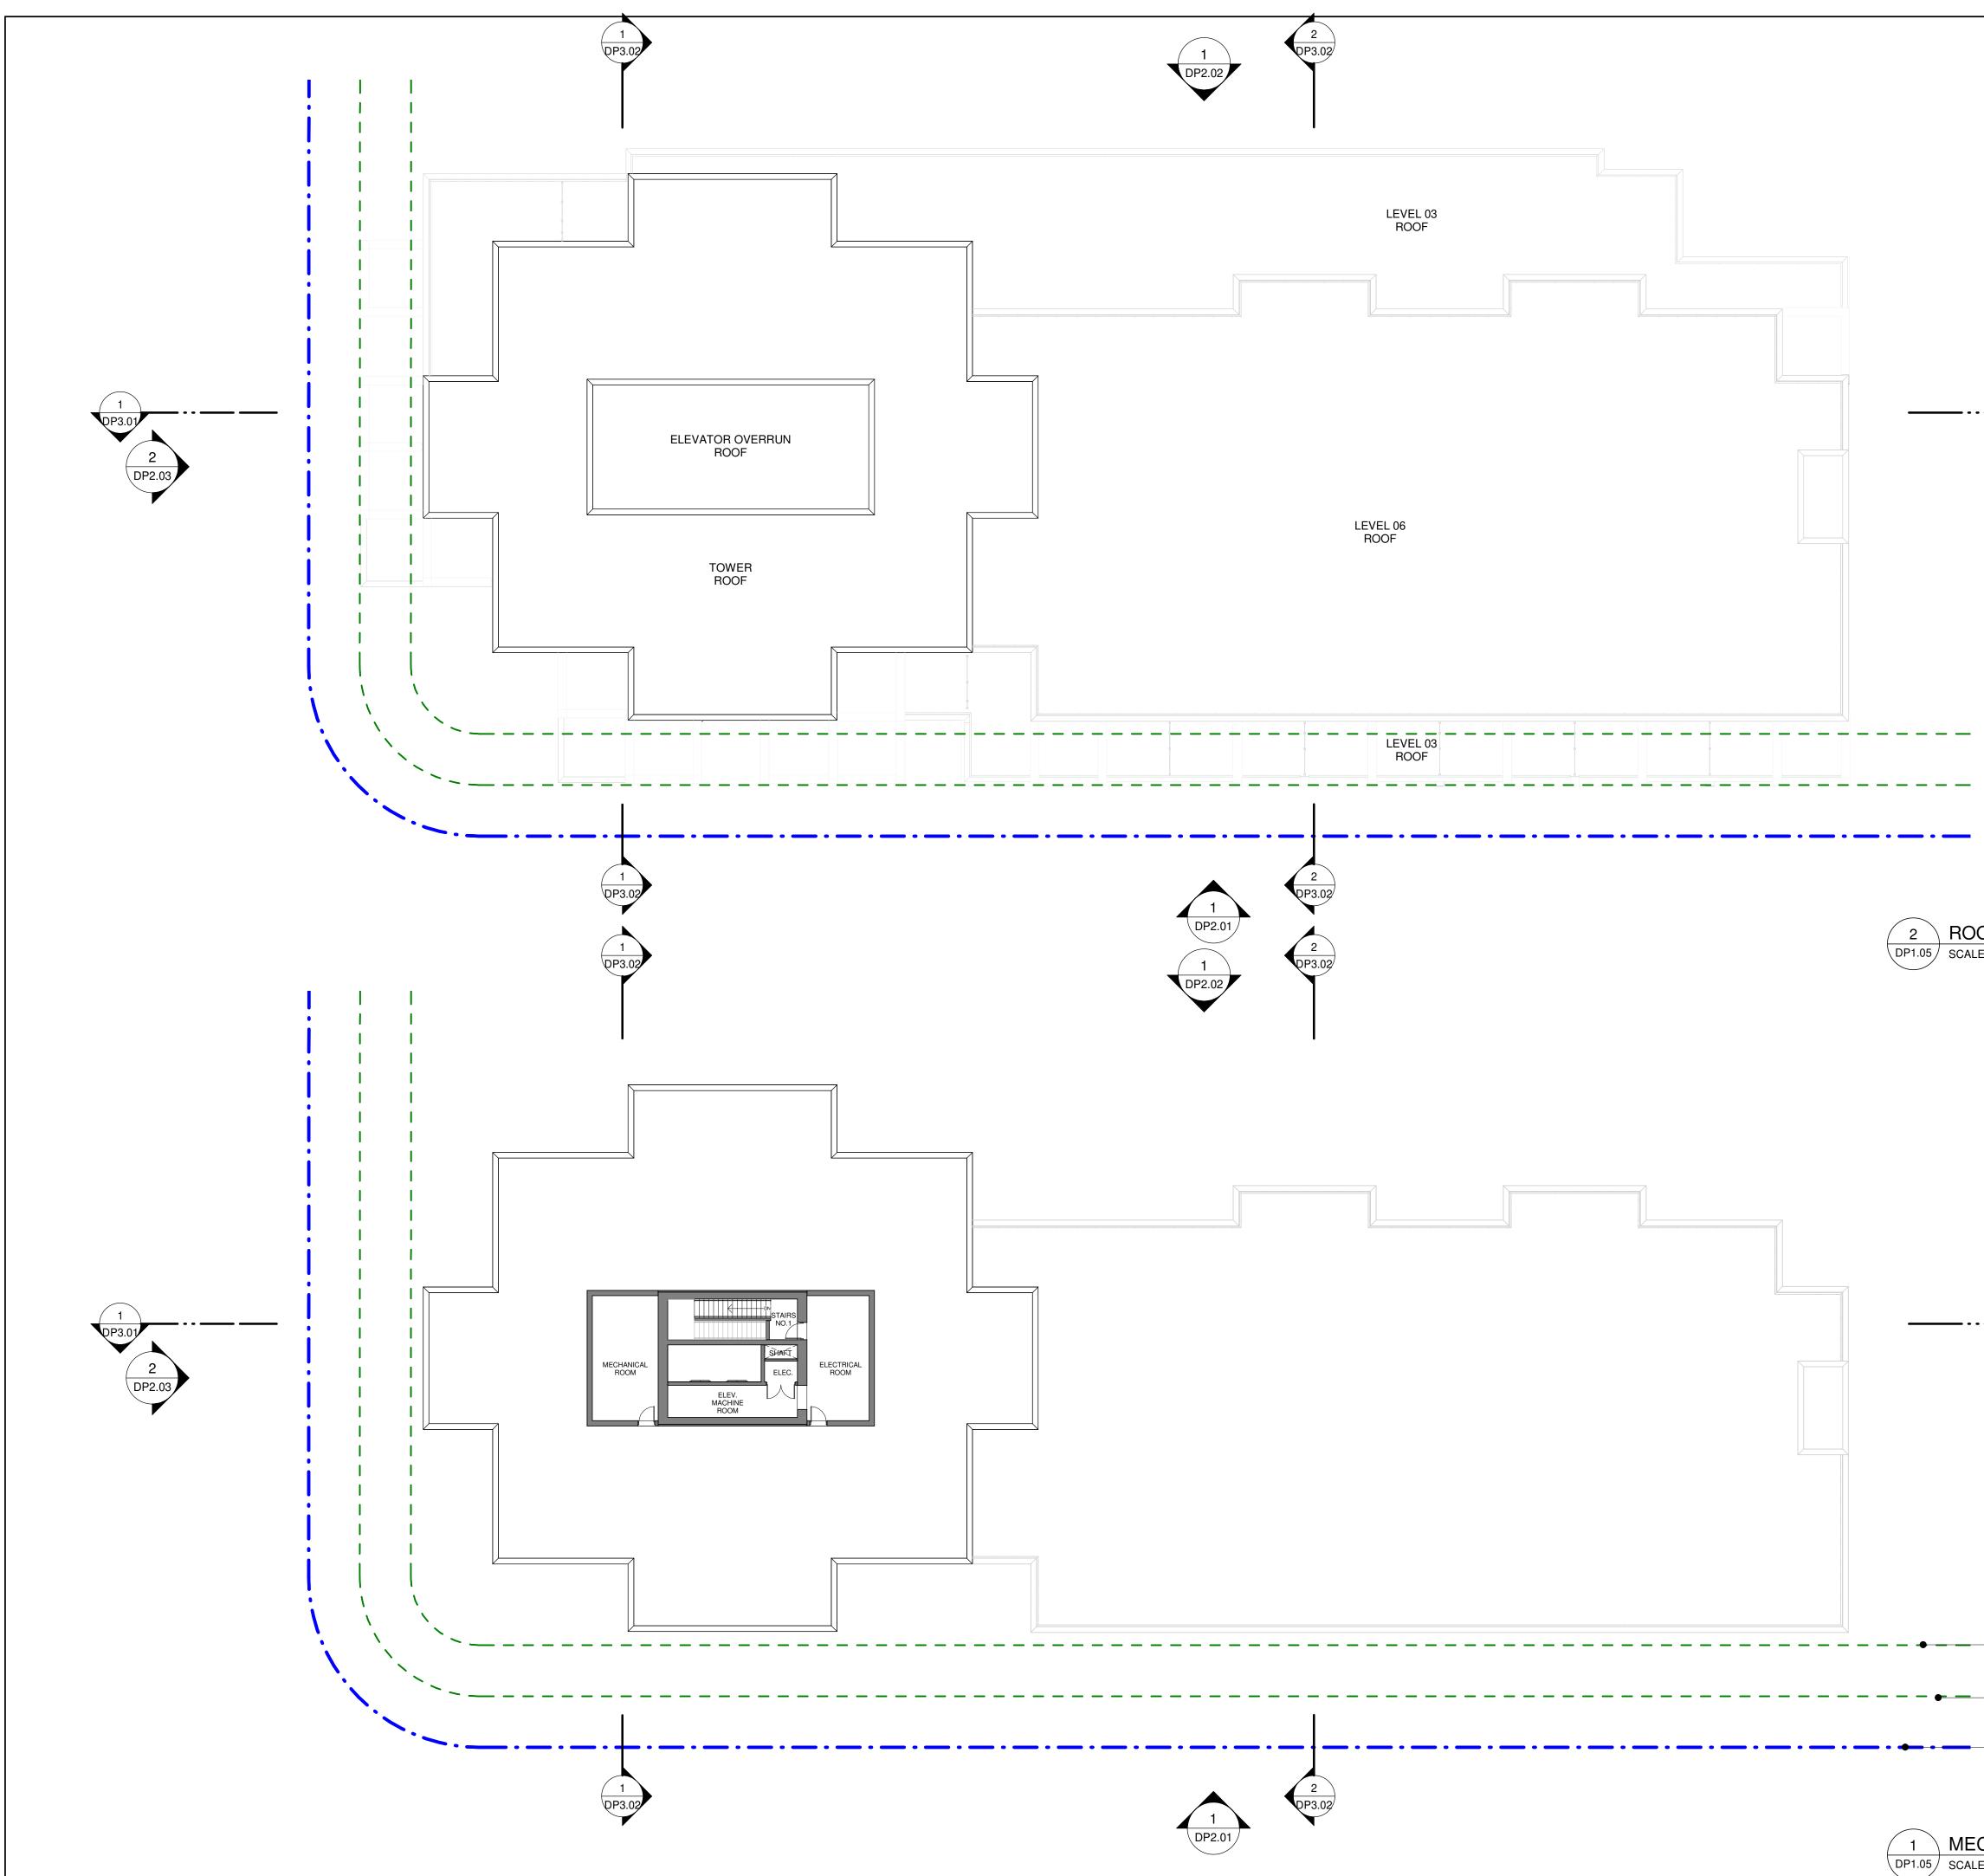


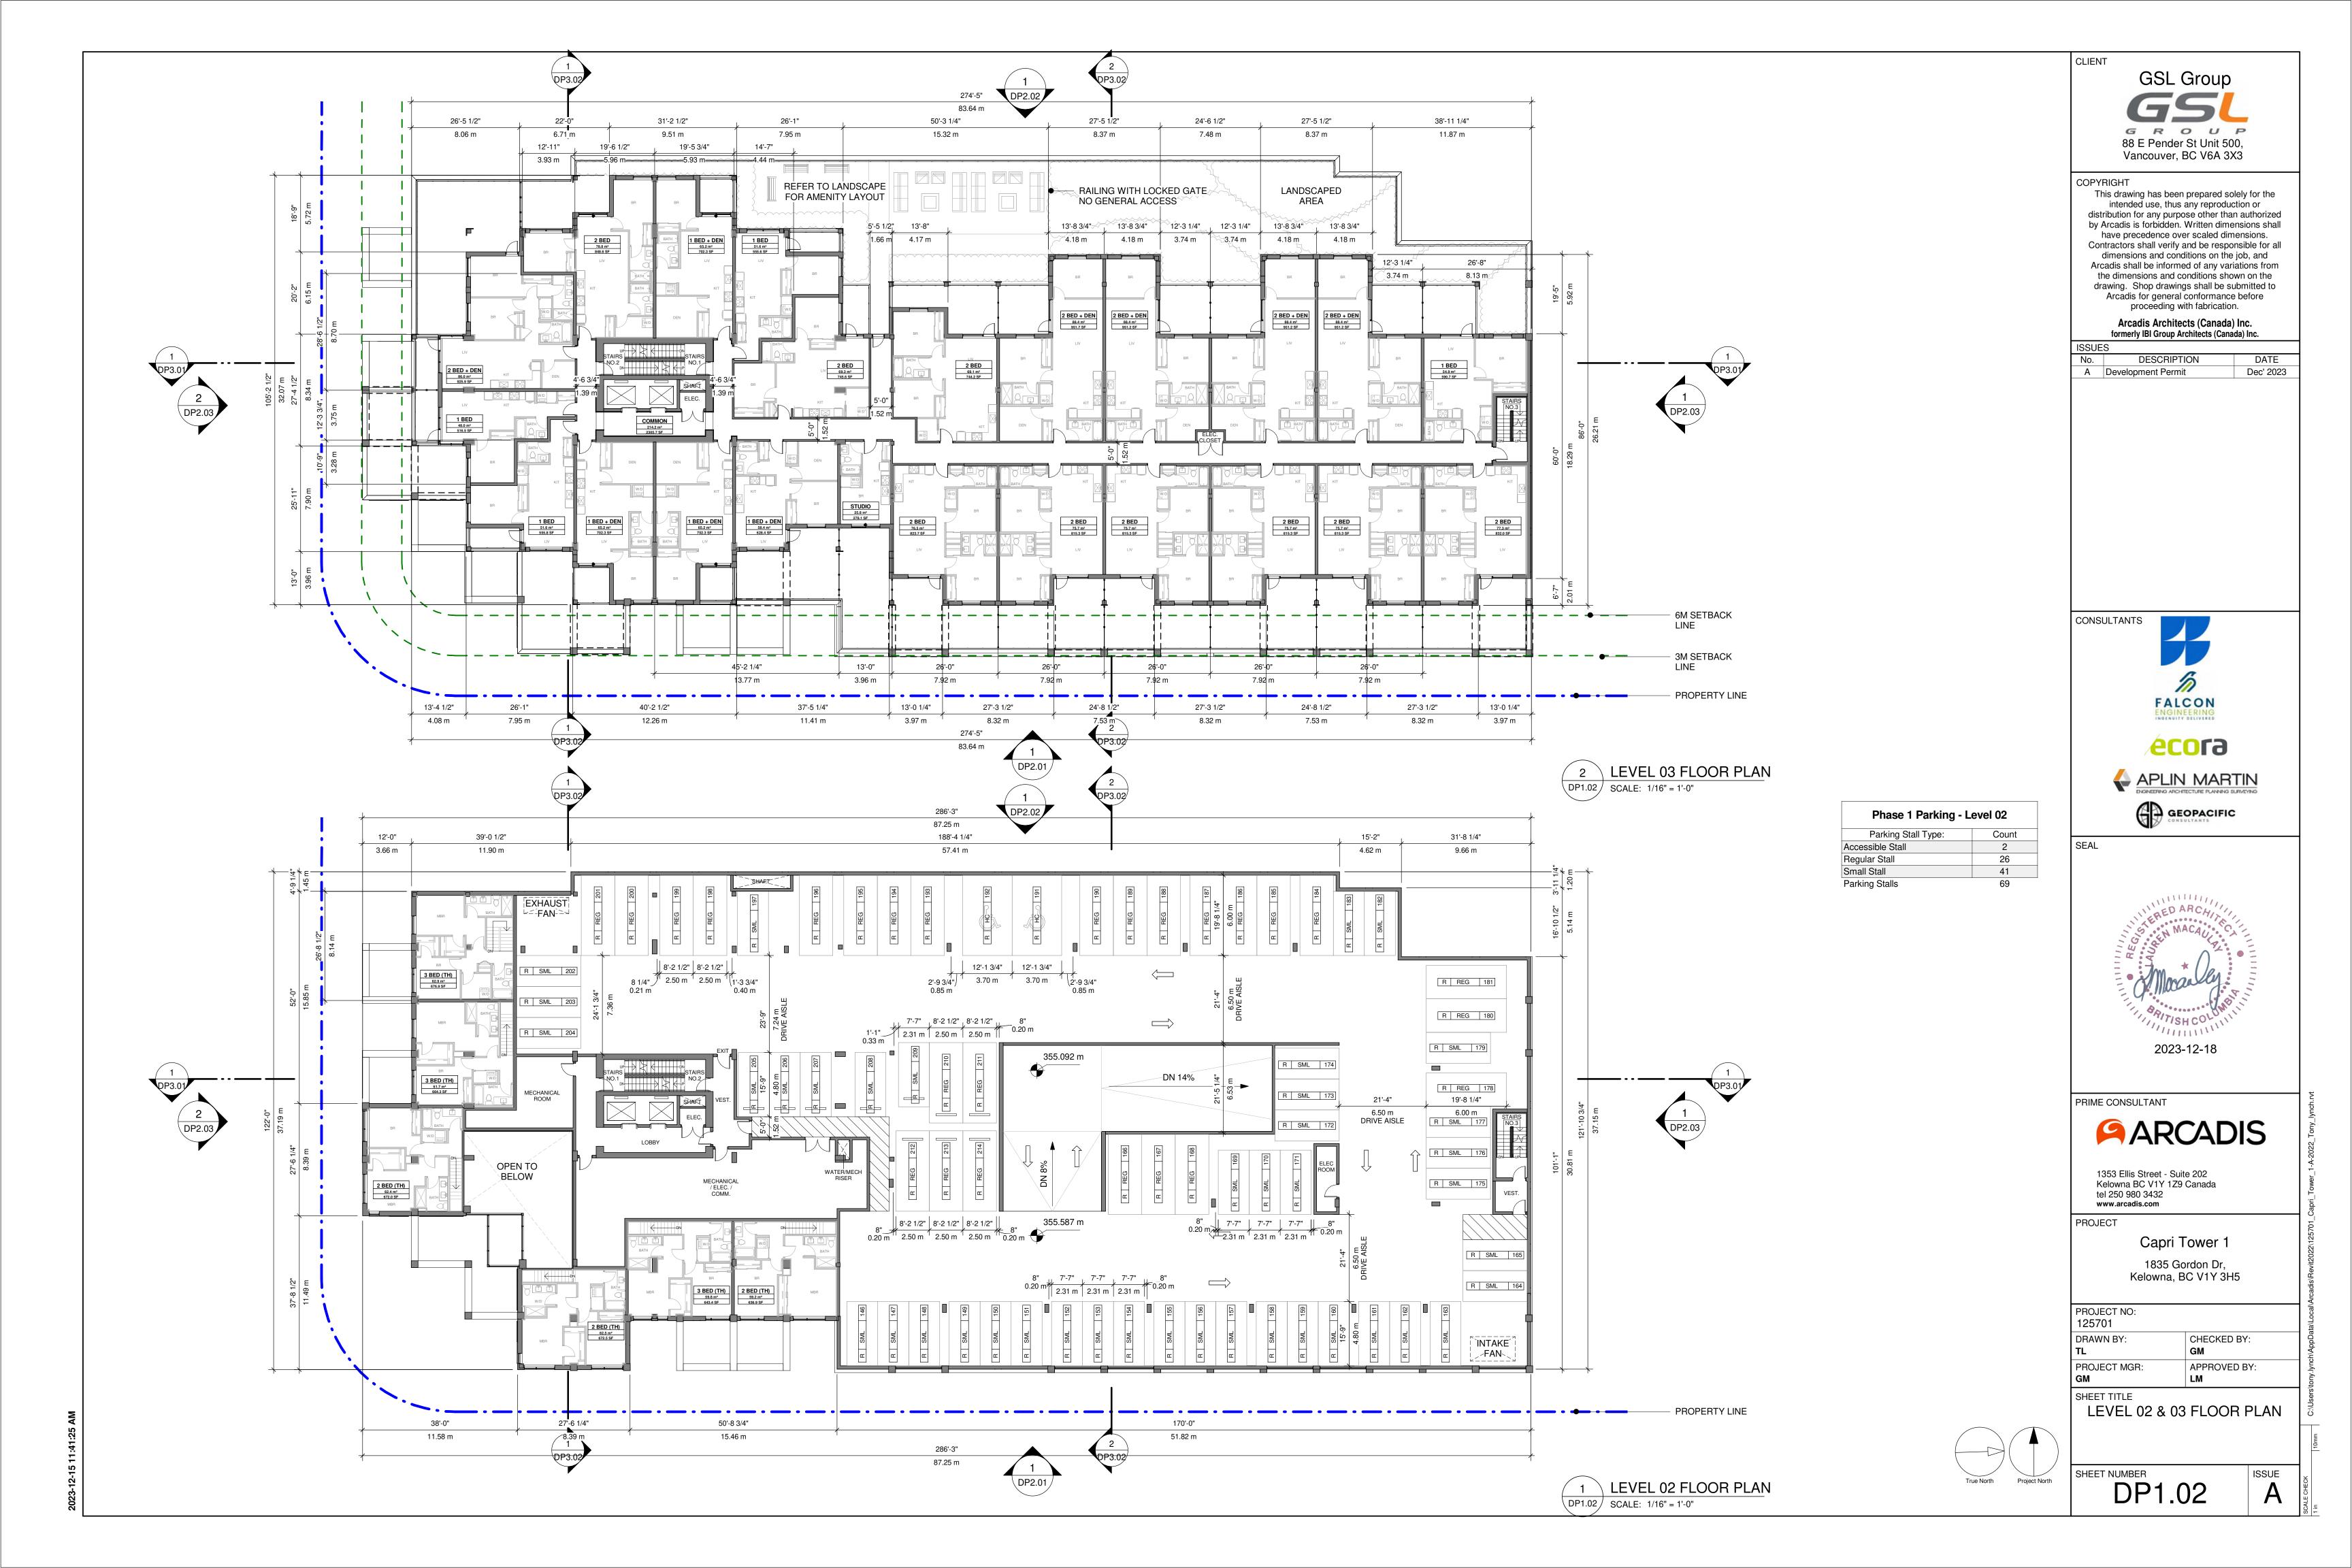	GSL Group GSL Group 88 E Pender St Unit 500, Vancouver, BC V6A 3X3
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	formerly IBI Group Architects (Canada) Inc. ISSUES
	No. DESCRIPTION DATE A Development Permit Dec' 2023
6M SETBACK LINE	CONSULTANTS
3M SETBACK LINE	
PROPERTY LINE	FALCON
VEL 06 FLOOR PLAN	ecora
E: 1/16" = 1'-0"	
	2023-12-18
	PRIME CONSULTANT PRIME CONSULTANT 1353 Ellis Street - Suite 202 Kelowna BC V1Y 1Z9 Canada tel 250 980 3432 www.arcadis.com
	PROJECT Capri Tower 1 1835 Gordon Dr, Kelowna, BC V1Y 3H5
6M SETBACK LINE	PROJECT NO: 125701 DRAWN BY: CHECKED BY:
3M SETBACK	TLGMPROJECT MGR:APPROVED BY:
PROPERTY LINE	GM LM SHEET TITLE LEVEL 04-05 & 06 FLOOR PLAN
VEL 04-05 FLOOR PLAN	True North Project North SHEET NUMBER ISSUE

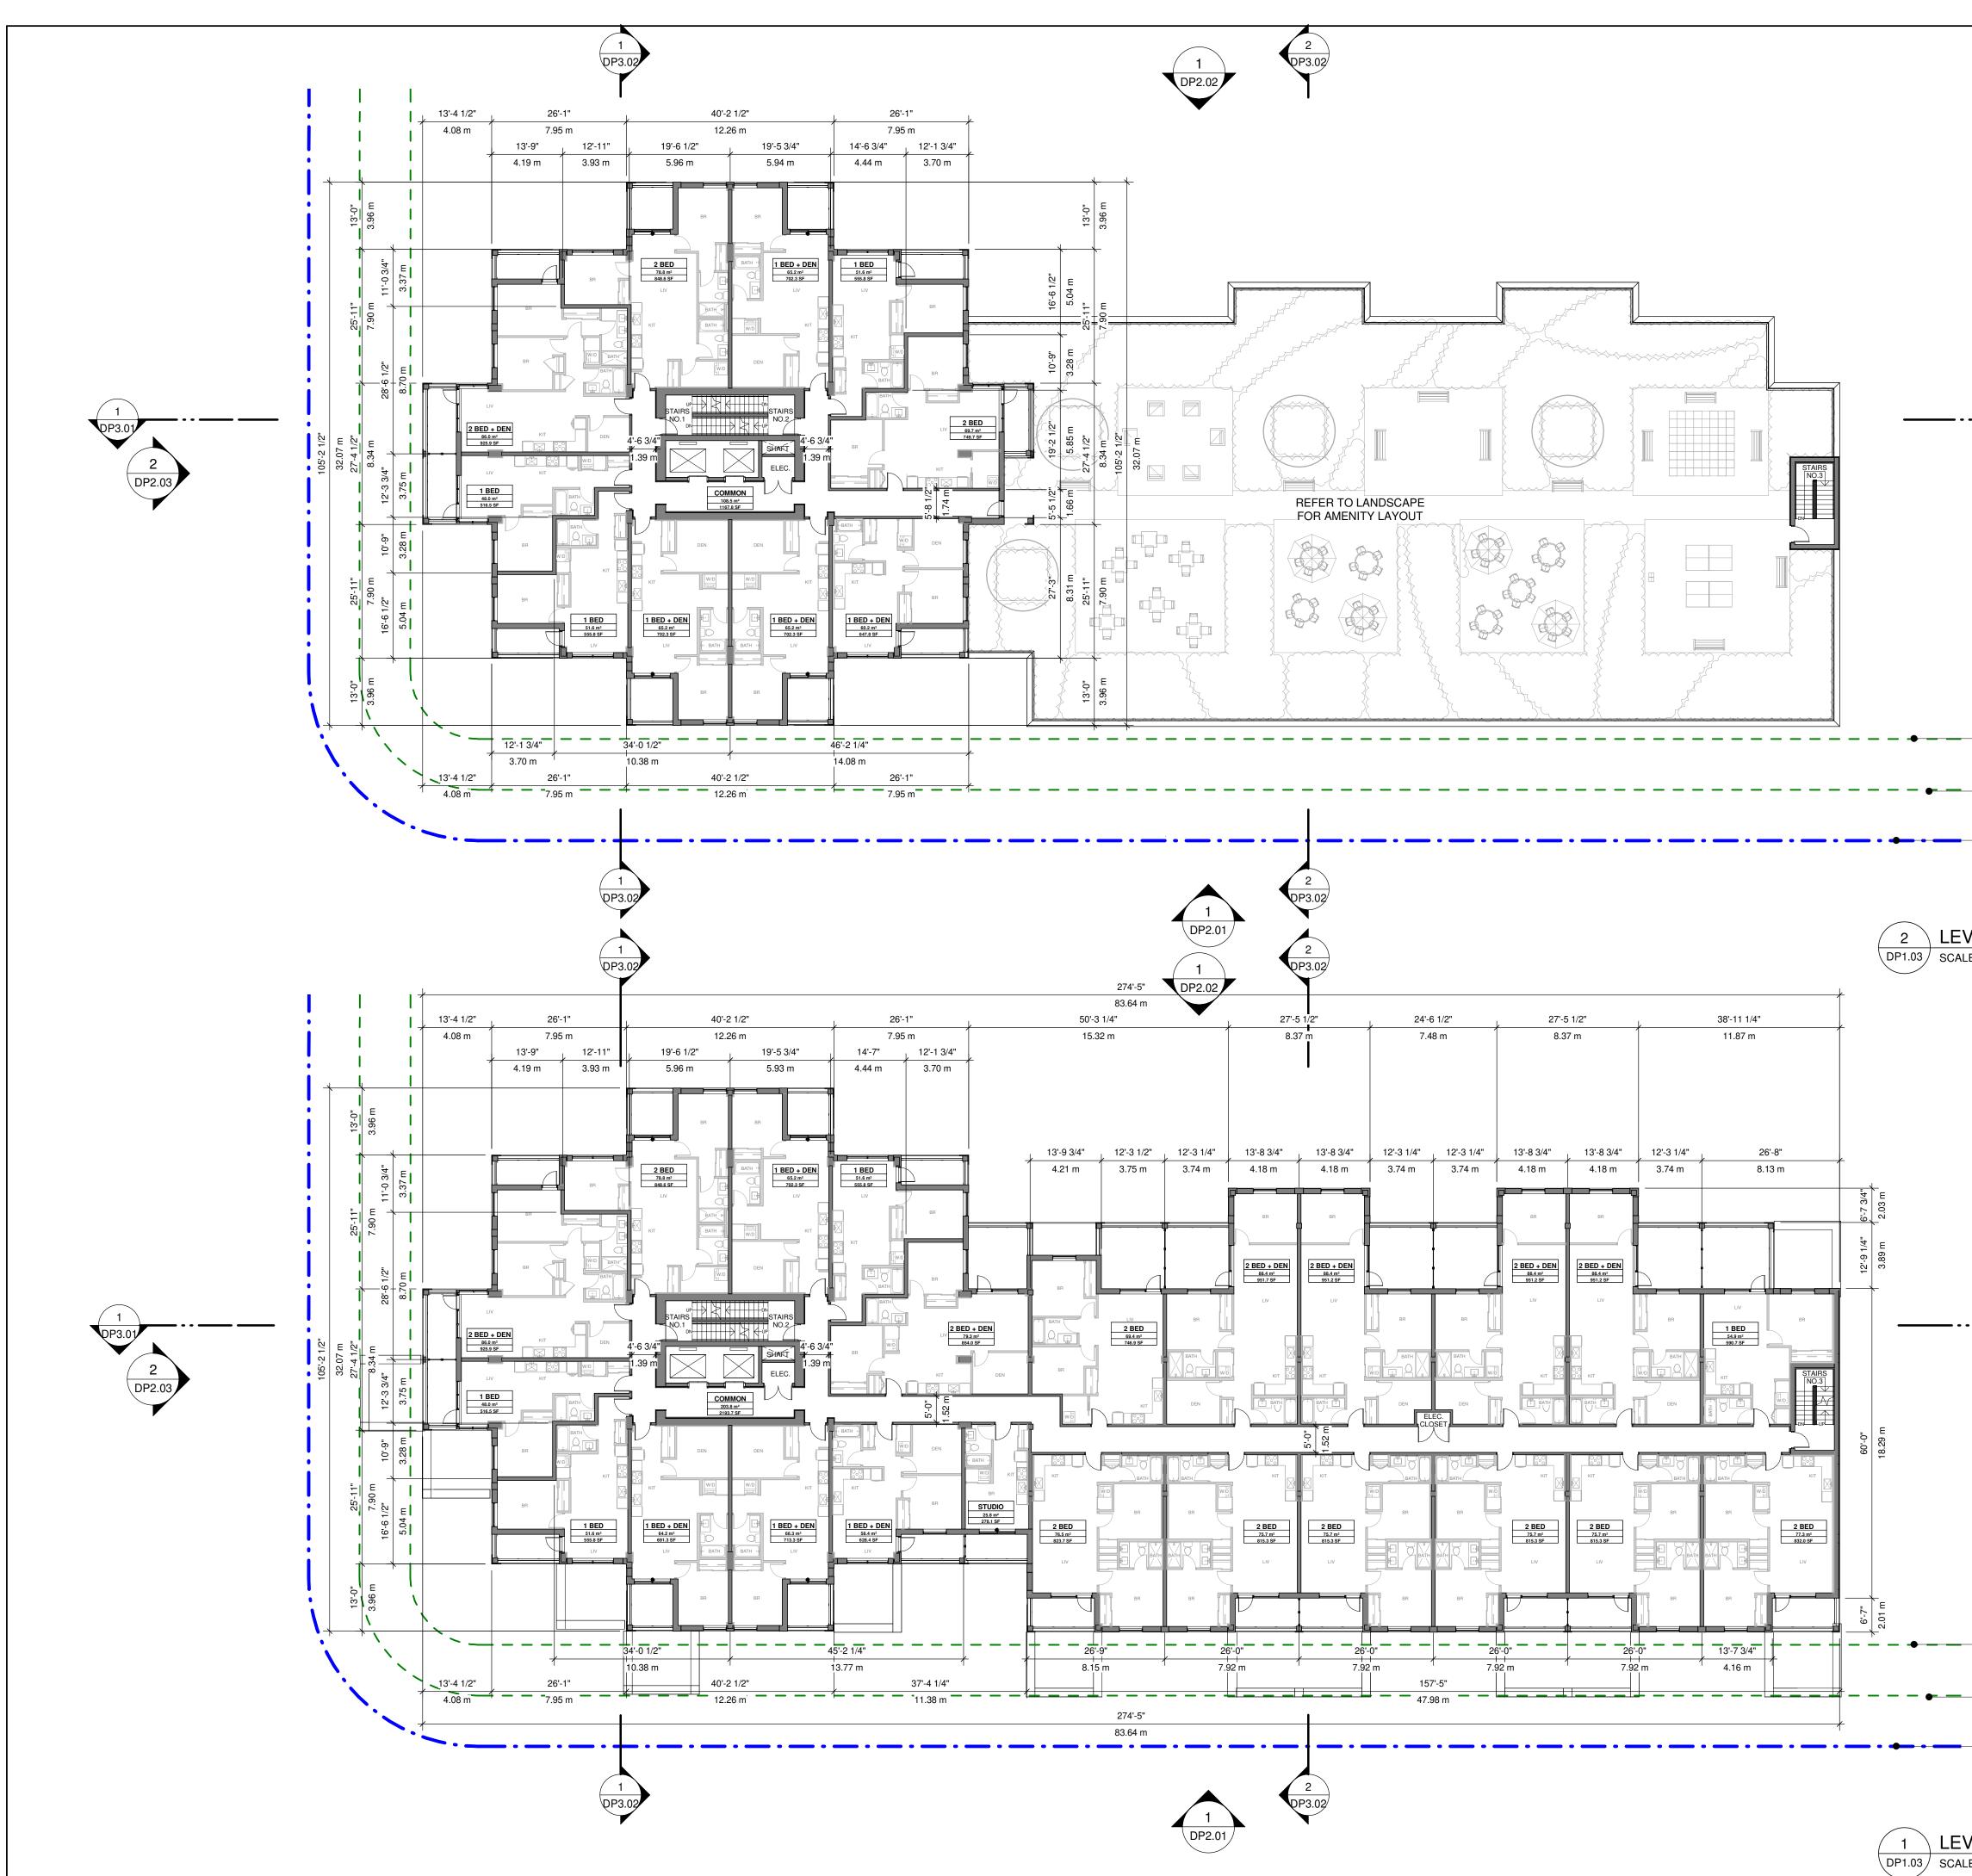CLIENT



	GSL Group	
		P
	88 E Pender St Unit 50 Vancouver, BC V6A 3>	
T disi by Co Art t	(RIGHT) his drawing has been prepared so intended use, thus any reproduct tribution for any purpose other that Arcadis is forbidden. Written dime have precedence over scaled dim ntractors shall verify and be respo dimensions and conditions on the cadis shall be informed of any vari he dimensions and conditions sho rawing. Shop drawings shall be su Arcadis for general conformance proceeding with fabrication	ction or n authorized ensions shall nensions. nsible for all job, and iations from wn on the ubmitted to before n.
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3M SETBACK LINE		
PROPERTY LINE	FALCON	
	ENGINEERING	
	ecora)	
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	GEOPACIFIC	:
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	AMarine Colored Colore	
	ECONSULTANT	
1 k te	353 Ellis Street - Suite 202 Kelowna BC V1Y 1Z9 Canada el 250 980 3432	IS
PROJ		
	Capri Tower 1	
	1835 Gordon Dr, Kelowna, BC V1Y 3H	5
	ECT NO:	
6М SETBACK 1257		BY
TL	ECT MGR: CHECKED	
3M SETBACK GM		
	EVEL 07-22 & 23 PH	FLOOR
	PLAN	
SHEE	T NUMBER	ISSUE
True Neuth Dustent Neuth		A
VEL 07-22 FLOOR PLAN LE: 1/16" = 1'-0"	DP1.04	

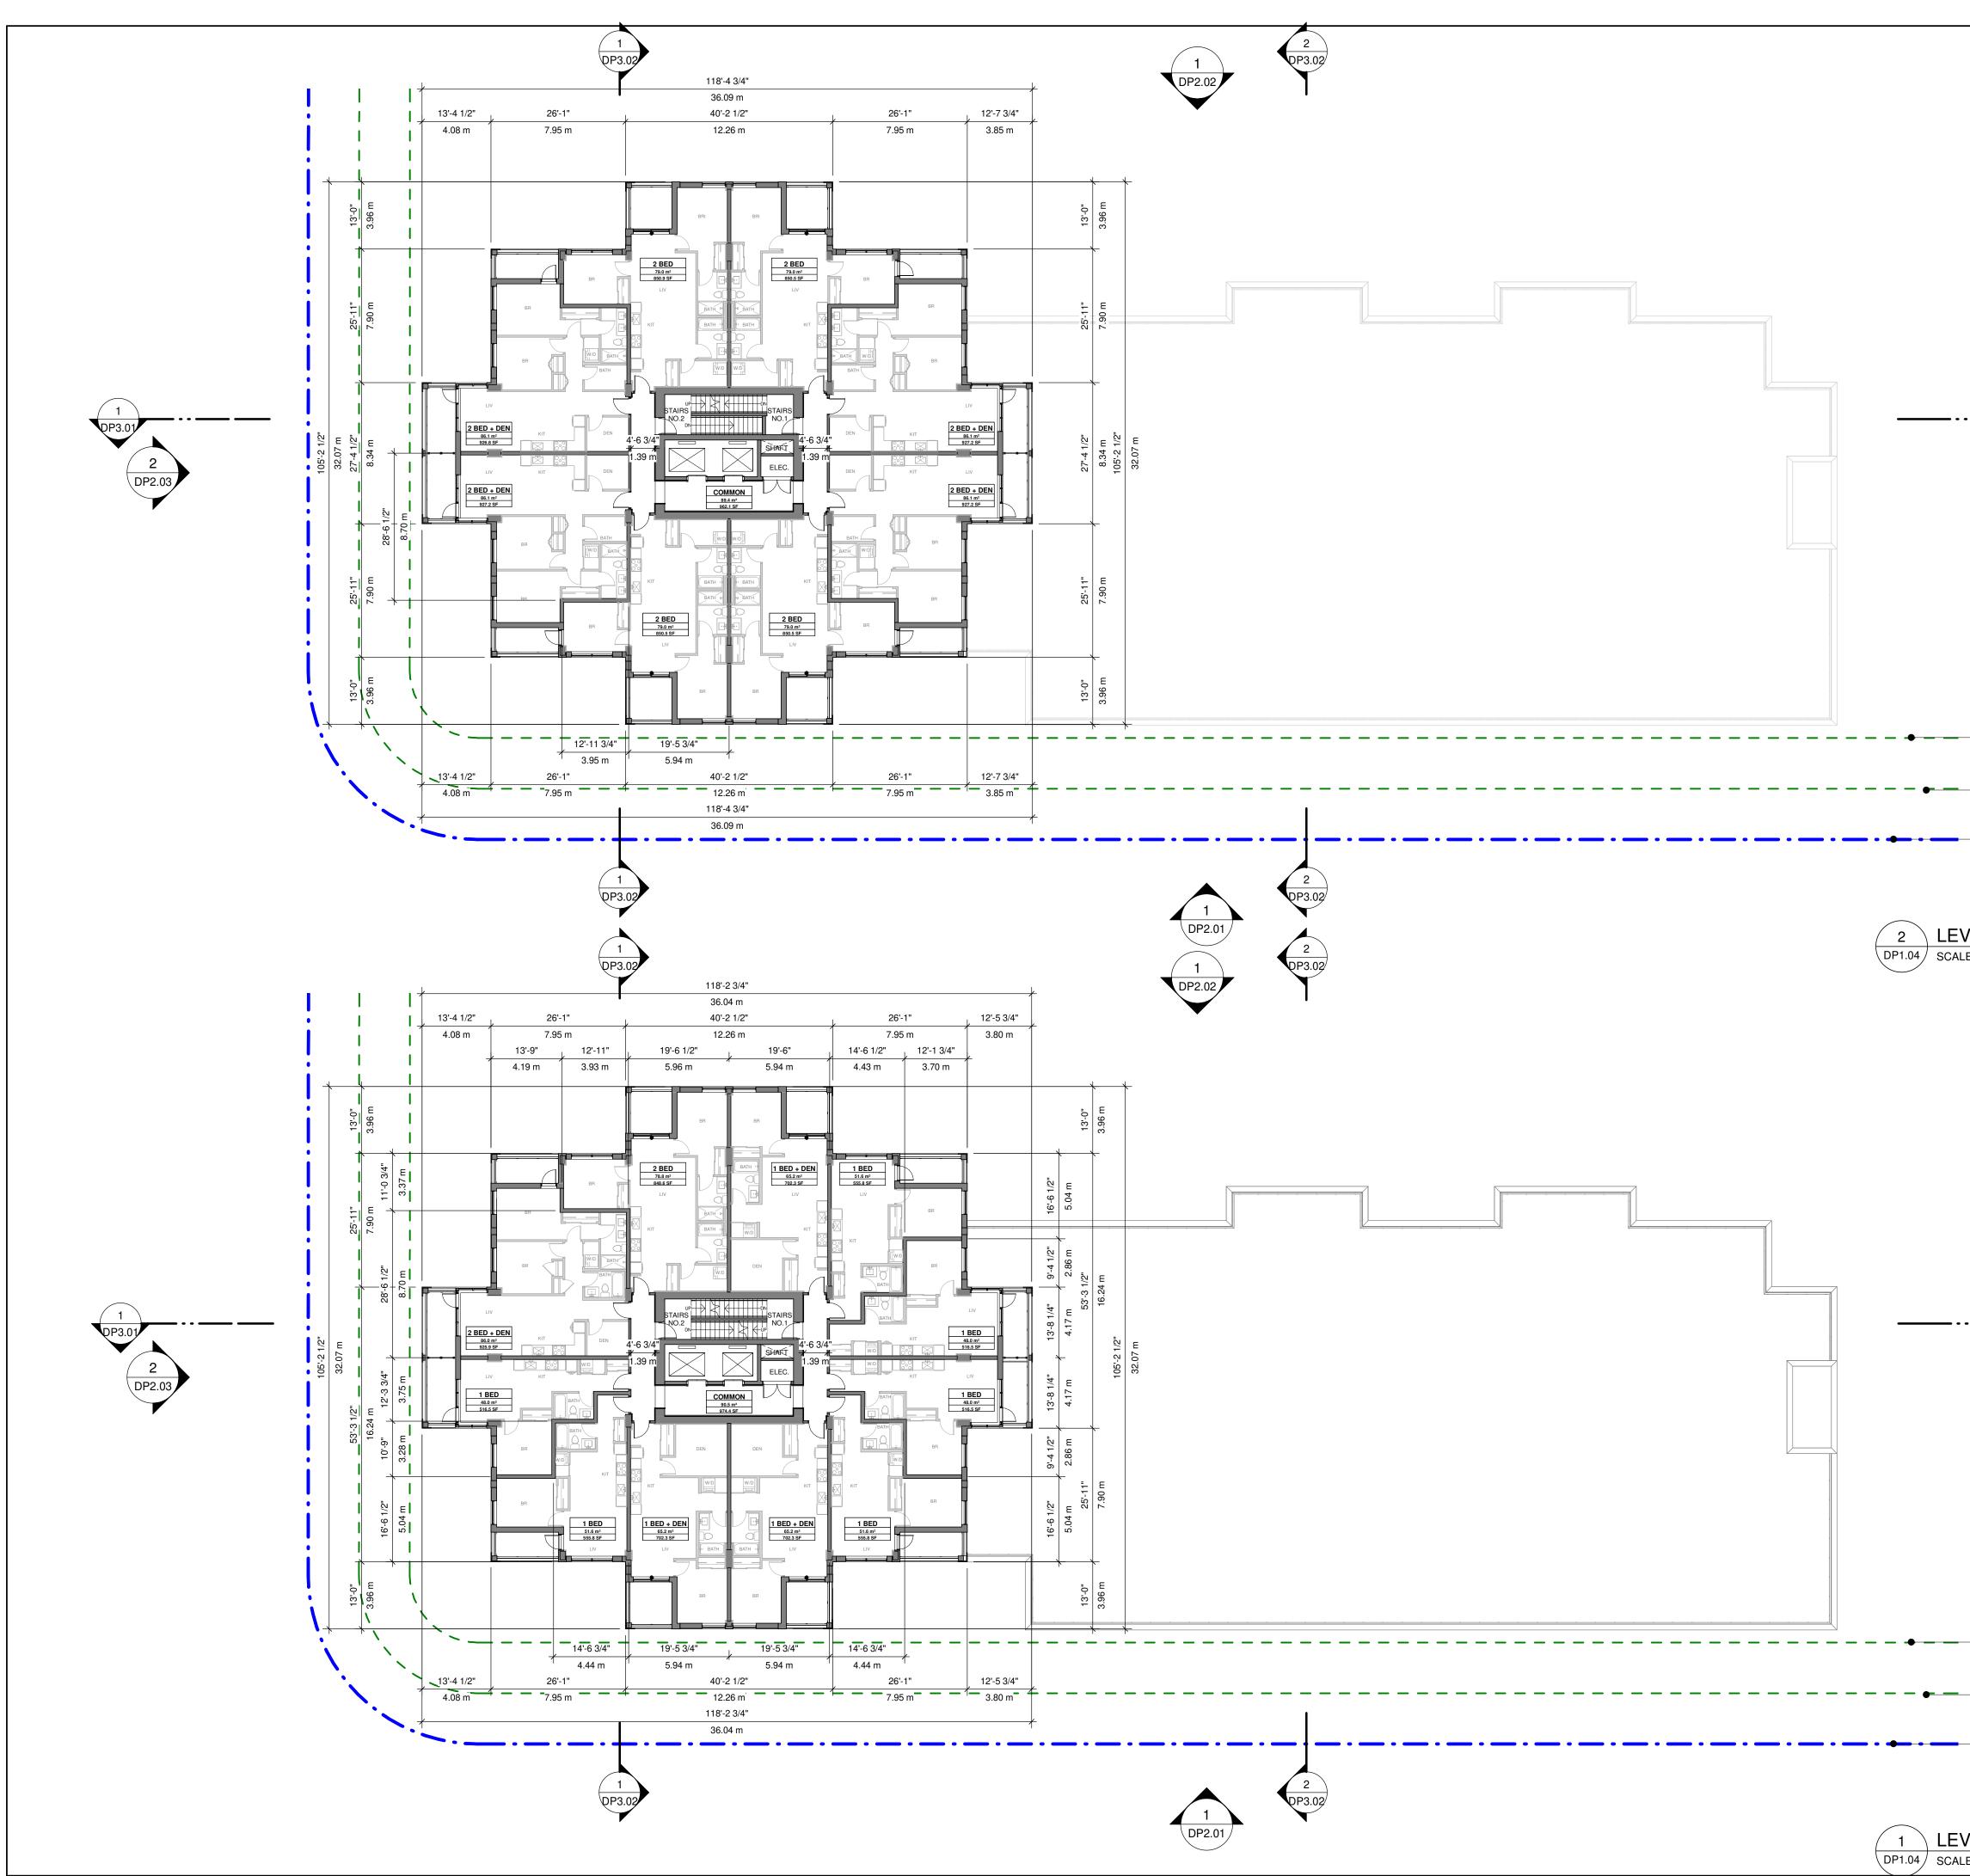

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	GSL Group
	GS
	BROUP 88 E Pender St Unit 500,
	Vancouver, BC V6A 3X3 COPYRIGHT This drawing has been prepared solely for the intended use, thus any reproduction or distribution for any purpose other than authorized by Arcadis is forbidden. Written dimensions shall have precedence over scaled dimensions. Contractors shall verify and be responsible for all dimensions and conditions on the job, and Arcadis shall be informed of any variations from the dimensions and conditions shown on the drawing. Shop drawings shall be submitted to Arcadis for general conformance before proceeding with fabrication. Arcadis Architects (Canada) Inc. formerly IBI Group Architects (Canada) Inc. ISSUES No. DESCRIPTION DATE A Development Permit Dec' 2023
OF PLAN	
.E: 1/16" = 1'-0"	ENGINEERING ARCHITECTURE PLANNING BURVEYING GEOPACIFIC CONSULTANTS SEAL
1 DP3.01	2023-12-18
1 DP2.03	PRIME CONSULTANT PRIME CONSULTANT 1353 Ellis Street - Suite 202 Kelowna BC V1Y 1Z9 Canada tel 250 980 3432 www.arcadis.com
	PROJECT Capri Tower 1 1835 Gordon Dr, Kelowna, BC V1Y 3H5
6M SETBACK LINE	PROJECT NO: 125701 DRAWN BY: CHECKED BY:
3M SETBACK LINE	TLGMPROJECT MGR:APPROVED BY:GMLM
PROPERTY LINE	SHEET TITLE MECHANICAL PH & ROOF
CHANICAL PENTHOUSE PLAN	North Project North SHEET NUMBER ISSUE
E: 1/16" = 1'-0"	North Project North DP1.05 A




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			88 E Pender St Unit 500, Vancouver, BC V6A 3X3
			COPYRIGHT
	4a SPANDREL PANEL - BLUE V	W/ CHARCOAL FRAME	This drawing has been prepared solely for the intended use, thus any reproduction or distribution for any purpose other than authorized
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	8a METAL PANEL - WHITE		dimensions and conditions on the job, and Arcadis shall be informed of any variations from the dimensions and conditions shown on the
	8b METAL PANEL - GREY		drawing. Shop drawings shall be submitted to Arcadis for general conformance before proceeding with fabrication.
	9a EIFS - GREY		Arcadis Architects (Canada) Inc. formerly IBI Group Architects (Canada) Inc.
	11a LOUVRE PANEL - GREY		ISSUES No. DESCRIPTION DATE
ROOF 1392.79	11b LOUVRE PANEL - BROWN		A Development Permit Dec' 2023
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EVEL 22 1363.29			
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EVEL 21 (1353.46) 412.534 m GEODETIC	22a ALUMINIUM CAPPING - DAR	RK GREY	
EVEL 20 1343.62 409.537 m GEODETIC			
EVEL 19 1333.79			CONSULTANTS
406.54 m GEODETIC			
<u>EVEL 18 (1323.96)</u> 403.542 m GEODETIC			h
EVEL 17 1314.12 400.545 m GEODETIC			FALCON
EVEL 16 1304.29	······		écora
397.548 m GEODETIC			
EVEL 15 (1294.46) 394.551 m GEODETIC			
EVEL 14 1284.62			CONSULTANTS
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EVEL 08 1225.62			
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370.573 m GEODETIC			ARCADIS
EVEL 06 1205.96 367.576 m GEODETIC			
EVEL 05 1196.12			1353 Ellis Street - Suite 202 Kelowna BC V1Y 1Z9 Canada tel 250 980 3432
364.579 m GEODETIC EVEL 04 1186.29			www.arcadis.com PROJECT
361.582 m GEODETIC			Capri Tower 1
EVEL 03 1176.46 358.584 m GEODETIC			PRIME CONSULTANT PRIME CONSULTANT SHEET TITLE EAST ELEVATION
EVEL 02 1166.62			PROJECT NO:
355.587 m GEODETIC			125701DRAWN BY:CHECKED BY:
<u>EVEL 01 (1156.79)</u> 352.59 m GEODETIC			TL GM PROJECT MGR: APPROVED BY:
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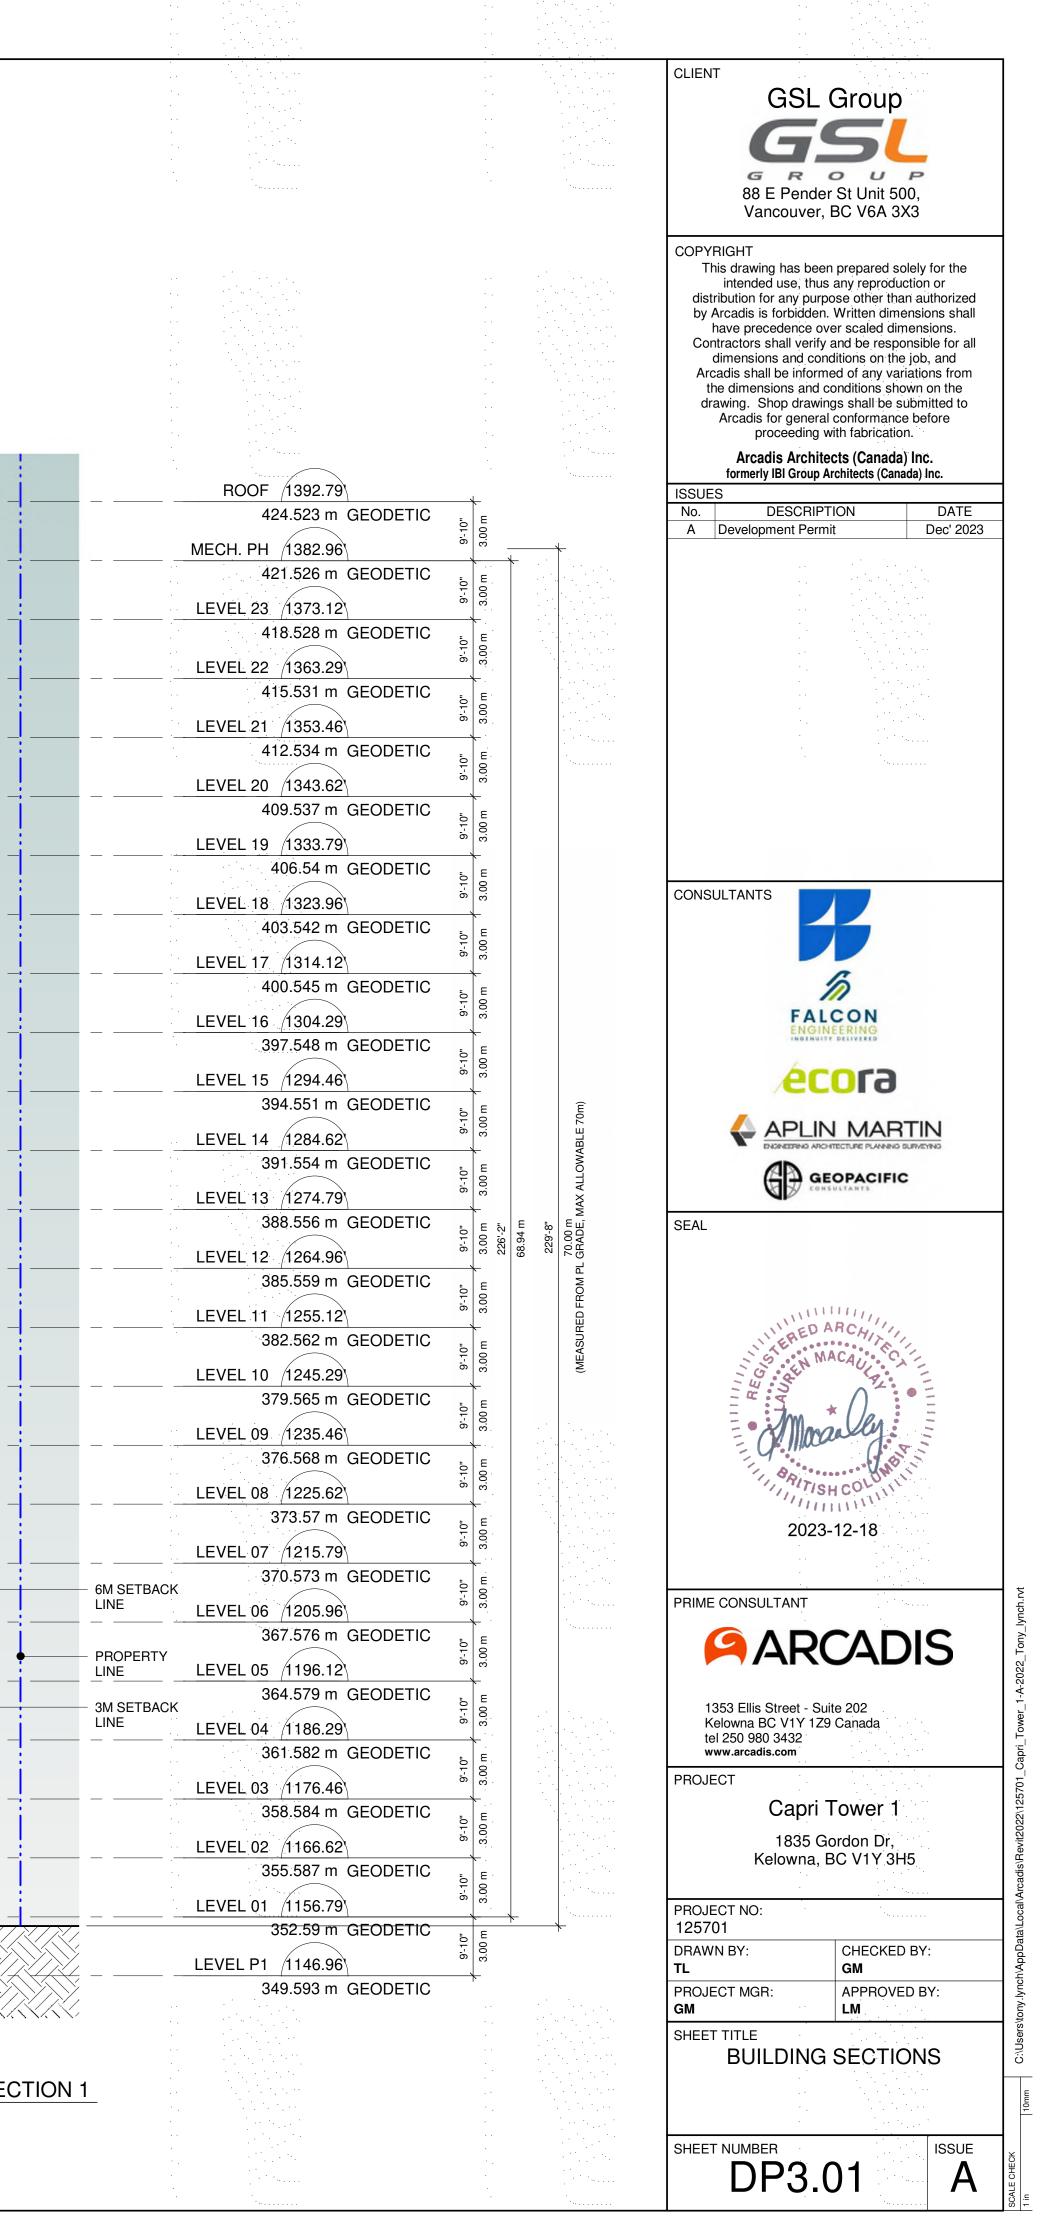
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		4a SPANDREL PAN	IEL - WHITE W/ CHA	RCOAL FRAME	Vancouver, BC V6A 3X3
					COPYRIGHT
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					by Arcadis is forbidden. Written dimensions shall have precedence over scaled dimensions.
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			·····		Arcadis shall be informed of any variations from the dimensions and conditions shown on the
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		11a LOUVRE PANEL	- GREY		ISSUES
					No. DESCRIPTION DATE A Development Permit Dec' 2023
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GEODETIC					1353 Ellis Street - Suite 202
	•••		· · ·		Kelowna BC V1Y 1Z9 Canada tel 250 980 3432
GEODETIC			· · ·		tel 250 980 3432 www.arcadis.com
			· .		PROJECT
GEODETIC	. ·				Capri Tower 1
	•				1835 Gordon Dr,
EODETIC	•		• •		Kelowna, BC V1Y 3H5
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		EL - BLUE W/ CHAR	COAL FRAME	COPYRIGHT This drawing has been prepare	
	7 GLASS RAILING	··· • · •		intended use, thus any repr distribution for any purpose other by Arcadis is forbidden. Written	oduction or than authorized dimensions shall
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1373.12 8.528 m GEODETIC		• .			
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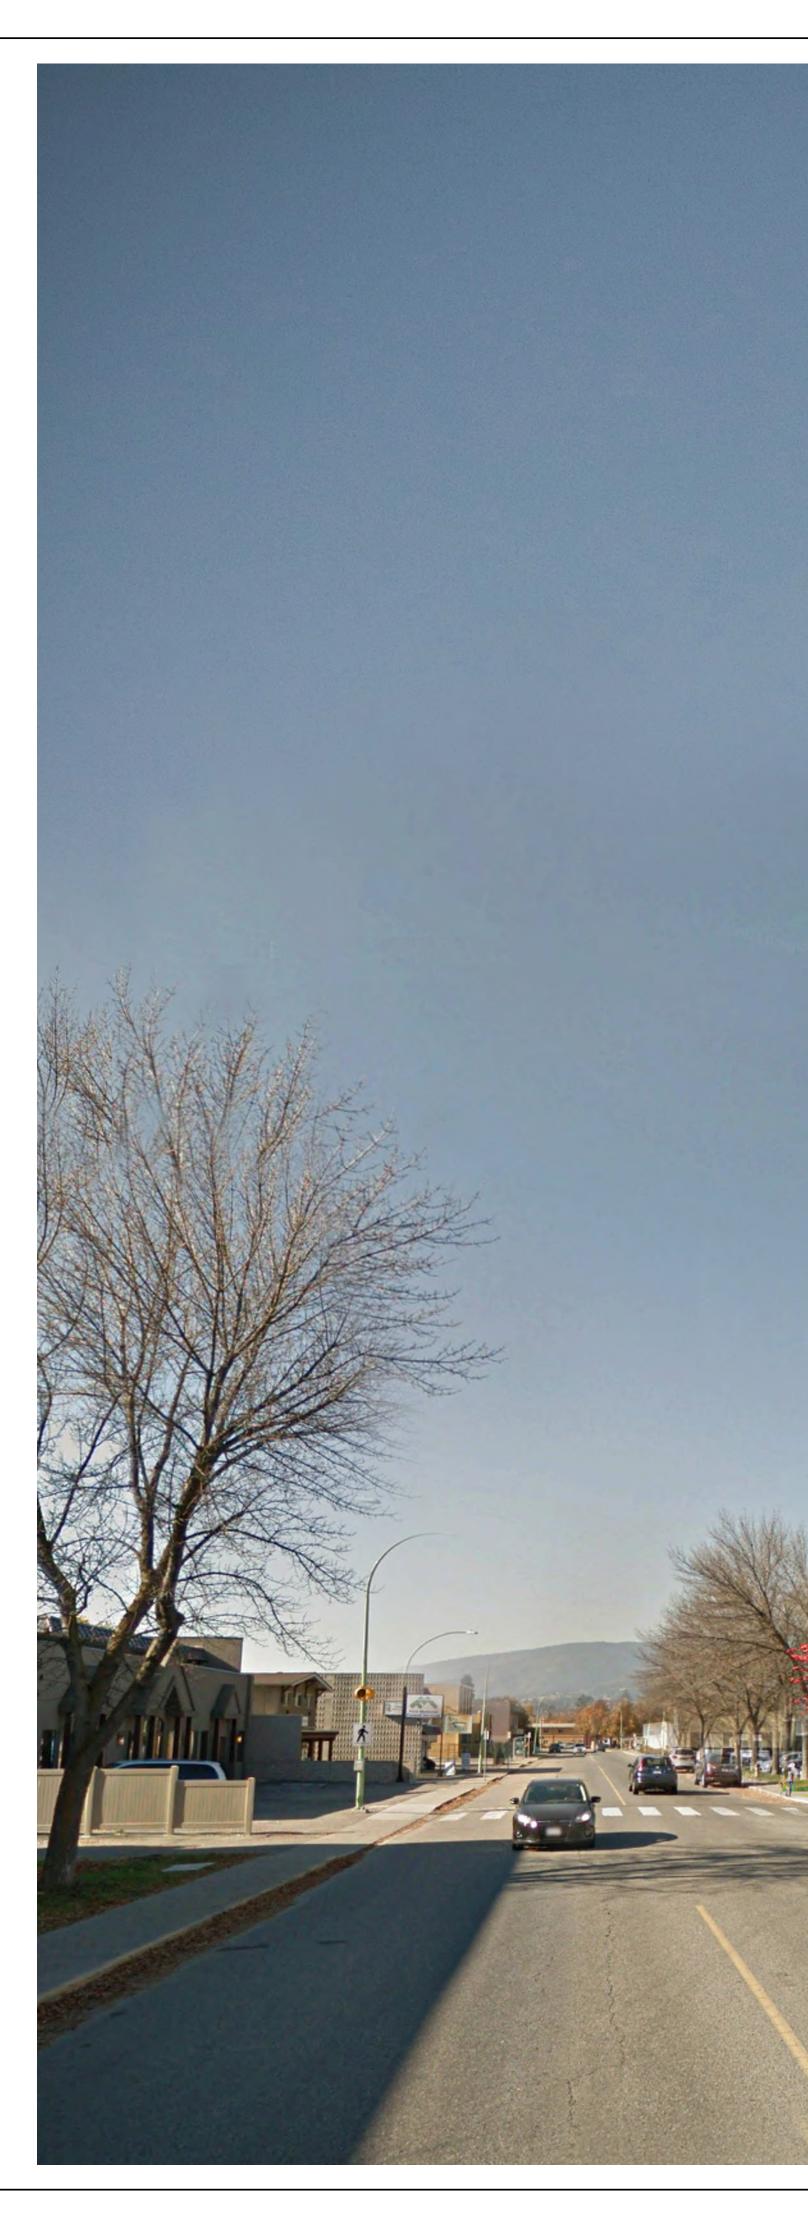




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6M SETBACK				
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52'-6" - Tall Building Regulations)	RESIDENTIAL UNIT	RESIDENTIAL UNIT		
Per Table 9.11 – T	PARAKDE LEVEL 02	RESIDENTIAL	PARAKDE LEVEL 02	
	PARAKDE LEVEL 02		PARAKDE LEVEL 02	
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424.523 m GEODETIC					
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LEVEL 22 1363.29		RESIDENTIAL		RESIDENTIAL	
415.531 m GEODETIC					
$= \underbrace{LEVEL 21}_{I} \underbrace{(1353.46)}_{I}$		RESIDENTIAL UNIT		RESIDENTIAL	
412.534 m GEODETIC		RESIDENTIAL		RESIDENTIAL	
$\frac{\text{Level 20}}{400 \text{ For a construction}}$		UNIT			
LEVEL 19 (1333.79)		RESIDENTIAL		RESIDENTIAL	
406.54 m GEODETIC					
		RESIDENTIAL UNIT		RESIDENTIAL UNIT	
403.542 m GEODETIC		RESIDENTIAL		RESIDENTIAL	
		UNIT		UNIT	
LEVEL 16 (1304.29)		RESIDENTIAL		RESIDENTIAL	
LEVEL 15 1294.46		RESIDENTIAL		RESIDENTIAL	
394.551 m GEODETIC					
$= \frac{LEVEL 14}{1204.02}$		RESIDENTIAL UNIT		RESIDENTIAL UNIT	
391.554 m GEODETIC		RESIDENTIAL		RESIDENTIAL	
$- \frac{\text{LEVEL 13}}{2} \frac{(1274.79)}{2}$	е	UNIT			
388.556 m GEODETIC	68.94	RESIDENTIAL		RESIDENTIAL	
385.559 m GEODETIC	— — — — — —				
LEVEL 11 1255.12		RESIDENTIAL UNIT	ALL	RESIDENTIAL	
382.562 m GEODETIC		RESIDENTIAL		RESIDENTIAL	
		UNIT			
LEVEL 09 (1235.46)		RESIDENTIAL UNIT		RESIDENTIAL UNIT	
LEVEL 08 1225.62		RESIDENTIAL		RESIDENTIAL	
373.57 m GEODETIC	Π	RESIDENTIAL		RESIDENTIAL	
$\frac{\text{Level 07}}{270,570} \xrightarrow{(1213.79)} $		UNIT		UNIT	
LEVEL 06 (1205.96)		RESIDENTIAL		RESIDENTIAL	
LEVEL 05 1196.12		RESIDENTIAL		RESIDENTIAL	
364.579 m GEODETIC	Π	RESIDENTIAL		RESIDENTIAL	!
$\frac{\text{Level 04}}{20100} = \frac{1100.29}{20100}$		UNIT		UNIT	
LEVEL 03 (1176.46)		RESIDENTIAL		RESIDENTIAL	
LEVEL 02 (1166.62)		PARAKDE LEVEL 02		l	
355.587 m GEODETIC					
LEVEL 01 1156.79					
		PARAKDE LEVEL P1			
349.593 m GEODETIC					
		KRIXIX XXX	KKKK	KKKKKK	KKKK
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CTION 3					BUILDING
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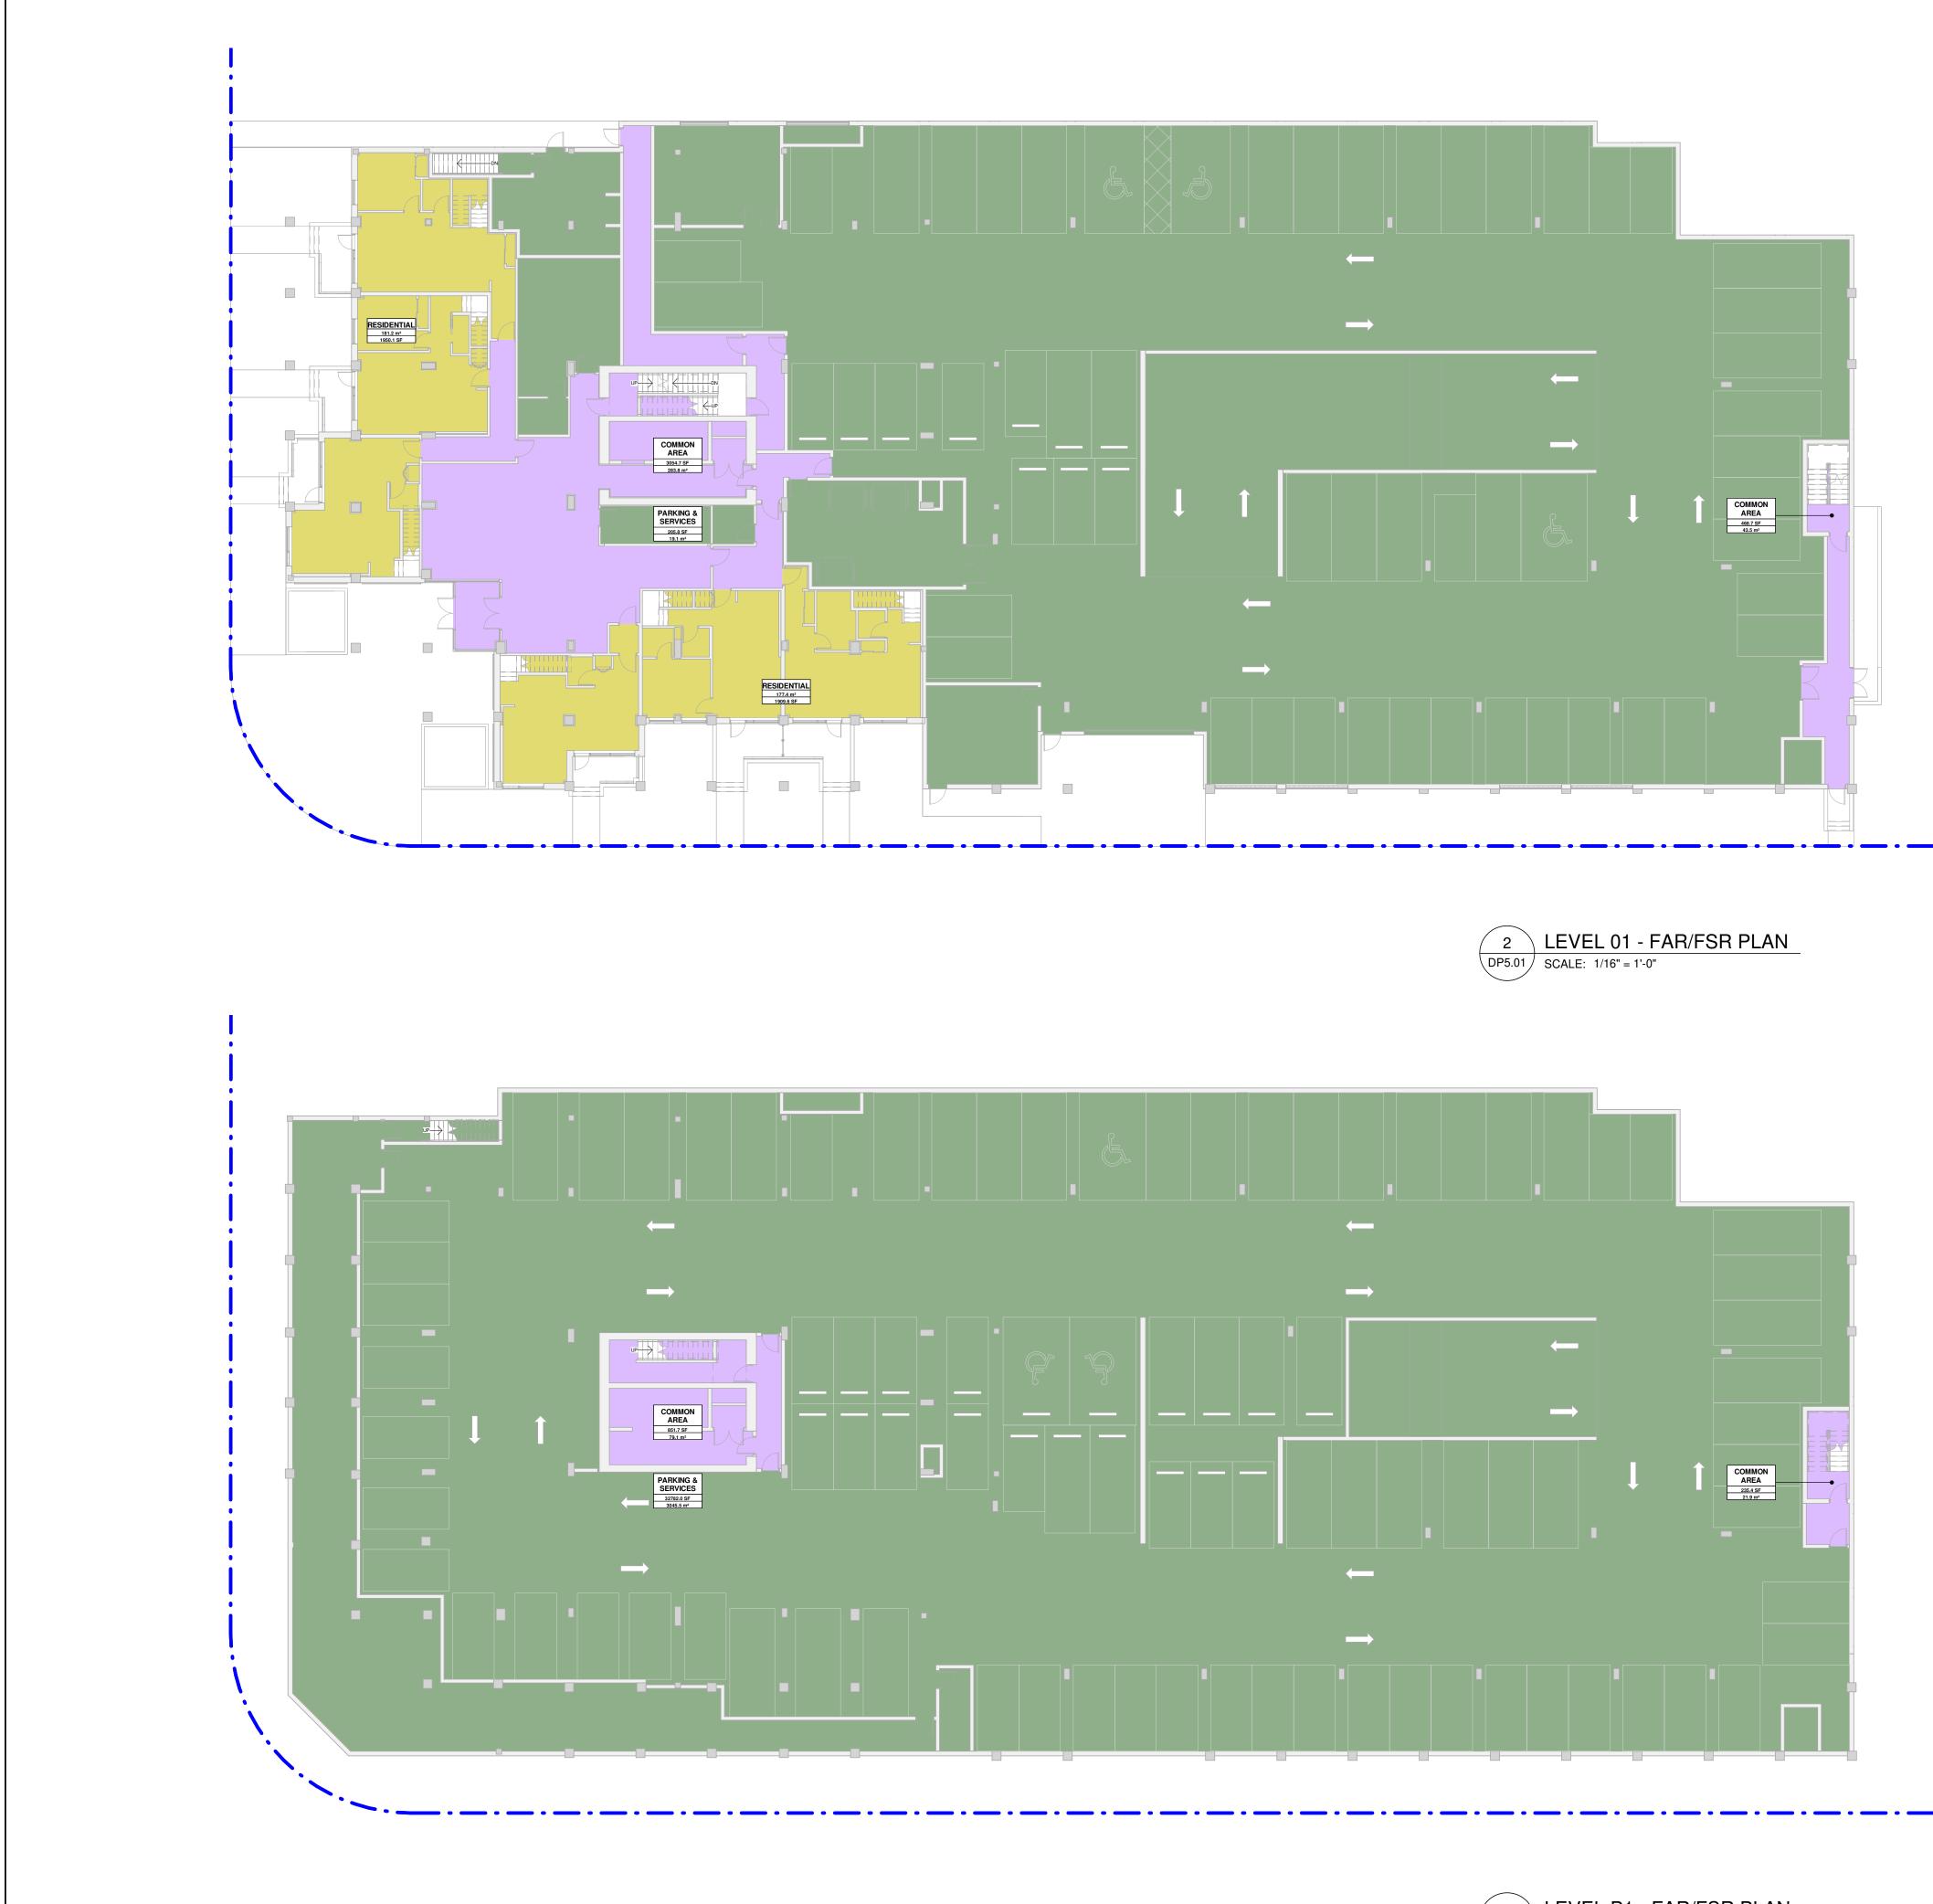


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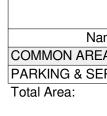


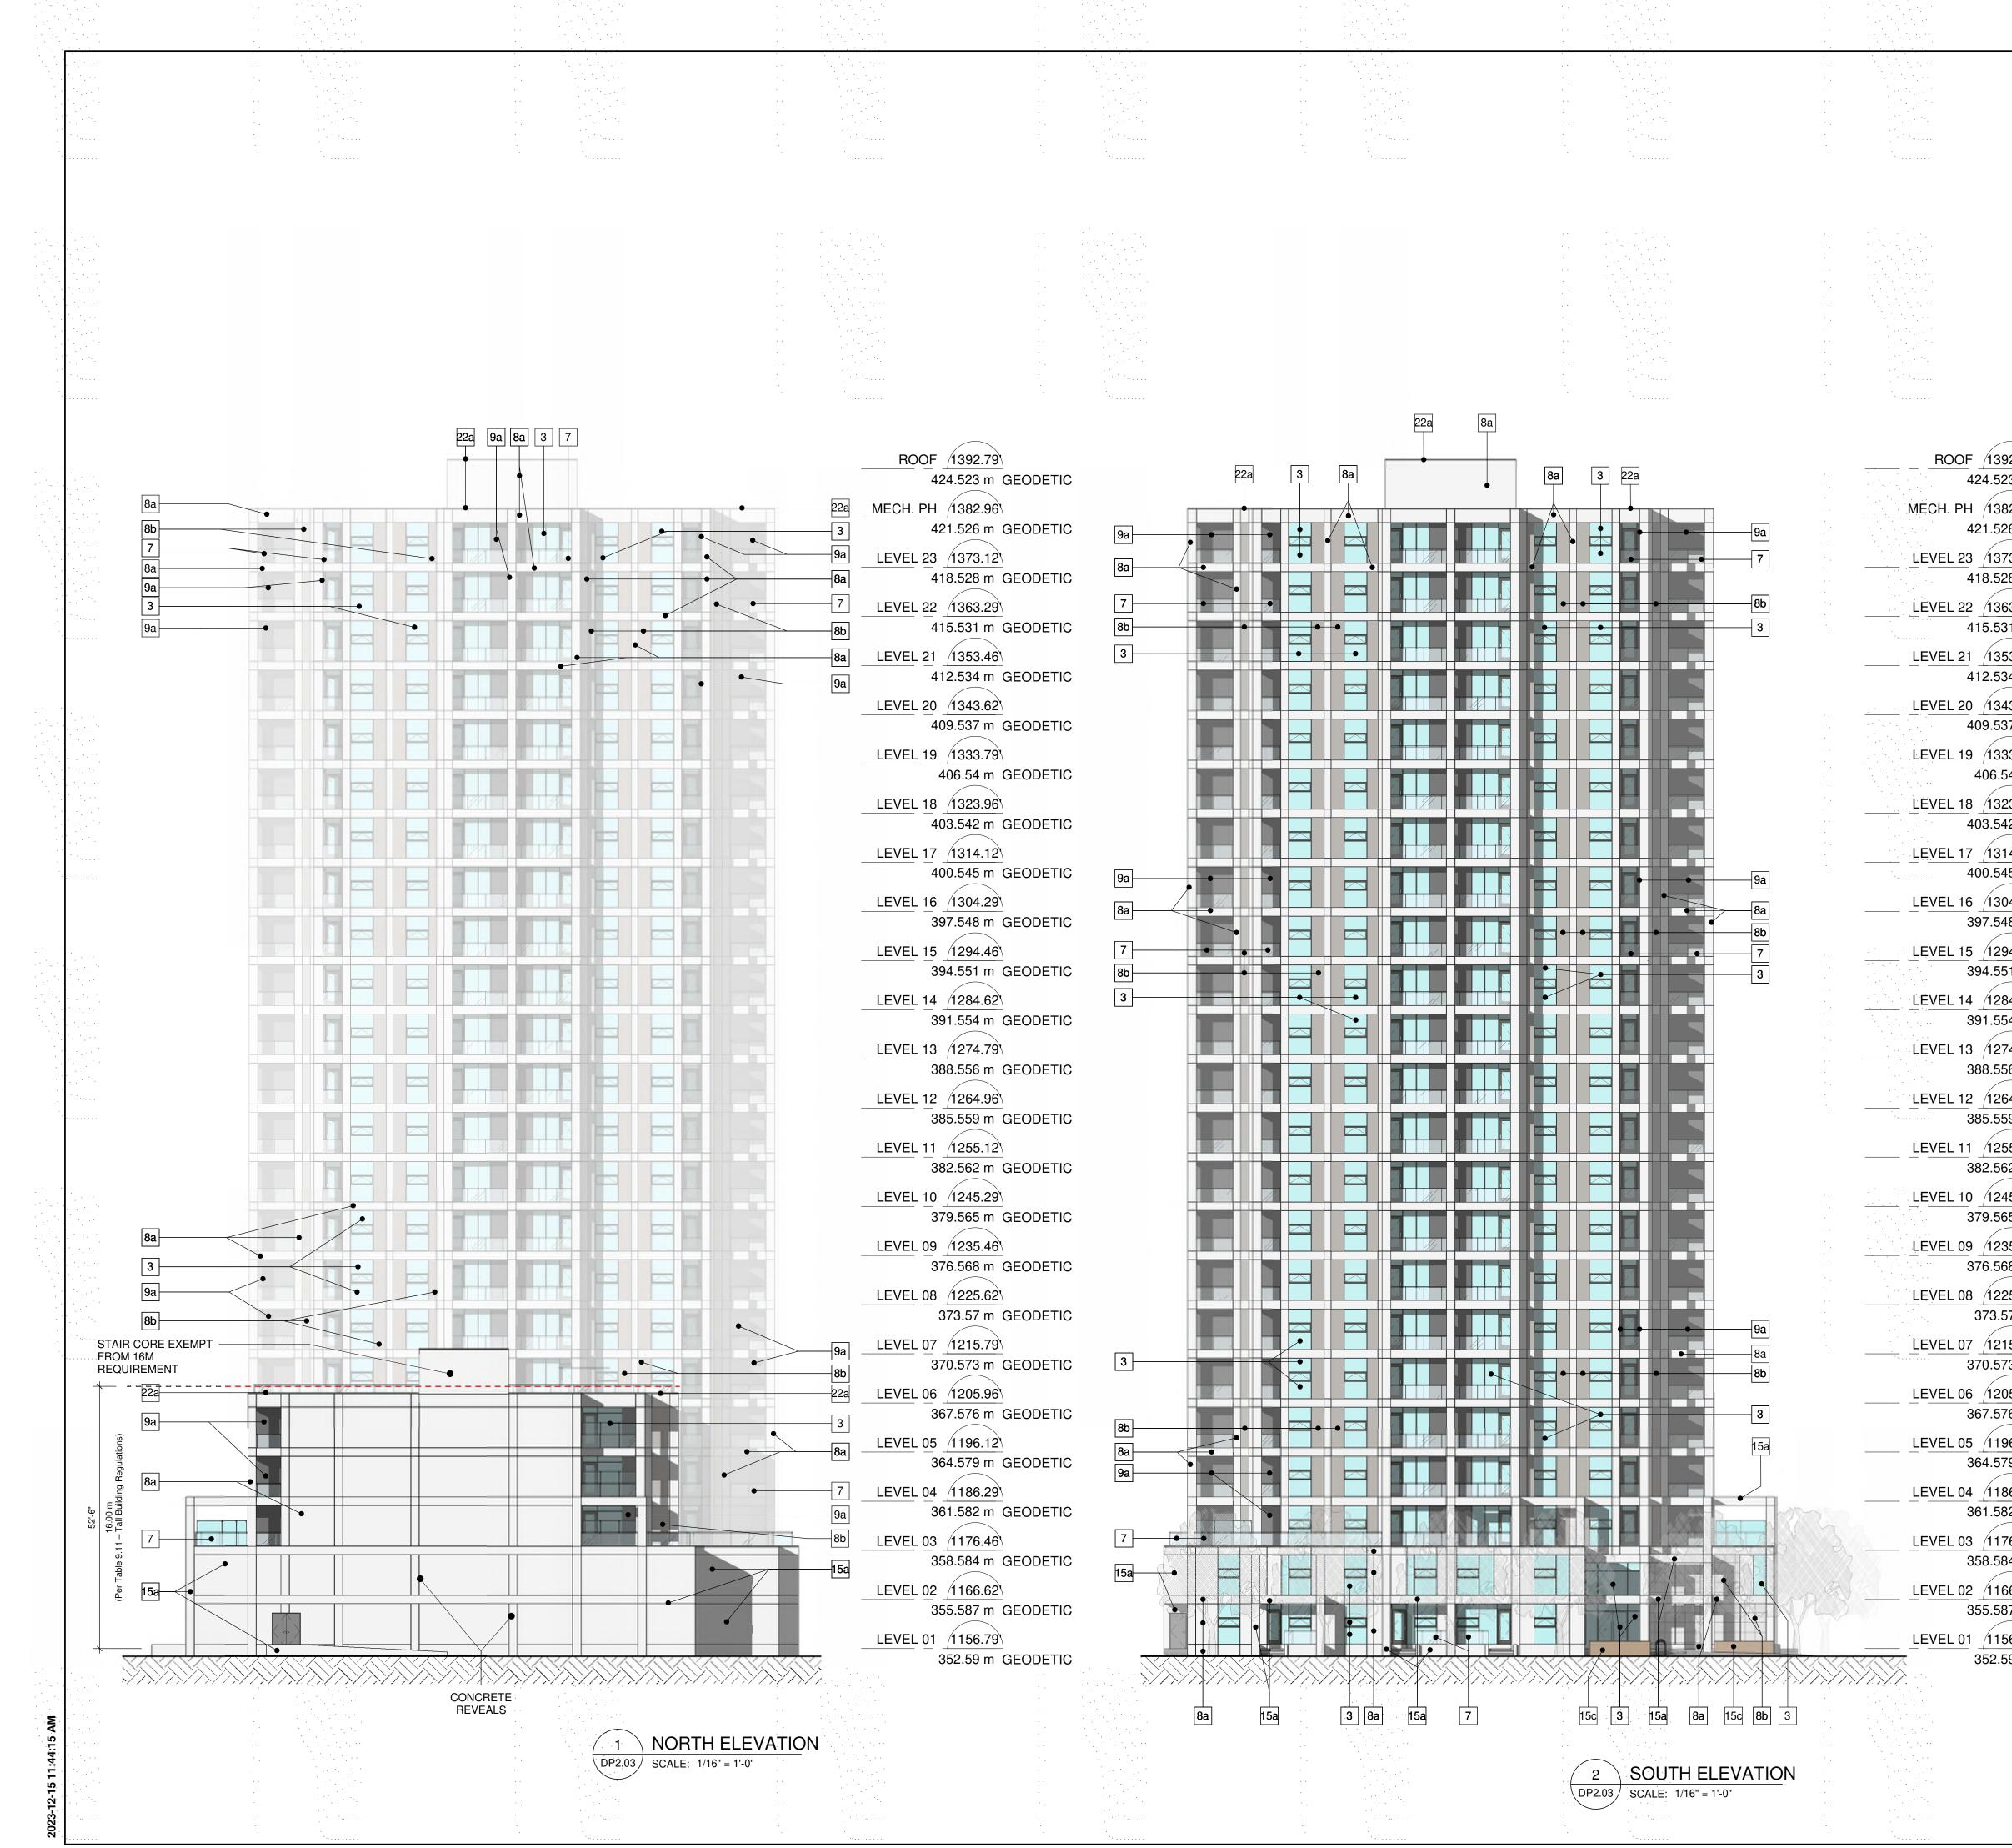


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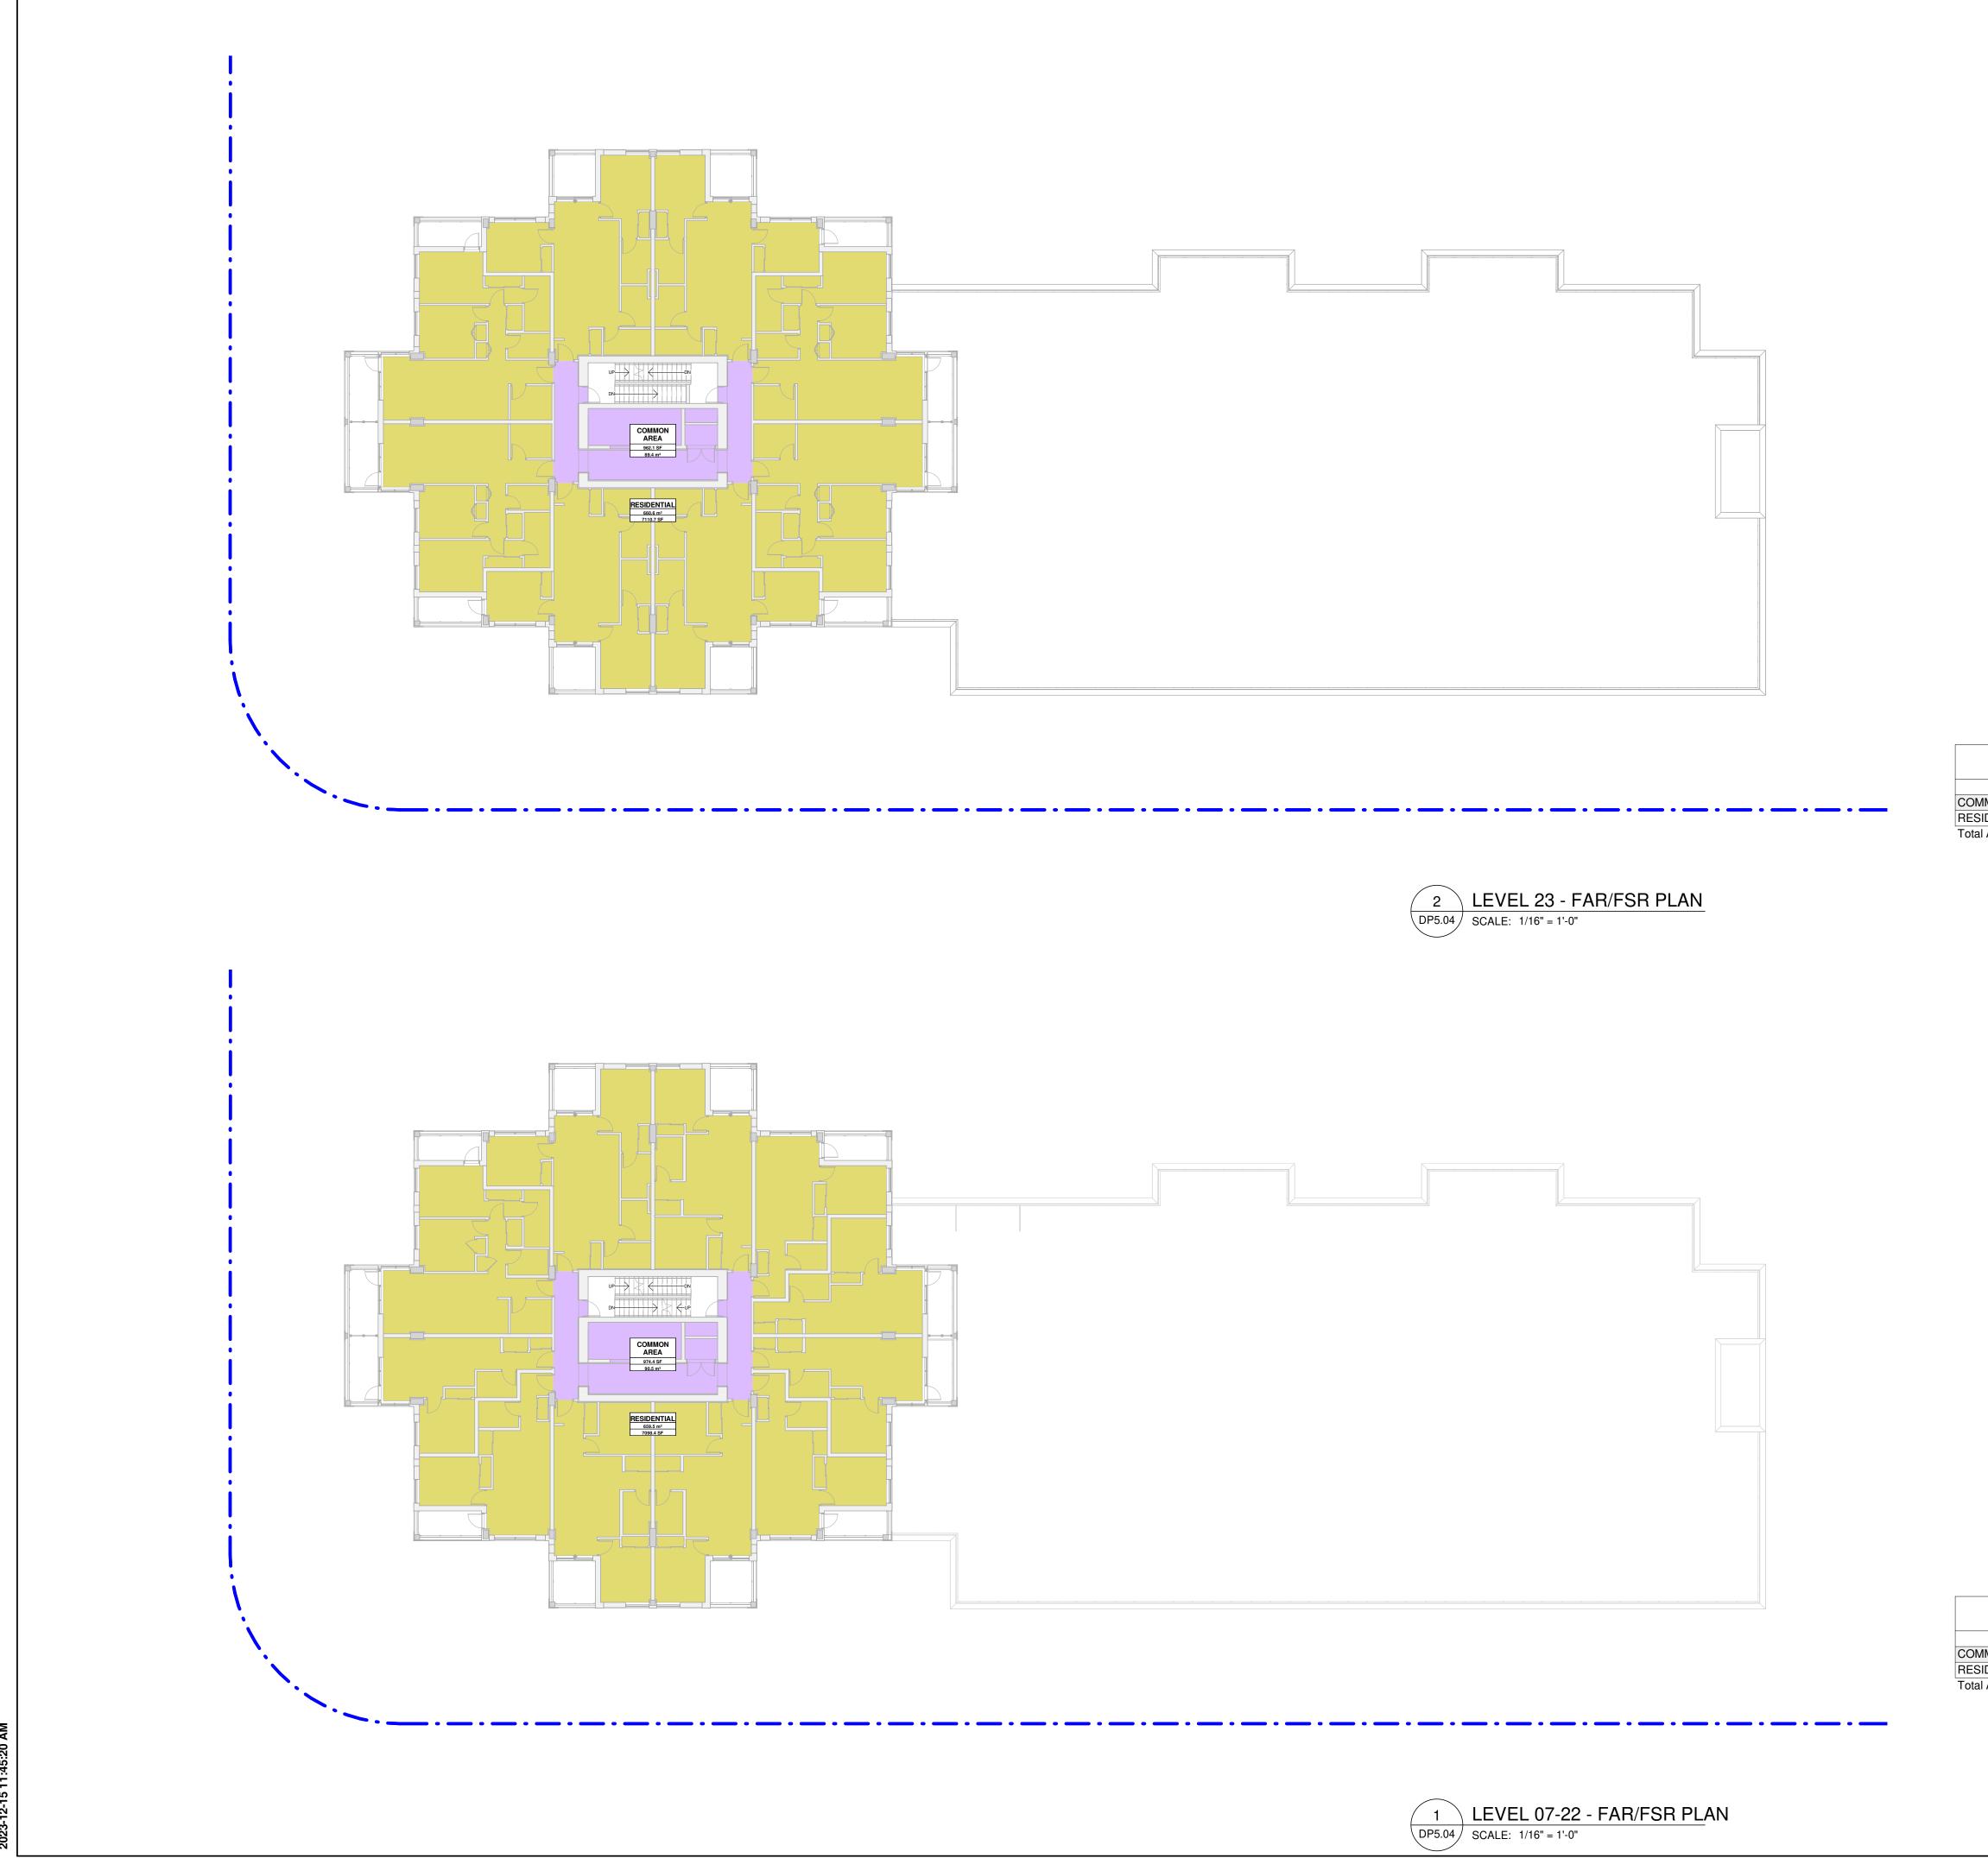
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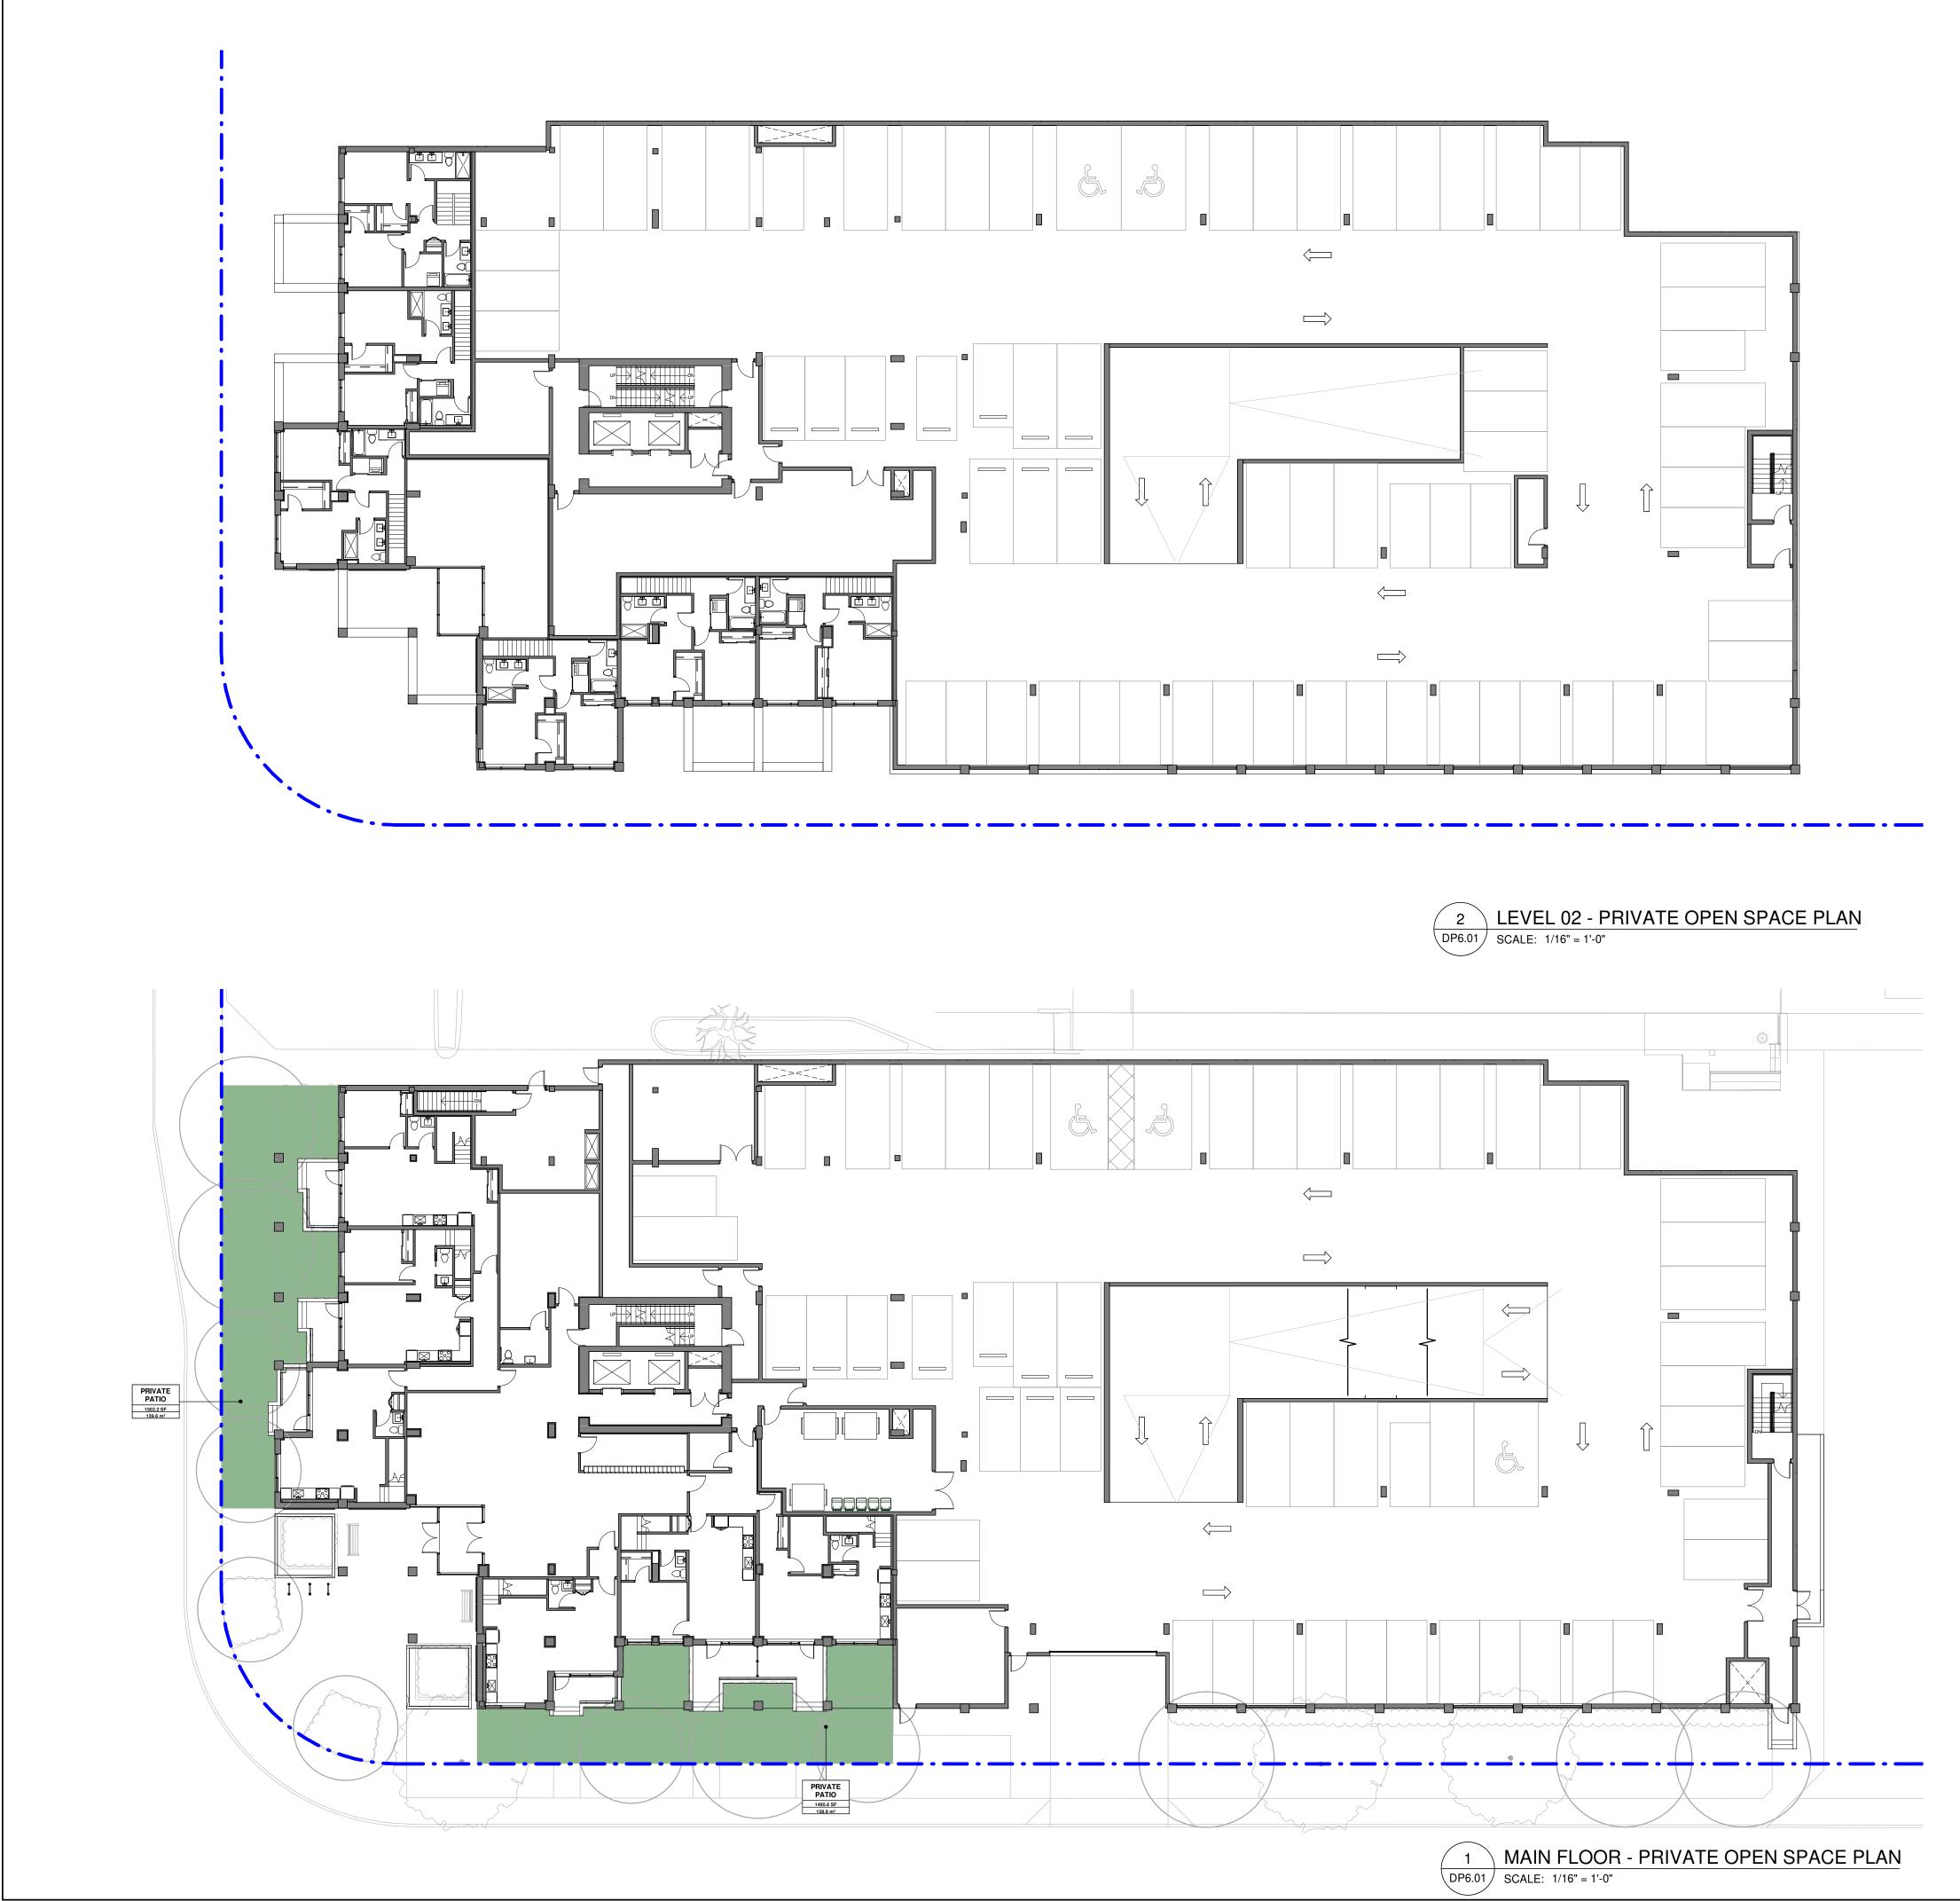


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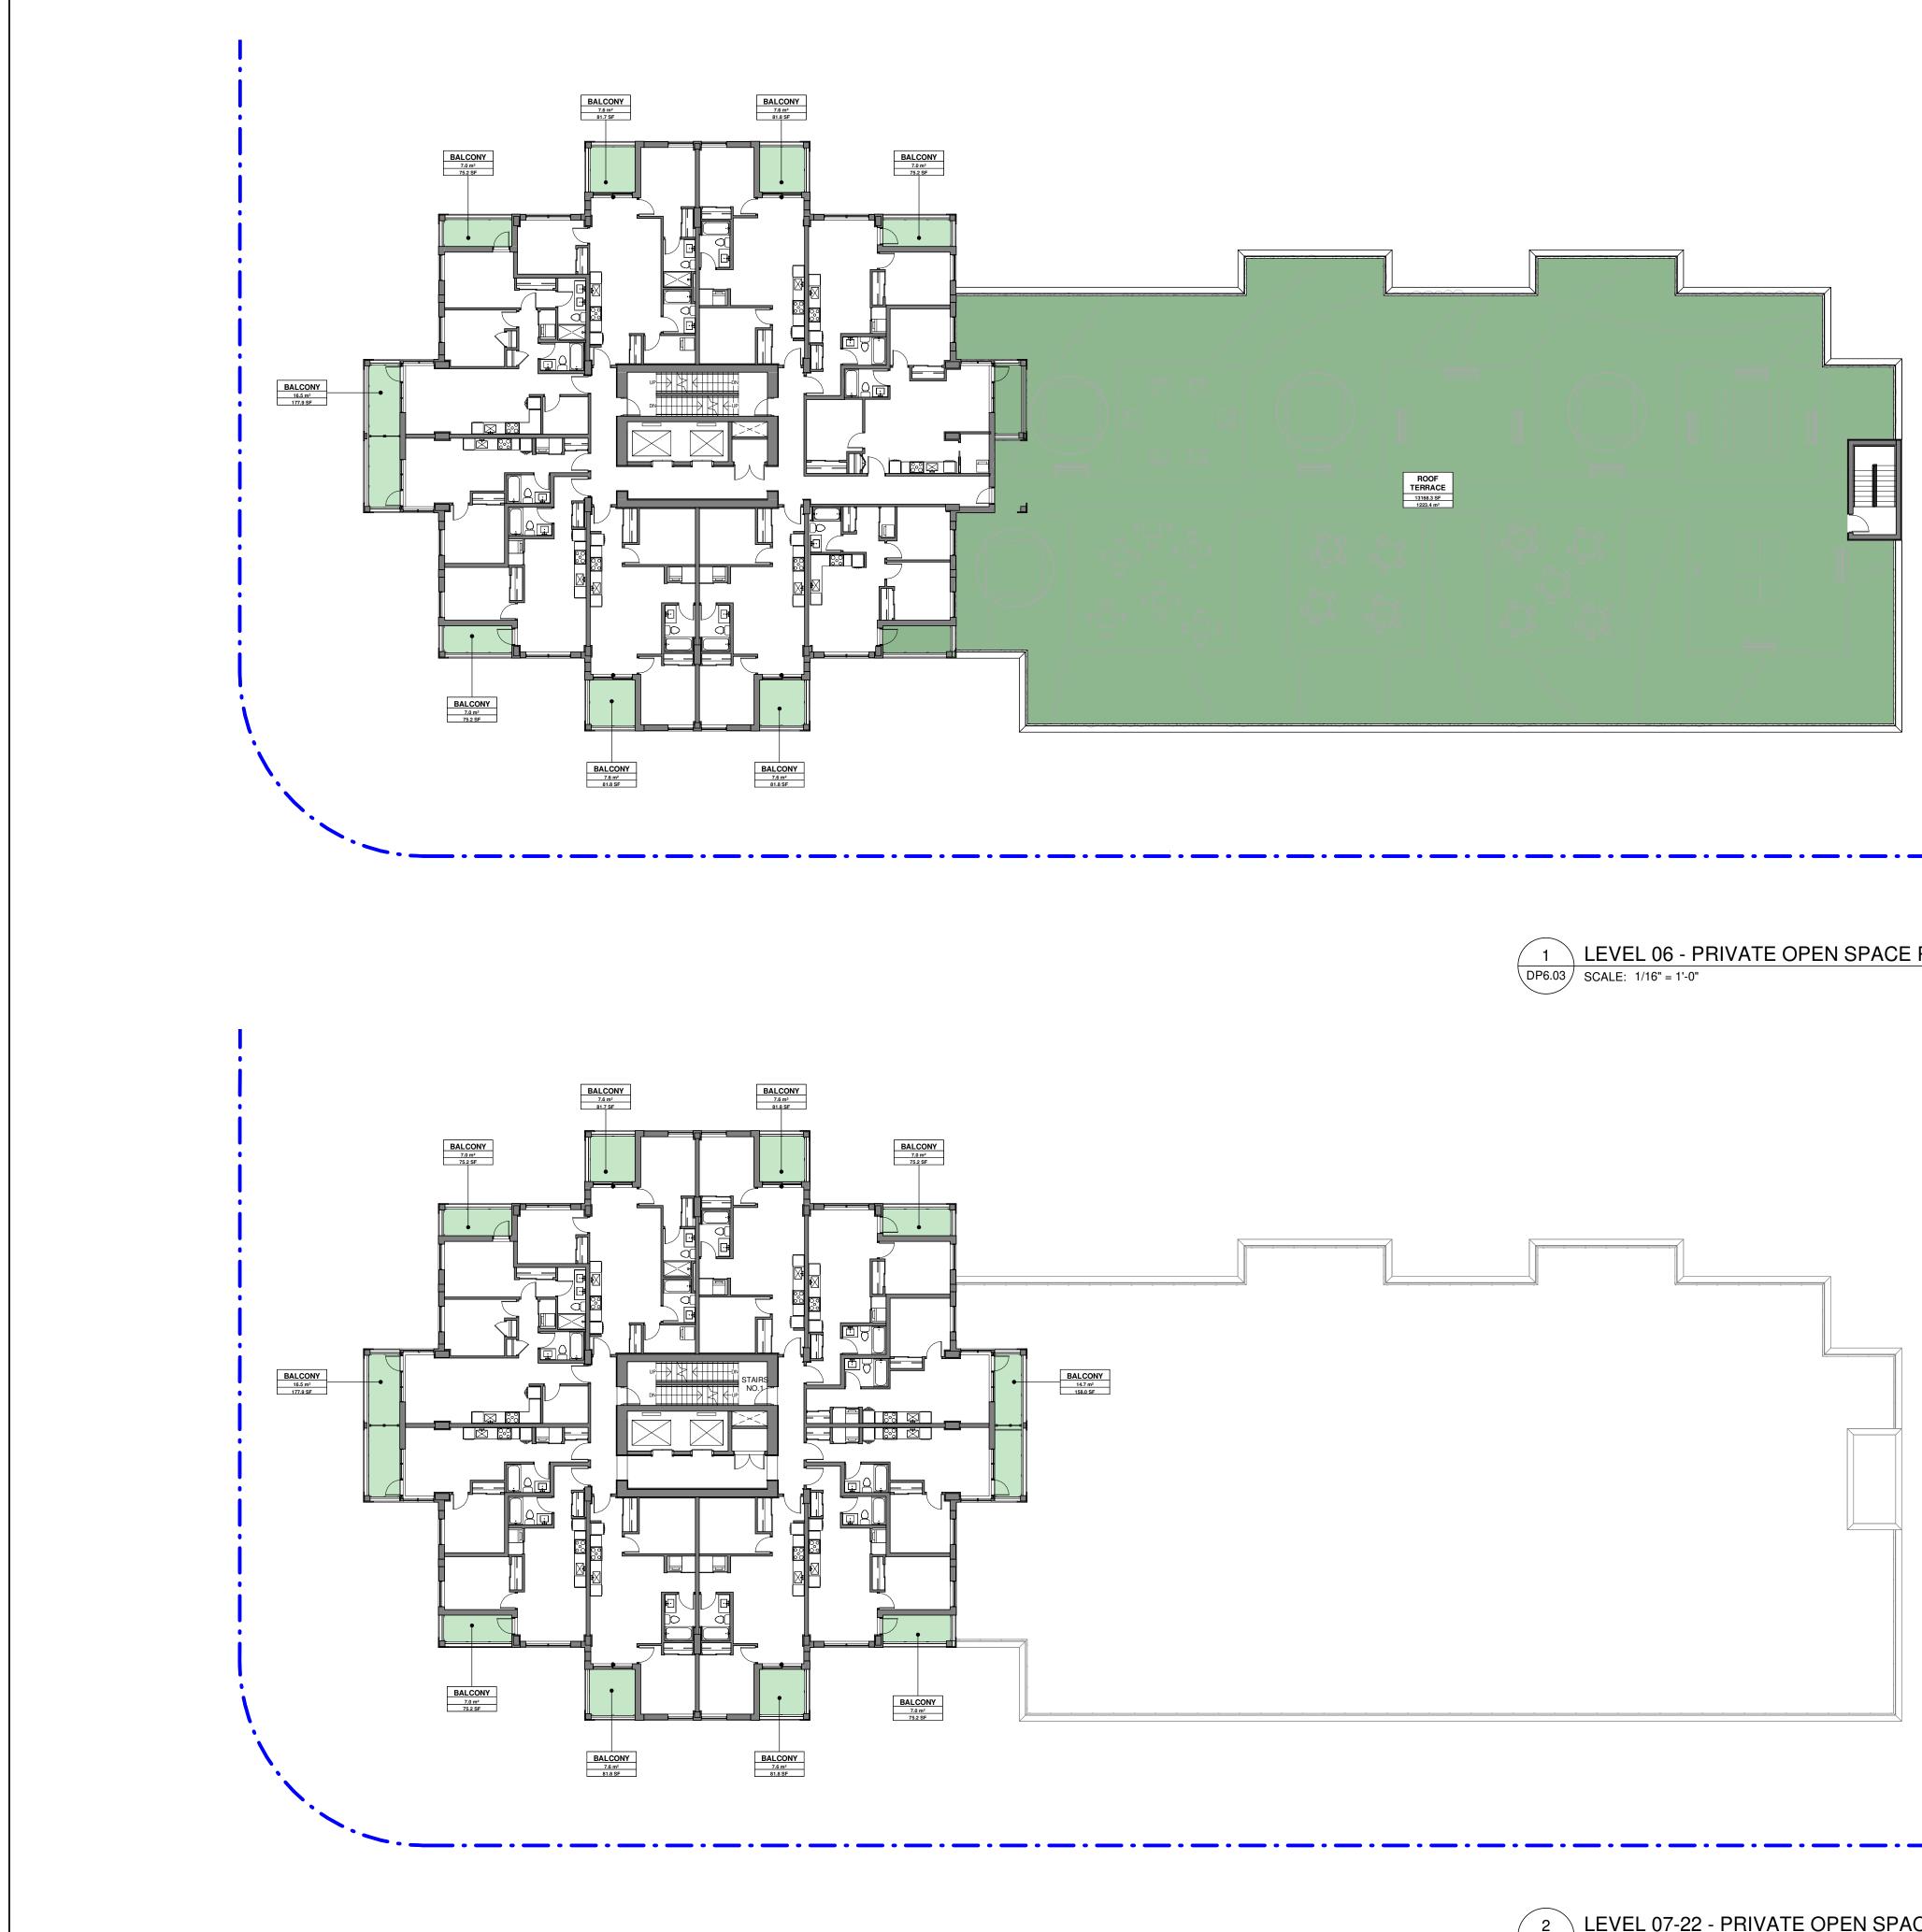


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Total Open Spa	ROOF TERRACE ce:	3	789.32 m ² 850.30 m ²	8496.21 SF 9152.52 SF		GM	ECT MGR: APPROVED E LM T TITLE)1.	ers\tony.ly
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1 LEVEL 06 - PRIVATE OPEN SPACE PLAN



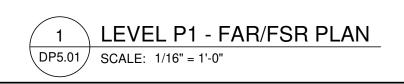

BALCONY PRIVATE PATIO ROOF TERRACE

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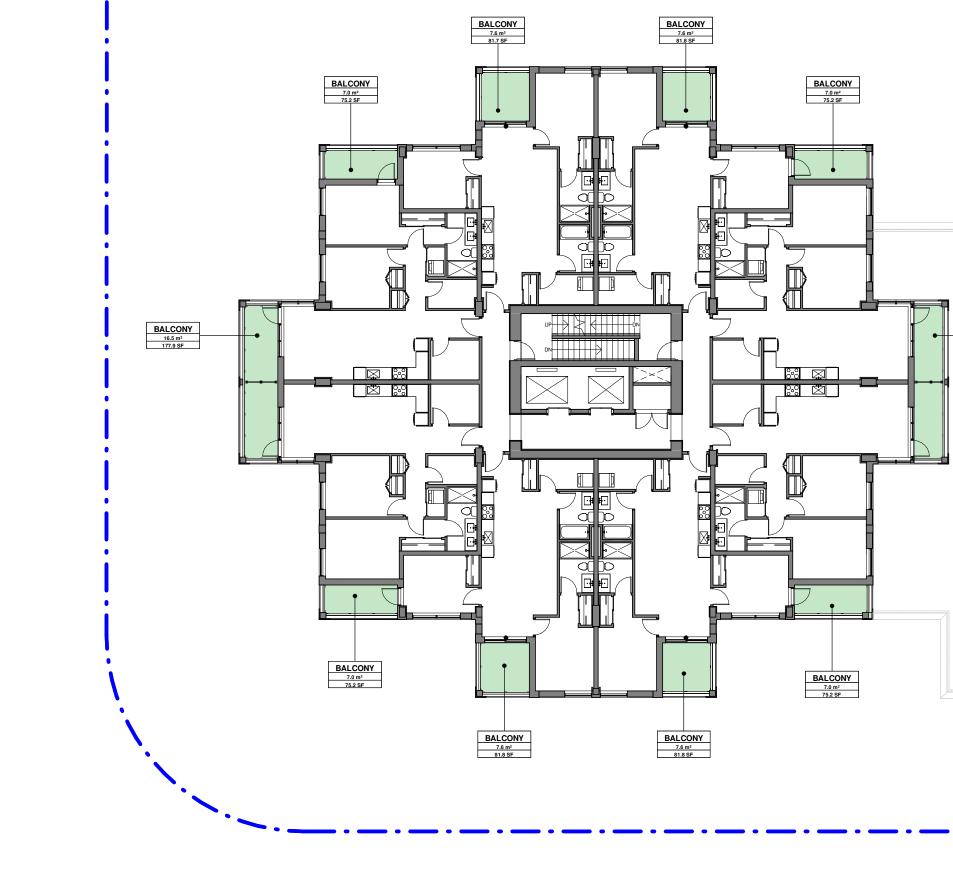


OPEN SPACE SCHEDULE - LEVEL 06					
egend	Usage Type	Count	Area m ²	Area ft ²	
	BALCONY	9	67.88 m ²	730.62 SF	
	ROOF TERRACE	1	1223.38 m ²	13168.32 SF	
Open Spa	ce:		1291.25 m ²	13898.94 SF	

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	1353 Ellis Street - Suite 202 Kelowna BC V1Y 1Z9 Canada tel 250 980 3432 www.arcadis.com	C:\Users\tony.lynch\AppData\Local\Arcadis\Revit2022\125701_Capri_Tower_1-A-2
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OPEN SPACE SCHEDULE - LEVEL 07-22					
gend	Usage Type	Count	Area m ²	Area ft ²	
	BALCONY	10	86.23 m ²	928.18 SF	
Open Spa	ce:		86.23 m ²	928.18 SF	


































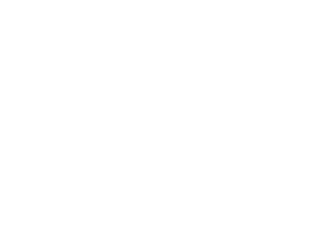




































BALCONY 14.7 m² 158.0 SF







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	COMMON NAME	QTY*	SIZE/SPACING & REMARKS
	BLOODGOOD JAPANESE MAPLE	4	3 cm CAL.
	RED MAPLE	7	4cm CAL.
	KENTUCKY COFFEE TREE	8	6cm CAL.
	ROSE GLOW BARBERRY	22	#02 CONT. /1.0M O.C. SPACING
	GREEN GEM BOXWOOD	22	#02 CONT. /1.0M O.C. SPACING
IATA'	VARIEGATE TARTARIAN DOGWOOD	22	#02 CONT. /1.0M O.C. SPACING
BELLE'	ANNABELLE HYDRANGEA	15	#02 CONT. /1.2M O.C. SPACING
	OREGON GRAPE HOLLY	10	#02 CONT. /1.5M O.C. SPACING
	MOCKORANGE	12	#02 CONT. /1.2M O.C. SPACING
	NORWAY SPRUCE	10	#02 CONT. /1.5M O.C. SPACING
	GROW LOW FRAGRANT SUMAC EMILY CARR ROSE	10 12	#02 CONT. /1.5M O.C. SPACING #02 CONT. /1.2M O.C. SPACING
	DWARF KOREAN LILAC	12	#02 CONT. /1.5M O.C. SPACING #02 CONT. /1.5M O.C. SPACING
		10	#02 CONT. 71.5M O.C. 5FACINO
OVERS			
	LADYSMANTLE	21	#01 CONT. /0.75M O.C. SPACING
l foerster'	KARL FOESTER FEATHER REED GRASS	12	#01 CONT. /1.0M O.C. SPACING
		33 33	#01 CONT. /0.6M O.C. SPACING
	MAGNUS CONEFLOWER SUMMERWINE DAYLILLY	33 21	#01 CONT. /0.6M O.C. SPACING #01 CONT. /0.75M O.C. SPACING
	OSTRICH FERN	12	#01 CONT. /1.0M O.C. SPACING
N	WALKER'S LOW CATMINT	15	#01 CONT. /0.9M O.C. SPACING
•	FOUNTAIN GRASS	8	#01 CONT. /1.2M O.C. SPACING
NER GOLD'		150	PLUGS /0.3M O.C. SPACING
	BLUE LAGOON STONECROP	150	PLUGS /0.3M O.C. SPACING
	AUTUMUN JOY STONECROP	150	PLUGS /0.3M O.C. SPACING
)'	DRAGON'S BLOOD STONECROP	150	PLUGS /0.3M O.C. SPACING
	BOSTON IVY	20	#01 CONT. /1.0M O.C. SPACING

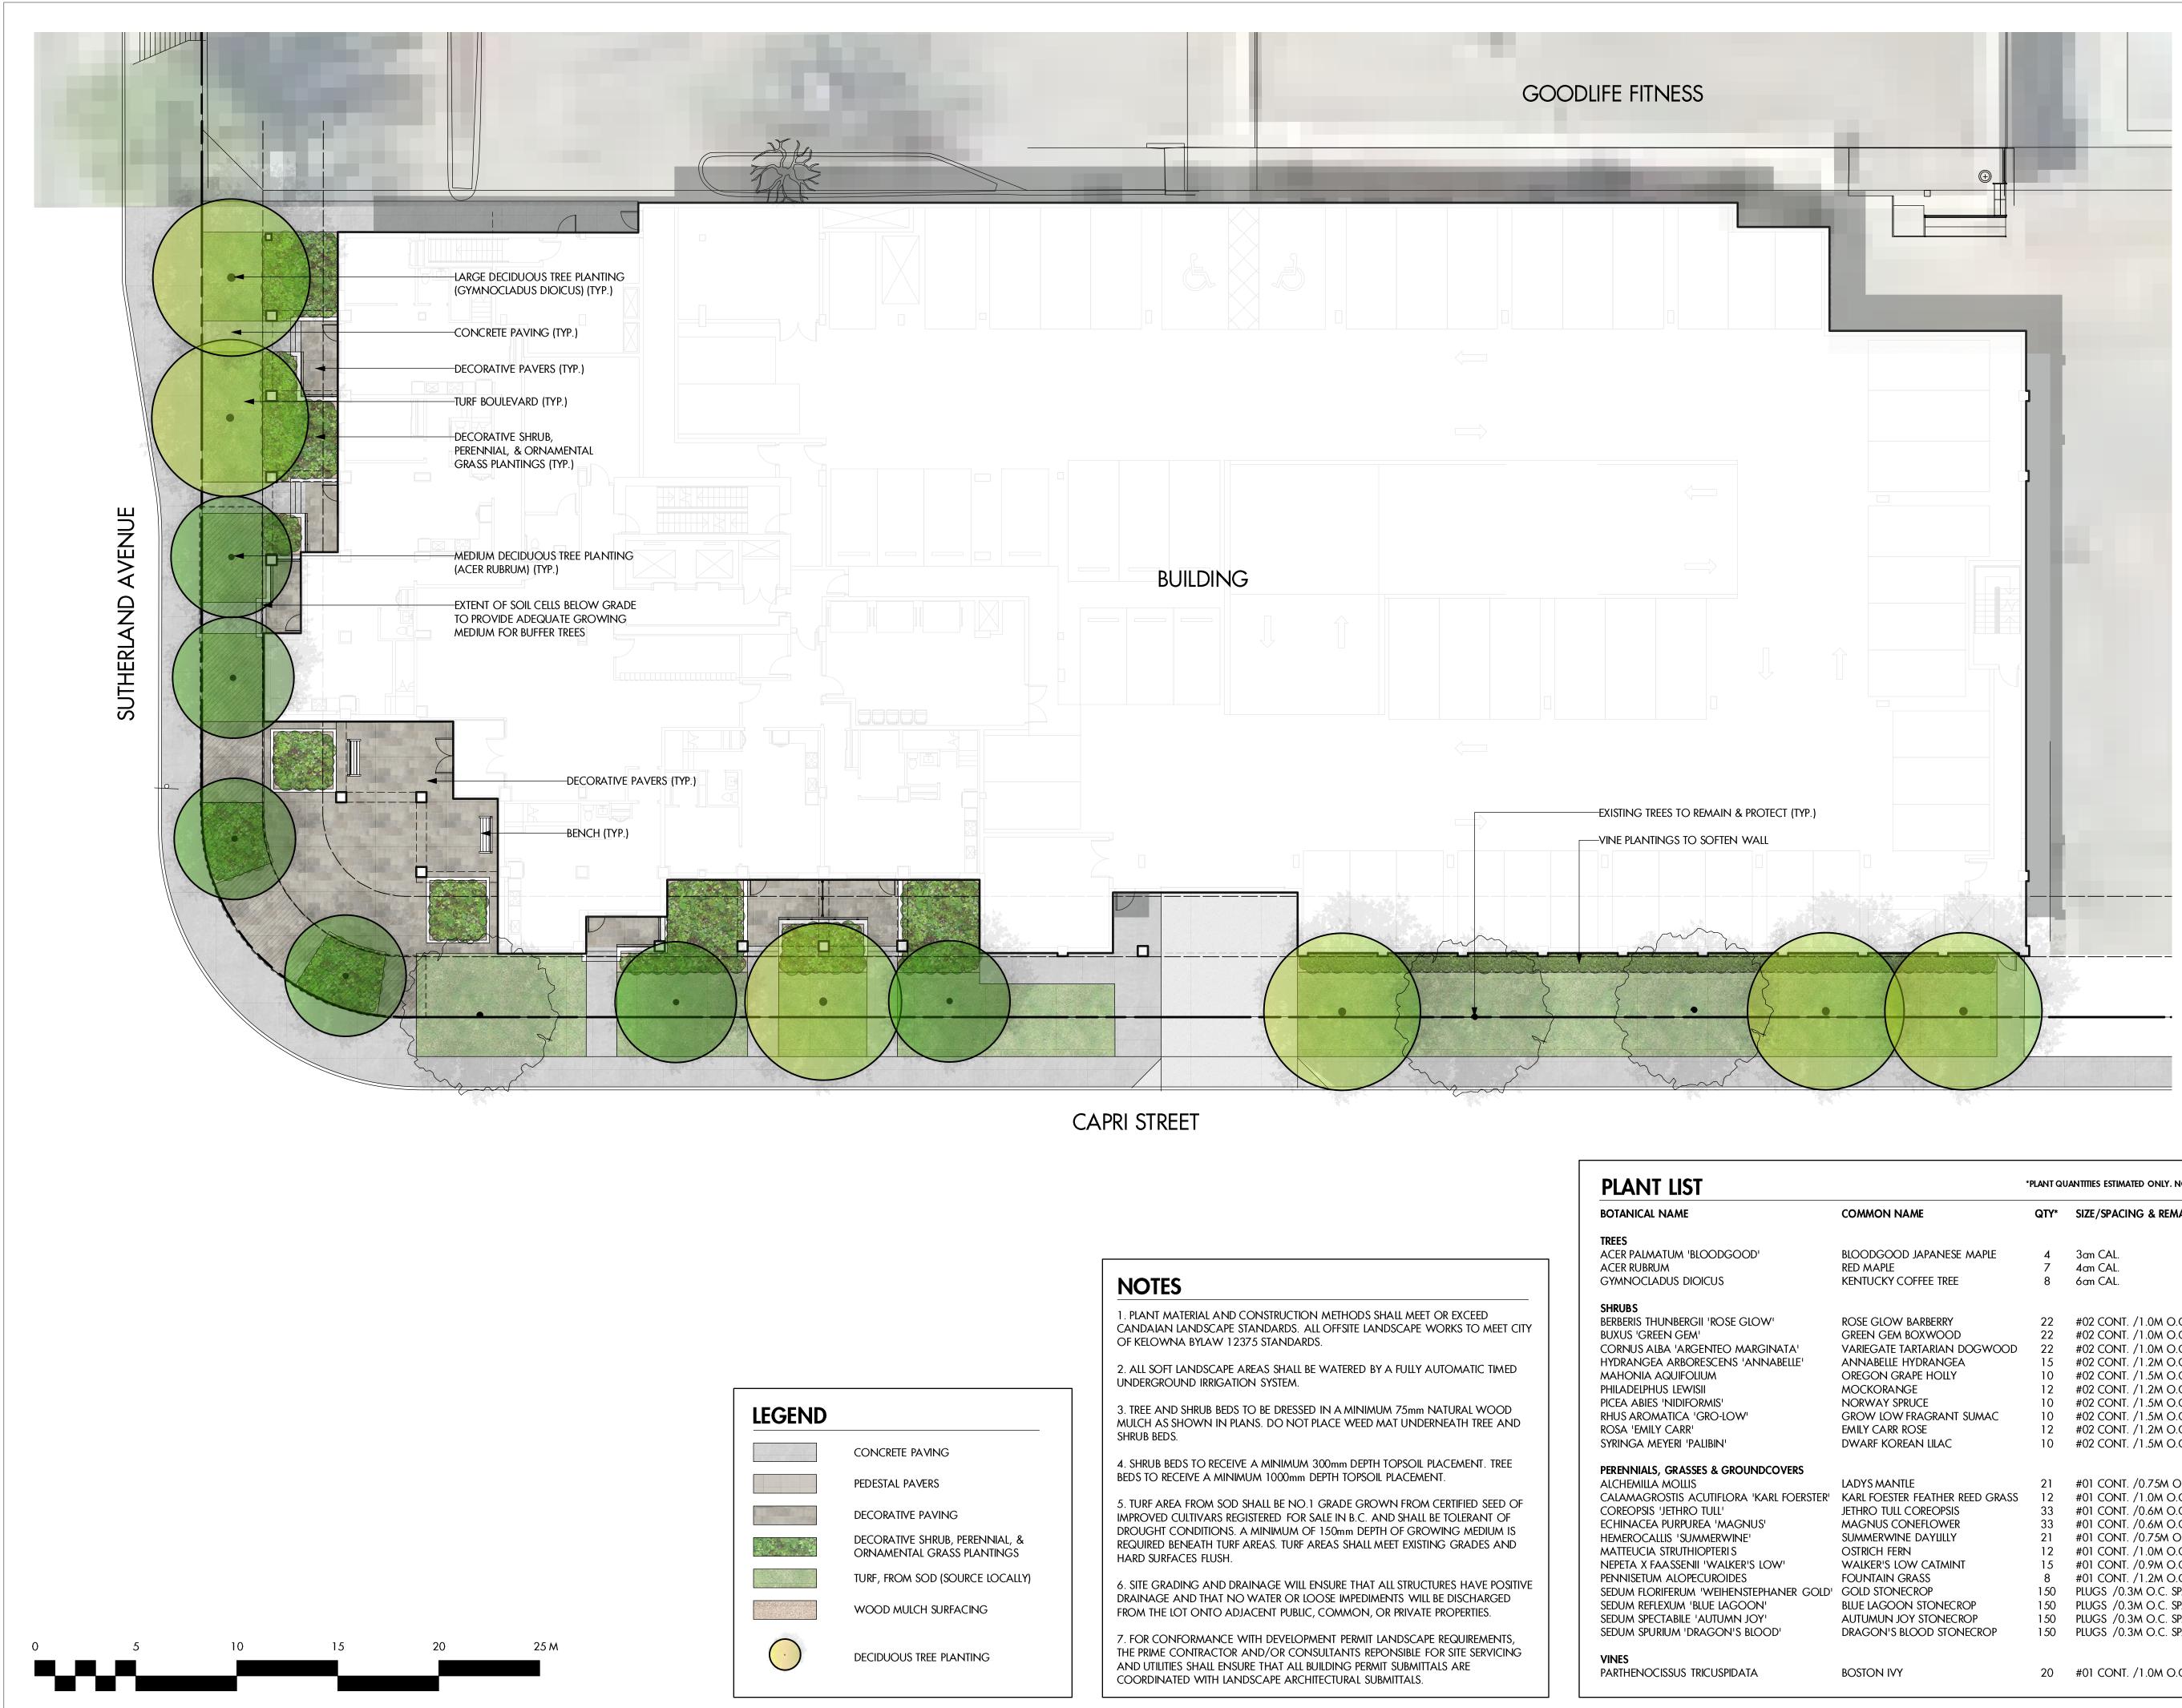



PROJECT TITLE

CAPRI TOWER

Kelowna, BC

DRAWING TITLE

CONCEPTUAL LANDSCAPE PLAN LEVEL 1

ISSUED FOR / REVISION

	,,,,	
1	23.06.16	Review
2	23.06.23	Development Permit
3	23.07.13	Development Permit
4	23.11.10	Development Permit
5		

project no	21-3613	
DESIGN BY	AM	
dravvn by	NM/MC	
CHECKED BY	FB	
DATE	NOV. 10, 2023	
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PAGE SIZE	24x36	


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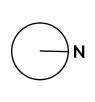
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		*PLANT QU	JANTITIES ESTIMATED ONLY. NOT FOR PRICING
	COMMON NAME	QTY*	SIZE/SPACING & REMARKS
	BLOODGOOD JAPANESE MAPLE	4	3cm CAL.
	RED MAPLE	7	4cm CAL.
	KENTUCKY COFFEE TREE	8	6cm CAL.
	ROSE GLOW BARBERRY	22	#02 CONT. /1.0M O.C. SPACING
	GREEN GEM BOXWOOD	22	#02 CONT. /1.0M O.C. SPACING
ATA'	VARIEGATE TARTARIAN DOGWOOD	22	#02 CONT. /1.0M O.C. SPACING
BELLE'	ANNABELLE HYDRANGEA	15	#02 CONT. /1.2M O.C. SPACING
	OREGON GRAPE HOLLY	10	#02 CONT. /1.5M O.C. SPACING
	MOCKORANGE	12	#02 CONT. /1.2M O.C. SPACING
	NORWAY SPRUCE	10	#02 CONT. /1.5M O.C. SPACING
	GROW LOW FRAGRANT SUMAC	10	#02 CONT. /1.5M O.C. SPACING
	EMILY CARR ROSE	12	#02 CONT. /1.2M O.C. SPACING
	DWARF KOREAN LILAC	10	#02 CONT. /1.5M O.C. SPACING
OVERS		_	
	LADYS MANTLE	21	#01 CONT. /0.75M O.C. SPACING
FOERSTER'	KARL FOESTER FEATHER REED GRASS	12	#01 CONT. /1.0M O.C. SPACING
	JETHRO TULL COREOPSIS	33	#01 CONT. /0.6M O.C. SPACING
	MAGNUS CONEFLOWER	33	#01 CONT. /0.6M O.C. SPACING
	SUMMERWINE DAYLILLY	21	#01 CONT. /0.75M O.C. SPACING
. /1	OSTRICH FERN	12	#01 CONT. /1.0M O.C. SPACING
V'	WALKER'S LOW CATMINT	15	#01 CONT. /0.9M O.C. SPACING
	FOUNTAIN GRASS	8	#01 CONT. /1.2M O.C. SPACING
NER GOLD'		150	PLUGS /0.3M O.C. SPACING
	BLUE LAGOON STONECROP	150	PLUGS /0.3M O.C. SPACING
N	AUTUMUN JOY STONECROP	150	PLUGS /0.3M O.C. SPACING
<i>)</i> .	DRAGON'S BLOOD STONECROP	1 <i>5</i> 0	PLUGS /0.3M O.C. SPACING
	BOSTON IVY	20	#01 CONT. /1.0M O.C. SPACING





PROJECT TITLE

CAPRI TOWER

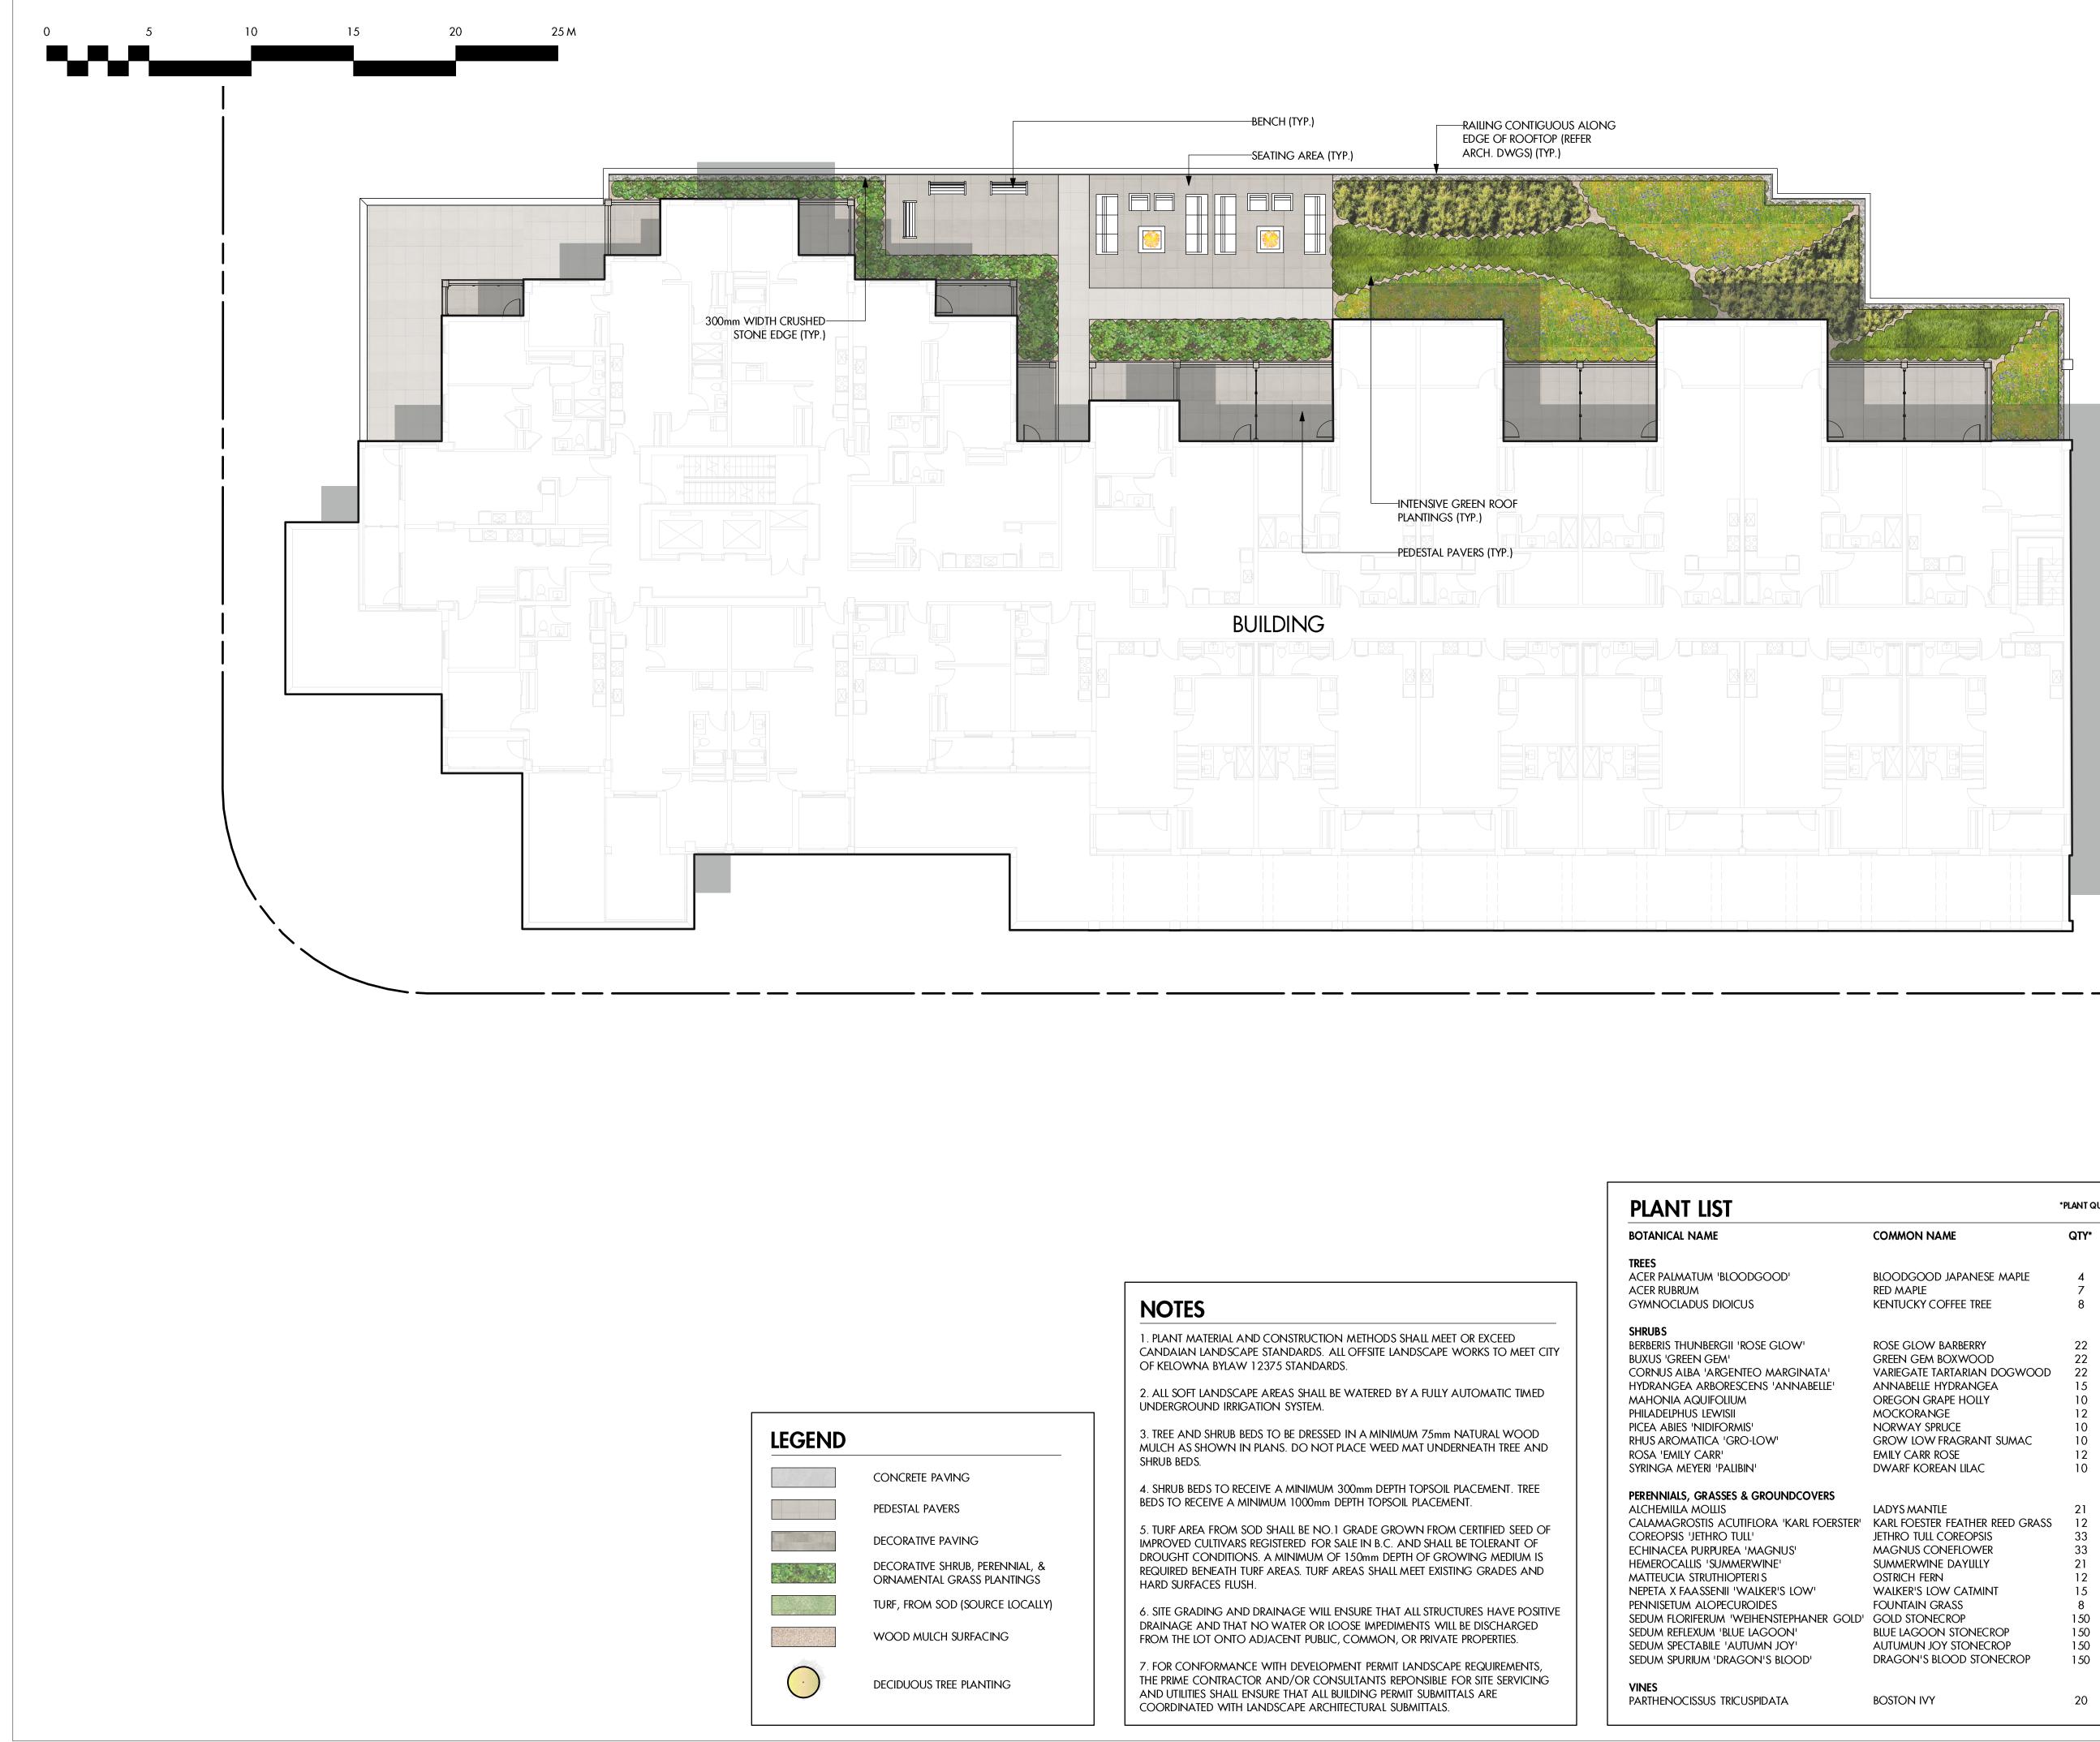Kelowna, BC

DRAWING TITLE

CONCEPTUAL LANDSCAPE PLAN LEVEL 3

ISSUED FOR / REVISION


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2	23.06.23	Development Permit
3	23.07.13	Development Permit
4	23.11.10	Development Permit
5		


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DESIGN BY	AM	
dravvn by	NM/MC	
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DATE	NOV. 10, 2023	
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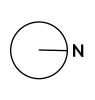
DRAWING NUMBER





		*PLANT QU	JANTITIES ESTIMATED ONLY. NOT FOR PRICING
	COMMON NAME	QTY*	SIZE/SPACING & REMARKS
	BLOODGOOD JAPANESE MAPLE	4	3cm CAL.
	RED MAPLE	7	4cm CAL.
	KENTUCKY COFFEE TREE	8	6cm CAL.
	ROSE GLOW BARBERRY	22	#02 CONT. /1.0M O.C. SPACING
	GREEN GEM BOXWOOD	22	#02 CONT. /1.0M O.C. SPACING
ATA'	VARIEGATE TARTARIAN DOGWOOD	22	#02 CONT. /1.0M O.C. SPACING
BELLE'	ANNABELLE HYDRANGEA	15	#02 CONT. /1.2M O.C. SPACING
	OREGON GRAPE HOLLY	10	#02 CONT. /1.5M O.C. SPACING
	MOCKORANGE	12	#02 CONT. /1.2M O.C. SPACING
	NORWAY SPRUCE	10	#02 CONT. /1.5M O.C. SPACING
	GROW LOW FRAGRANT SUMAC	10	#02 CONT. /1.5M O.C. SPACING
	EMILY CARR ROSE	12	#02 CONT. /1.2M O.C. SPACING
	DWARF KOREAN LILAC	10	#02 CONT. /1.5M O.C. SPACING
VERS			
	LADYSMANTLE	21	#01 CONT. /0.75M O.C. SPACING
FOERSTER'	KARL FOESTER FEATHER REED GRASS	12	#01 CONT. /1.0M O.C. SPACING
	JETHRO TULL COREOPSIS	33	#01 CONT. /0.6M O.C. SPACING
		33	#01 CONT. /0.6M O.C. SPACING
		21	#01 CONT. /0.75M O.C. SPACING
/1	OSTRICH FERN	12	#01 CONT. /1.0M O.C. SPACING
V	WALKER'S LOW CATMINT	15	#01 CONT. /0.9M O.C. SPACING
NER GOLD'	Fountain grass Gold Stonecrop	8	#01 CONT. /1.2M O.C. SPACING
INER GULD'	BLUE LAGOON STONECROP	1 <i>5</i> 0 1 <i>5</i> 0	PLUGS /0.3M O.C. SPACING
	AUTUMUN JOY STONECROP	150	PLUGS /0.3M O.C. SPACING PLUGS /0.3M O.C. SPACING
4	DRAGON'S BLOOD STONECROP	150	PLUGS /0.3M O.C. SPACING PLUGS /0.3M O.C. SPACING
'	DRAGON 3 BLOOD STONLCROP	100	FLOGG / U.SIM O.C. SFACING
	BOSTON IVY	20	#01 CONT. /1.0M O.C. SPACING

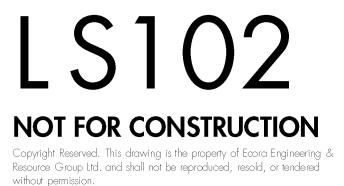

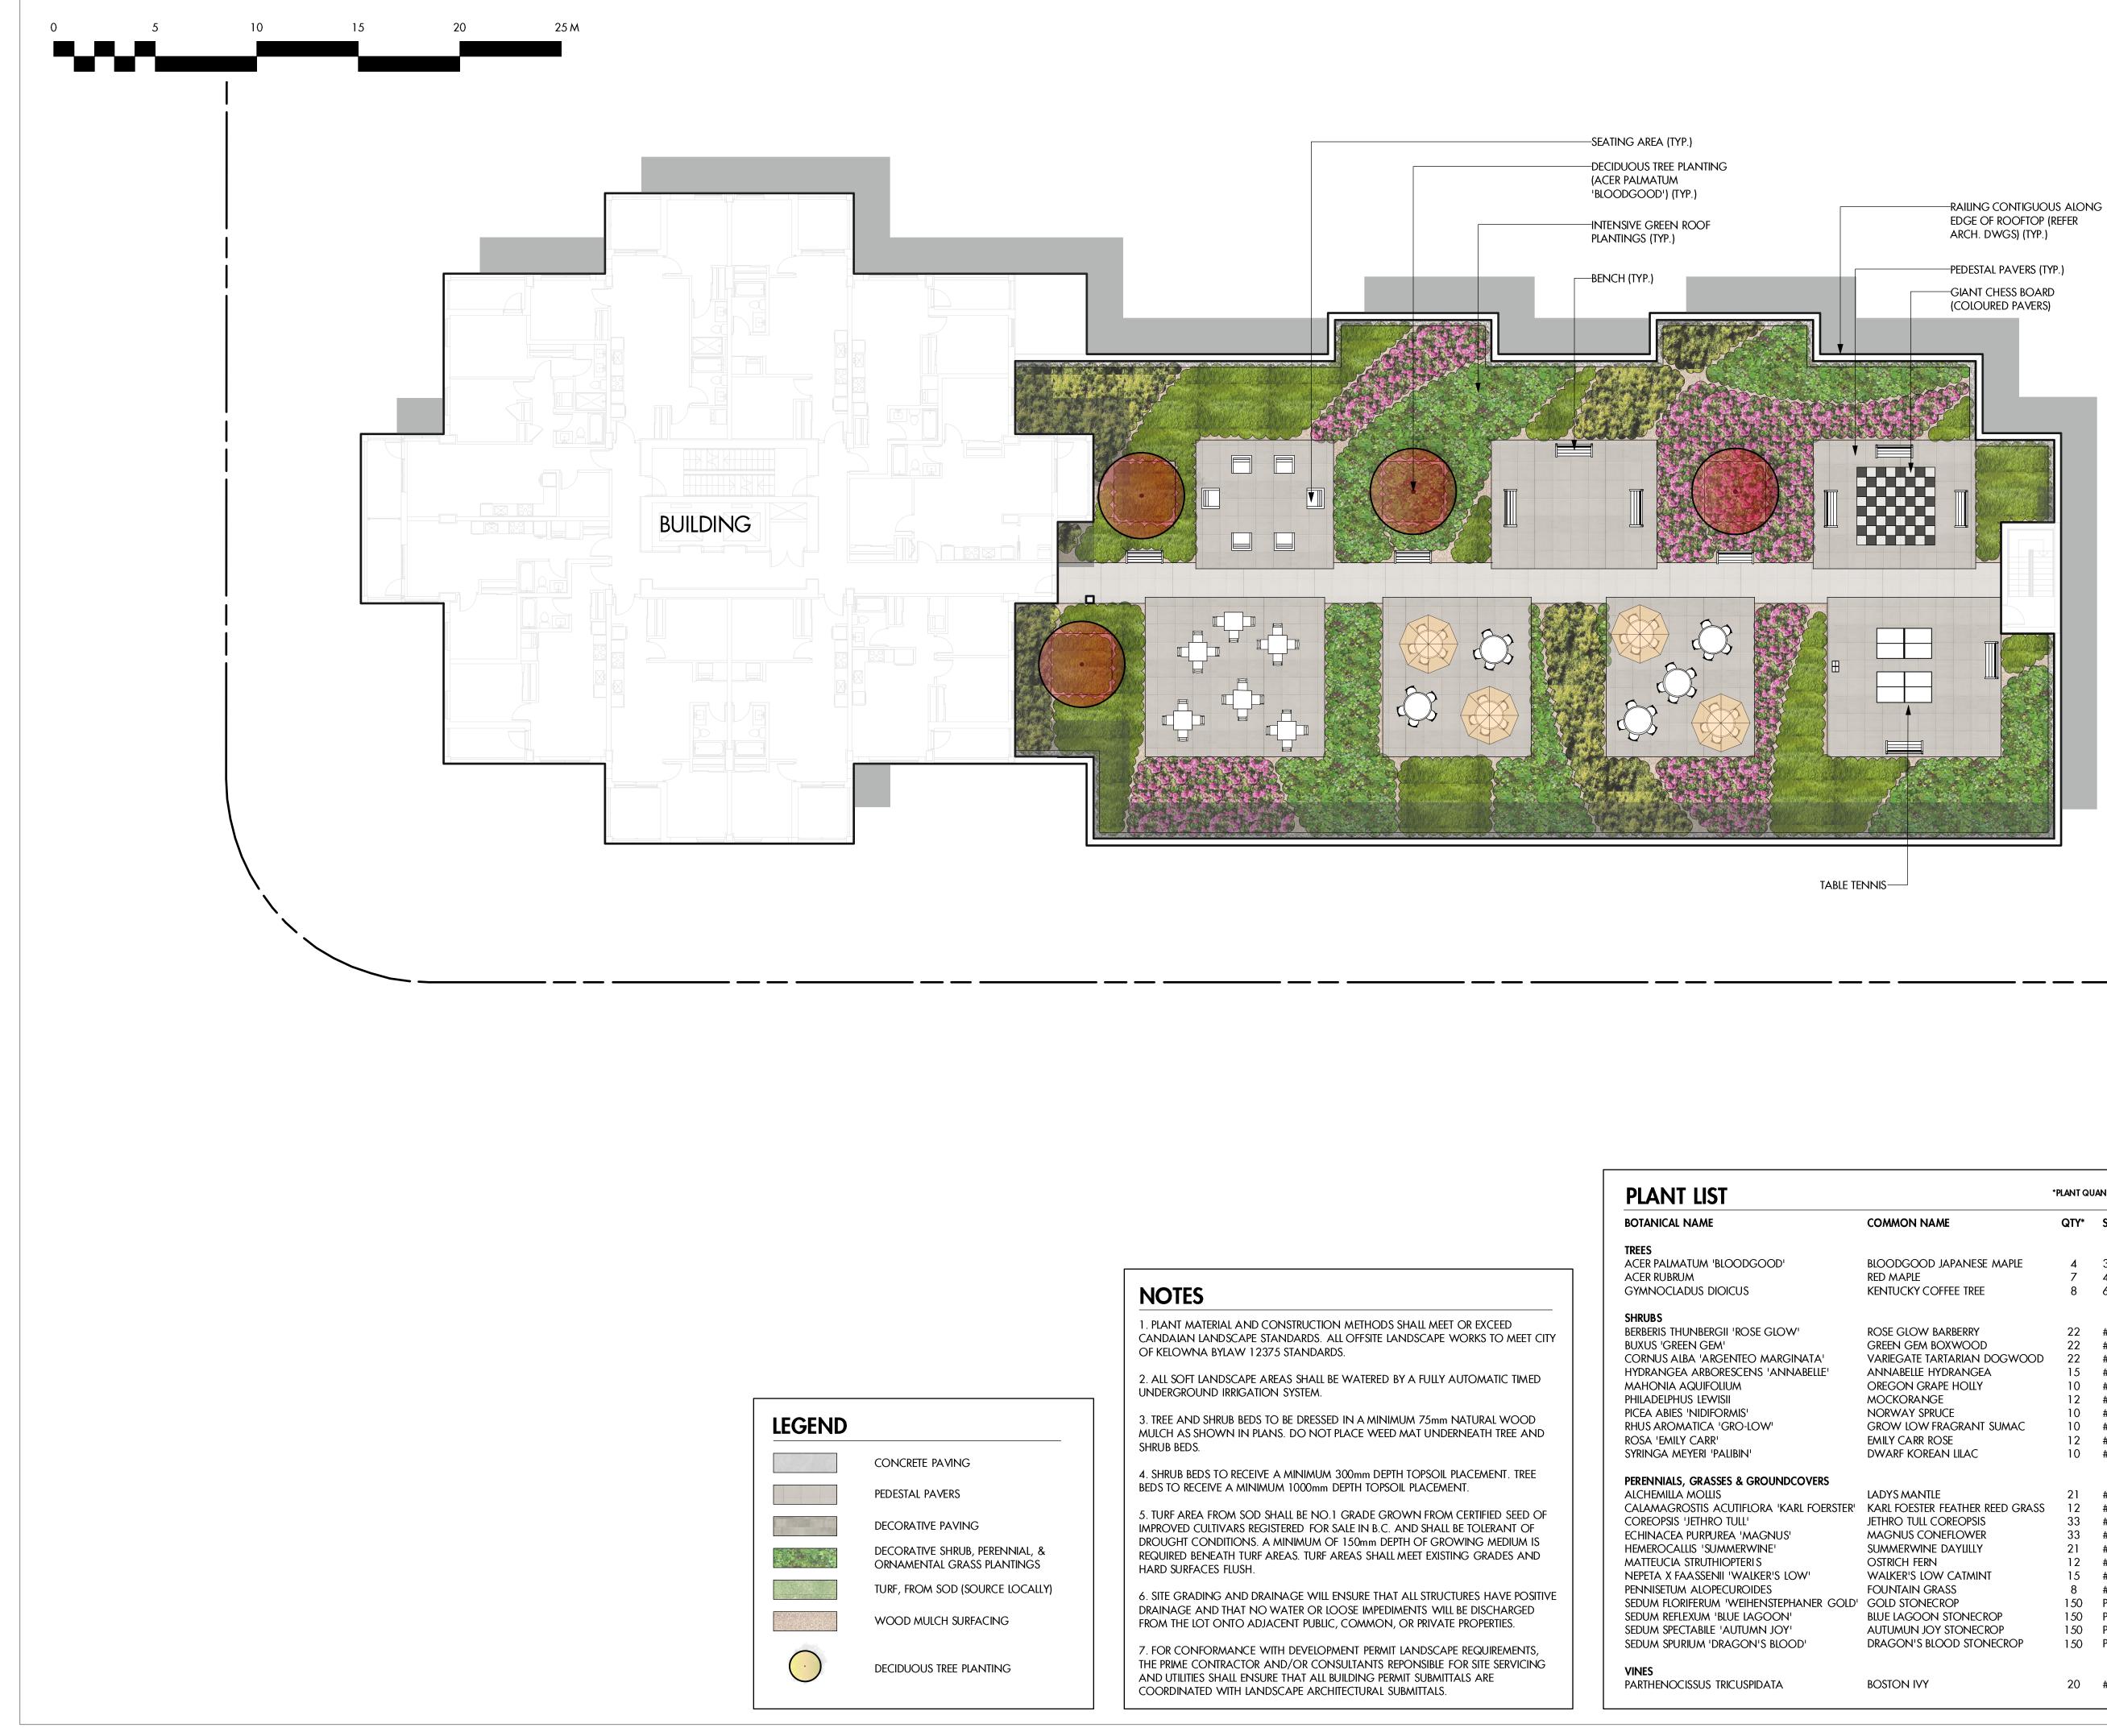

PROJECT TITLE

CAPRI TOWER

Kelowna, BC

DRAWING TITLE

CONCEPTUAL LANDSCAPE PLAN LEVEL 6

ISSUED FOR / REVISION


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2	23.06.23	Development Permit
3	23.07.13	Development Permit
4	23.11.10	Development Permit
5		


project no	21-3613	
DESIGN BY	AM	
dravvn by	NM/MC	
CHECKED BY	FB	
DATE	NOV. 10, 2023	
SCALE	1:150	
PAGE SIZE	24x36	

SEAL



drawing number

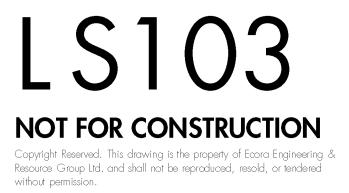

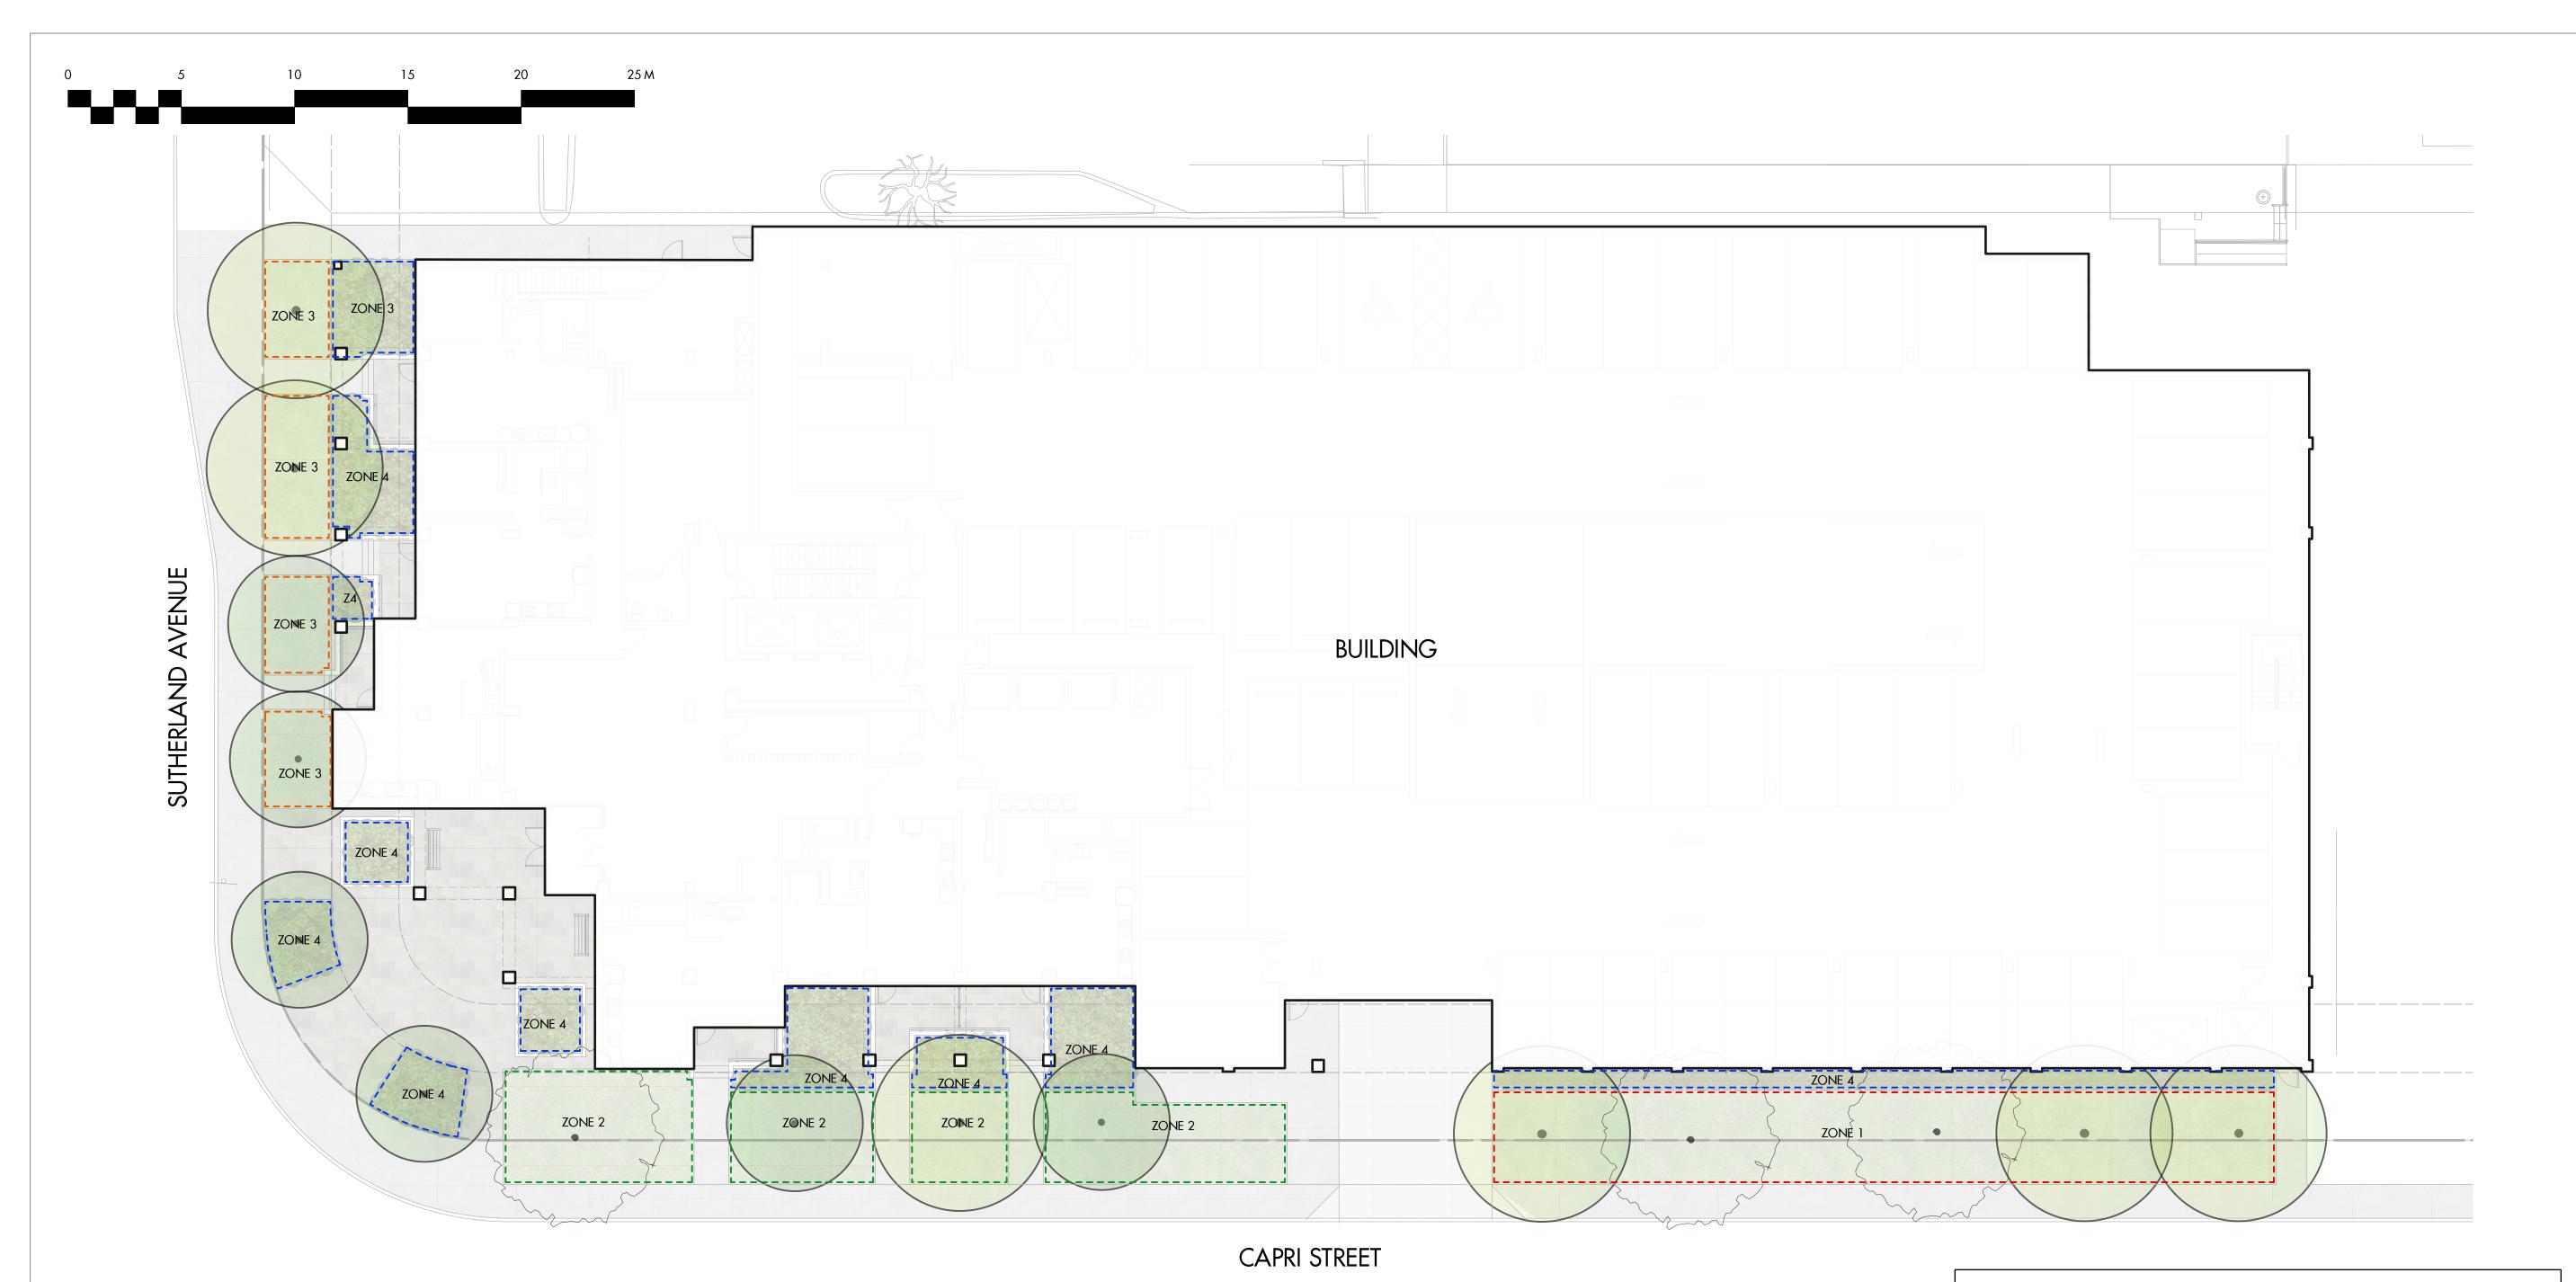

WATER CONSERVATION CALCULATIONS


LANDSCAPE MAXIMUM WATER BUDGET (WB) = 892 cu.m. / year ESTIMATED LANDSCAPE WATER USE (WU) = 670 cu.m. / year WATER BALANCE = 222 cu.m. / year *REFER ATTACHED IRRIGATION APPLICATION FOR DETAILED CALCULATIONS

RRIGATION NOTES
. IRRIGATION PRODUCTS AND INSTALLATION METHODS SHALL MEET OR EXCEED THE REQUIREMENTS OF THE WATER USE REGULATION BYLAW NO. 10480 AND THE SUPPLEMENTARY SPECIFICATIONS IN THE CITY OF KELOWNA BYLAW 7900 (PART 6, SCHEDULE 5).
2. THE IRRIGATION SYSTEM SHALL MEET THE REQUIREMENTS, REGULATIONS, AND BYLAWS OF THE WATER PURVEYOR.
3. THE IRRIGATION SYSTEM SHALL BE EQUIPPED WITH AN APPROVED BACKFLOW PREVENTION DEVICE, WATER METER, AND SHUT OFF VALVE OCATED OUTSIDE THE BUILDING ACCESSIBLE TO THE CITY.
I. AN APPROVED SMART CONTROLLER SHALL BE INSTALLED. THE IRRIGATION SCHEDULING TIMES SHALL UTILIZE A MAXIMUM ET VALUE OF 7" / MONTH (KELOWNA JULY ET), TAKING INTO CONSIDERATION SOIL TYPE, SLOPE, AND MICROCLIMATE.
5. DRIP LINE AND EMITTERS SHALL INCORPORATE TECHNOLOGY TO LIMIT ROOT INTRUSION.
5. IRRIGATION SLEEVES SHALL BE INSTALLED TO ROUTE IRRIGATION LINES UNDER HARD SURFACES AND FEATURES.
7. IRRIGATION PIPE SHALL BE SIZED TO ALLOW FOR A MAXIMUM FLOW OF 1.5m /SEC.

IRRIGATION LEGEND

[]]]]	ZONE #1: LOW VOLUME POP-UP SPRAYHEADS FOR TURF AREAS TOTAL AREA: 144 sq.m. MICROCIIMATE: SOUTHEAST EXPOSURE, PARTIALLY SHADED BY TREES AND BUILDING ESTIMATED ANNUAL WATER USE: 123 cu.m.
[]]]]	Zone #2: Low Volume Pop-UP Sprayheads for turf areas Total Area: 1:30 sq.m. Microclimate: Southwest exposure, partially shaded by trees and building Estimated annual water use: 111 cu.m.
[]]]]	ZONE #3: LOW VOLUME POP-UP SPRAYHEADS FOR TURF AREAS TOTAL AREA: 59 sq.m. MICROCLIMATE: SOUTHWEST EXPOSURE, PARTIALLY SHADED BY TREES AND BUILDING ESTIMATED ANNUAL WATER USE: 51 cu.m.
[]]]]	ZONE #4: HIGH EFFICIENCY SUBSURFACE DRIP IRRIGATION FOR MODERATE WATER USE PLANTING AREAS TOTAL AREA: 159 sq.m. MICROCLIMATE: SOUTHWEST EXPOSURE, PARTIALLY SHADED BY TREES AND BUILDING ESTIMATED ANNUAL WATER USE: 53 cu.m.
[]]]]	ZONE #5: HIGH EFFICIENCY SUBSURFACE DRIP IRRIGATION FOR MODERATE WATER USE PLANTING AREAS TOTAL AREA: 307 sq.m. MICROCLIMATE: NORTHWEST EXPOSURE, PARTIALLY SHADED BY TREES AND BUILDING ESTIMATED ANNUAL WATER USE: 102 cu.m.
[]]]]	ZONE #6: HIGH EFFICIENCY SUBSURFACE DRIP IRRIGATION FOR MODERATE WATER USE PLANTING AREAS TOTAL AREA: 356 sq.m. MICROCLIMATE: SOUTHWEST EXPOSURE, PARTIALLY SHADED BY TREES AND BUILDING ESTIMATED ANNUAL WATER USE: 119 cu.m.
[]]]]	ZONE #7: HIGH EFFICIENCY SUBSURFACE DRIP IRRIGATION FOR MODERATE WATER USE PLANTING AREAS TOTAL AREA: 331 sq.m. MICROCIJMATE: NORTHWEST EXPOSURE, PARTIALLY SHADED BY TREES AND BUILDING ESTIMATED ANNUAL WATER USE: 110 cu.m.



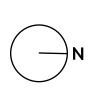

PROJECT TITLE

CAPRI TOWER

Kelowna, BC

DRAWING TITLE

WATER CONSERVATION/ IRRIGATION PLAN LEVEL 1

ISSUED FOR / REVISION

	,	
1	23.06.16	Review
2	23.06.23	Development Permit
3	23.07.13	Development Permit
4	23.11.10	Development Permit
5		


project no	21-3613	
DESIGN BY	AM	
dravvn by	NM/MC	
CHECKED BY	FB	
DATE	NOV. 10, 2023	
SCALE	1:150	
PAGE SIZE	24x36	

SEAL



DRAWING NUMBER



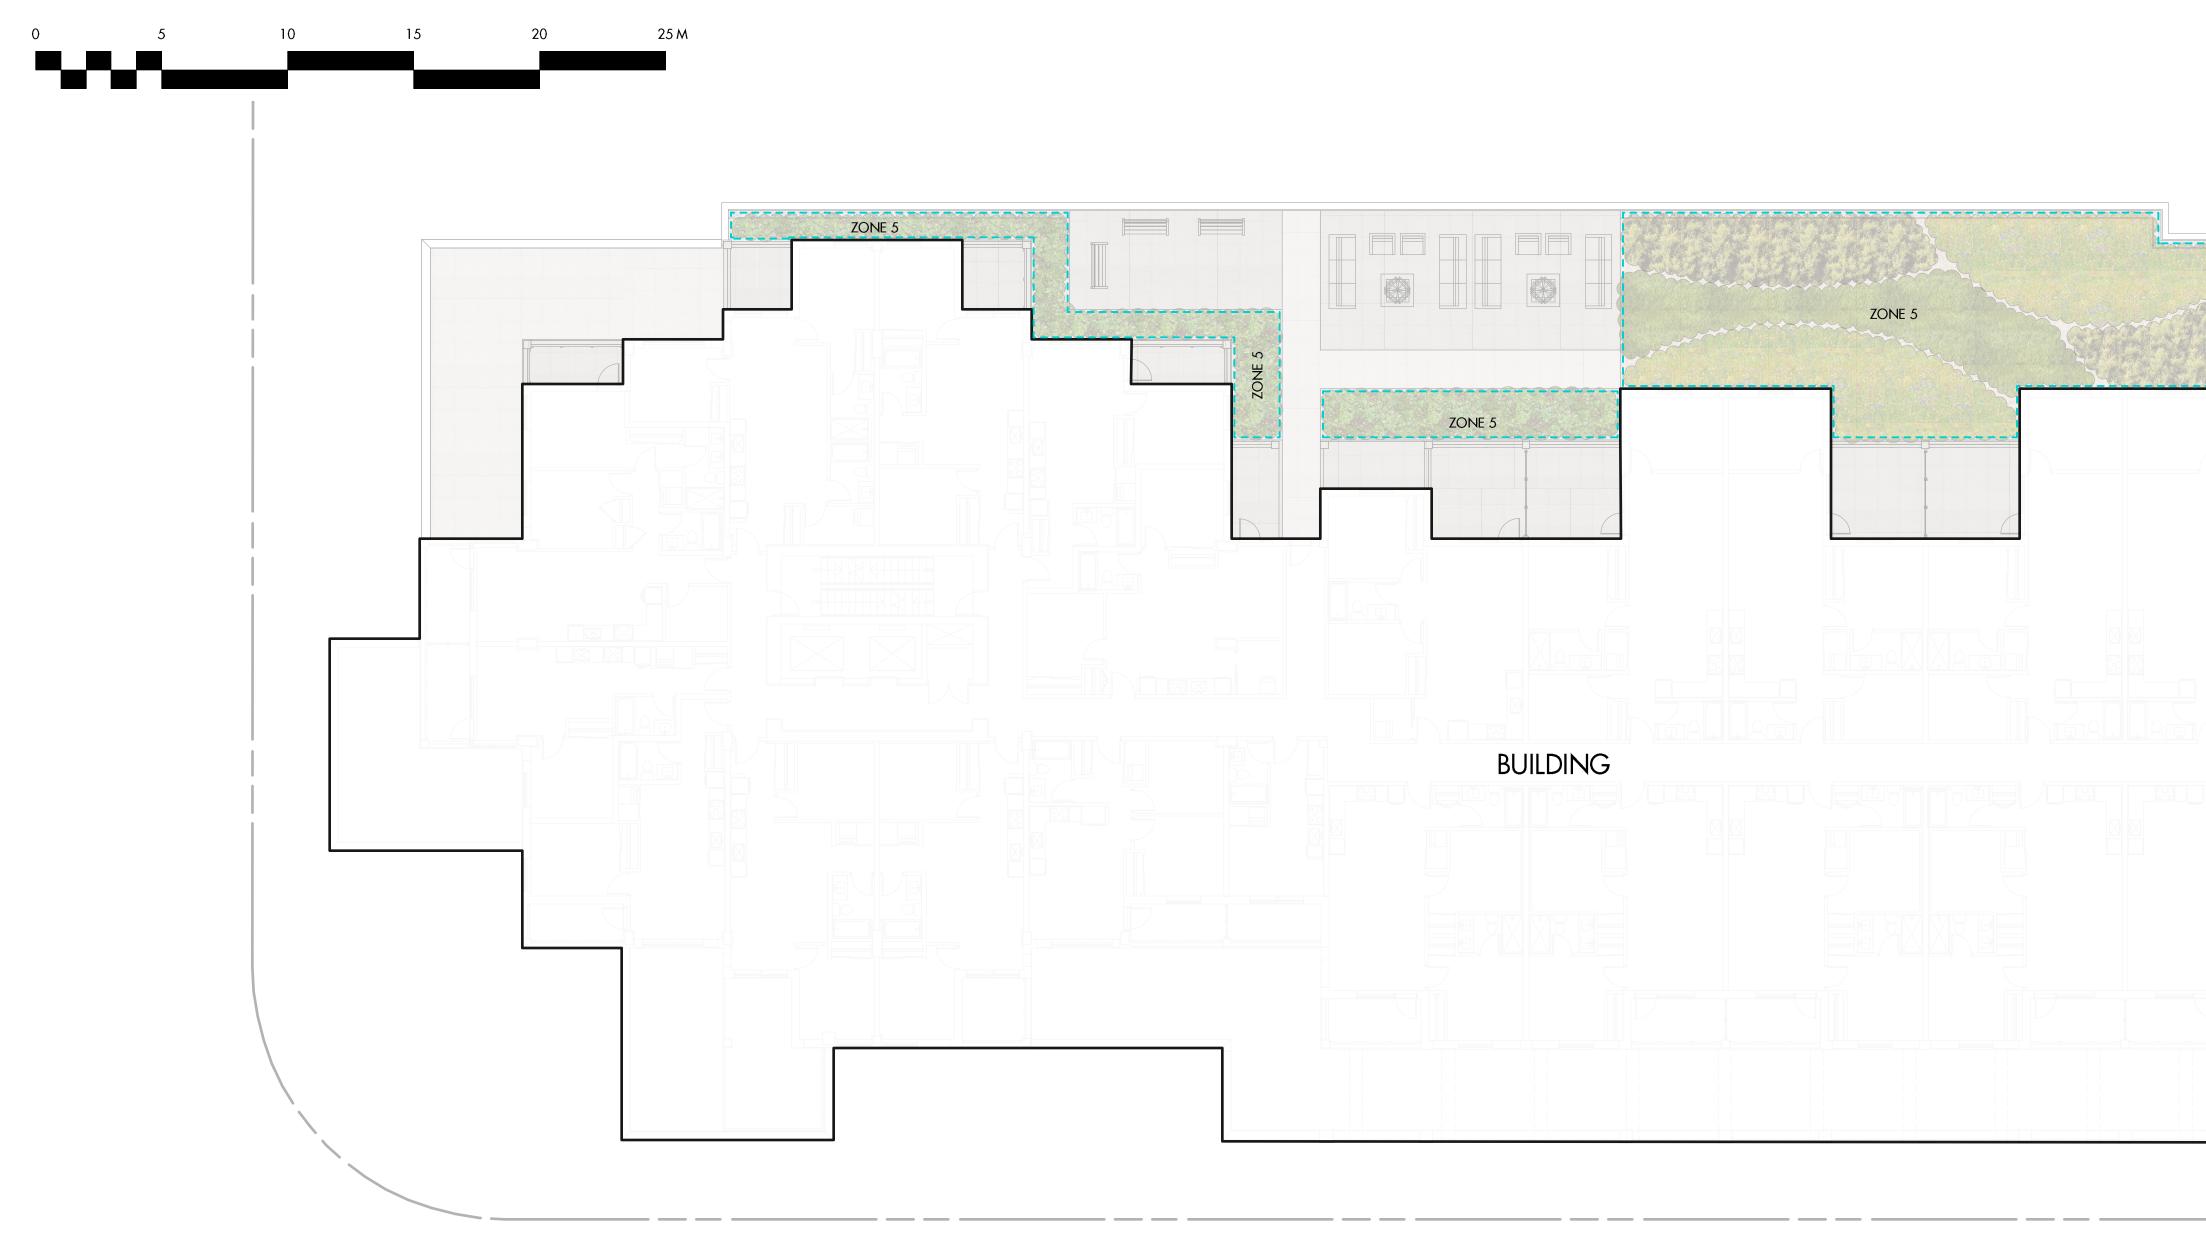

WATER CONSERVATION CALCULATIONS


LANDSCAPE MAXIMUM WATER BUDGET (WB) = 892 cu.m. / year ESTIMATED LANDSCAPE WATER USE (WU) = 670 cu.m. / year WATER BALANCE = 222 cu.m. / year *REFER ATTACHED IRRIGATION APPLICATION FOR DETAILED CALCULATIONS

	ZONE #1: LOW VOLUME POP-UP SPRAYHEADS FOR TURF AREAS TOTAL AREA: 144 sq.m. MICROCLIMATE: SOUTHEAST EXPOSURE, PARTIALLY SHADED BY TREES AND BUILDING ESTIMATED ANNUAL WATER USE: 123 cu.m.
	ZONE #2: LOW VOLUME POP-UP SPRAYHEADS FOR TURF AREAS TOTAL AREA: 130 sq.m. MICROCLIMATE: SOUTHWEST EXPOSURE, PARTIALLY SHADED BY TREES AND BUILDING ESTIMATED ANNUAL WATER USE: 111 cu.m.
	ZONE #3: LOW VOLUME POP-UP SPRAYHEADS FOR TURF AREAS TOTAL AREA: 59 sq.m. MICROCLIMATE: SOUTHWEST EXPOSURE, PARTIALLY SHADED BY TREES AND BUILDING ESTIMATED ANNUAL WATER USE: 51 cu.m.
	ZONE #4: HIGH EFFICIENCY SUBSURFACE DRIP IRRIGATION FOR MODERATE WATER USE PLANTING AREAS TOTAL AREA: 159 sq.m. MICROCLIMATE: SOUTHWEST EXPOSURE, PARTIALLY SHADED BY TREES AND BUILDING ESTIMATED ANNUAL WATER USE: 53 cu.m.
IRRIGATION NOTES	
1. IRRIGATION PRODUCTS AND INSTALLATION METHODS SHALL MEET OR EXCEED THE REQUIREMENTS OF THE WATER USE REGULATION BYLAW NO. 10480 AND THE SUPPLEMENTARY SPECIFICATIONS IN THE CITY OF KELOWNA BYLAW 7900 (PART 6, SCHEDULE 5).	ZONE #5: HIGH EFFICIENCY SUBSURFACE DRIP IRRIGATION FOR MODERATE WATER USE PLANTING AREAS TOTAL AREA: 307 sq.m.
2. THE IRRIGATION SYSTEM SHALL MEET THE REQUIREMENTS, REGULATIONS, AND BYLAWS OF THE WATER PURVEYOR.	MICROCLIMATE: NORTHWEST EXPOSURE, PARTIALLY SHADED BY TREES AND BUILDING ESTIMATED ANNUAL WATER USE: 102 cu.m.
 3. THE IRRIGATION SYSTEM SHALL BE EQUIPPED WITH AN APPROVED BACKFLOW PREVENTION DEVICE, WATER METER, AND SHUT OFF VALVE LOCATED OUTSIDE THE BUILDING ACCESSIBLE TO THE CITY. 4. AN APPROVED SMART CONTROLLER SHALL BE INSTALLED. THE IRRIGATION SCHEDULING TIMES SHALL UTILIZE A MAXIMUM ET VALUE OF 7" / MONTH (KELOWNA JULY ET), TAKING INTO CONSIDERATION SOIL TYPE, SLOPE, AND MICROCLIMATE. 	ZONE #6: HIGH EFFICIENCY SUBSURFACE DRIP IRRIGATION FOR MODERATE WATER USE PLANTING AREAS TOTAL AREA: 356 sq.m. MICROCLIMATE: SOUTHWEST EXPOSURE, PARTIALLY SHADED BY TREES AND BUILDING
5. DRIP LINE AND EMITTERS SHALL INCORPORATE TECHNOLOGY TO LIMIT ROOT INTRUSION.	ESTIMATED ANNUAL WATER USE: 119 cu.m.
6. IRRIGATION SLEEVES SHALL BE INSTALLED TO ROUTE IRRIGATION LINES UNDER HARD SURFACES AND FEATURES.	ZONE #7: HIGH EFFICIENCY SUBSURFACE DRIP IRRIGATION FOR MODERATE WATER USE PLANTING AREAS
7. IRRIGATION PIPE SHALL BE SIZED TO ALLOW FOR A MAXIMUM FLOW OF 1.5m /SEC.	TOTAL AREA: 331 sq.m. MICROCLIMATE: NORTHWEST EXPOSURE, PARTIALLY SHADED BY TREES AND BUILDING
8. A FLOW SENSOR AND MASTER VALVE SHALL BE CONNECTED TO THE CONTROLLER AND PROGRAMMED TO STOP FLOW TO THE SYSTEM IN CASE OF AN IRRIGATION WATER LEAK.	ESTIMATED ANNUAL WATER USE: 110 cu.m.

ZONE 5

IRRIGATION LEGEND



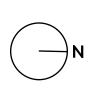

PROJECT TITLE

CAPRI TOWER

Kelowna, BC

DRAVVING TITLE

WATER CONSERVATION/ IRRIGATION PLAN LEVEL 3

ISSUED FOR / REVISION

1	23.06.16	Review
2	23.06.23	Development Permit
3	23.07.13	Development Permit
4	23.11.10	Development Permit
5		


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design by	AM	
dravvn by		
CHECKED BY	FB	
DATE	NOV. 10, 2023	
SCALE	1:150	
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SEAL



DRAWING NUMBER

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LANDSCAPE MAXIMUM WATER BUDGET (WB) = 892 cu.m. / year ESTIMATED LANDSCAPE WATER USE (WU) = 670 cu.m. / year WATER BALANCE = 222 cu.m. / year *REFER ATTACHED IRRIGATION APPLICATION FOR DETAILED CALCULATIONS

	[[]]
	[
	[
	[]]]
IRRIGATION NOTES	
1. IRRIGATION PRODUCTS AND INSTALLATION METHODS SHALL MEET OR EXCEED THE REQUIREMENTS OF THE WATER USE REGULATION BYLAW NO. 10480 AND THE SUPPLEMENTARY SPECIFICATIONS IN THE CITY OF KELOWNA BYLAW 7900 (PART 6, SCHEDULE 5).	r
2. THE IRRIGATION SYSTEM SHALL MEET THE REQUIREMENTS, REGULATIONS, AND BYLAWS OF THE WATER PURVEYOR.	·
3. THE IRRIGATION SYSTEM SHALL BE EQUIPPED WITH AN APPROVED BACKFLOW PREVENTION DEVICE, WATER METER, AND SHUT OFF VALVE LOCATED OUTSIDE THE BUILDING ACCESSIBLE TO THE CITY.	
4. An approved smart controller shall be installed. The irrigation scheduling times shall utilize a maximum et value of 7" / Month (Kelowna July et), taking into consideration soil type, slope, and microclimate.	
5. DRIP LINE AND EMITTERS SHALL INCORPORATE TECHNOLOGY TO LIMIT ROOT INTRUSION.	
6. IRRIGATION SLEEVES SHALL BE INSTALLED TO ROUTE IRRIGATION LINES UNDER HARD SURFACES AND FEATURES.	
7. IRRIGATION PIPE SHALL BE SIZED TO ALLOW FOR A MAXIMUM FLOW OF 1.5m /SEC.	

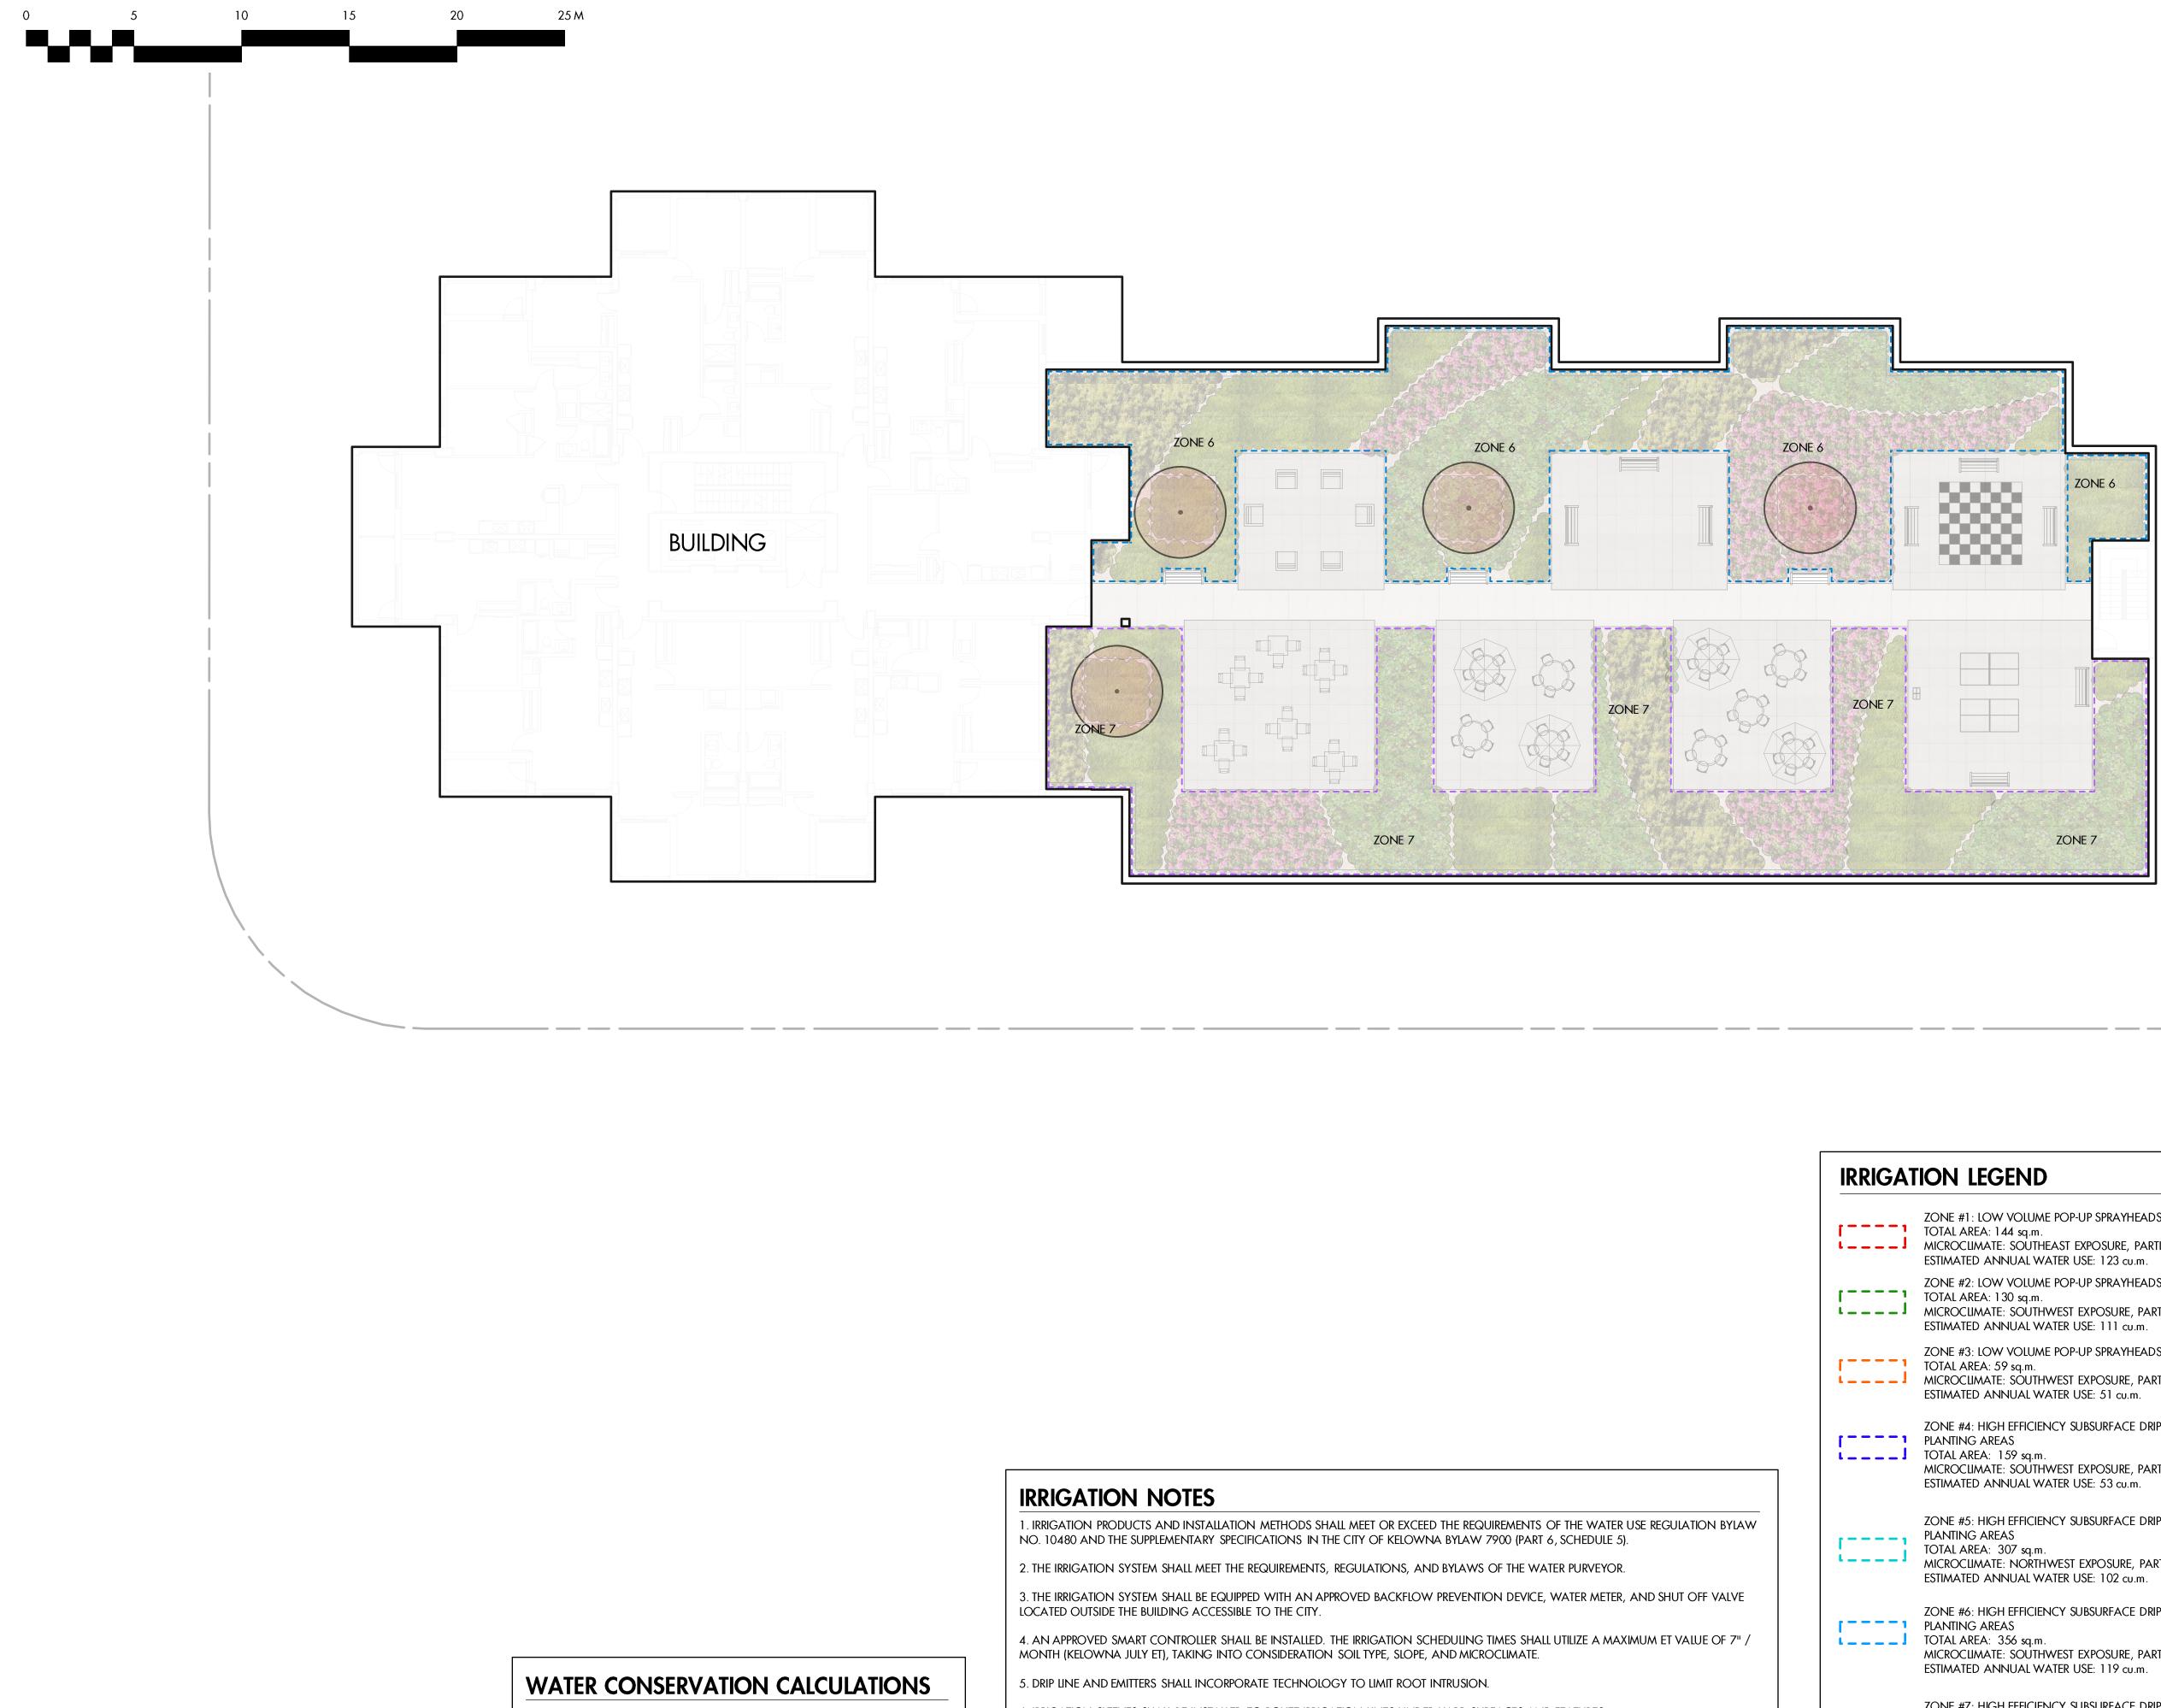

]	Zone #1: Low Volume Pop-UP Sprayheads for Turf Areas Total Area: 144 sq.m. Microclimate: Southeast Exposure, partially shaded by trees and building Estimated Annual Water USE: 123 cu.m.
- 1 _]	ZONE #2: LOW VOLUME POP-UP SPRAYHEADS FOR TURF AREAS TOTAL AREA: 130 sq.m. MICROCLIMATE: SOUTHWEST EXPOSURE, PARTIALLY SHADED BY TREES AND BUILDING ESTIMATED ANNUAL WATER USE: 111 cu.m.
]]	Zone #3: Low Volume Pop-up Sprayheads for turf areas Total Area: 59 sq.m. Microclimate: Southwest exposure, partially shaded by trees and building Estimated annual water use: 51 cu.m.
]]	ZONE #4: HIGH EFFICIENCY SUBSURFACE DRIP IRRIGATION FOR MODERATE WATER USE PLANTING AREAS TOTAL AREA: 159 sq.m. MICROCLIMATE: SOUTHWEST EXPOSURE, PARTIALLY SHADED BY TREES AND BUILDING ESTIMATED ANNUAL WATER USE: 53 cu.m.
]	ZONE #5: HIGH EFFICIENCY SUBSURFACE DRIP IRRIGATION FOR MODERATE WATER USE PLANTING AREAS TOTAL AREA: 307 sq.m. MICROCLIMATE: NORTHWEST EXPOSURE, PARTIALLY SHADED BY TREES AND BUILDING ESTIMATED ANNUAL WATER USE: 102 cu.m.
]	ZONE #6: HIGH EFFICIENCY SUBSURFACE DRIP IRRIGATION FOR MODERATE WATER USE PLANTING AREAS TOTAL AREA: 356 sq.m. MICROCLIMATE: SOUTHWEST EXPOSURE, PARTIALLY SHADED BY TREES AND BUILDING ESTIMATED ANNUAL WATER USE: 119 cu.m.
]]	Zone #7: High Efficiency Subsurface DRIP Irrigation for moderate water use Planting Areas Total Area: 331 sq.m. Microclimate: Northwest exposure, partially shaded by trees and building Estimated Annual water use: 110 cu.m.



PROJECT TITLE

CAPRI TOWER

Kelowna, BC

DRAWING TITLE

WATER CONSERVATION/ **IRRIGATION PLAN** LEVEL 6

ISSUED FOR / REVISION

1	23.06.16	Review
2	23.06.23	Development Permit
3	23.07.13	Development Permit
4	23.11.10	Development Permit
5		

project no	21-3613	
design by	AM	
dravvn by	NM/MC	
CHECKED BY	FB	
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SCALE	1:150	
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