#### MARWAHA DESIGNS INC.

778-318-4874 <u>creative.marwaha@gmail.com, info@marwahazdesigns.com,</u> 106-460 Doyle Ave., Kelowna (BC) V1Y 0C2 <u>www.marwahazdesigns.com</u>

### Design Rationale

Project address -1020 Graham Rd. City of Kelowna Client Name - BC 1039634 BC LTD. (Inderjit Chhokar and Sandeep Kaur Chhokar)

#### Context response

1020 Graham road is currently zoned under MF1 as 4 to 6 plexus Residential with all family residences in the area. As per 2040 Official Community Plan of Kelowna, it is one of the fastest growing cities of Canada and will be home to another 45,000 people in coming years. Therefore, densification of land is proposed in OCP with focus on more multifamily houses. As per OCP, the future land use of area is Core Area Neighborhood (C-NHD). The Core Area Neighborhoods will accommodate much of the city's growth through sensitive residential infill, some low rise buildings permitted in strategically located properties. Single and Four family dwelling, secondary suites and carriage houses and Ground-oriented multi-unit housing are supported in core area neighborhoods. The property is MF-1 zone for 4 to 6 plexus housing with maximum Site Covered of 0.55.

Moreover, this lot is 1821 Square meter compared to other 900 square meter lots in the area and therefore has more potential for redevelopment.



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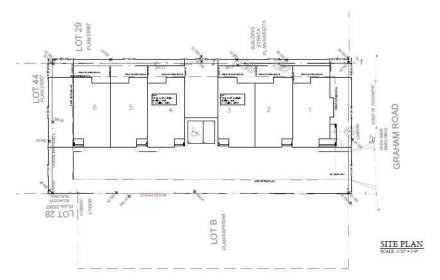
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### Site Organization

The site is divided into 2 parts with 3 and 3 units on either side. Each unit have its own separate entrance and two car garage. The site is accessed from Graham road with 6m driveway from side with common landscaping area on rear side of the lot. The private open space is for each 6 units is on one of the side setback. The site also have accessible and visitor car parking spaces.



#### **Basic Building Form**

Responding to basic two-storey character of Graham road, the townhouse is 2 storeys above grade. The overall massing of site is simple with first floor is dark with chestnut brown hardie and second floor with grey hardie wall to reduce the visual height of building. The recessed balconies with glass railing on rear side of building are above private open spaces for each townhouse.



## **PROPOSED MULTIPLE** 1020 GRAHAM RD. **DWELLING** KELOWNA (BC)

PROJECT DATA

1020 GRAHAM ROAD, CITY OF KELOWNA CIVIC ADDRESS PLAN KAP28367 LOT 43 SECTION 22 TOWNSHIP 26 003-458-539

CURRENT ZONING: MF1

LOT AREA:

1839.98 SQM (19805.37 SQFT)

SITE COVERAGE

55% SITE COVERAGE OF ALL BUILDING 75% SITE COVERAGE OF ALL BUILDING, STRUCTURE AND PERMEABLE SURFACES. ALLOWED 1011.98 5QM (10892.95 5QFT) 1379.98 5QM (14854.02 5QFT)

FAR ALLOWED 1.0 1839.98 (19805.37 SQFT)

PROPOSED AREA:

MAIN FLOOR FIRST FLOOR GARAGE AREA 5200.23 SQFT (483.11 SQM) 6697.79 SQFT (622.24 SQM) 2268.0 SQFT (210.70 SQM)

14166.02 SQFT (1,316.06 SQM)

SITE COVERAGE PROPOSED

PROPOSED

TOTAL AREA:


MAIN FLOOR PORCH TOTAL: 7468.23 5QFT (693.82 5QM) 224.11 5QFT (20.82 5QM) 7692.34 5QFT (714.64 5QM) 38.83%


DRIVEWAY & WALKWAY=3983.71 SQFT(351.51 SQM) 20.119

TOTAL SITE COVERAGE=3983.71 SQFT + 7692.34 SQFT =11,676.05 SQFT (1084.74 SQM) 58.95%

HEIGHT

ALLOWED PROVIDED 9.0m 7.63M

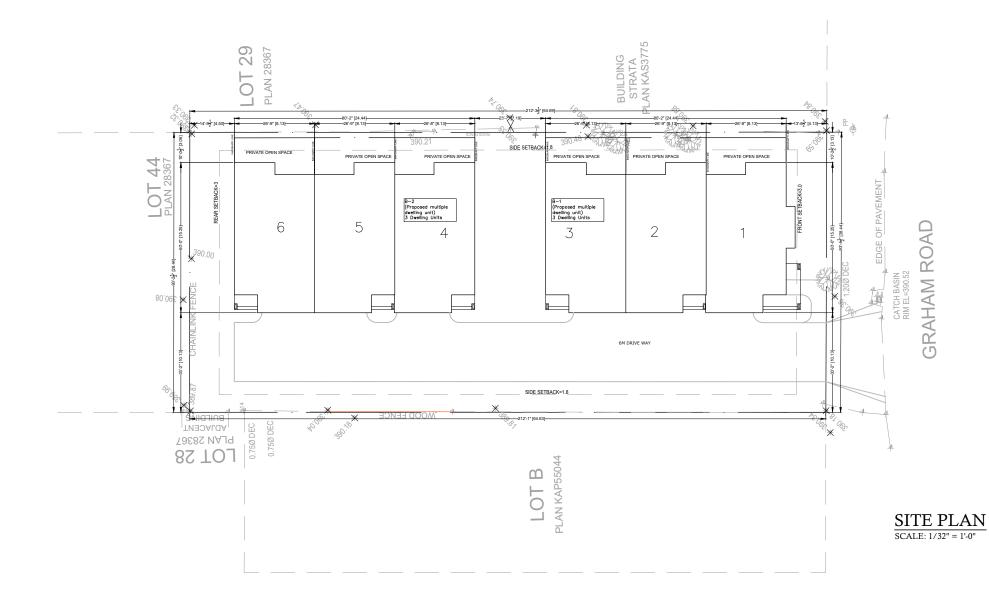

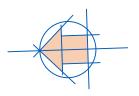



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PROPOSED MULTIPLE DWELLING 1020 GRAHAM ROAD KELOWNA, BC

INDERJIT SINGH


SITE PLAN

THE CONTRACTOR IS TO CONFIRM ALL MEASUREMENTS AND REPORT ANY ERORS OR OMISSIONS BACK TO MARWAHA DESIGNS INC. BEFORE COMMENCING WRK. MARWAHA DESIGNS INC WILL NOT BE LIABLE FOR ANY ERRORS OR OMISSIONS. ALL WORK IS TO BE DONE IN ACCORDANCE WITH THE CURRENT PART 9 OF THE BCBC. LOADS NOT COVERED IN THE BUILDING CODE WILL REQUIRE AN ENGINEER AND IS THE RESPONSIBILITY OF THE CONTRACTOR TO SECURE. THIS PLAN IS EXCLUSIVE PROPERTY OF MARWAHA DESIGNS INC. AND MAY NOT BE REPRODUCED WITH OUT WRITTEN CONSENT.


A-101

## PROPOSED MULTIPLE


# MULTIPLE 1020 GRAHAM RD. DWELLING KELOWNA (BC)

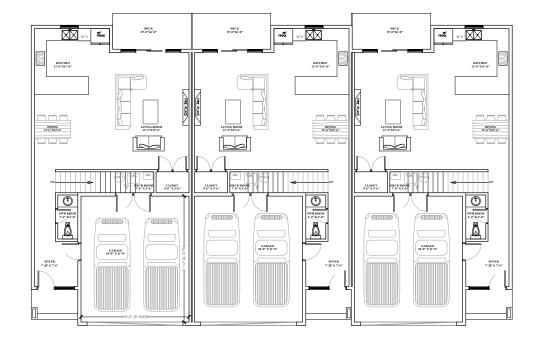

MAIN FLOOR PLAN B-2
SCALE: 1/16" = 1'-0"
PROPOSED FLOOR: 860.74 SQ.FT. Per DU
GARAGE: 378 SQ.FT. EACH

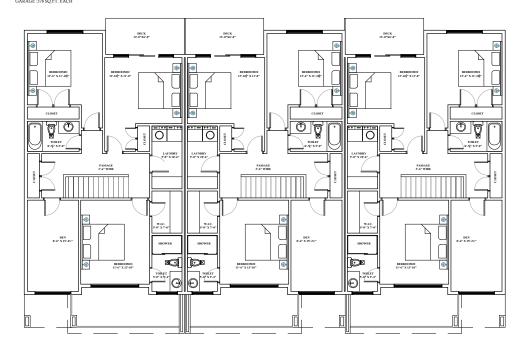

FIRST FLOOR PLAN B-2 SCALE: 1/16" = 1'-0"

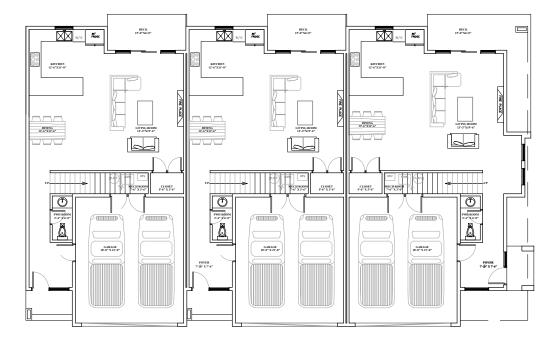

MAIN FLOOR PLAN B-1
SCALE: 1/16" = 1"·0"
PROPOSED FLOOR: \$60.74 SQ.FT. Per DU
GARAGE: 378 SQ.FT. EACH



FIRST FLOOR PLAN B-1
SCALE: 1/16" = 1'-0"

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PROJECT:

PROPOSED MULTIPLE

DWELLING

1020 GRAHAM ROAD

KELOWNA, BC

INDERJIT SINGH

DRAWN: 85

CHECKED: HS

SCALE: 1/16° = 1'-0"

JOB NO.: KEL-ND-380(N)

DAIE: 24/03/2024

FLOOR PLANS

DRAWING NO.:

A-102



6'0"x6'0" 6'0"x6'0" 6'0"x6'0" 10'0"x8'0" EAST ELEVATION B-1

6'0" 2'0"

SOUTH ELEVATION B-1





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#### MATERIAL SPECIFCATIONS:

- 1. Grey Hardie Siding.
- 2. Chestnut Brown Hardie Siding.
- Vinyl Window with 2x5 Trim.
- 4. Fibre Glass Door.
- 5. Asphalt Shingles.
- 36" High Wooden Railing
- 7. 36" High MS Railing



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PROPOSED MULTIPLE **DWELLING** 1020 GRAHAM ROAD KELOWNA, BC

INDERJIT SINGH

SCALE: 3/32" = 1'-0" JOB No.: KEL-IND-380(IN)

**ELEVATIONS** 

A-103













- 1. Grey Hardie Siding.
- 2. Chestnut Brown Hardie Siding.
- Vinyl Window with 2x5 Trim.
- 4. Fibre Glass Door.
- 5. Asphalt Shingles.
- 36" High Wooden Railing
- 36" High MS Railing



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PROPOSED MULTIPLE **DWELLING** 1020 GRAHAM ROAD KELOWNA, BC

INDERJIT SINGH

JOB No.: KEL-IND-380(IN)


**ELEVATIONS** 

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A-104







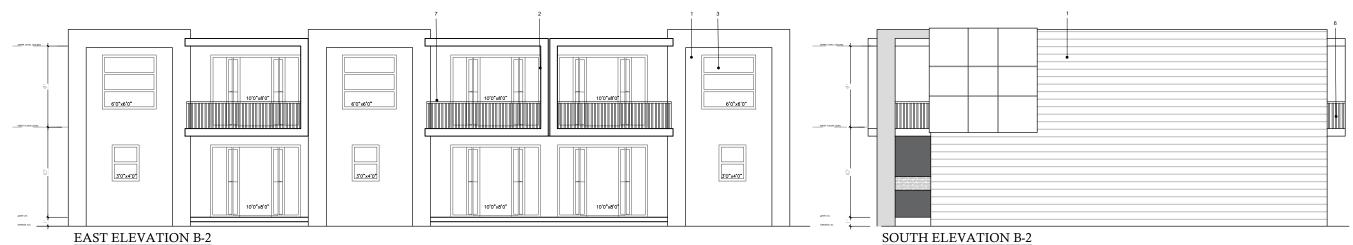












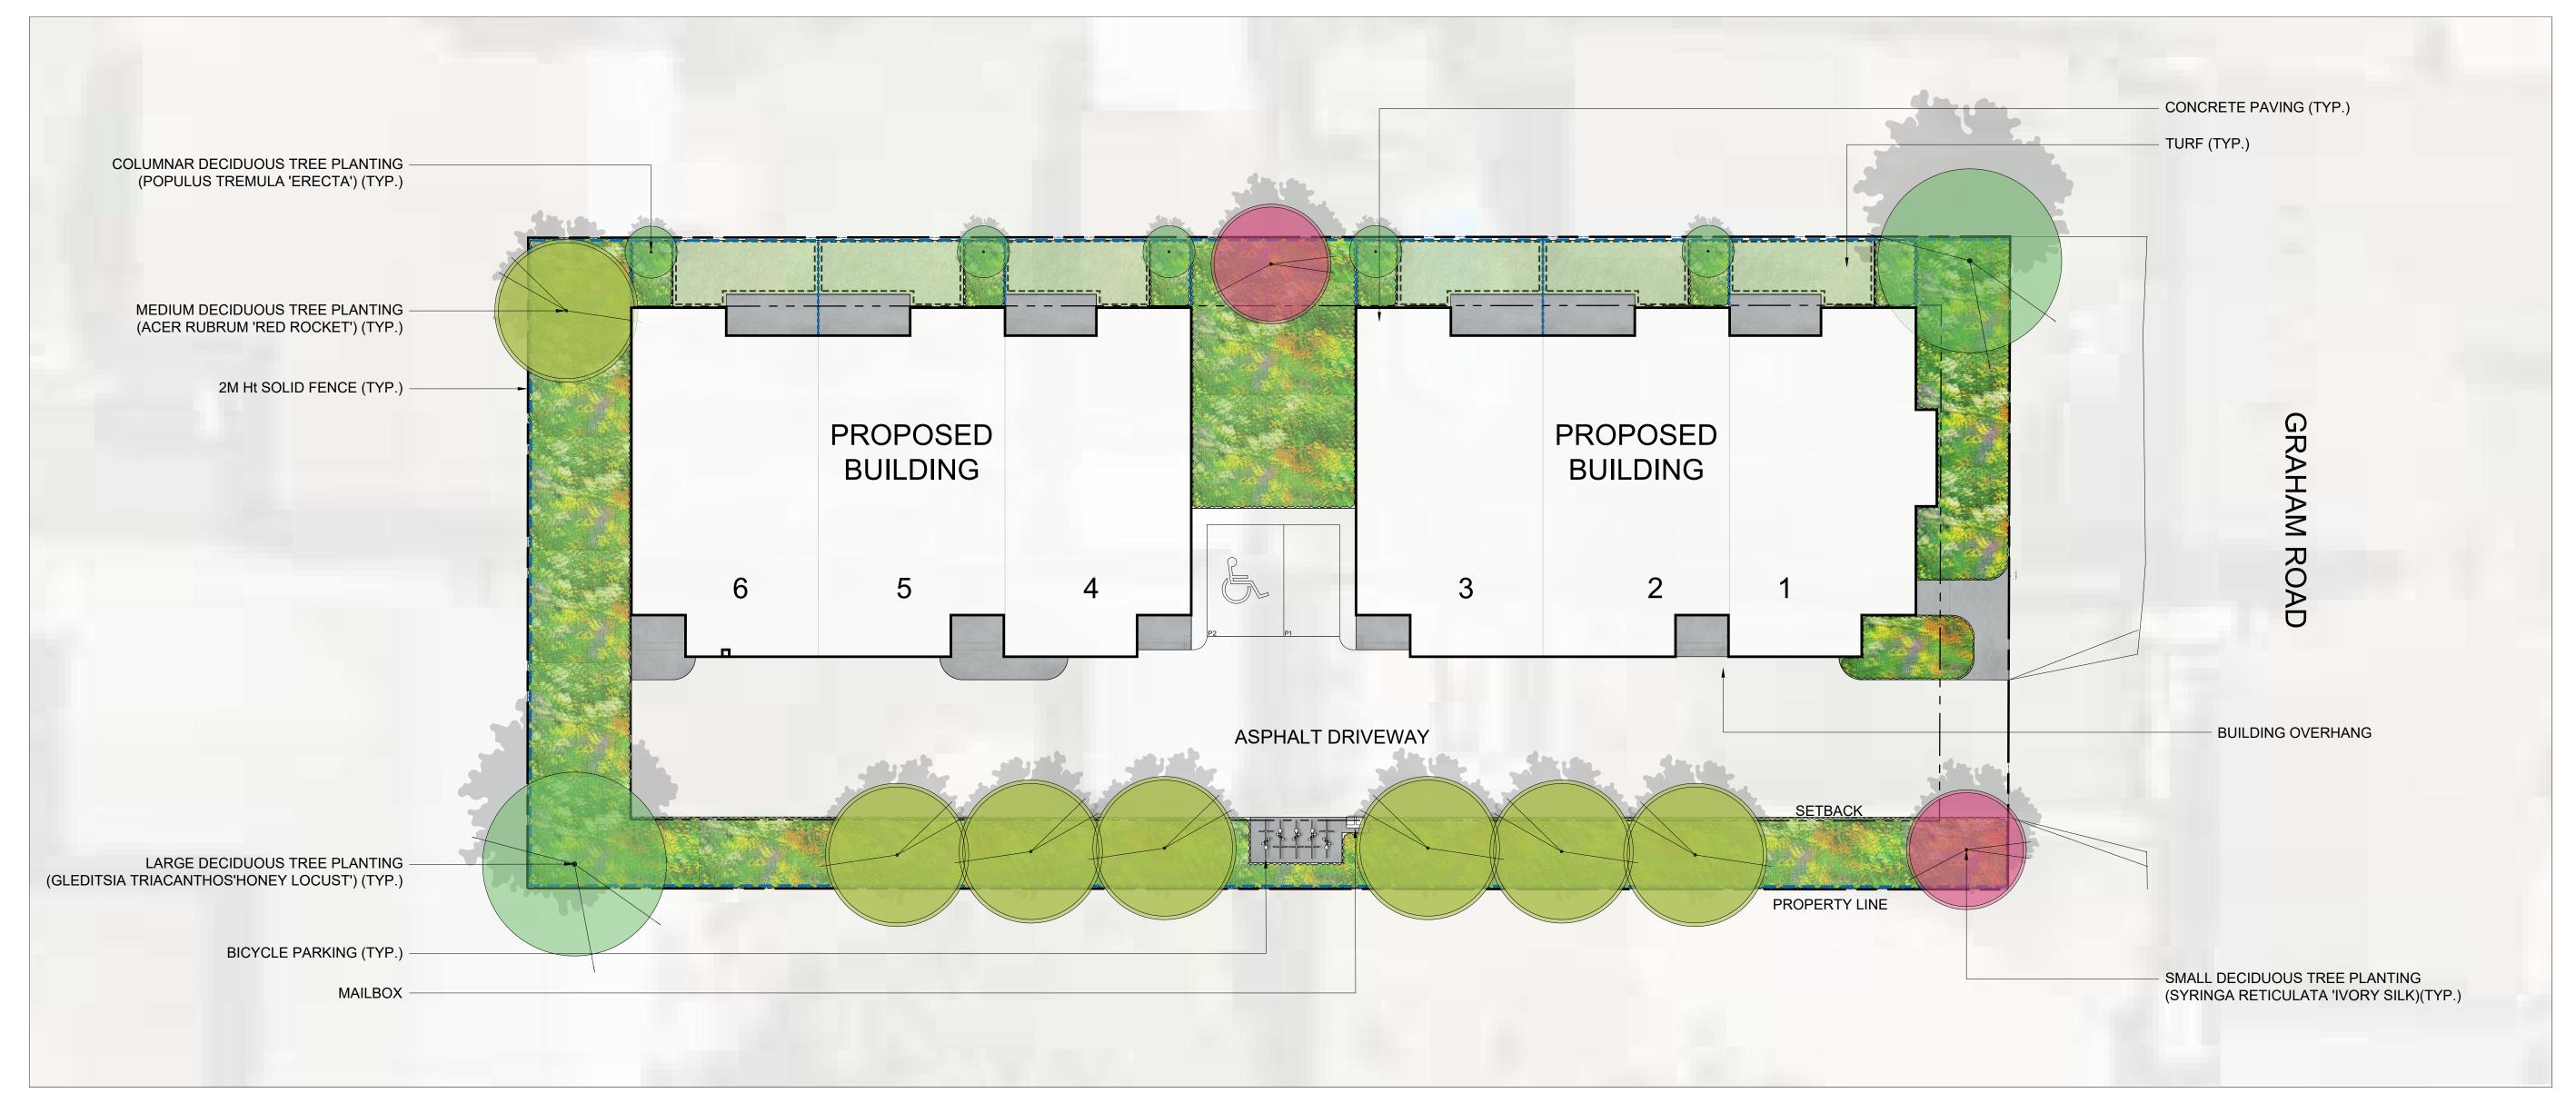



PROJECT TITLE

1020 GRAHAM ROAD

Kelowna, BC

DRAWING TITLE

## CONCEPTUAL LANDSCAPE PLAN

1	22.08.22	Review	
2	23.08.23	Review	
3	23.10.11	Review	
4	23.10.17	DP	
5			

PROJECT NO	22-0790
DESIGN BY	GS
DRAWN BY	GS
CHECKED BY	FB
DATE	Aug. 23th, 2023
SCALE	1:150
PAGE SIZE	24" x 36"



DRAWING NUMBER

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## NOTES

1. PLANT MATERIAL AND CONSTRUCTION METHODS SHALL MEET OR EXCEED CSLA STANDARDS. ALL OFFSITE LANDSCAPE WORKS TO MEET CITY OF KELOWNA BYLAW 7900 STANDARDS.

2. ALL SOFT LANDSCAPE AREAS SHALL BE WATERED BY A FULLY AUTOMATIC TIMED UNDERGROUND IRRIGATION SYSTEM.

3. TREE AND SHRUB BEDS TO BE DRESSED IN A MINIMUM 75mm NATURAL WOOD MULCH AS SHOWN IN PLANS. DO NOT PLACE WEED MAT UNDERNEATH TREE AND SHRUB BEDS.

4. TREE AND SHRUB BEDS TO RECEIVE A MINIMUM 300mm DEPTH TOPSOIL PLACEMENT.

5. TURF AREA FROM SOD SHALL BE NO.1 GRADE GROWN FROM CERTIFIED SEED OF IMPROVED CULTIVARS REGISTERED FOR SALE IN B.C. AND SHALL BE TOLERANT OF DROUGHT CONDITIONS. A MINIMUM OF 150mm DEPTH OF GROWING MEDIUM IS REQUIRED BENEATH TURF AREAS. TURF AREAS SHALL MEET EXISTING GRADES AND HARD SURFACES FLUSH.

6. SITE GRADING AND DRAINAGE WILL ENSURE THAT ALL STRUCTURES HAVE POSITIVE DRAINAGE AND THAT NO WATER OR LOOSE IMPEDIMENTS WILL BE DISCHARGED FROM THE LOT ONTO ADJACENT PUBLIC, COMMON, OR PRIVATE PROPERTIES.

## PLANT LIST \*PLANT LIST ESTIMATED ONLY. NOT FOR PRICING\*

**BOTANICAL NAME COMMON NAME** RED ROCKET MAPLE

TREES ACER RUBRUM 'RED ROCKET' GLEDITSIA TRIACANTHOS SYRINGA RETICULATA 'IVORY SILK' POPULUS TREMULA 'ERECTA'

SHRUBS BERBERIS THUNBERGII 'GENTRY' BUXUS 'GREEN VELVET' PICEA ABIES 'LITTLE GEM' SPIRAEA JAPONICA 'GOLDMOUND' TAXUS X MEDIA 'HICKSII'

PERENNIALS & GRASSES ASTILBE JAPONICA 'PEACH BLOSSOM' CALAMAGROSTIS ACUTIFLORA 'KARL FOERSTER' HOSTA 'STRIPTEASE' LAVANDULA ANGUSTIFOLIA 'HIDCOTE' PENNISETUM ORIENTALE 'KARLEY ROSE' RUDBECKIA FULGIDA 'GOLDSTURM'

SEDUM SPECTABILE 'AUTUMN FIRE'

HONEY LOCUST IVORY SILK LILAC TREE SWEDISH COLUMNAR ASPEN

ROYAL BURGUNDY BARBERRY GREEN VELVET BOXWOOD LITTLE GEM NORWAY SPRUCE GOLDMOUND SPIREA HICK'S YEW

AUTUMN FIRE STONECROP

PEACH BLOSSOM ASTILBE STRIPTEASE HOSTA HIDCOTE ENGLISH LAVENDER KARLEY ROSE FOUNTAIN GRASS GOLDSTURM CONEFLOWER

8 #01 CONT. /0.9M O.C. SPACING KARL FOERSTER FEATHER REED GRASS 7 #01 CONT. /1.0M O.C. SPACING

QTY\* SIZE/SPACING & REMARKS

13 #02 CONT. /1.2M O.C. SPACING

23 #02 CONT. /0.9M O.C. SPACING

19 #02 CONT. /1.0M O.C. SPACING

23 #02 CONT. /0.9M O.C. SPACING

34 #02 CONT. /0.75M O.C. SPACING

7 6cm CAL.


5 6cm CAL.

6cm CAL.

6cm CAL.

#01 CONT. /0.9M O.C. SPACING 12 #01 CONT. /0.75M O.C. SPACING #01 CONT. /1.2M O.C. SPACING 12 #01 CONT. /0.75M O.C. SPACING 12 #01 CONT. /0.75M O.C. SPACING



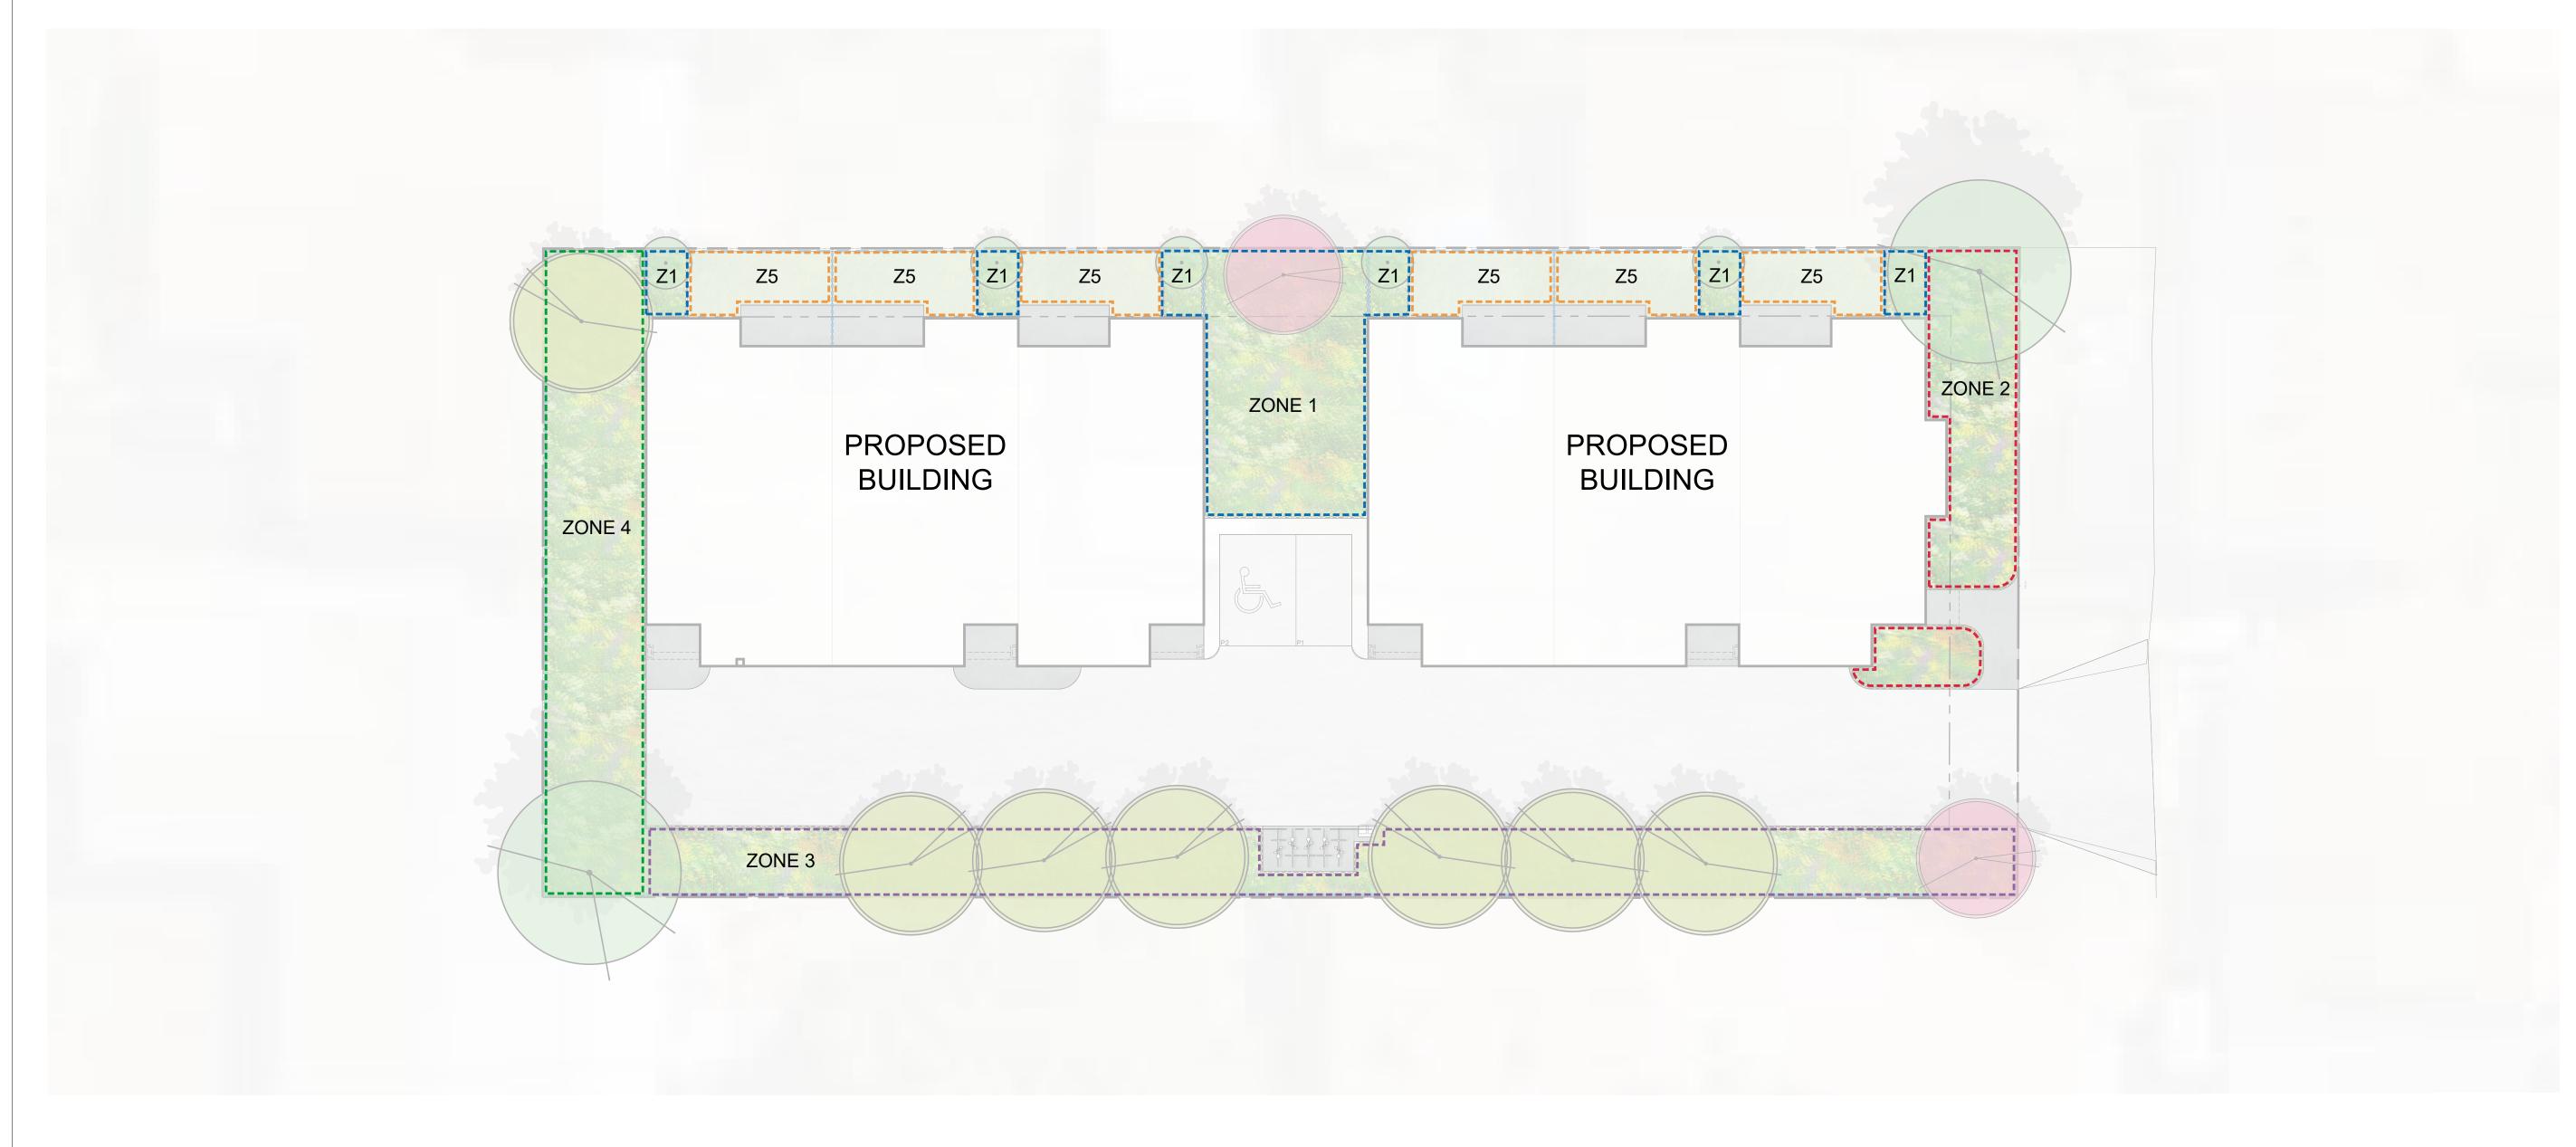

## WATER CONSERVATION CALCULATIONS

LANDSCAPE MAXIMUM WATER BUDGET (WB) = 233 cu.m. / year ESTIMATED LANDSCAPE WATER USE (WU) = 232 cu.m. / year WATER BALANCE = 1 cu.m. / year

\*REFER ATTACHED IRRIGATION APPLICATION FOR DETAILED CALCULATIONS

## IRRIGATION LEGEND

1-----

ZONE #1: HIGH EFFICIENCY SUBSURFACE DRIP IRRIGATION FOR MODERATE WATER USE PLANTING AREAS TOTAL AREA: 110sq.m. r-----MICROCLIMATE: SOUTH EAST/WEST EXPOSURE, PARTIALLY SHADED BY TREES 1-----ESTIMATED ANNUAL WATER USE: 28 cu.m. ZONE #2: HIGH EFFICIENCY SUBSURFACE DRIP IRRIGATION FOR MODERATE WATER USE PLANTING AREAS -----TOTAL AREA: 63sq.m.

MICROCLIMATE: SOUTHEAST/WEST EXPOSURE, PARTIALLY SHADED BY TREES 1-----ESTIMATED ANNUAL WATER USE: 22cu.m. ZONE #3: HIGH EFFICIENCY SUBSURFACE DRIP IRRIGATION FOR MODERATE WATER USE PLANTING AREAS TOTAL AREA: 161sq.m.
MICROCLIMATE: SOUTH EAST EXPOSURE, PARTIALLY SHADED BY BUILDING AND TREES

ESTIMATED ANNUAL WATER USE: 55 cu.m. ZONE #4: HIGH EFFICIENCY SUBSURFACE DRIP IRRIGATION FOR MODERATE WATER USE PLANTING AREAS |-----TOTAL AREA: 119sq.m. MICROCLIMATE: SOUTH WEST EXPOSURE, PARTIALLY SHADED BY BUILDING AND TREES

ESTIMATED ANNUAL WATER USE: 41cu.m. ZONE #5 LOW VOLUME POP-LIP SPRA YHEADS FOR TURF AREAS TOTAL AREA: 90sq.m. MICROCLIMATE: SOUTH WEST EXPOSURE, PARTIALLY SHADED BY BUILDING AND TREES ESTIMATED ANNUAL WATER USE: 70cu.m.



DRAWING NUMBER

PROJECT TITLE

Kelowna, BC

DRAWING TITLE

PLAN

2 23.08.23

3 23.10.11

4 23.10.17

PROJECT NO

**DESIGN BY** 

DRAWN BY

DATE

SCALE

SEAL

PAGE SIZE

CHECKED BY

ISSUED FOR / REVISION 22.08.22

1020 GRAHAM ROAD

WATER CONSERVATION

Review

Review

Review

22-0790

GS

GS

FB

1:150

24" x 36"

Aug. 23th, 2023

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## IRRIGATION NOTES

1. IRRIGATION PRODUCTS AND INSTALLATION METHODS SHALL MEET OR EXCEED THE REQUIREMENTS OF THE WATER USE REGULATION BYLAW NO. 10480 AND THE SUPPLEMENTARY SPECIFICATIONS IN THE CITY OF KELOWNA BYLAW 7900 (PART 6, SCHEDULE 5).

2. THE IRRIGATION SYSTEM SHALL MEET THE REQUIREMENTS, REGULATIONS, AND BYLAWS OF THE WATER PURVEYOR.

3. THE IRRIGATION SYSTEM SHALL BE EQUIPPED WITH AN APPROVED BACKFLOW PREVENTION DEVICE, WATER METER, AND SHUT OFF VALVE LOCATED OUTSIDE THE BUILDING ACCESSIBLE

4. AN APPROVED SMART CONTROLLER SHALL BE INSTALLED. THE IRRIGATION SCHEDULING TIMES SHALL UTILIZE A MAXIMUM ET VALUE OF 7" / MONTH (KELOWNA JULY ET), TAKING INTO CXXONSIDERATION SOIL TYPE, SLOPE, AND MICROCLIMATE.

5. DRIP LINE AND EMITTERS SHALL INCORPORATE TECHNOLOGY TO LIMIT ROOT INTRUSION.

6. IRRIGATION SLEEVES SHALL BE INSTALLED TO ROUTE IRRIGATION LINES UNDER HARD SURFACES AND FEATURES.

7. IRRIGATION PIPE SHALL BE SIZED TO ALLOW FOR A MAXIMUM FLOW OF 1.5m /SEC.

8. A FLOW SENSOR AND MASTER VALVE SHALL BE CONNECTED TO THE CONTROLLER AND PROGRAMMED TO STOP FLOW TO THE SYSTEM IN CASE OF AN IRRIGATION WATER LEAK.



#### 1020 Graham Road - Zoning Bylaw 12375 Landscape Summary

Landscaping Standards (7.2)	Zone (MF1)		Proposed	
Min. tree amount	4		4	
Min. deciduous tree caliper	L: 5cm		L: 5cm	
	M: 4cm		M: 4cm	
	S: 3cm		S: N/A	
Min. coniferous tree height	250cm		N/A	
Min. ratio between tree size	L: 50% minimum (min.)		L: 50%	
	M: no min. or max.		M: 25%	
	S: 25% maximum (max.)		S: 25%	
Min. growing medium area	75% soil based landscaping		75% soil based landscaping	
Min. growing medium volumes per tree	L: 30 cu.m or 25 cu.m if		L: 25 cu.m where connected	
	connected trench/cluster		trench/cluster	
	M: 20 cu.m or 18 cu.m if		M: 18 cu.m where connected	
	connected trench/cluster		trench/cluster	
	S: 15 cu.m or 12 cu.m if			
	connected trench/cluster			
Landscape graded area (7.2.7)	Max. 1:3 (33%) lawn areas,		Max. 1:3 (33%) lawn areas,	
	Max. 1:2 (50%) planting areas	S,	Max. 1:2 (50%) planting areas,	
	Min. 1:50 (2%) cross slopes		Min. 1:50 (2%) cross slopes	
Fence Height	2.0m		1.8m	
Riparian management area?	N	y/n	N	
Retention of existing trees on site?	N	y/n	N	
Surface parking lot (7.2.10)?	N	y/n	N	
Refuse & recycle bins screened?	N	y/n	N	
Other:				