

DEVELOPMENT PERMIT RATIONALE

Mixed Use Apartment Housing

2606 - 2696 Pandosy Street, Kelowna, BC



PROPOSAL

This application is presented to advance an 85dwelling mixed-use apartment and townhouse complex under the existing UC5 Urban Centre zone. The application is consistent with the intent of the Official Community Plan to foster a greater variety of housing and employment within the Pandosy Urban Center.

The completed mixed-use building will be offered as 642m² of Commercial space at street level, with 5 three-bedroom townhouses, 6 studios, 42 onebedroom, 6 two-bedroom and 26 three-bedroom



Figure 1: Site location outlined in red.

apartments. The proposal is tracking no variances to the zoning bylaw. A total of 105 parking spaces and 73 bike parking spaces are provided along with 2585m² of amenity space, 710m² of which is provided as common rooftop amenity space for all residents to enjoy.



ARCHITECTURAL FORM & CHARACTER



Figure 2: View from Pandosy.

The architecture is developed as segmented vertical masses with large balconies and roof top amenity terraces, fostering a sense of community among the residents. The commercial level forms a sturdy base, blending seamlessly with neighboring commercial structures, using brick cladding. The combination of imitation wood and black-and-white aluminum panels on the tower and townhomes adds visual interest. The penthouse suites stand out with their black aluminum panels and wooden soffits, exuding warmth and luxury. This separation, dividing the building into lower, middle, and upper sections, adds a sense of horizontal segmentation to the architecture.





Figure 3: Large balconies and Townhome Amenity Terrace.



The exterior design aligns with the OCP Design Guidelines in the following ways:

OCP Guideline 2.1.1. To site and design buildings to positively frame and activate streets and public open spaces.

The primary Building Façade is oriented to both fronting streets to create street definition. Distance between building and sidewalk have been minimized to create a sense of enclosure. Windows and street-level uses are located to create active frontages.

OCP Guideline 2.1.2. To ensure buildings contribute positively to the neighbourhood context and provide a sensitive transition in scale to existing and future buildings, parks, and open spaces.

The mass of the building is separated through visual breaks and the upper storey is stepped back to minimize shadowing on sidewalks.

OCP Guideline 2.1.4. To ensure the provision of adequate servicing, vehicle access, and parking while minimizing adverse impacts on the comfort, safety and attractiveness of the public realm.

Parking areas and garbage collection have been located at the rear of site and are accessed by the rear lane.

OCP Guideline 2.1.6. To enhance liveability, visual interest, identity, and sense of place through building form, architectural composition and materials.

The design incorporates a range of architectural features and details, such as variations in roof height, canopies and overhangs, to create visual interest.

OCP Guideline 4.1.1. To site and design buildings to positively frame and activate streets and public open spaces.

The developments main building entrance is clearly visible from the fronting street. The parking garage entrance is located away from the street frontage. The building has a continuous active and transparent retail frontage at grade to provide a visual connection between the public and private realm.

OCP Guideline 4.1.6. To enhance liveability, visual interest, identity, and sense of place through building form, architectural composition, and materials.

The building base is defined through brick and commercial uses, the middle of the building is defined through lighter tones, and the top is setback for Penthouse suites and rooftop patios. Awnings are also provided on the commercial street, and varying roof lines provide visual interest.

SITE & LOCATION


The site is located at the intersection of Pandosy Street and Osprey Avenue and features convenient pedestrian access from Pandosy to the commercial units. The parkade consists of one level partially below grade and a second level above. To maintain aesthetics, the at-grade parkade is shielded from pedestrian view by the



commercial units and residential lobby. Situated in a walkable and bikeable area, the location also offers proximity to transit services.





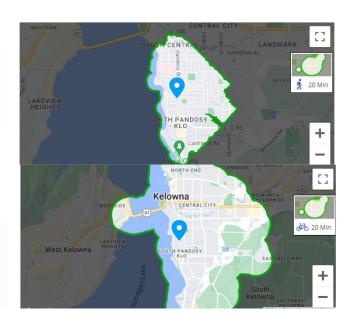

SUMMARY

This development is a key housing component to be added within the context of the Pandosy Urban Centre. It complies with the zoning bylaw in all aspects and follows the OCP guidelines for appropriate development. In summary, the proposal offers a mix of essential housing units alongside a commercial component that supports a vibrant and growing urban neighborhood. The applicant kindly requests support from staff and Council for this mixed-use project.







2606 - 2696 PANDOSY STREET

ISSUED FOR DP, 2024-07-05



ARCHITECTURAL

NEW TOWN ARCHITECTURE & ENGINEERING 200-1464 ST. PAUL STREET KELOWNA, BC V1Y 2E6 e: usman@newtownservices.net t: (250) 860-8185

CLIENT HYEUM PROPERTIES LTD. 2626 AIRPORT WAY

REVELSTOKE, BC V0E 2S3 e: pjs@hyeum.co.kr t: +82-44-864-2050

NEW TOWN ARCHITECTURE & ENGINEERING 200-1464 ST. PAUL STREET

KELOWNA, BC V1Y 2E6 e: jacob@newtownservices.net t: (250) 860-8185

LANDSCAPE ARQUIECOS GROUP LTD. 8-121 VILLAGE HEIGHTS SW CALGARY, AB T3H 2L2 e: carlos@arquiecos.com t: (403) 618-4427

RUNNALS DENBY BC LAND SURVEYORS 259A LAWRENCE AVENUE

KELOWNA, BC V1Y 6L2 e: jen@runnallsdenby.com t: (250) 763-7322

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NEW TOWN



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PANDOSY ST - UC5 MXR

2606 - 2696 Pandosy Street KELOWNA BC

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LEGAL ADDRESS:	ST STREET, KELO	OWNA, V1Y 1V6, BRITISH CO	LUMBIA, CANADA	
	OT 14 OSOYOOS E	DIVISION YALE DISTRICT PLA	N 33506	
GRADES: EXISTING: FLA			PROPOSI	ED: FLAT
NUMBER OF BUILD 1 BUILDING (85 UN	ITS)			
ZONING A				
EXISTING: UC5 - SOUTH PANE	OOSY URBAN CEN	ITRE	PROPOSED: UC5 - SOUTH PA CENTRE	NDOSY URBAN
FUTURE LAND US			UC5	
TRANSIT SUPPOR			N	
ADJACENT LAND U	UC5		USE PARKING	
NORTH SOUTH EAST WEST	UC5 UC5 UC5		PARKING COMMERCIAL SINGLE FAMILY/ RESIDENTIAL	COMMERCIAL
		UIREMENTS	RESIDENTIAL	
003 2011	REQUI		PROPOSI	ED:
SITE AREA (m²)	460.00	m²	3363.576r	n²
SITE WIDTH (m)	13.0m		30.5m	
SITE DEPTH (m)	30.0m		30.5m	
MAXIMUM SITE CO		DINGS (%)		
			76.2%	
		ERMEABLE SURFACES (%) %	100.00%	
VEHICULAR ACCE	SS FROM LANE O	R LOWER CLASSED ROAD	Υ	
DEVELOF	PMENT R	EQUIREMENT:	3	
	REQUI	RED:	PROPOSI	ED:
TOTAL NUMBER &	TYPES OF UNITS N/A		85 UNITS	
		8m² MAX (BASED ON 2.65 FA	R) 8480.05m SITE COV	² (2563.995 GFA FOF /ERAGE)
FLOOR AREA RATI BASE STREETSCAPE BO	2 3 5		2.52	
BUILDING HEIGHT	(m):			
OCP DESIGNATED MAX. ST-SCAPE BO	31.0m	(8 STOREYS) (11 STOREYS)		
MAX. ST-SCAPE BO	JNU3 43.0III		32.5m (10	STOREYS)
MAX. CONTINUOUS	S FRONTAGE: N/A		32.5m (10 109.1m	STOREYS)
MAX. CONTINUOUS	S FRONTAGE: N/A	FROM B/O CURB	109.1m	ROM B/O CURB
MAX. CONTINUOUS	S FRONTAGE: N/A	FROM B/O CURB	109.1m	
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SPECIFIC BUILT FORMS					
		REQUIRED:	PROPOSED:		
URBAN & VILLAGE CENTRE (1	4.11):				
UPPER FLOOR STEPBACK ABU CORNER LOT TRIANGULAR SE URBAN PLAZA		3.0m 4.5m N	3.0m 4.5m N		
STREET TYPE: MIN. COMMERCIAL GROUND F MAX./MIN. RESIDENTIAL	LOOR	90% N/A	100% N/A		
MAX. SITE COVERAGE BASED		(%) 100.00%	100.00%		
MAX. PARKADE EXPOSURE TO	SIREEI (%)	0.00%	0.00%		
AREA FOR FAR					
Level Area	Name				











		PARKADE	
OCCUPANCY	GROUP C	GROUP F3	GROUP E
ARTICLE	3.2.2.47	3.2.2.80	3.2.2.64
# OF STOREYS	UNLIMITED	UNLIMITED	UNLIMITED
# OF STREETS FACING	2	2	2
MAX BUILDING AREA	ANY AREA	ANY AREA	ANY AREA
CONSTRUCTION TYPE	NON-COMBUSTIBLE	NON-COMBUSTIBLE	NON-COMBUSTIB
CONSTRUCTION TYPE SPRINKLERED	NON-COMBUSTIBLE YES	NON-COMBUSTIBLE YES	NON-COMBUSTIB
SPRINKLERED			
SPRINKLERED ASSEMBLY RATINGS:	YES		
SPRINKLERED ASSEMBLY RATINGS: FLOORS	YES 2 HR 2 HR		

SPATIAL SEPARATION 3.2.3.1.					
		NORTH	EAST	SOUTH	WEST
WALL AREA	NOTE: WINDOW	244.0m²	2315.0m²	662.0m²	35.0m²
OPENING AREA	OPENINGS AND WALL	32.0m²	1513.0m²	443.0m²	28.0m²
% PERMITTED	UN-RESTRICTED,	22.0%	100.00%	100.00%	84.5%
LIMITING DISTANCE	WHERE THE LIMITING DISTANCE EXCEEDS	3.0m	>9.0m	>9.0m	4.5m
% PROVIDED	9.0m, OR THE BUILDING IS FACING A STREET IN ACCORDANCE WITH ARTICLE 3.2.3.10.	13.0%	65.4%	66.9%	80.0%
CONST. TYPE		COMB/NON	COMB/NON	COMB/NON	COMB/NON
CLADDING MATERIAL		NON	COMB/NON	COMB/NON	COMB/NON
REQUIRED RATING		1 HR	45 MIN	45 MIN	45 MIN

ROOFS

REQUIRED FIF	3.1.3.1.				
MAJOR OCCUPANCIES					
GROUP C TO C	1 HR	3.3.1.1.			
GROUP F3 TO C	1 HR	3.2.1.2.			
SERVICE ROOMS	1 HR	3.6.2.			
ELECTRICAL ROOM	1 HR	3.6.2.1. (1)			
JANITORS ROOMS	N/A	3.6.2.			

BUILDING FIRE SAFETY				
SOFFIT PROTECTION	N/A	3.2.3.16.		
FLAME SPREAD RATINGS	COMPLY WITH	3.1.13.2.		
METAL DECK ASSEMBLIES	N/A	3.1.14.2.		
ROOF COVERING CLASSIFICATION	CLASS A	3.1.15.2.		
ATTIC FIRESTOPS	YES	3.1.11.		
MAX ATTIC AREA	300 m ²	3.1.11.5.		
MAX. CRWL SPACE AREA	N/A	3.1.11.6.		
CONCEALED FLOOR AREA	N/A	3.1.11.5.		

EXIT FACILITIES		3.1. TO 3.6
PARKADE LEVEL	2 MIN. PER FLOOR	
	REQUIRED WIDTHS	PROVIDED WIDTHS
	MIN. 800mm DOOR WIDTH (TABLE 3.4.3.2.A)	
	MIN. 1100mm STAIR WIDTH (TABLE 3.4.3.2.A)	
PARKADE LEVEL	6.1mm/ PERSON x 63 PERSONS = 384.3mm	2 DOORS @ 3'-0" = 6'-0" (1828mm)
RESIDENTIAL LEVELS		
LEVEL 1 - 10 (DOORS)	MIN. DOOR WIDTH/FLOOR = 305mm	2 DOORS @ 3'-0" EACH
	6.1mm/ PERSON x 50 PERSONS MAX	WIDTH/FLOOR = 1828mm
LEVEL 1 - 10 (STAIRS)	8.0mm/ PERSON x 50 PERSONS MAX	2 STAIRS @ 4'-0" EACH
	MIN. STAIR WIDTH/FLOOR = 400mm	WIDTH/FLOOR = 2400mm
RESIDENTIAL UNITS	MIN. 1 DOOR @ 800mm/UNIT	36" DOOR @ EACH UNIT
EXIT THROUGH LOBBY	YES	3.4.4.2.
PANIC HARDWARE REQ'D	YES	3.4.6.16.(2)
EXIT EXPOSURE	NO	3.2.3.13.
MAX TRAVEL DISTANCE	45m	3.4.2.5.(1)
EXIT RATINGS REQUIRED		
STAIR SHAFTS	2 HR	3.4.4.1.
CORRIDORS	2 HR	3.3.2.6.(4)

ALL CONTRACTORS ARE REQUIRED TO PERFORM THEIR WORK AND SUPPLY THEIR PRODUCTS IN COMPLIANCE WITH ALL BUILDING CODES AND LAWS OF THE PROVINCE OF BRITISH COLUMBIA

> sperty of view flown curvicus. The case of awing shall be restricted to the original si was prepared and publication thereof is e litted to such use.

Verify all dimensions and datums prior to ommencement of work.



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PANDOSY ST - UC5 MXR

project address 2606 - 2696 Pandosy Street KELOWNA BC


project no. 4242


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ZONING & BYLAW







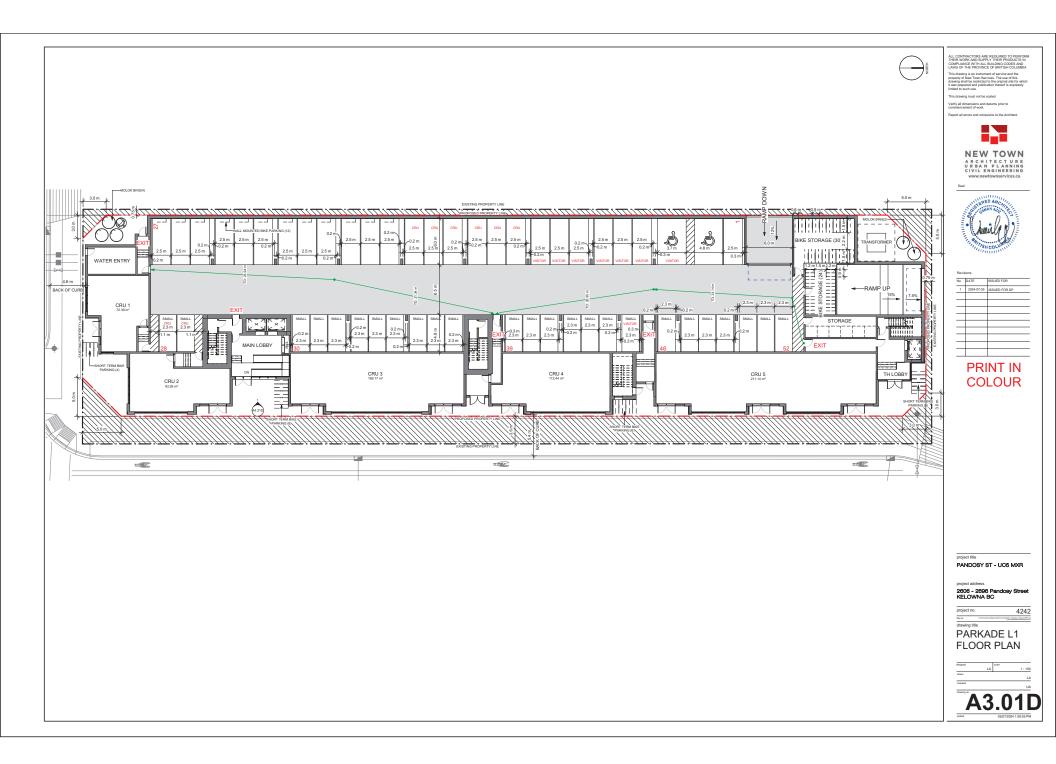

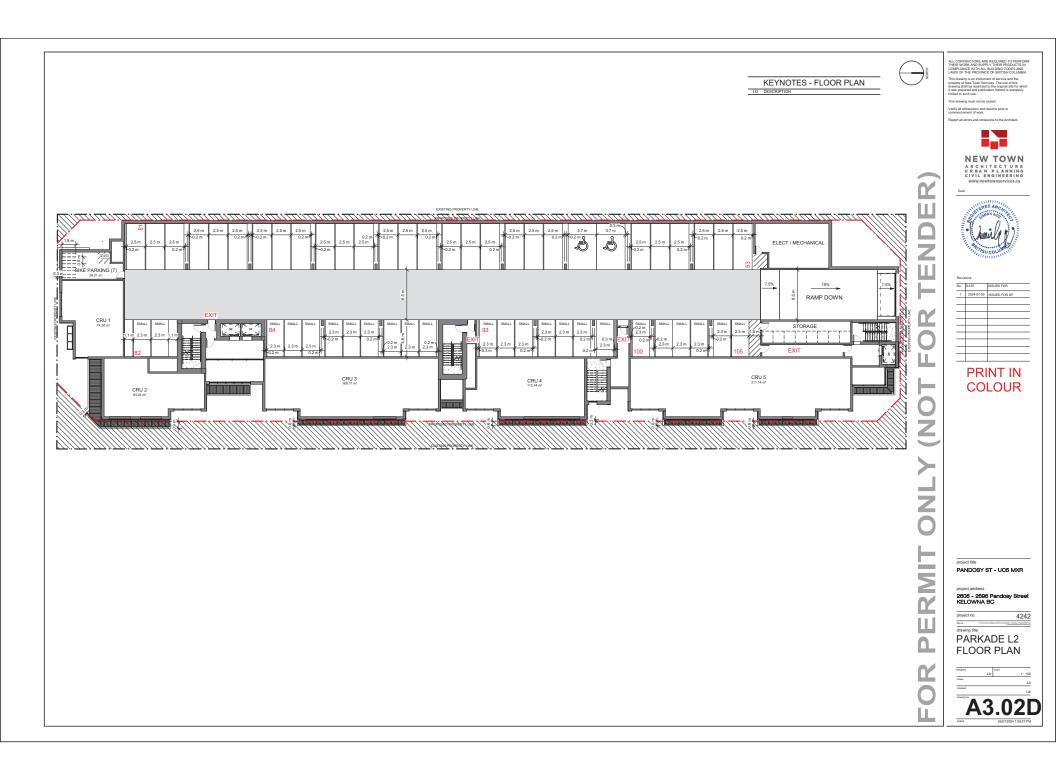KEYNOTES - FLOOR PLAN



ALL CONTRACTORS ARE REQUIRED TO PERFORM.
THEIR WORK AND SUPPLY THEIR PRODUCTS IN
COMPLIANCE WITH ALL BUILDING CODES AND
LAWS OF THE PROVINCE OF BRITISH OCLUMBIA.
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recently of New Trans Revision. The use of this

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Verify all dimensions and datums prior to commencement of work.

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www.newtownservices.ca

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Revisions

No. DATE | SSUED FOR |
1 2004-07-05 | SSUED FOR DP |

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project title
PANDOSY

project address

2606 - 2696 Pandosy Street KELOWNA BC project no. 4242

drawing title


LEVEL 3 FLOOR PLAN


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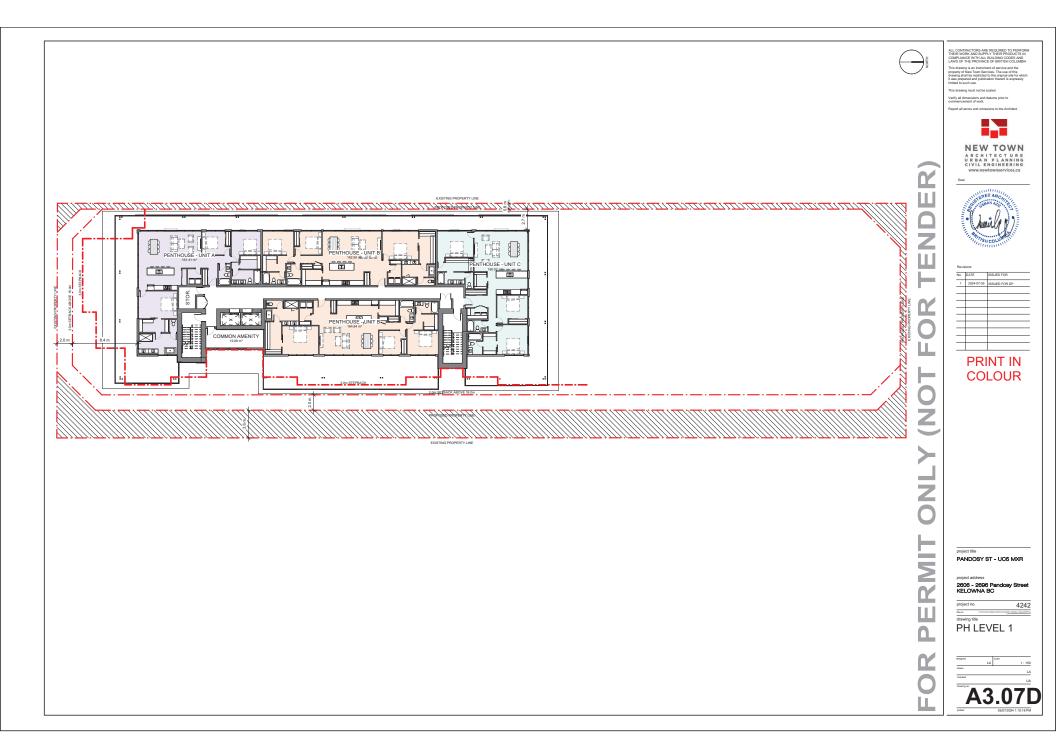



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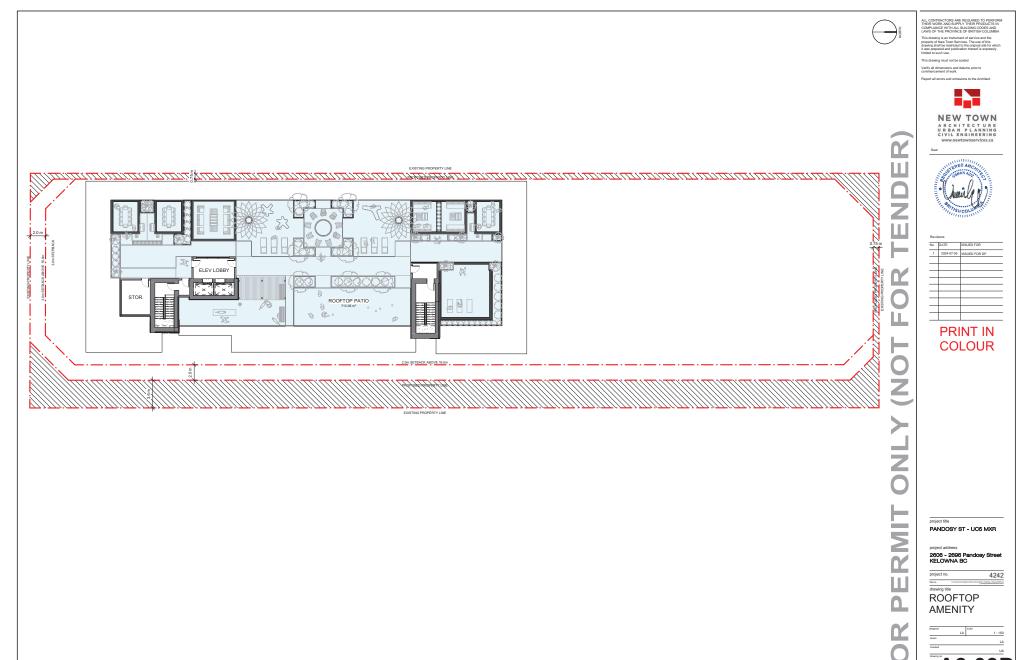
2606 - 2696 Pandosy Street KELOWNA BC

4242

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A3.09

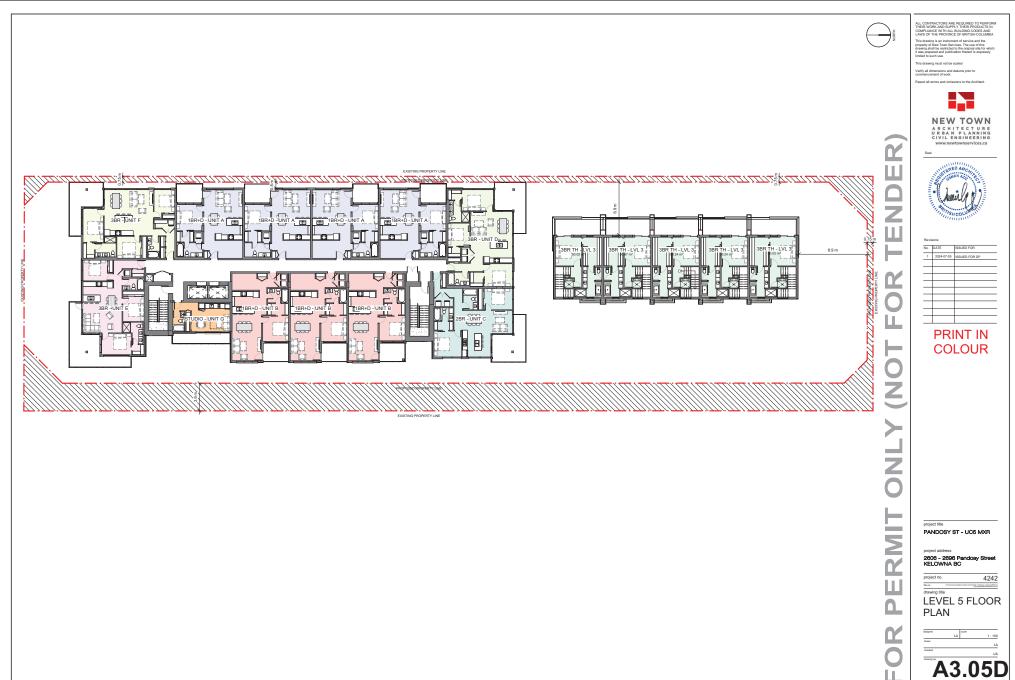COLOUR & CODE: FAWN I.D NUMBER: 01 COLOUR & CODE: CHARCOAL BLACK I.D NUMBER: 02

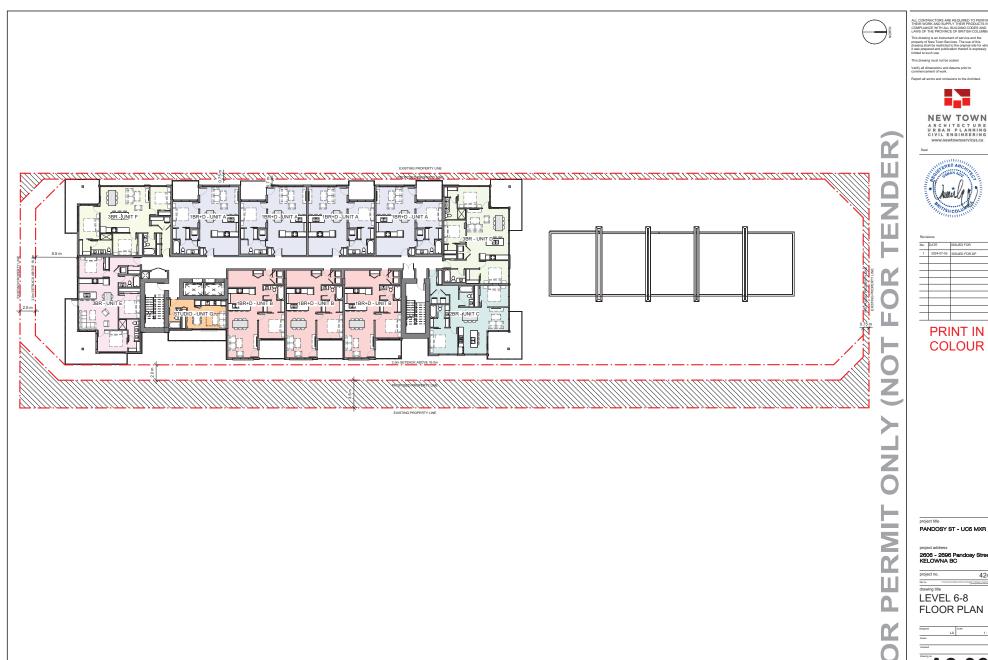SAMPLE FOR COLOL

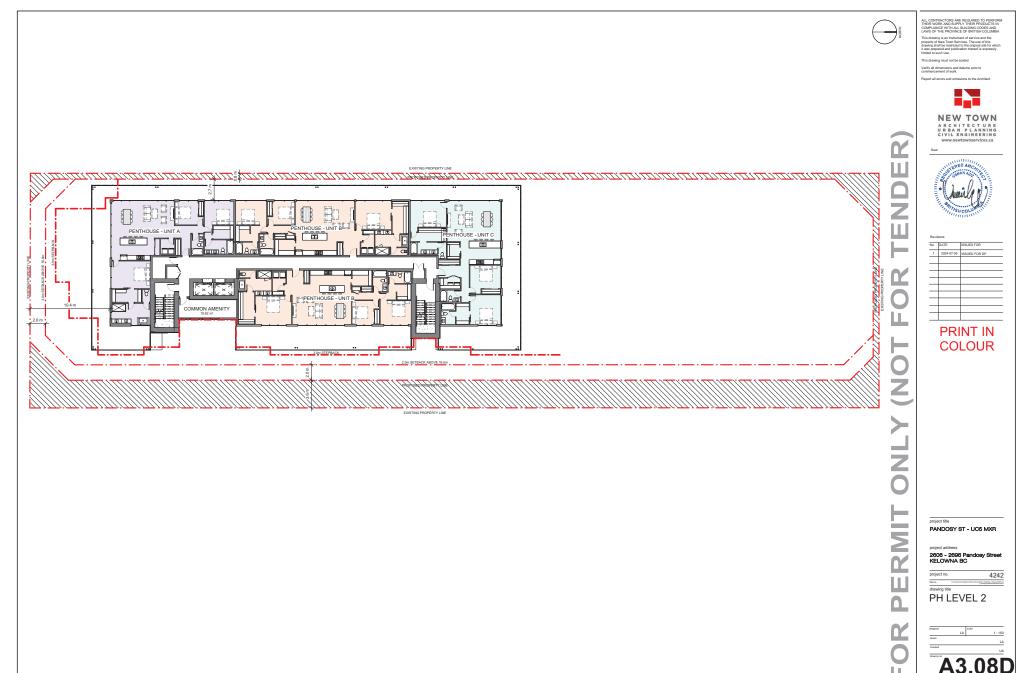MANUFACTURER: LUX ARCHITECTURAL PRODUCTS

PRODUCT: V-GROOVE SIDING

MANUFACTURER: TBD PRODUCT: ALUMINIUM RAILING W/ GLASS PANEL INFILL COLOUR & CODE: BLACK I.D NUMBER: 05



MANUFACTURER: TBD PRODUCT: ALUMINIUM SLIDING PATIO DOOR IN BLACK FRAME COLOUR & CODE: BLACK I.D NUMBER: 09



MANUFACTURER: TBD PRODUCT: ALUMINIUM WINDOW IN BLACK FRAME

COLOUR & CODE: BLACK I.D NUMBER: 10

PRODUCT: ALUMINUM PRE-FORMED PANELS

MANUFACTURER: EQUITONE

PRODUCT: LINEA COLOUR & CODE: BLACK I.D NUMBER: 06





SAMPLE FOR COLOR PURPOSES ON

SAMPLE FOR COLOU.
PURPOSES ONL



MANUFACTURER: TBD PRODUCT: BIKE RACK - LOOPS COLOUR & CODE: BLACK I.D NUMBER: 11

MANUFACTURER: TBD PRODUCT: BRICK COLOUR & CODE: GREY I.D NUMBER: 07





MANUFACTURER: TBD PRODUCT: ALUMINUM PRE-FORMED PANELS COLOUR & CODE: WHITE I.D NUMBER: 03



SAMPLE FOR COLOUR

SAMPLE FOR COLOUR PURPOSES ONLY



MANUFACTURER: TBD PRODUCT:STOREFRONT GLAZING COLOUR & CODE: BLACK FRAME I.D NUMBER: 08



MANUFACTURER: MOLOK PRODUCT: GARBAGE RECEPTACLES COLOUR & CODE: TBD I.D NUMBER: 12



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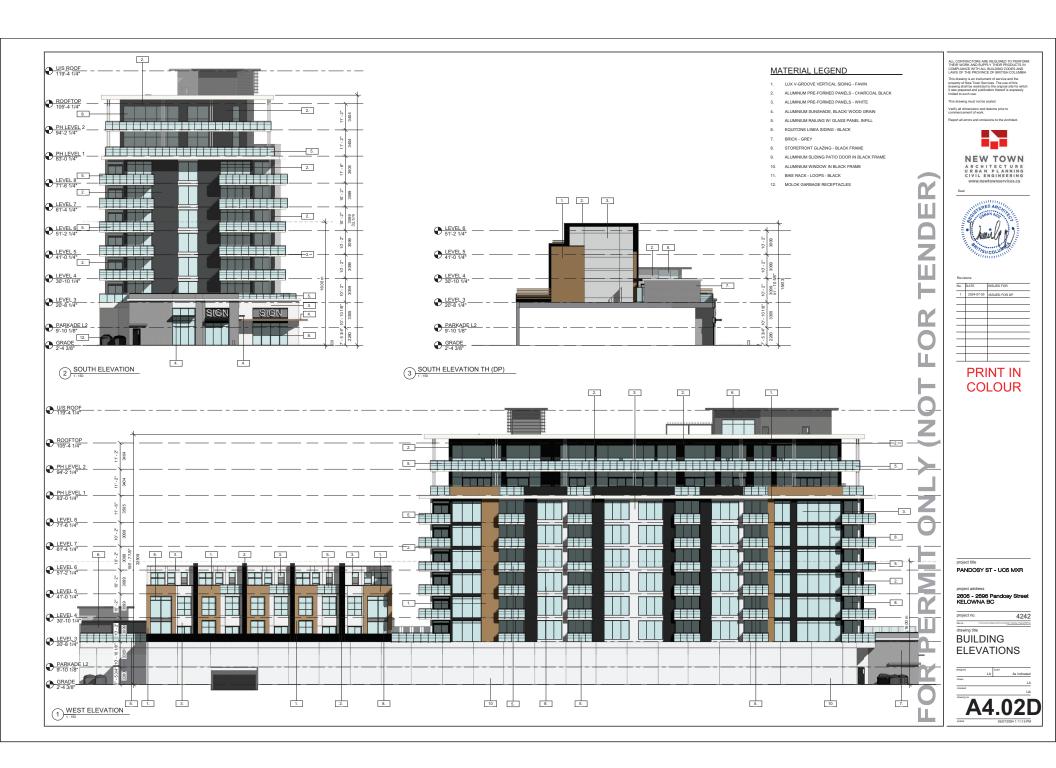
PANDOSY ST - UC5 MXR

2606 - 2696 Pandosy Street

4242

MATERIALS










1 SUMMER @ 8AM

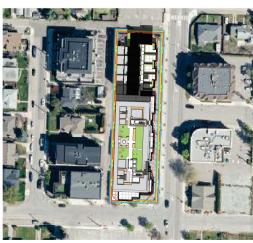

SUMMER @ NOON



3 SUMMER @4PM







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2606 - 2696 Pandosy Street KELOWNA BC

SHADOW **ANALYSIS**



RENDERING NUMBER 1 - VIEW FROM CORNER OF PANDOSY AND WARDLAW



RENDERING NUMBER 2 - VIEW FROM PANDOSY STREET



RENDERING NUMBER 3- REAR VIEW FROM OSPREY ST



RENDERING NUMBER 4 - INTERSECTION OF OSPREY & PANDOSY

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PANDOSY ST - UC5 MXR

2606 - 2696 Pandosy Street KELOWNA BC 4242

RENDERINGS




RENDERING NUMBER 5 - BIRDSEYE VIEW



RENDERING NUMBER6 - MAIN TOWER ENTRANCE STREET VIEW



RENDERING NUMBER 7 - ROOFTOP AMENITY VIEW

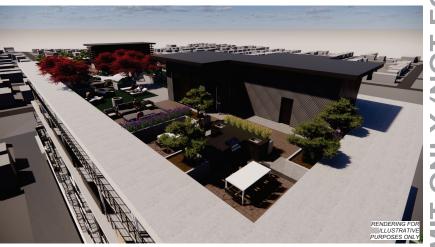

RENDERING NUMBER 8 - ROOFTOP AMENITY VIEW

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project address

2606 - 2696 Pandosy Street KELOWNA BC

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RENDERINGS

designed LA 1:10
drawn LA
checked UA

A9.02D



RENDERING NUMBER 9 - VIEW FROMPANDOSY ST - MAIN TOWNHOME ENTRANCE



RENDERING NUMBER 10 - STREETSCAPE VIEW - PANDOSY STREET



RENDERING NUMBER 11- TOP TOWNHOME VIEW - FRONT



RENDERING NUMBER 12 -TOP TOWNHOME VIEW - REAR

	ALL CONTRACTORS ARE REQUIRED TO PERFORM THEIR WORK AND SUPPLY THEIR PRODUCTS IN COMPLIANCE WITH ALL BUILDING CODES AND LAWS OF THE PROVINCE OF BRITISH COLUMBIA
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project title
PANDOSY ST - UC5 MXR

2606 - 2696 Pandosy Street KELOWNA BC

roject no. 4242

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RENDERINGS

A9.03



Site Information

Address: 2606 - 2696 Pandosy Street Kelowna, B.C.

Pandosy Urban Centre

Landscape Statistics

City of Calgary Zoning:

Site Area length of Frontage Pandosy Street +Ospreay Ave **2,946.12** sq m 130.42 lm

1 tree per 10 lm frontage

Shrubs


required provided 13.0 provided 654 221.00

grasses and goundcovers

autumn blaze maple min 75mm cal




emperor japanese maple min 50mm cal

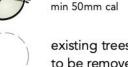

existing trees to be removed

ivory silk lilac

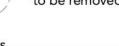


globe blue spruce (tree form)



min 600mm ht or spread abbotswood potentilla

min 600mm ht or spread

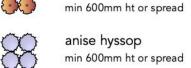

autumn red daylily min 600mm ht or spread

caradonna sage



candy corn spirea min 600mm ht or spread black eyed susan



oso paprika rose min 600mm ht or spread



purple emperor cornflower min 600mm ht or spread



tiny wine ninebark min 600mm ht or spread



karl foerster grass min #2 container

433.00



variegated moor grass min #2 container

landscape mulch



Plant List

Qty Common Name **Ornamental Grasses and Groundcovers**

24 Avalanche Reed Grass 36 Bronze Veil Tufted Hair Grass

119 Foerster's Feather Reed Grass 158 Northern Lights Tufted Hair Grass

48 Prairie Fire Red Switch Grass

48 Variegated Moor Grass

Shrubs

Coniferous

10 Globe Blue Spruce (tree form) 16 Little spire Russian Sage

Deciduous

Trees

13 Abbotswood Potentilla 14 Anise Hyssop

Coniferous

Deciduous

32 Autumn Red Daylily 16 Caradonna Sage

15 Double play candy corn spirea 35 Indian Summer Black Eyed Susan

17 Oso Easy Paprika Rose 55 Purple Emperor Coneflower

18 Red Garden Astilbe Tiny Wine Ninebark

Picea pungens 'Globosa (tree form)' Perovskia atriplicifolia ' little spire' Potentilla fruticosa 'Abbotswood'

Panicum virgatum 'Prairie Fire'

Molinia caerulea 'Variegata'

Calamagrostis x acutiflora 'Avalanche'

Deschampsia caespitosa 'Bronzeschleier'

Calamagrostis x acutiflora 'Karl Foerster'

Deschampsia cespitosa 'Northern Lights'

Agastache 'Blue Fortune' Hemerocallis 'Autumn Red' Salvia x sylvestris 'Caradonna' Spiraea japonica 'candy corn' Rudbeckia hirta 'Indian Summer'

Rosa sp ' Oso Paprika'

Echinacea purpurea 'Purple Emperor' Astilbe x arendsii 'Fanal'

Physocarpus opulifolius

Botanical Name

11 Autumn Blaze Maple Acer x freemanii 'Jeffsred' Acer palmatum 'Wolff' Emperor Japanese Maple Ivory Silk Japanese Tree Lilac Syringa reticulata 'Ivory Silk' arquiecos





Arquiecos Group Ltd.

8-121 Village Heights SW

e. info@arquiecos.com

Calgary, Alberta T3H 2L2 p. 403.618.44.27

General Notes


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- Standards. Irrigation Notes
 - 1. trees, shrubs, grasses, and perennials will require irrigation system to be tendered as design build to be reviewed by landscape architect prior to award. permanent high efficiency sprinkler (for open lawn areas) and dripline irrigation (for established planting bed areas) are envisioned to ensure the highest water conservation measures are achieved
 - 2. watering provisions in accordance with City of Kelowna water system rates and regulations.

Firesmart Notes

- 1. The proposed landscape plan adheres to the current edition of the firesmart guide to landscaping BC.
- 2. The proposed landscape plan uses primarily native species and cultivar species that are well adapted to the kelowna climate with low to moderate water requirements.
- 3. From building edge to 1.5m establishes a non-combustible zone per firesmart guidelines. 4. Zone 1 - up to 10m from building edge, no coniferous trees or
- shrubs have been proposed.

 5. Existing conifers to remain are to be pruned to a height of 2.0m.
- 6. Ensure a minimum of 3m between crowns of existing coniferous trees. the tips of the branches of a mature coniferous tree are no closer than 3m to the tips of the branches of another coniferous

7. Proposed landscape mulch will be non-combustible.

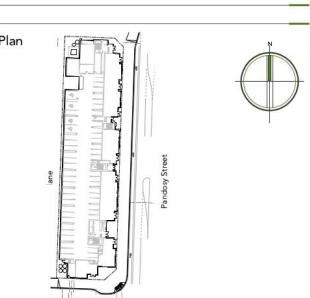

24.07.03 development permit review and coordination 24.06.21 24.06.19 review and coordination 24.06.07 2 review and coordination 24.04.29 revew and coordination Issued for: Date. (yy.mm.dd)

Project No. 43-001

Pandosy x Osprey Mixed Use

Kelowna, B.C.

Drawing Title:


Overall Landscape Plan

Drawn by: Drawing No. Checked by: cmp

Scale: 1:300





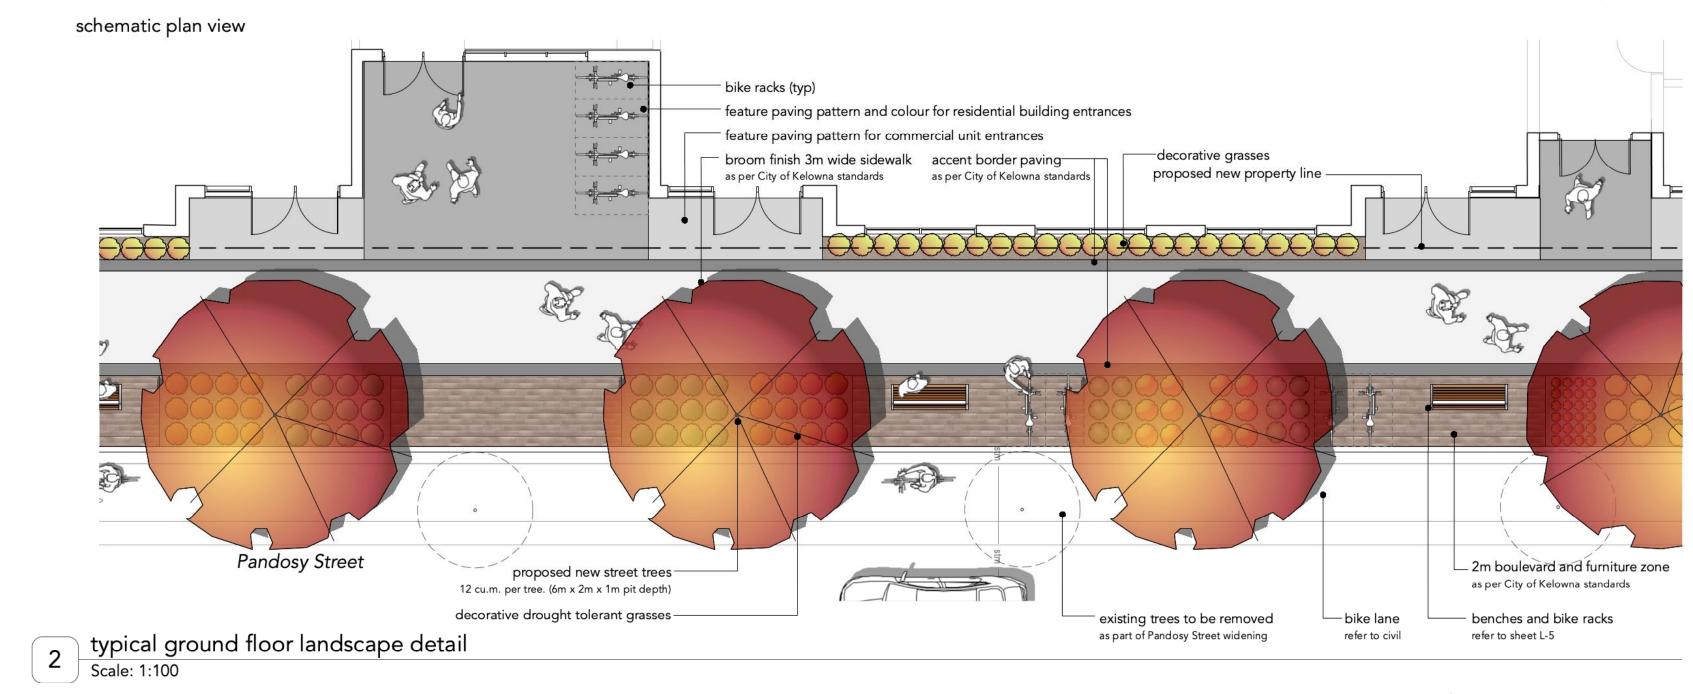



legend

autumn blaze maple

emperor japanese maple

globe blue spruce (tree form)

min 600mm ht or spread

little spire russian sage

abbotswood potentilla

min 600mm ht or spread

min 600mm ht or spread

min 600mm ht or spread

autumn red daylily min 600mm ht or spread

caradonna sage min 600mm ht or spread

candy corn spirea min 600mm ht or spread

black eyed susan

oso paprika rose min 600mm ht or spread

min 600mm ht or spread

min 600mm ht or spread

red garden astilbe

min 600mm ht or spread

tiny wine ninebark

min 600mm ht or spread

purple emperor cornflower

anise hyssop

min 75mm cal

min 50mm cal

ivory silk lilac

min 50mm cal

existing trees

to be removed



schematic perspectives


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- conservation measures are achieved

 2. watering provisions in accordance with City of Kelowna water system rates and regulations.

Firesmart Notes

grasses and goundcovers

avalanche reed grass min #2 container

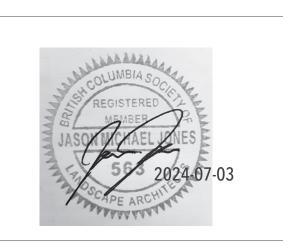karl foerster grass min #2 container

bronze tuffted hair grass min #2 container

northern lights hair grass min #2 container

prairie fire switch grass min #2 container

variegated moor grass
min #2 container

landscape mulch

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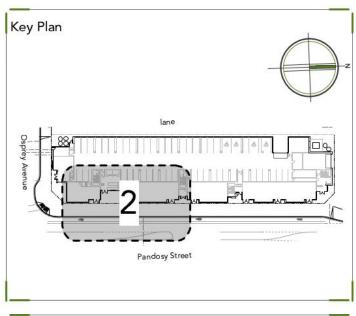
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development permit	24.07.0
review and coordination	24.06.2
review and coordination	24.06.1
review and coordination	24.06.1
review and coordination	24.06.0
Issued for:	Date. (yy.mm.d
	review and coordination review and coordination review and coordination review and coordination

Project No.

43-001 Project Title.

Pandosy x Osprey
Mixed Use

Kelowna, B.C.

Drawing Title:

Landscape Plan

Drawn by:

cmp

Checked by:
cmp

Scale: 1.175

rooftop landscape plan 1 Scale: 1:100









schematic perspectives

autumn blaze maple

min #2 container

emperor japanese maple min 50mm cal

ivory silk lilac min 50mm cal

min 75mm cal

existing trees to be removed

globe blue spruce (tree form)

min 600mm ht or spread little spire russian sage min 600mm ht or spread

abbotswood potentilla min 600mm ht or spread

min 600mm ht or spread

anise hyssop min 600mm ht or spread autumn red daylily

caradonna sage min 600mm ht or spread

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karl foerster grass min #2 container

northern lights hair grass

min #2 container prairie fire switch grass min #2 container

variegated moor grass min #2 container

landscape mulch

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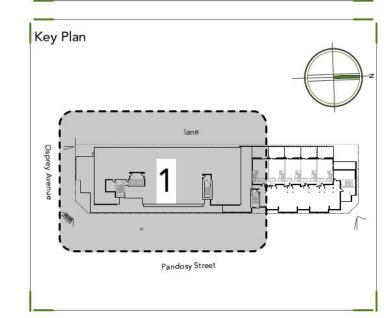
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24.07.03 development permit 24.06.21 review and coordination 24.06.19 review and coordination 24.06.07 review and coordination 24.04.29

Date. (yy.mm.dd)

Project Title.

Pandosy x Osprey Mixed Use

Kelowna, B.C.

Drawing Title:


Rooftop landscape plan

Drawn by:

revew and coordination Issued for: Project No. 43-001



upper level townhomes amenity spaces
Scale: 1:100

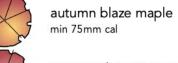

emperor japanese maple min 50mm cal



ivory silk lilac min 50mm cal



existing trees to be removed



globe blue spruce (tree form) min 600mm ht or spread

little spire russian sage



anise hyssop min 600mm ht or spread






black eyed susan min 600mm ht or spread



purple emperor cornflower

min 600mm ht or spread red garden astilbe

min 600mm ht or spread

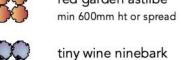



grasses and goundcovers avalanche reed grass min #2 container















Arquiecos Group Ltd. Design and Development Consultants

8-121 Village Heights SW Calgary, Alberta T3H 2L2 p. 403.618.44.27

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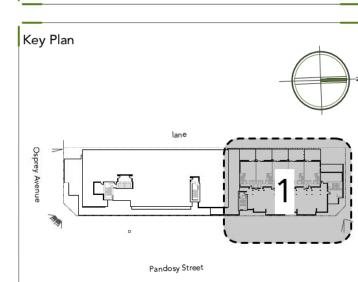
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revew and coordination Issued for:

Date. (yy.mm.dd)

Project Title.

Pandosy x Osprey Mixed Use


Kelowna, B.C.

Drawing Title:

Rooftop landscape plan

cmp Checked by:

cmp

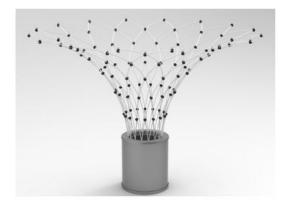

Proposed canopy element Maglin Corole Canopee standard base and LED lights on canopee Surface mount



Proposed bench Maglin Iconic bench Titanium powdercoat colour Surface mount



Proposed bike rack Maglin Iconic bike rack Orange powdercoat colour Surface mount

Estimated Total Cost

\$ 637,825



Proposed sculptural benches Landscape forms Twig Air and Starfish Air white with LED lighting Surface mount



Proposed shade elelments Shade Sails Canada custom shade structures for dining areas and yoga deck Surface mount

Proposed site furnishings

ltem	Qty	Unit		Unit Cost Comments	Tota
oftscape and Plant Material					
1.1 Deciduous Trees		21	each	\$900 Supply and Install, Includes Topsoil, bark mulch and 2 year warranty.	\$ 18,900
1.3 Deciduous Shrubs		221	each	\$65 Supply and Install, Includes Topsoil, bark mulch and 2 year warranty.	\$ 14,36
1.4 Coniferous Shrubs		26	each	\$65 Supply and Install, Includes Topsoil, bark mulch and 2 year warranty.	\$ 1,690
1.5 Ornamental Grasses		433	each	\$35 Supply and Install, Includes Topsoil, bark mulch and 2 year warranty.	\$ 15,15
1.6 Sod		51	sq. m.	\$20 Including 15mm of topsoil and grading	\$ 1,014
1.8 wood bark mulch		257	sq.m.	\$40 Non flamable landscape mulch. Nature's Gold Black mulch or aproves similar	\$ 10,291
1.1 Irrigation		1	allow	\$50,000 Irrigation System with high efficiency MP spray heads, and bubblers for trees. Design Build by contractor to be reviewed and approved by Landscape Architect.	\$ 50,000
				Subtotal	\$ 111,415
lardscape					
2.1 Artificial Grass		211	sq.m.	\$150 Synlawn Artificial pet turf. as per manufacturers specifications	\$ 31,689
2.1 Concrete paving		241	sq.m.	\$200 Broom finish concrete paving as per City of Kelowna Standards	\$ 48,244
2.2 Accent paving and precast pa	avers	991	sq.m.	\$275 Concrete paving with integral colour or precast concrete pavers as per plans	\$ 272,477
				Subtotal	\$ 352,410
ite Furnishings					
3.1 Bike racks		20	each	\$750 Bike racks as per drawings	\$ 15,000
3.2 Benches		7	each	\$1,500 Benches as per drawings	\$ 10,500
3.3 Rooftop sculptural benches		3	each	\$5,000 Landscape forms Twig Air and Starfish Air in white with LED lighting	\$ 15,000
3.4 Rooftop Firepit and chairs		1	each	\$7,000 Firepit with decorative gravel and 9 individual chairs TBD	\$ 7,000
3.5 Rooftop Sofas and loungers		19	each	\$1,500 Sofas and tables for lounging areas and loungers for open space TBD	\$ 28,500
3.6 Canopy Structures		2	each	\$5,000 Maglin Canopee Small with LED lights	\$ 10,000
3.7 Sail Shade elements		3	each	\$6,000 Sail shade emelments over dining areas	\$ 18,000
3.8 Raised planters		40	each	\$1,000 Freestanding raised planters by urbanpot. 1.2m high for trees and 0.6m high for shrubs	\$ 40,000
3.9 Outdoor kitchens		3	each	\$10,000 Outdoor kitchens with BBQ, sink and conutertop	\$ 30,000
				Subtotal	\$ 174,000

- 1. This is a preliminary opinion of probable costs based on development permit design plans, not a guaranteed cost figure.
- 2. Contractors are responsible for accurate quantity calculations and field measurements.
- 3. Cost estimate does not include; haulage, maintenance, unforeseen site conditions, and other costs associated with construction phasing and staging.
- 4. All costs include supply and installation unless otherwise noted.
- 5. All costs are exclusive of taxes



Arquiecos Group Ltd. Design and Development Consultants Calgary, Alberta T3H 2L2 p. 403.618.44.27 e. info@arquiecos.com





General Notes

Representative.

- 1. This drawing, including all concepts and design ideas are property of Arquiecos Group Ltd. This drawings can only be reproduced with writen authorization of Arquiecos Group, the Project Owner or the Owner's
- 2. These drawings must not be used for construction purposes unless specifically issued as such. 3. This drawings have been drawn to scale as indicated in the
- titleblock and viewports. Do not scale drawings. Written dimensions rule over scaled dimensions. 4. Any variatons and design changes to the information shown on

these drawings must not be carried out without written

- authorization from Arquiecos Grup Ltd. the Project Owner or the Owner's Representative 5. Any references made to the location of all existing and proposed utilities, including URW must be verified on site prior to
- comencing work. Report any and all conficts identified immediately. 6. Contractor must adhere to municipal, provincial and federal regulations, guidelines and by-laws including but not limited to
- the most recent versions of the Canadian Standards for Nursery Stock as well as municipal Landscape and Roads Construction Standards.


Irrigation Notes

- 1. trees, shrubs, grasses, and perennials will require irrigation system to be tendered as design build to be reviewed by landscape architect prior to award. permanent high efficiency sprinkler (for open lawn areas) and dripline irrigation (for established planting bed areas) are envisioned to ensure the highest water conservation measures are achieved
- 2. watering provisions in accordance with City of Kelowna water system rates and regulations.

Firesmart Notes 1. The proposed landscape plan adheres to the current edition of the

- firesmart guide to landscaping BC. 2. The proposed landscape plan uses primarily native species and cultivar species that are well adapted to the kelowna climate with
- low to moderate water requirements. 3. From building edge to 1.5m establishes a non-combustible zone
- per firesmart guidelines.
 4. Zone 1 up to 10m from building edge, no coniferous trees or
- shrubs have been proposed. 5. Existing conifers to remain are to be pruned to a height of 2.0m.
- 6. Ensure a minimum of 3m between crowns of existing coniferous trees. the tips of the branches of a mature coniferous tree are no closer than 3m to the tips of the branches of another coniferous

7. Proposed landscape mulch will be non-combustible.

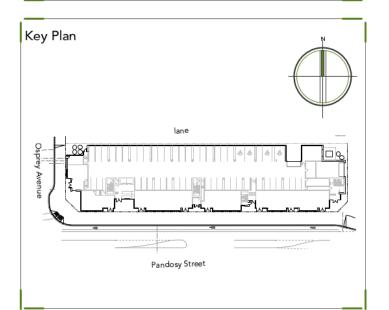

6	development permit	24.07.03
5	review and coordination	24.06.21
4	review and coordination	24.06.19
2	review and coordination	24.06.07
1	revew and coordination	24.04.29
	Issued for:	Date. (yy.mm.dd)

Pandosy x Osprey Mixed Use

Kelowna, B.C.

Drawing Title:

Furnishings / Cost estimate

Drawn by:	Drawing No.
cmp	ı or
Checked by:	1-05
cmp	
Scalo:	

as noted



1435 Water Street Kelowna, BC V1Y 1J4 250 469-8500 kelowna.ca

Landscape Water Conservation Report

APPLICANT INFORMATION

Owner		Contractor co. name Arquiecos Group Ltd.				
Project address		Contractor contact name Carlos Mier y Ponce Arzani				
City	/ Kelowna	Contractor phone # 403-618-4427				
Owner phone #		Contractor email <u>carlos@arquiecos.com</u>				
Owner email	pjs@hyeum.co.kr					
Province	BC Postal Code: V1Y 1V6	Preferred contact Owner $ igcirc$ Contractor $ igtizen$				
NOTE: ALL	3 PAGES OF THE APPLICATION M	MUST BE COMPLETED AND SUBMITTED				
LANDSCAPE	E AND IRRIGATION CHECKLIST					
The Applicant in	n submitting this application, has adhered to: Applicable elctrical standards and codes	:				
	• •					
	Applicable plumbing standards and codes					
	Applicable backflow prevention standards ar	nd codes				
The Applicant ir	n submitting this application, has adhered to	the irrigation and landscape requirements required for the classification				
of project as fol	llows:					
	Residential property: Bylaw 7900 Schedule 4	4, Bylaw 10480 Part 4				
	Non-residential property: Bylaw 7900 Schedu	Jule 4 and Schedule 5, Bylaw 10480 Part 4				
Note that checklis	sts for selecting an irrigation contractor are availa	able through the IIABC or the IA. Below is the link to the IIABC checklist.				
https://www.irrig	gationbc.com/page/selecting-a-contractor					
Where an exem _l	option is required (e.g. golf course or large sc	chool field), contact the Water Smart program directly.				
·	s pertaining to the application:	*				
Liberras	percanning to the opposite					



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Landscape Water **Conservation Report**

LANDSCAPE WATER USE AREA

Applicant: New Town Architecture & Engineering / Arquiecos Address: 2606 - 2696 Pandosy Street

Step 1: Measure Total Landscape Area (LA)

Area of site that will absorb water:

306.49

Note: Include boulevard, and proposed lawn, plants, mulch, pervious decks or paving stones. Do not include areas that are not pervious such as buildings, paved driveways,

Step 2: Divide Into Landscap	e Treatments*	Plant Factor	Irrig Efficiency	Hydrozone Area (Sq.m.)	% of Total LA	Estimated Wate Use (cu.m.)
Note: each of the areas below are a 'HYI	DROZONE'	(PF)	(IE)	(HA)		(WU)
Unwatered Pervious Areas (not impervious paving)					
Mulch (Stone, bark or sand)		N/A	N/A		0%	N/A
Pervious deck (Spaced wood deck)		N/A	N/A		0%	N/A
Pervious paving (ie: AquaPave, Rima	a Pave)	N/A	N/A		0%	N/A
Naturalized meadow (wildflowers)		N/A	N/A		0%	N/A
Naturalized area (Existing natural a	rea)	N/A	N/A		0%	N/A
Other: Artificial sod		N/A	N/A		0%	N/A
Swimming or ornamental pool		1	1	0	0%	0
Watered Planting Beds (shru	ubs or groundcover)					
Planting Type	Irrig Efficiency					
Low water use plants	High (Drip or Bubbler)	0.3	0.9		0%	0
Low water use plants	Moderate (Spray orRotor)	0.3	0.7		0%	0
Moderate water use plants	High (Drip or Bubbler)	0.5	0.9	130	42%	58
Moderate water use plants	Moderate (Spray orRotor)	0.5	0.7		0%	0
High water use plants	High (Drip or Bubbler)	0.7	0.9	125.77	41%	78
High water use plants	Moderate (Spray orRotor)	0.7	0.7		0%	0
Watered Mown Lawn Areas	Low	1	0.7	50.72	17%	58
Special Landscape Areas (SL	A)					
Vegetable Garden	High (Drip or Bubbler)	1	0.9		0%	0
Vegetable Garden	Moderate (Spray orRotor)	<u>·</u> 1	0.7		0%	0
Sports Lawn (Commercial / Parks)	Moderate (Spray orRotor)	 1	0.7		0%	0
Rainwater or Recycled Water Use	(epray arrange)	0.3	1		0%	0
Totals				306.49	100%	194
Special Landscape Area (SLA) Sub to	tal			0		177

^{*}If proposed design conditions are not shown on the form please contact Water Smart 250-460-0678



1435 Water Street Kelowna, BC V1Y 1J4 250 469-8500 kelowna.ca

Landscape Water Conservation Report

Address: 2606 - 2696 Pandosy Street

Applicant: NTAE / Arquiecos

CALCULATE & COMPARE WATER BUDGET TO ESTIMATED WATER USE

Total Landscape Area	306	sq.m.		
Landscape Water Budget (WB)	245	cu.m./yr.		
Estimated Landscape Water Use (WU)	194	cu.m./yr.		
Under (-OVER) Budget (Must be under Water Budget WB)	51	cu.m./yr.		
	OK			
I confirm by completing the attached Landscape Water Con- practices for landscape and irrigation installation in Kelown will conform to the Hydrozone areas as identified in the Lan	a. I also acknowle	dge that the l	landscape treatments of the project	
Carlos Mier y Ponce Arzani		Date:	05-Jul-24	
Name of Applicant (person submitting the form)				
FOR CITY OF KELOWNA OFFICE USE ONLY				
TOR CITT OF RELOWING OFFICE OSE ONE!				
The calculations above satisfy the requirements of the Water is hereby APPROVED with the signature of the Water Manage	-	w 10480 Secti	ion 4.4.2 and 4.4.3.and the application	
Name of Kelowna Water Smart designate		Date:		
For Water Manager				