

#### Transmittal Page 1 of 2

To: Planning Department

CC: Dave Sidhu

City of Kelowna dave@patrika.ca

November 16, 2023

Re: Design Rationale for the Proposed Development of

925 Laurier Ave, Kelowna, BC (The Site)

Dear City of Kelowna Planning Department,

Further to submitted information as it pertains to the rezoning associated with the proposed Development of 925 Laurier Avenue in Kelowna to an MF2 Zone designation, we offer the following Rationale for the project:

Located in the Core Area, between the Capri Urban Centre and the Downtown Urban Centre created by the 2040 OCP. The proposed site is in close proximity both the Capri and Downtown Urban Centres and is the perfect location for families who need to be in close proximity to amenities such as grocery and retail stores, restaurants, schools, and parks. The location also offers alternative modes of transit to support those who wish to commute by bus, bicycle, or foot.

The proposed MF2 zone allows for ground-oriented townhouses that are strategically incorporated into the area, providing an increase in density from the existing single family in the neighbourhood.

The development provides an easily accessible mail centre, bicycle parking, and garbage & recycling area towards the entry of the site. The entrance to the parking area will be provided via a lane which will be accessed from Ethel Street. The units will have ground-oriented access from Laurier Avenue. The development consists of one (1) townhouse building with five (5) 3-bedroom units. The proposed townhouse will be 3-storeys (11.0m) tall and will conform to all requirements of the MF2 zone; no variances are being requested.

Each unit is provided with two (2) parking stalls in a shared parking area below the building. The main entrance to each unit will be located from grade, providing mechanical rooms and entry closets on the main floor. The second floor contains the kitchen, dining, living, and bathroom. The third floor contains one (1) primary bedroom with ensuite and walk-in-closet, two (2) bedrooms with a common bathroom, a storage room, and a laundry closet. The rooftop contains large private outdoor deck spaces for each unit.

The proposed building form and style serves to maintain consistency with the new developments in the area, bringing new life to the neighbourhood with its modern design. Simplified massing is utilized to ensure both energy efficiency in the exterior wall layout, as well as cost effective construction. The design takes advantage of the simplistic form by accenting elements such as unit entrances to create visual intrigue. Natural elements such as brick and wood-appearance privacy



#### **Transmittal** Page 2 of 2

slats are used to enhance the character of the neighbourhood, making the façade more inviting from a pedestrian perspective.

In summary, the rationale for this project is as follows:

- i. Provide an increase in density to a neighbourhood where this density is desired.
- ii. Provide 3-bedroom units to accommodate the need for family-oriented housing.
- iii. Provide a building typology that fits into the context, provides ground-oriented units, and allows for an energy-efficient built-form.
- iii. The proposed development meets all City of Kelowna Bylaw requirements.

This proposed development recognizes the City of Kelowna's strategic approach to overall growth including better use of precious developable land in accordance with the City's OCP/Future Land Use, Healthy City Strategy and planning initiatives.

We look forward to your supportive comments in response to this Rezoning/Development Variance Permit application.

Please do not hesitate to contact our office if you have any questions or require additional information in these matters.

Sincerely:

Matt Johnston

Architect AIBC, LEED AP

LIME Architecture Inc.

## 925 LAURIER AVE, KELOWNA, BC



NORTHWEST VIEW FROM LAURIER AVENUE



NORTHEAST VIEW FROM LAURIER AVENUE



SITE KEY PLAN (NOT TO SCALE)

## PROPERTY DESCRIPTION

925 LAURUER AVE, KELOWNA BC LOT B, DL 138, ODYD, PLAN KAP2255

## ARCHITECTURAL SHEET LIST

A-001	LOCATION CONTEXT
A-002	2040 OCP RESPONSE
A-003	PROJECT INFORMATIO
A-101	LEVEL 1 PLAN
A-102	LEVEL 2 PLAN
A-103	LEVEL 3 PLAN
A-104	ROOF TOP PATIO PLAN
A-200	ELEVATIONS
A-201	ELEVATIONS
A-202	ELEVATIONS
A-203	ELEVATIONS

COVER SHEET

## CONSULTANT TEAM

OWNER / OPERATOR	<u>ARCHITECTURAL</u>
Patrika Media 1481 Tracey Street Abbotsford, BC V2T 6G4 604-621-1827	LIME Architecture 205-1626 Richter Stree Kelowna, BC V1Y 2M3 250-448-7801

Contact(s):	Contact(s):
Dave Sidhu	Brandon Dobroskay

#### <u>CIVIL</u> <u>LANDSCAPING</u>

250-763-2315

Contact(s):

David Mori

Meghan Nimegeers Landscape Design D E Pilling & Associates 540 Groves Avenue 15675 McDonagh Rd Kelowna, BC V1Y 4Y7 Lake Country, BC V4V 2E7 250-864-3873

> Contact(s): Meghan Nimegeers



SOUTHEAST VIEW FROM LANE



SOUTHWEST VIEW FROM LANE

PRELIMINARY DESIGN



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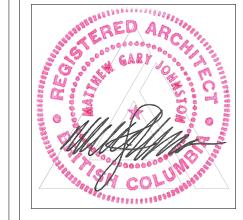
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**Revision No., Date** and Description

11.17.23 FOR REZONING / DP

2023-11-16 11:30:28 AM **PROJECT** 925 LAURIER AVENUE DRAWING TITLE

**COVER SHEET** 



## Site Description & Current Conditions


The proposed development consists of a 3-storey, 5-unit townhouse building. Access will be provided by a lane which will be accessed from Ethel St. Located in the Core Area, between the Capri Urban Centre and the Downtown Urban Centre, the proposed site is the perfect location for families who need to be in close proximity to amenities such as grocery and retail stores, restaurants, schools, and parks. The location also offers alternative modes of transit to support those who wish to commute by bus, bicycle, or foot.



1. VIEW FROM LAURIER AVE FACING THE SITE




4. VIEW FROM THE SITE LOOKING ACROSS LAURIER AVE

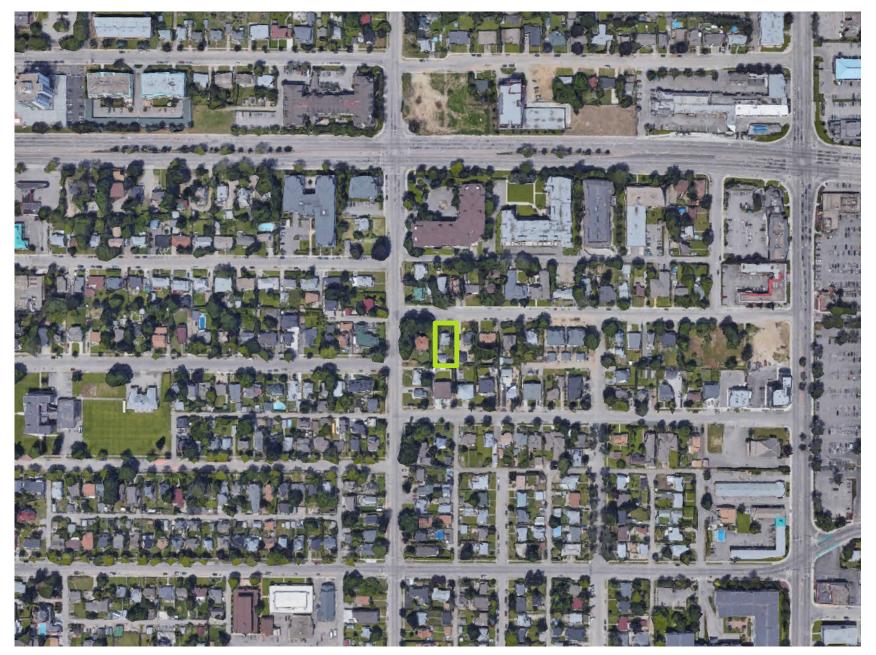


SITE LOCATION



2. VIEW FROM LAURIER AVE FACING THE SITE

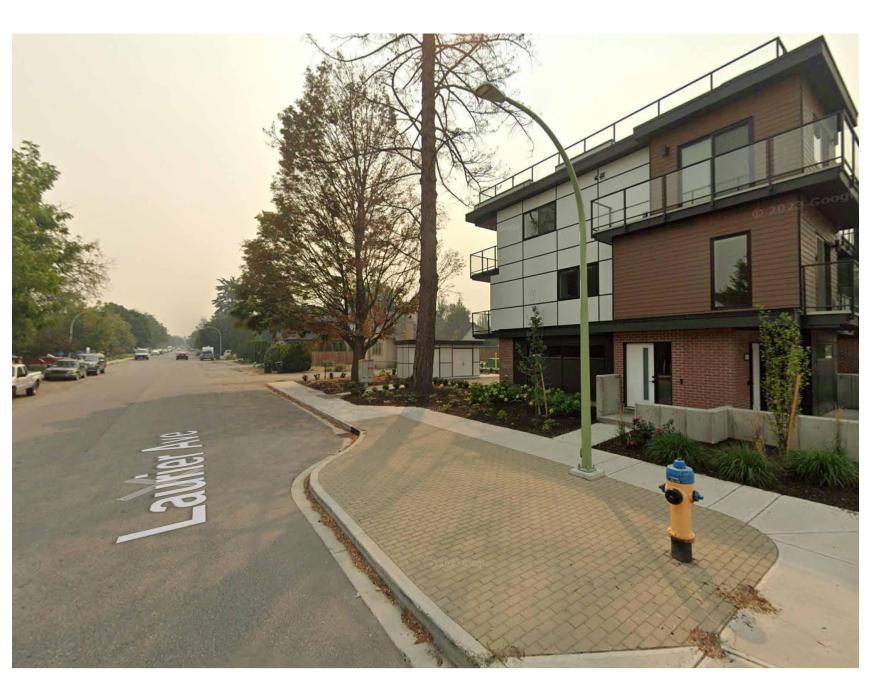

5. VIEW FROM ETHEL ST FACING THE SITE

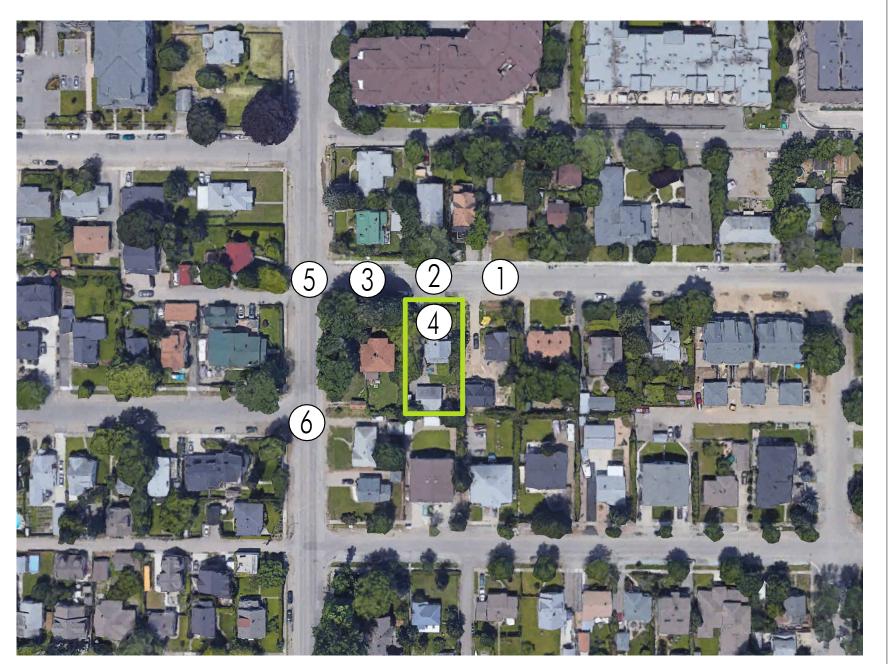

SITE CONDITION KEY MAP



3. VIEW FROM LAURIER AVE FACING THE SITE



6. VIEW FROM ETHEL ST FACING THE LANE

### PRELIMINARY DESIGN



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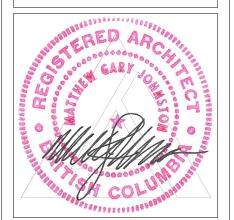
Revision No., Date and Description

11.17.23 FOR REZONING / DP

Plot Date 10.16.23 PROJECT 925 LAURIER AVENUE

LOCATION
CONTEXT

Drawing No.




## Iransportation

Surrounded by both bus and bicycle paths, Kelowna's transportation network is accessible to residents who wish to travel without a car. There are many bus stops along Harvey Ave, Gordon Dr, Sutherland Avenue, and Richter St, all in short walking distance from Laurier Ave. A quick bicycle ride or bus ride can have residents to any of the amenities they could need either Downtown Kelowna or at the Capri Centre. If desired, the commute would also be doable by foot in 10-15 minutes in either direction. This will allow families the freedom of living in this location without every member of the family requiring access to a car.

A bicycle path exists along Ethel St with many future bicycle path planned to connect this one in either direction to both Downtown Kelowna and to the Capri Centre. While these might be some of the more common locations cyclists choose to go, there are many more bicycle paths both existing and planned, providing many options for commuting by bicycle in this location.

# — 925 LAURIER AVE Park Memorial Park

SURROUNDING TRANSIT

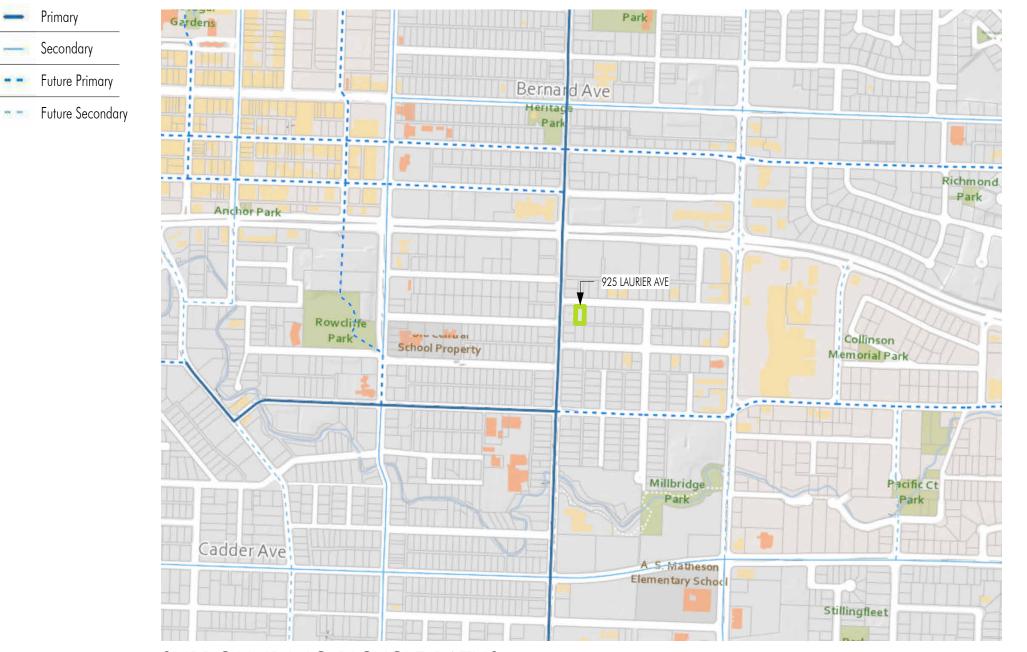

SURROUNDING BICYCLE PATHS

## Response to Core Area Guidelines

#### Land Use and Urban Design Guidelines

Design residential infill to be sensitive to neighbourhood context

- 3.0m of the property is being dedicated along the south to provide lane access from Ethel St.
- Site coverage of hardscaping is decreased by providing surface parking below the building footprint, allowing more greenspace to surround the site.

#### Housing Guidelines

Include diverse housing:

 A ground-oriented unit has been provided to support family-friendly housing.

Future Frequent

Local

• All units are 3-bedroom units to support a family-friendly neighbourhood development.

Provide private amenity space to enhance the quality of the development:

• Each unit is provided with their own private rooftop patio and their own personal unit entrance.

#### Transportation Guidelines

Provide a bicycle-oriented Development:

 Long-term and short-term bicycle parking has been included to encourage biking as a convenient transportation option. Short-term bicycle racks are provided at the entrance of the site off the lane, and long-term bicycle spaces are provided between parking stalls within the parking garage.



Secondary

Future Primary



2040 OCP Future Land Use Plan

## Response to Form & Character

#### Relationship to Street Guidelines

Design the building to frame and activate the public streets:

 Windows and front entry doors have been oriented to provide access directly from Laurier Ave and to provide "eyes on the street" for increased neighbourhood security.

Define ground-oriented units:

- The ground-oriented unit faces Laurier Ave and is clearly defined, providing a visual accent to the overall development.
- Direct pedestrian access will be provided from Laurier Ave, encouraging foot traffic in the neighbourhood.

#### **Site Planning**

Design to unique site conditions:

 Designing an increase in density to an already small site, the dedication of laneway to help improve this and future developments in the area made the design increasingly challenging to achieve the target density.

Use crime prevention through environmental design:

- The entrances are open and highly visible.
- Windows and balconies overlook public streets and provide natural surveillance.
- The building is free from any small enclosures that provide hiding spots.
- Window heights provide the residents a certain level of privacy while also allowing "eyes on the street."


#### Building Articulation, Features, & Material Guidelines

Articulate building facades into intervals:

- Building projections and canopy placement have been strategically located to create intervals.
- Window patterning and styles correlate with intervals.
- Material changes have been utilized in corresponding intervals.

#### Weather protection:

 Roof projections are used to provide weather protection from both rain infiltration and heat gain.

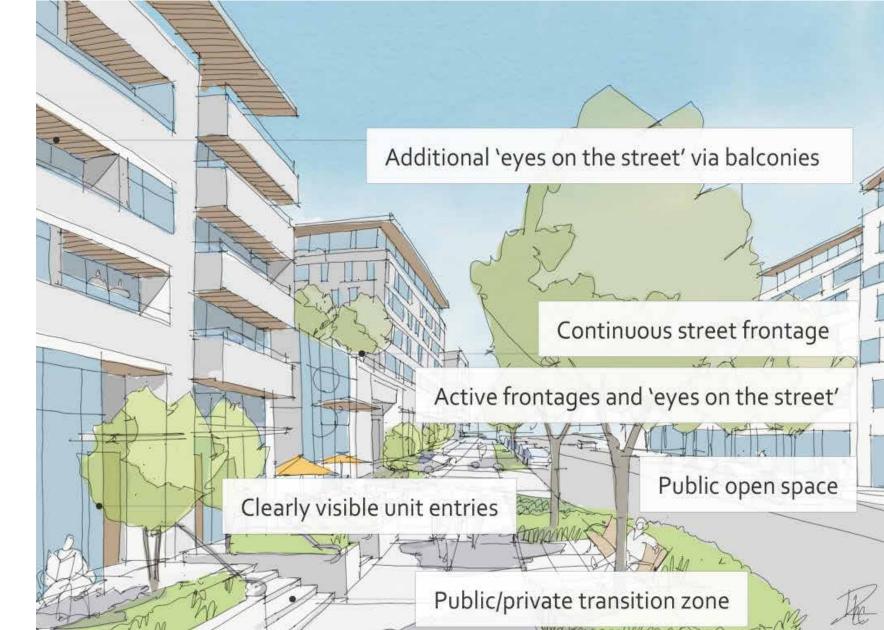

2040 OCP Relationship to Street Graphic

PRELIMINARY DESIGN



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# 925 LAURIER AVE, KELOWNA, BC

#### PROPERTY DESCRIPTION:

CIVIC: 925 LAURIER AVE, KELOWNA, BC LEGAL: LOT B, PLAN KAP2255

#### **ZONING CALCULATIONS:**

CURRENT: CITY OF KELOWNA RU4 ZONING CORE AREA NEIGHBOURHOOD PROPOSED: MF2 ZONING

#### SITE INFORMATION:

COMMON =

GROSS SITE AREA = 9,494 SF (882.1m<sup>2</sup>)

	<u>ALLOWED/REQUIRED</u>	<u>PROPOSED</u>
SITE COVERAGE =	55% (5,222 SF)	54% (4,948 SF)
SITE COVERAGE $+$ HARDSCAPING $=$	80% (7,596 SF)	68% (5,378 SF)
FAR =	1.0 (9,494 SF)	1.0 (9,484 SF)

N/A

11.0m (3 STOREYS)

3.0m

3.0m

3.0m

1 (0 VAN ACCESSIBLE)

9' - 11 23/32" [3041] 9' - 0 19/32" [2759]

2' - 11 7/16" [900] REAR YARD

1 SITE PLAN A-003 1/8" = 1'-0"

ROAD DEDICATION

2.54m PROPERTY LINE

0.50m PROPERTY LINE

HEIGHT =	11.0m (3 STOREYS)
PRIVATE & COMMON AMENITY SPACE:	

PRIVATE =	N/A
YARD SETBACKS:	
FRONT YARD =	3.0m
FRONT YARD (GROUND ORIENTED) =	3.0m
SIDE YARD (FAST) =	3 0m

SIDE LAKO (EAST) =	S.UM	
SIDE YARD (WEST) =	3.0m	
REAR YARD =	0.9m	
PARKING CALCULATIONS:		

3 BEDROOM UNITS =	5  UNITS x  1.6 = 8
VISITOR =	5  UNITS x  0.14 = 0.7
TOTAL =	9
ACCESSIBLE PARKING =	1 (0 VAN ACCESSIBLE)


LONG-TERM BICYCLE STORAGE:		
3 BEDROOM =	5  UNITS x  1 = 5	
TOTAL =	5	5

## CLIONT TENA DICYCLE CTORAGE

<u>Short-term</u> <u>bicycle storage:</u>		
TOWNHOUSES =	4	
TOTAL =	4	4

	PARKING		
COUNT TYPE			
1 ACCESSIBLE - 90 deg			
5	REGULAR - 90 deg		
5 SMALL - 90 deg			
11			

UNIT CALCULATIONS				
UNIT	# OF BEDROOMS	UNIT AREA	PRIVATE AMENITY SPACE	
UNIT 1	3	1893 SF	734 SF	
UNIT 2	3	1909 SF	734 SF	
UNIT 3	3	1910 SF	734 SF	
UNIT 4	3	1908 SF	734 SF	
UNIT 5	3	1865 SF	740 SF	
TOTAL UNIT AREAS		9484 SF		

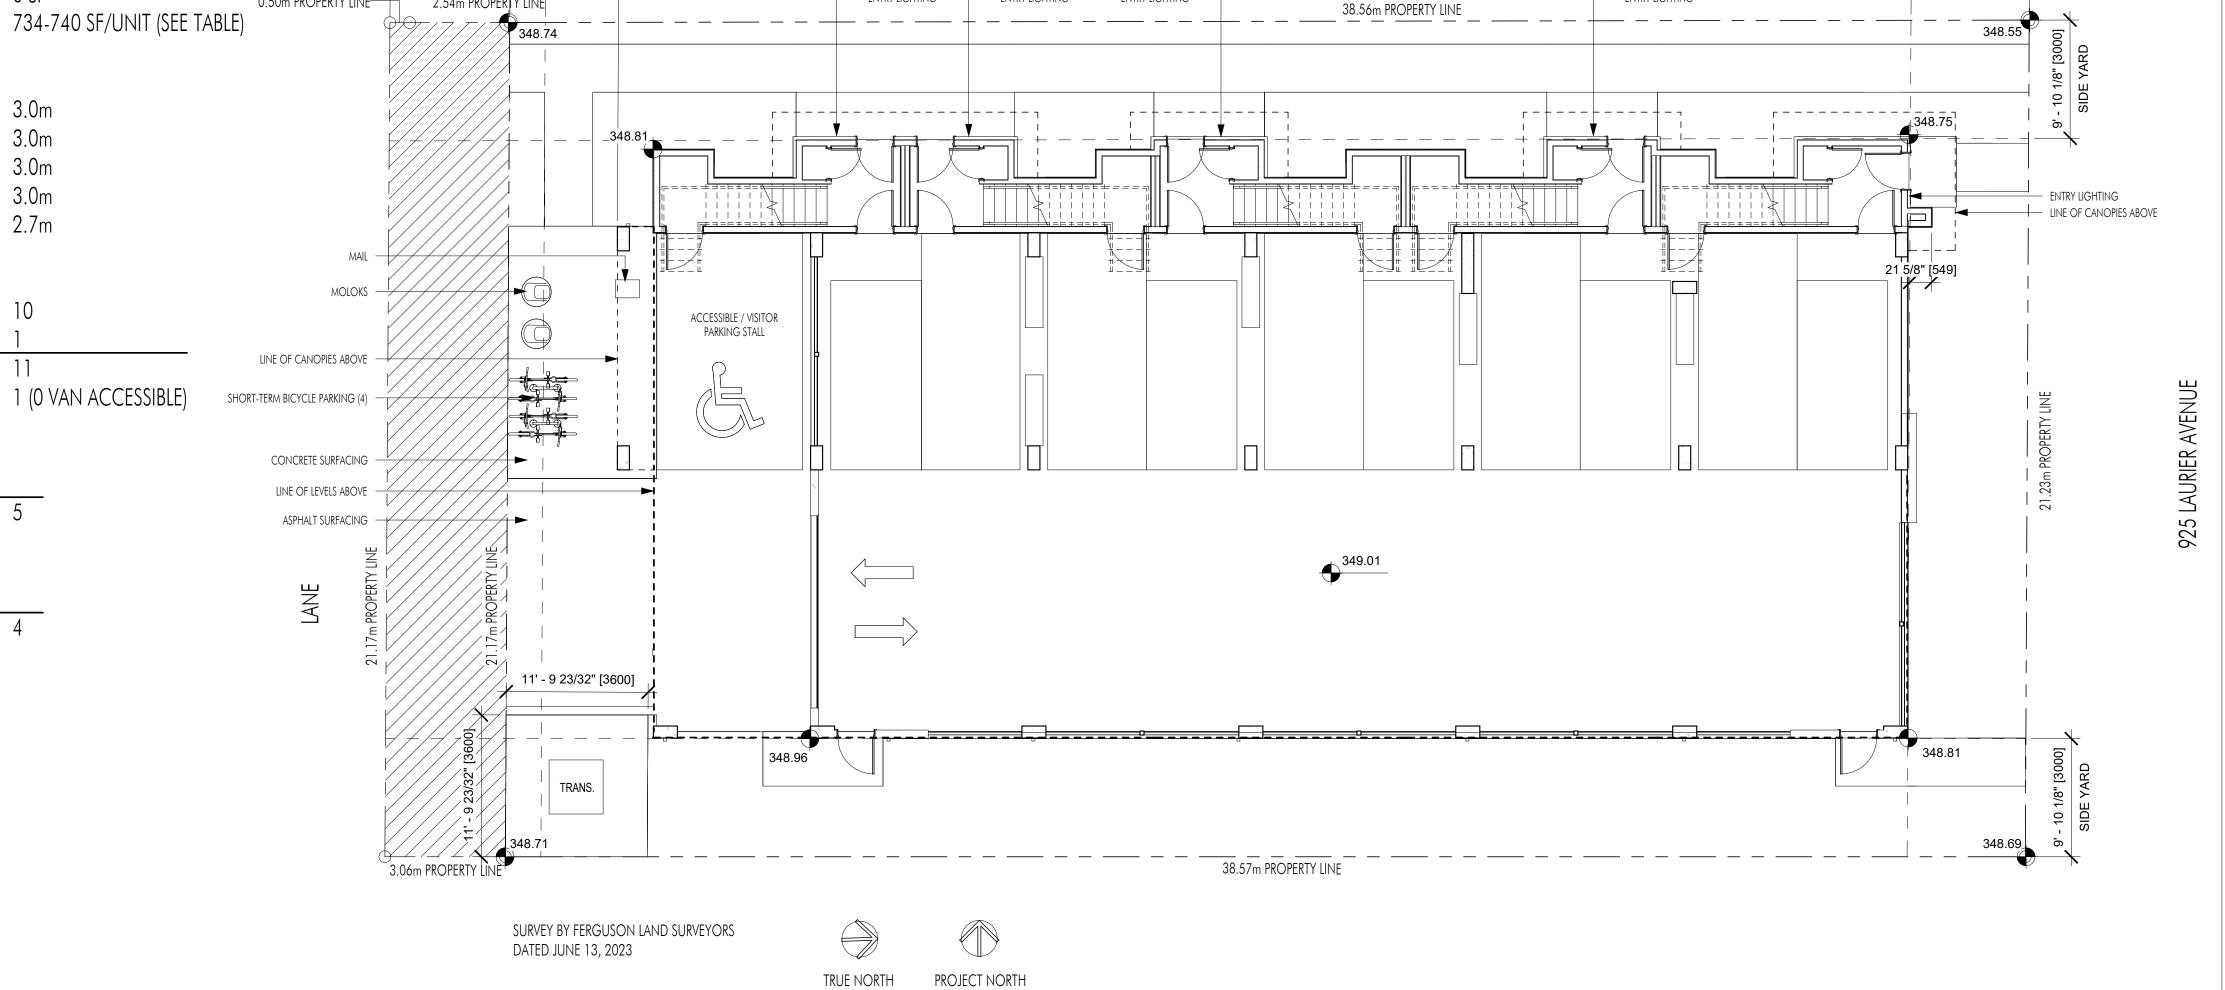

ENTRY LIGHTING

ENTRY LIGHTING

ENTRY LIGHTING -

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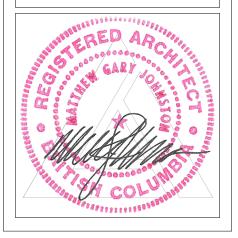
11.17.23 FOR REZONING / DP

Plot Date 2023-11-16 11:30:29 AM **PROJECT** 

925 LAURIER AVENUE **DRAWING TITLE** 

PROJECT INFORMATION


A-003



9' - 10 1/8" [3000]

FRONT YARD

- ENTRY LIGHTING

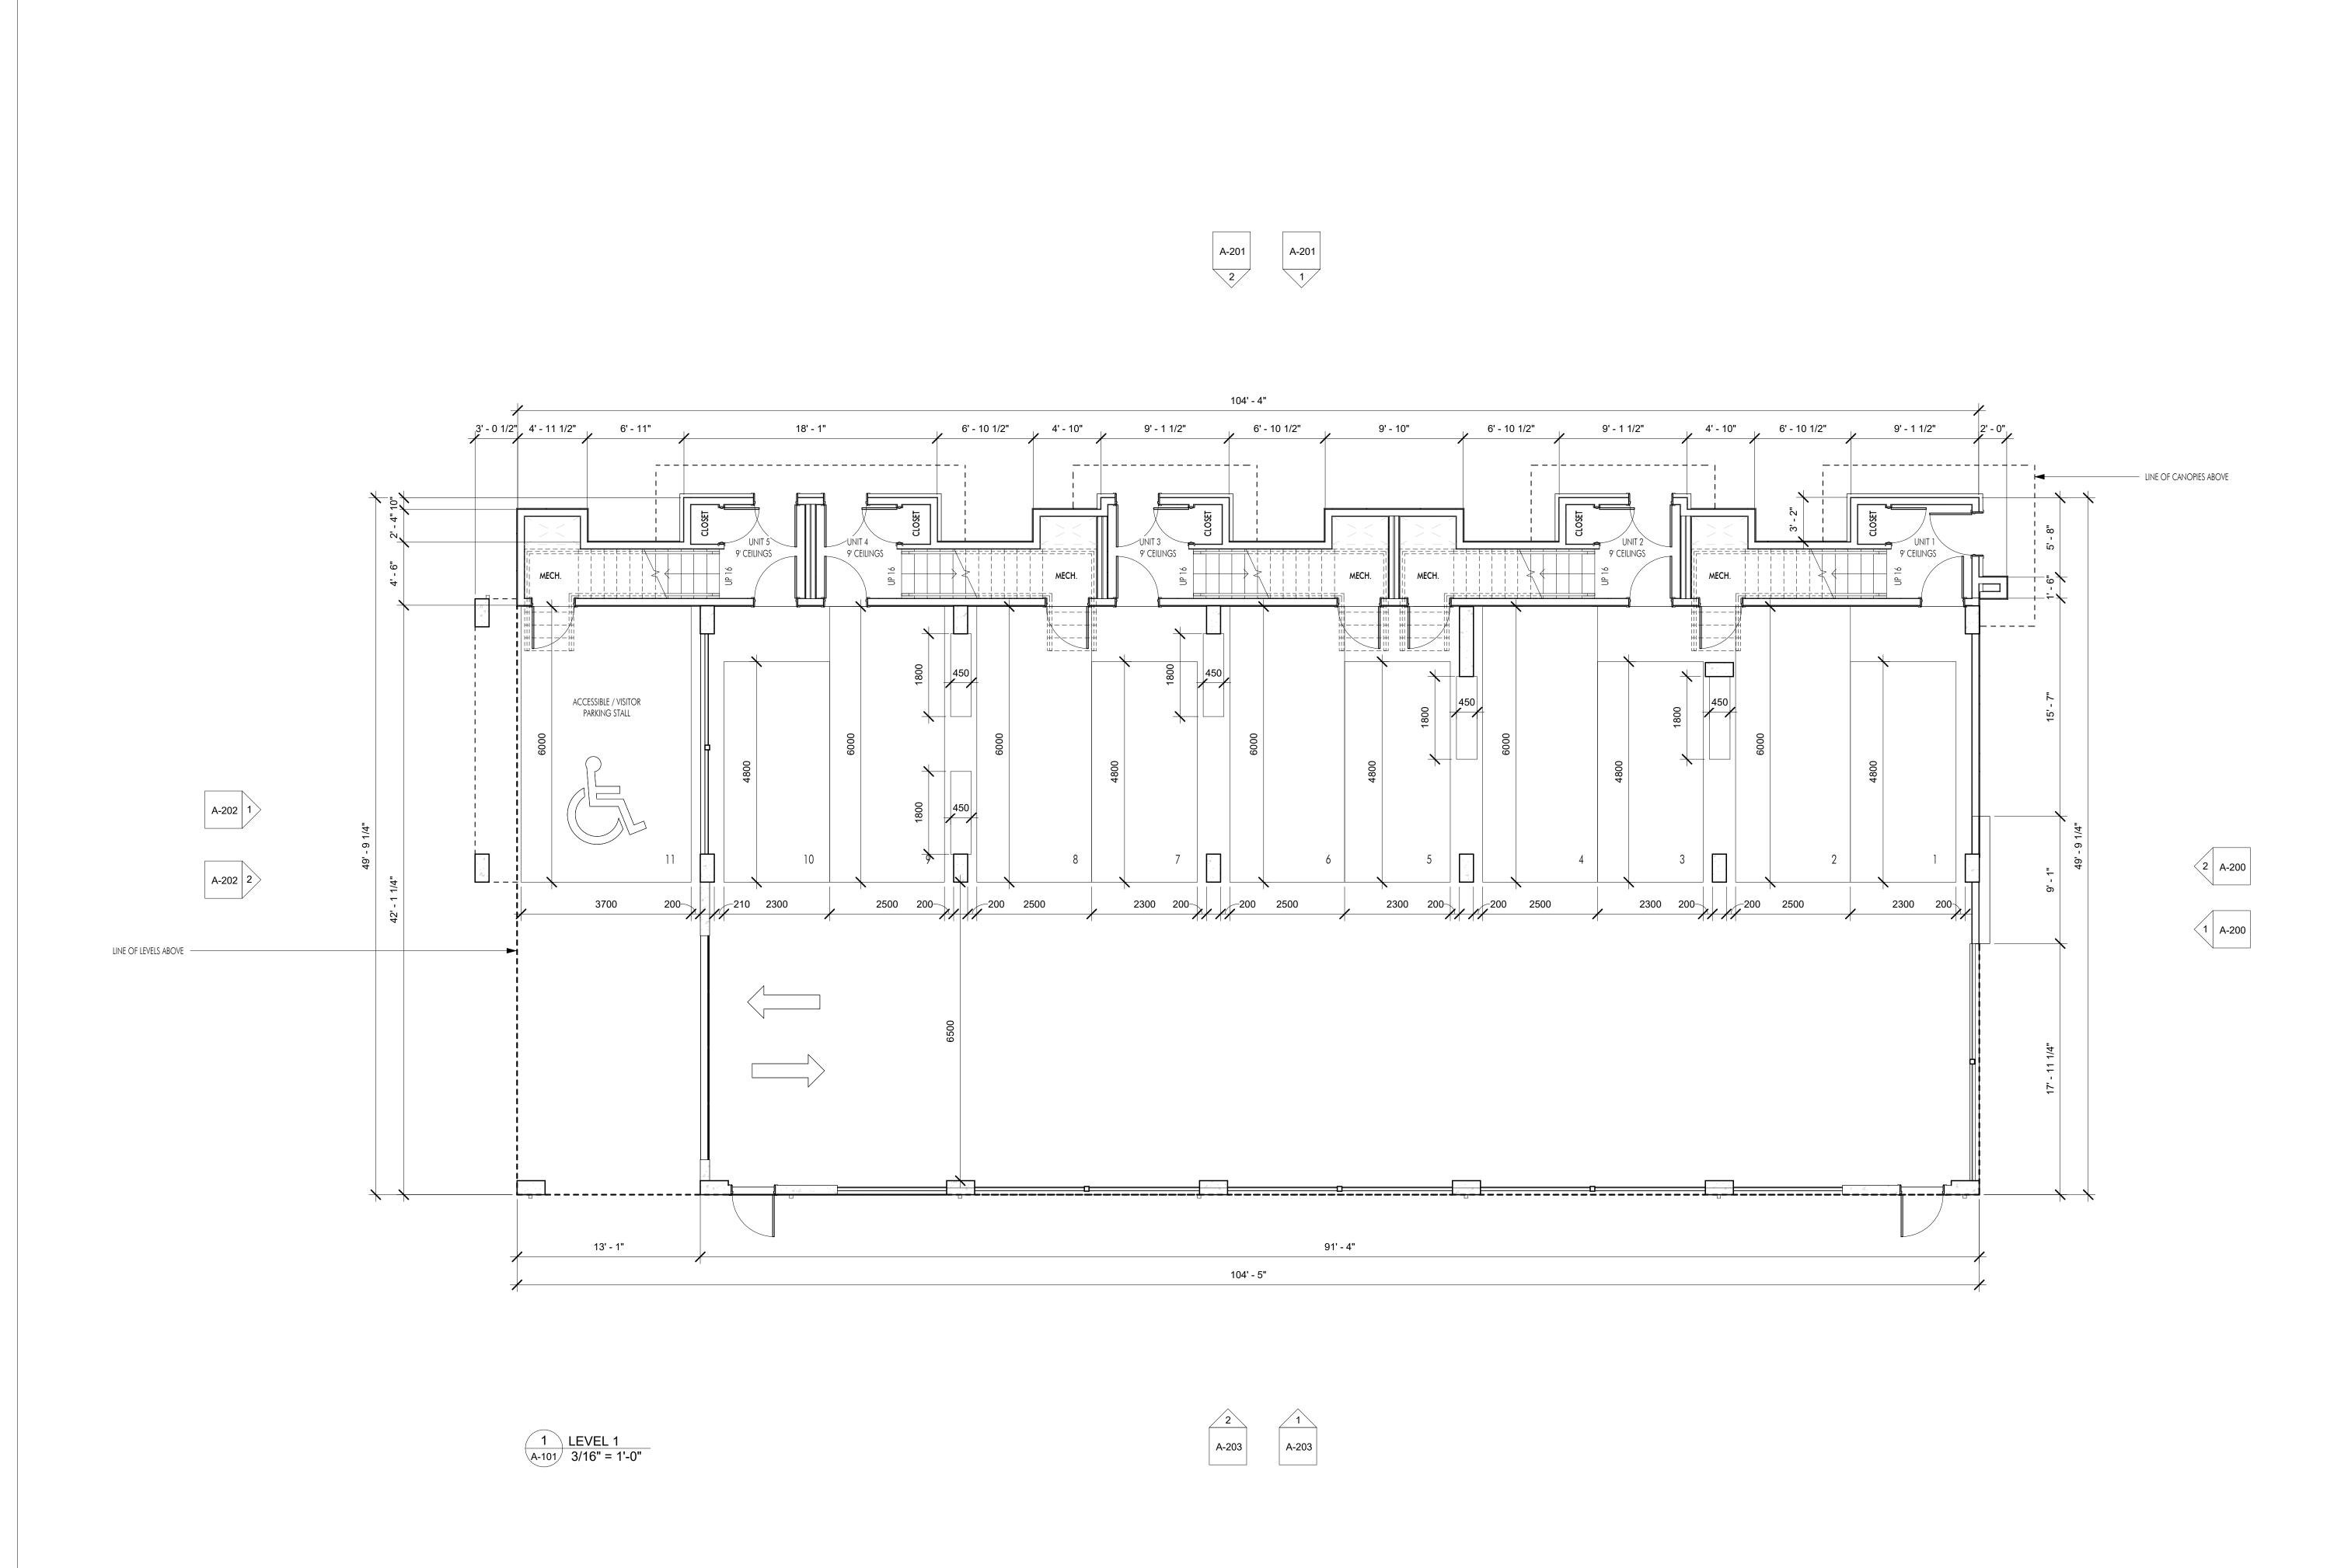

LIA ARCHITECT

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Plot Date 2023-11-16 11:30 PROJECT


925 LAURIER AVENUE

DRAWING TITLE

LEVEL 1 PLAN

Drawing No.



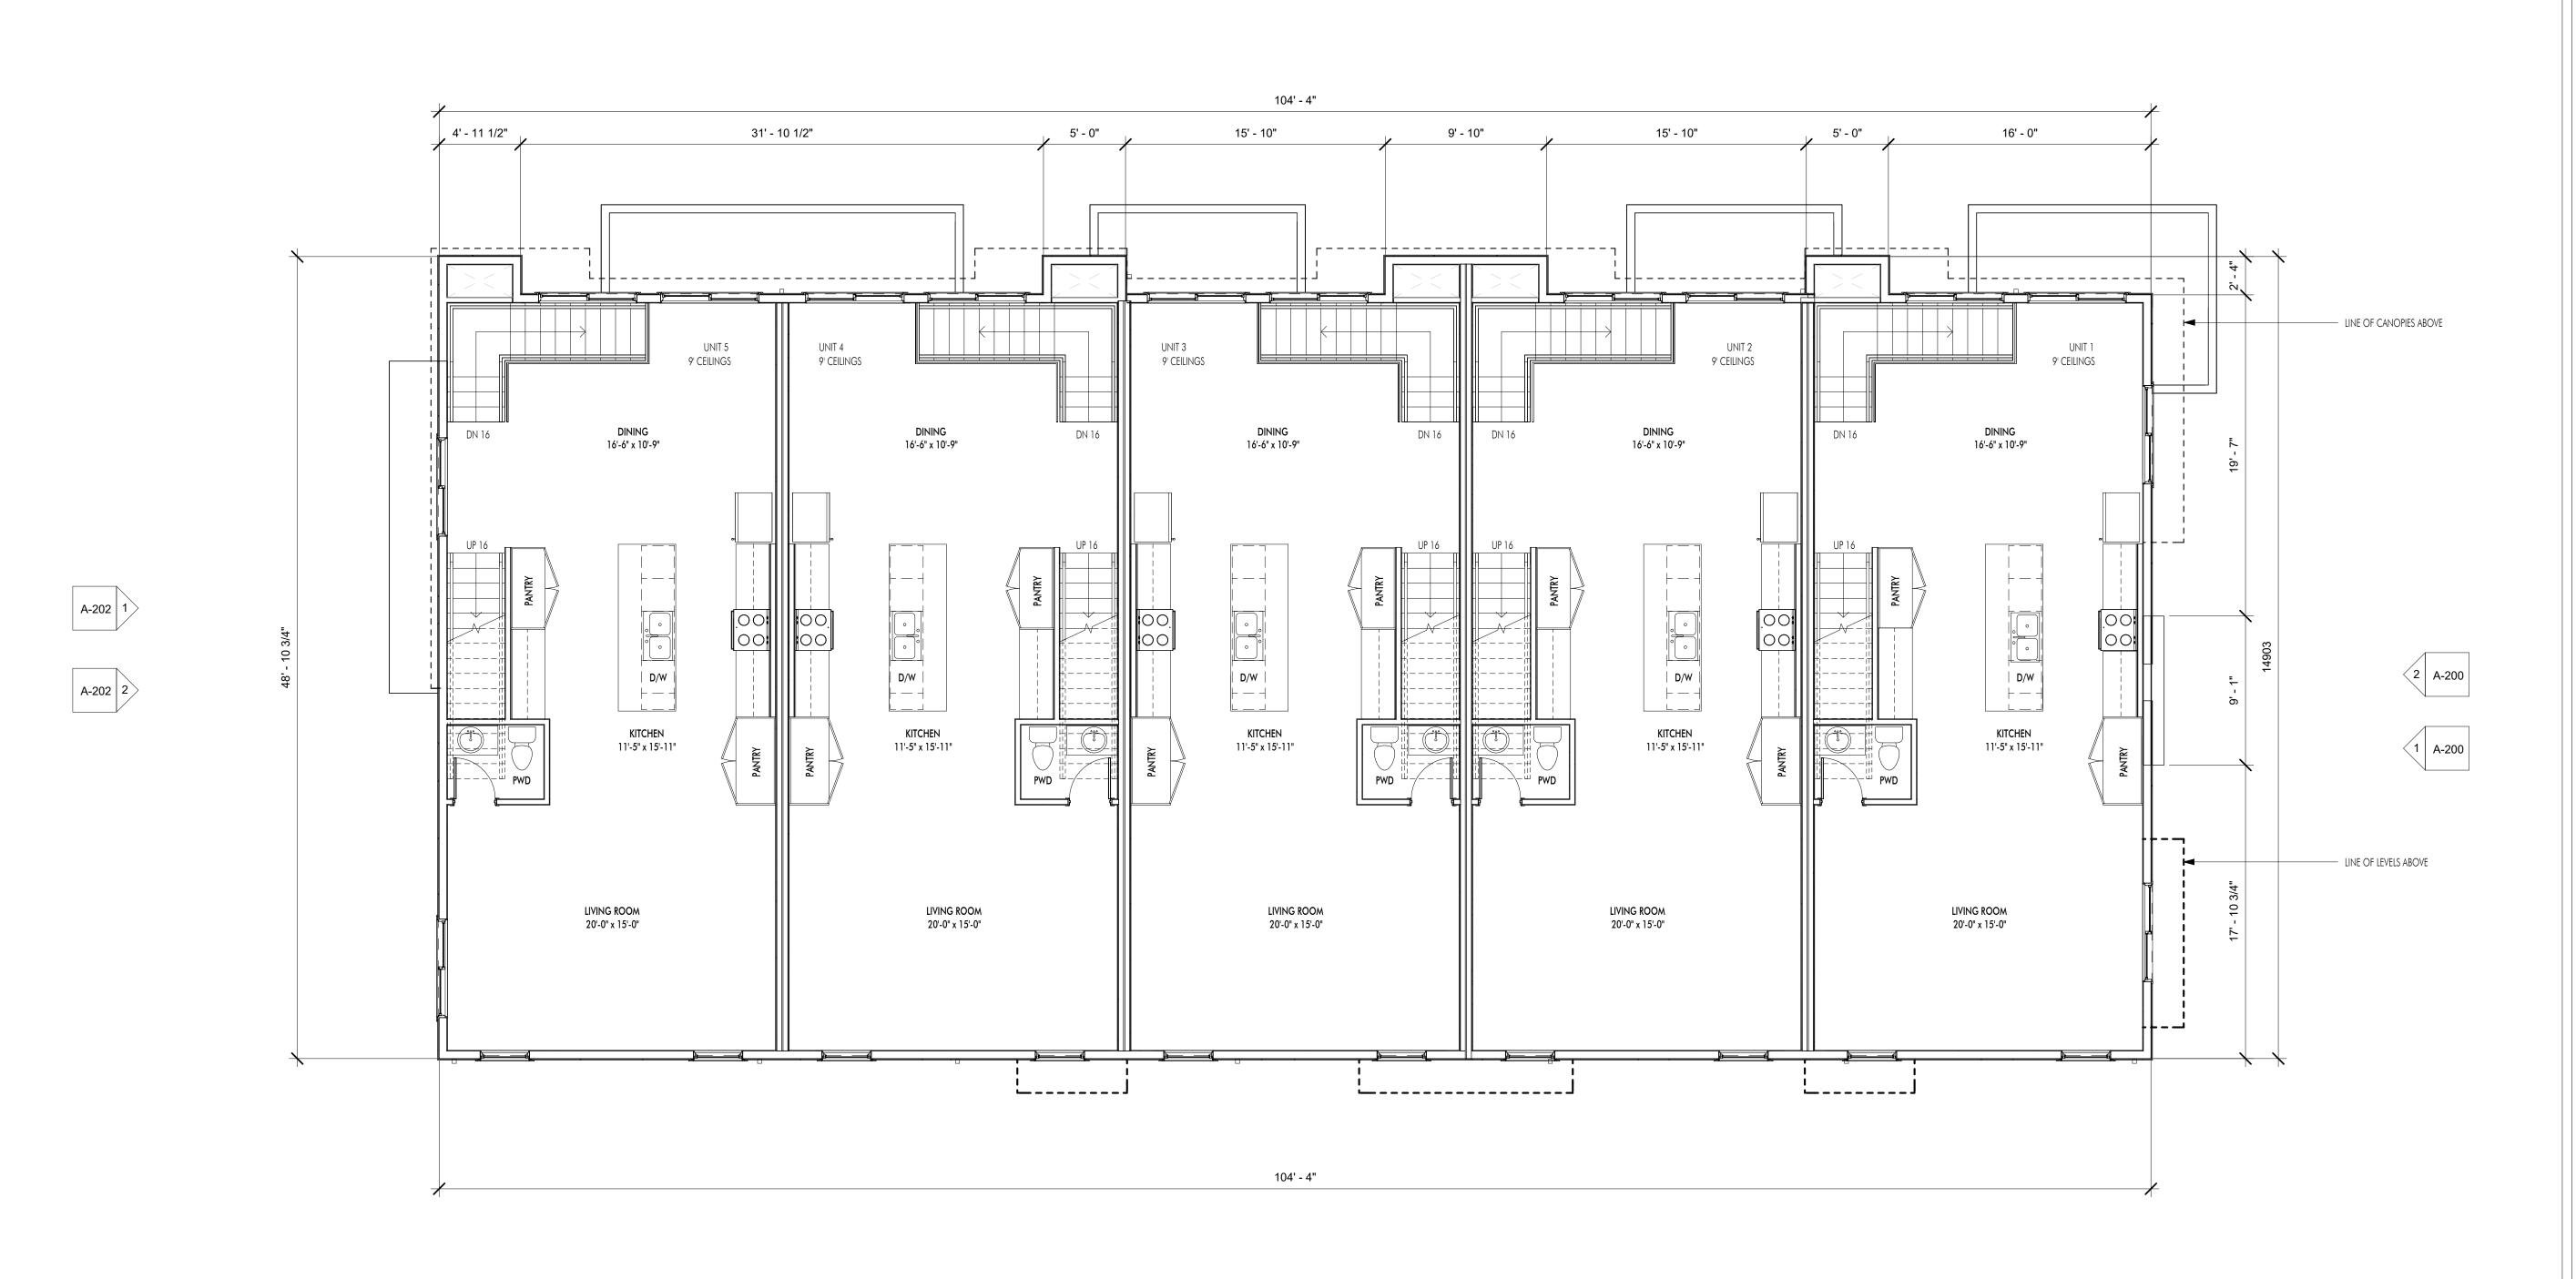

1 LEVEL 2 A-102 3/16" = 1'-0" ARCHITEC

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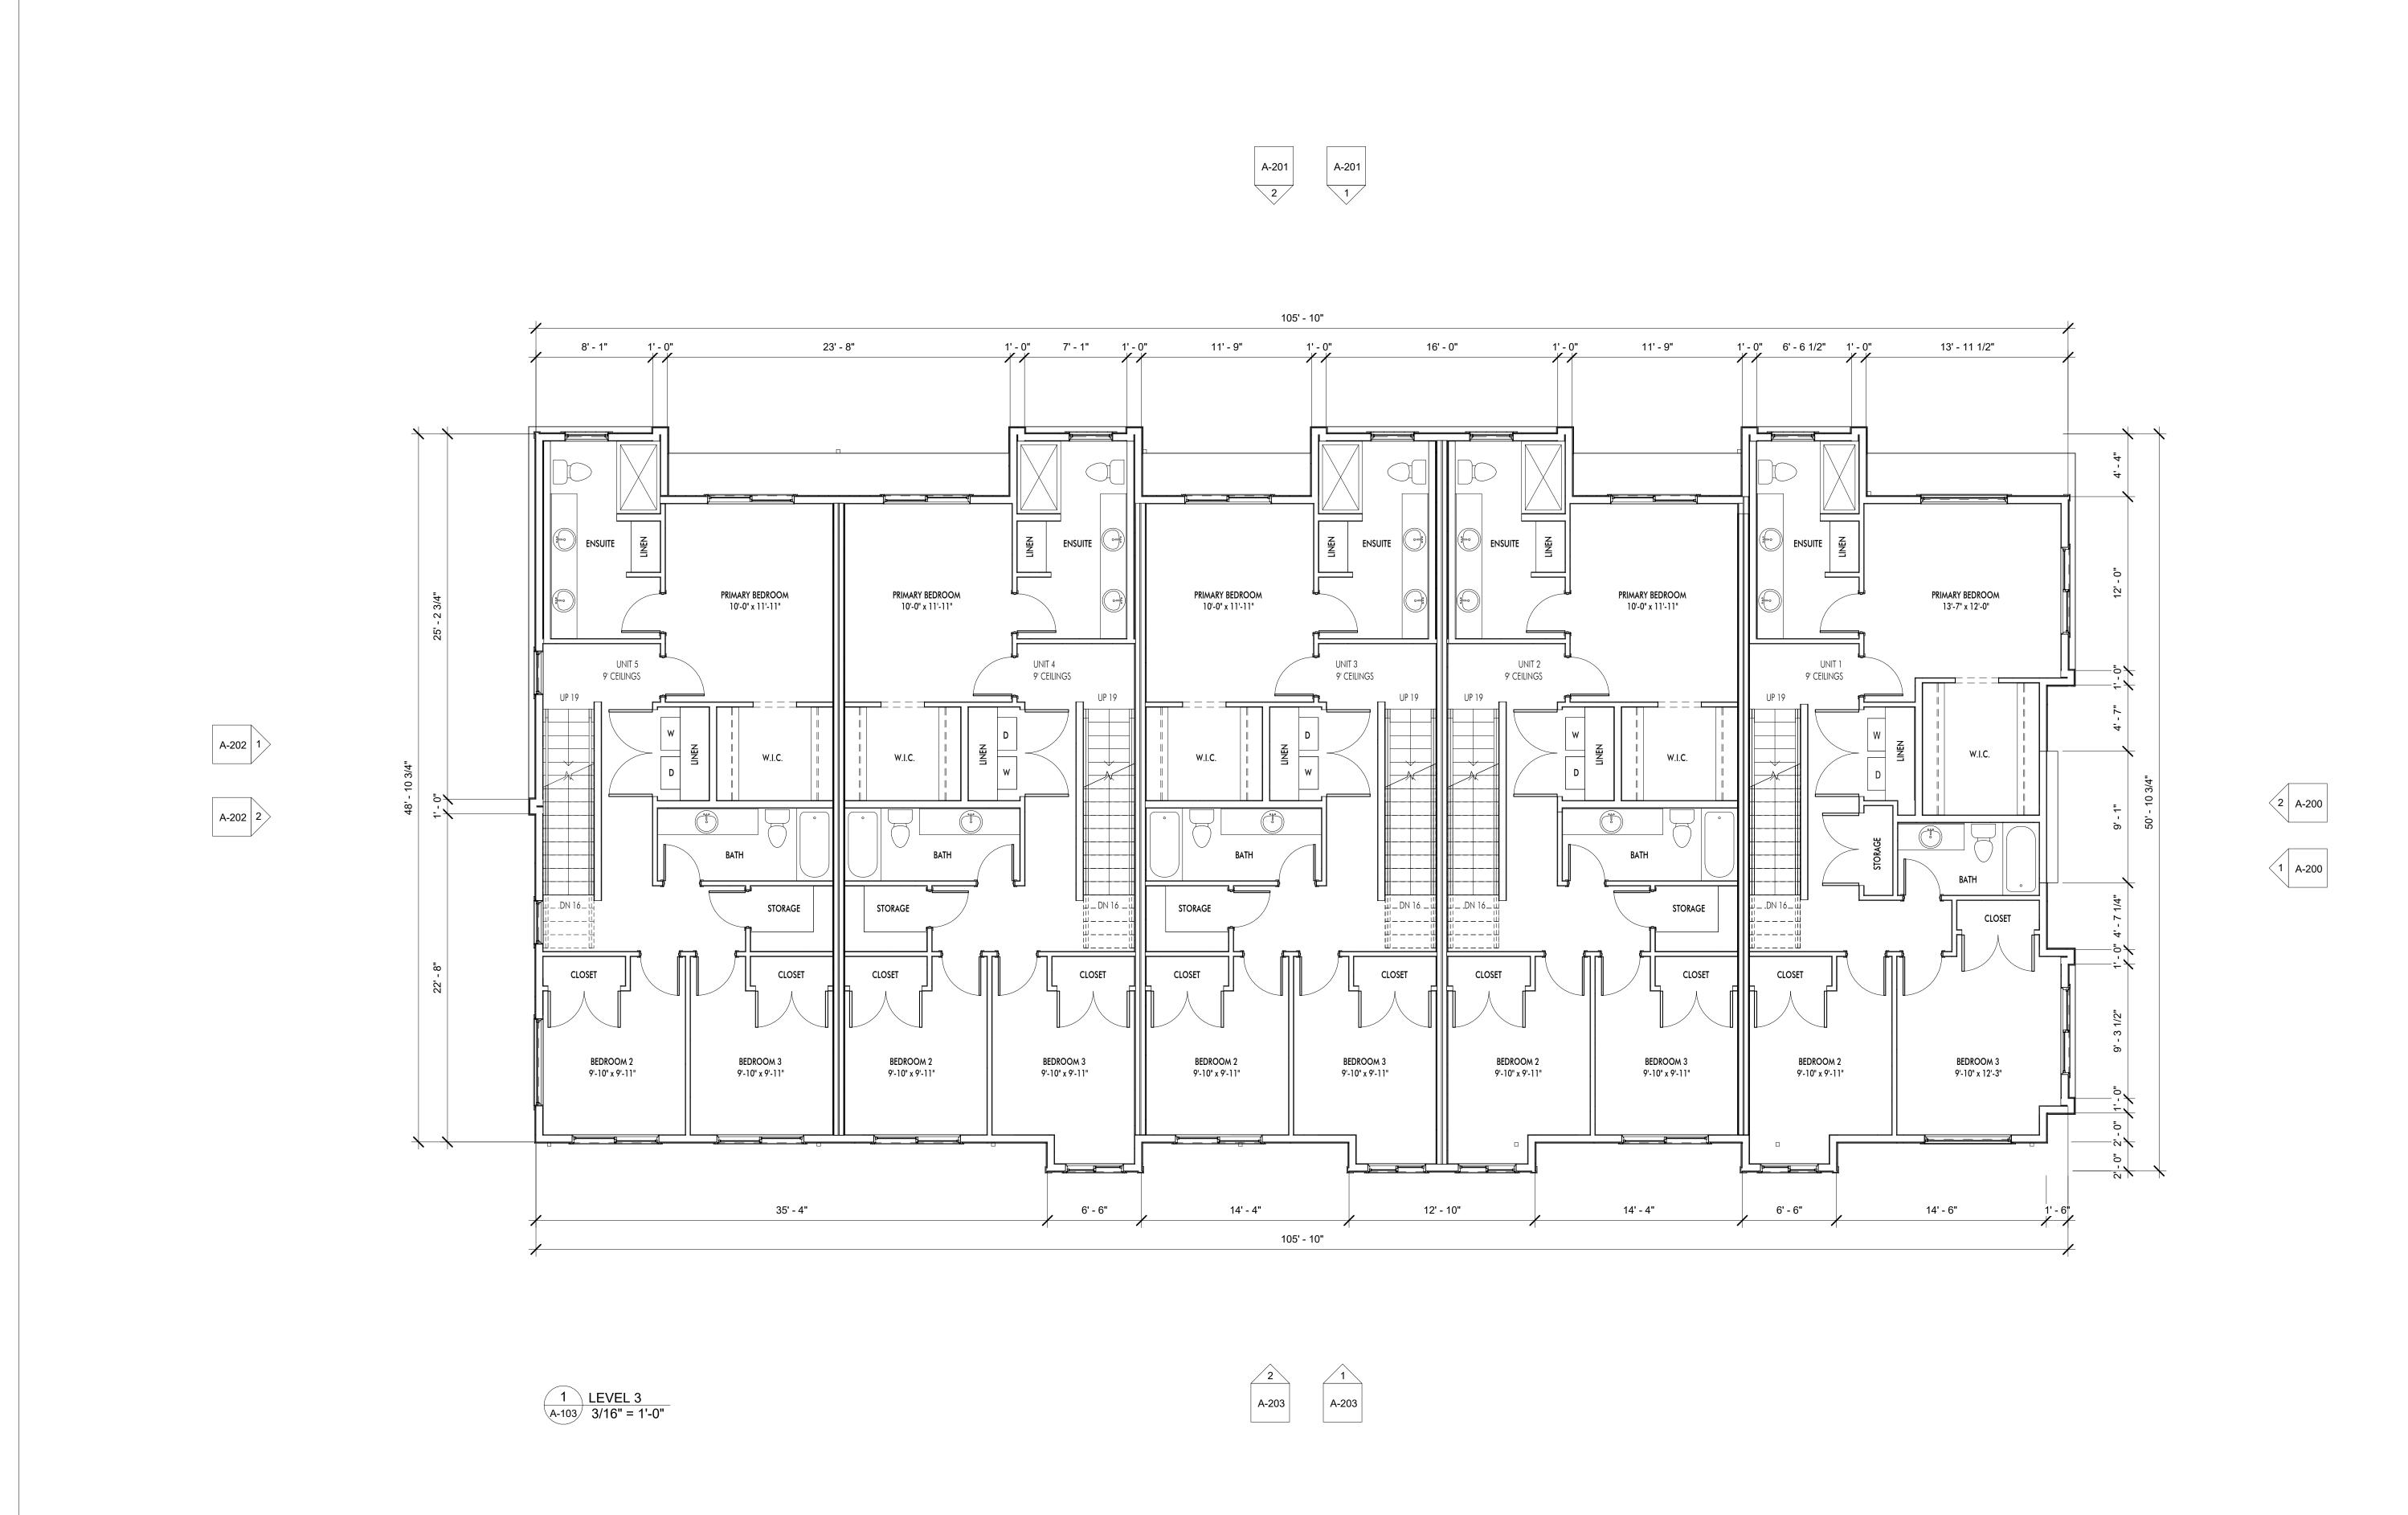
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DRAWING TITLE

LEVEL 2 PLAN

Drawing No.





LIV

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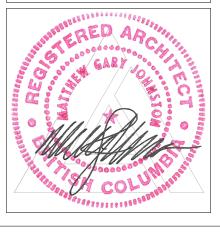
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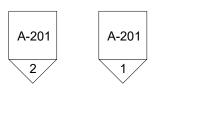
PROJECT
925 LAURIER AVENUE


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LEVEL 3 PLAN

Drawing No







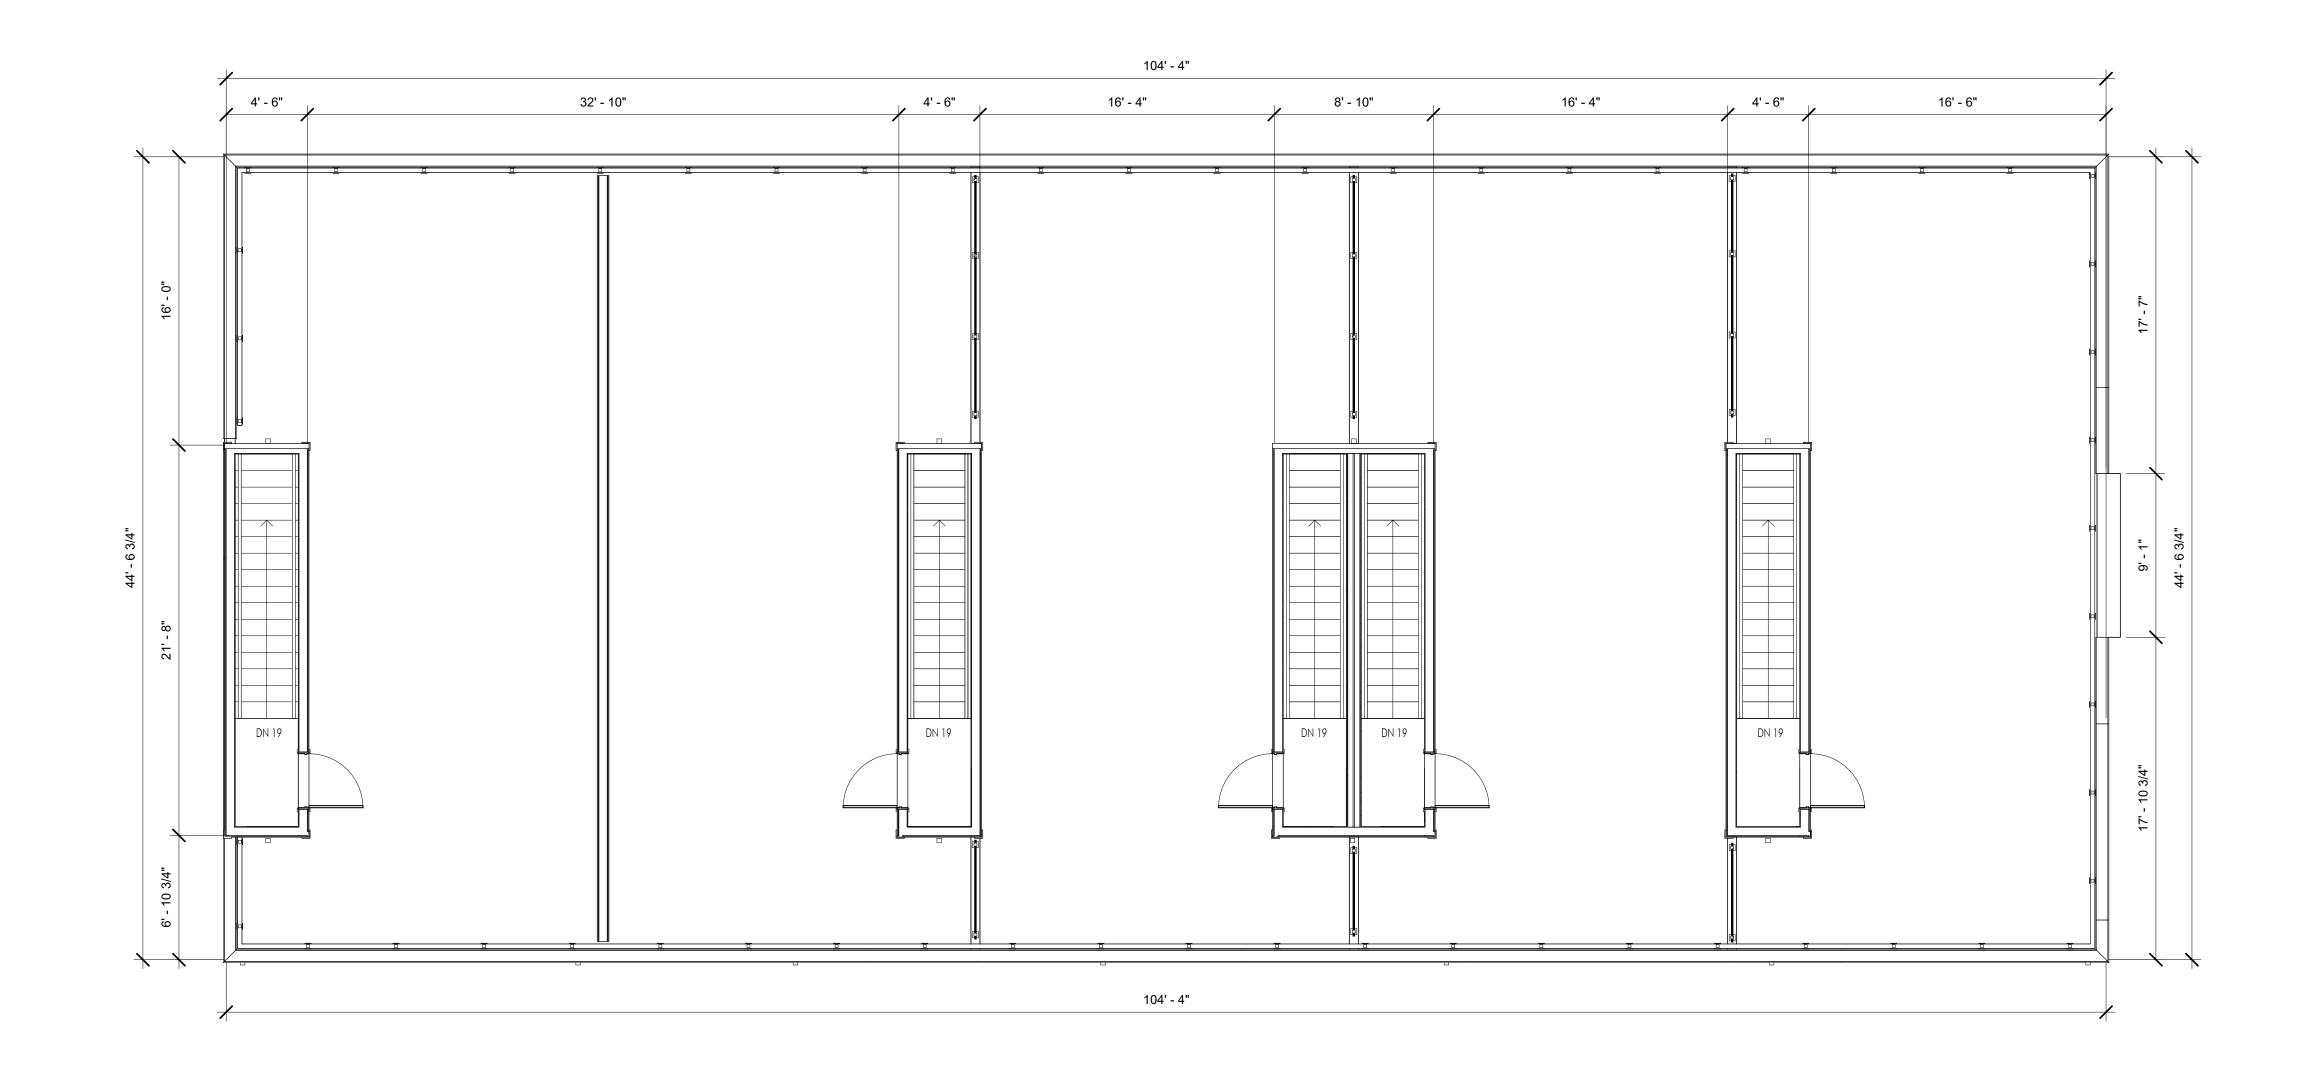



Plot Date 2023-11-16 11:30:30 AM

PROJECT
925 LAURIER AVENUE

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ROOF TOP PATIO PLAN

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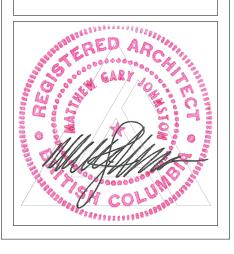
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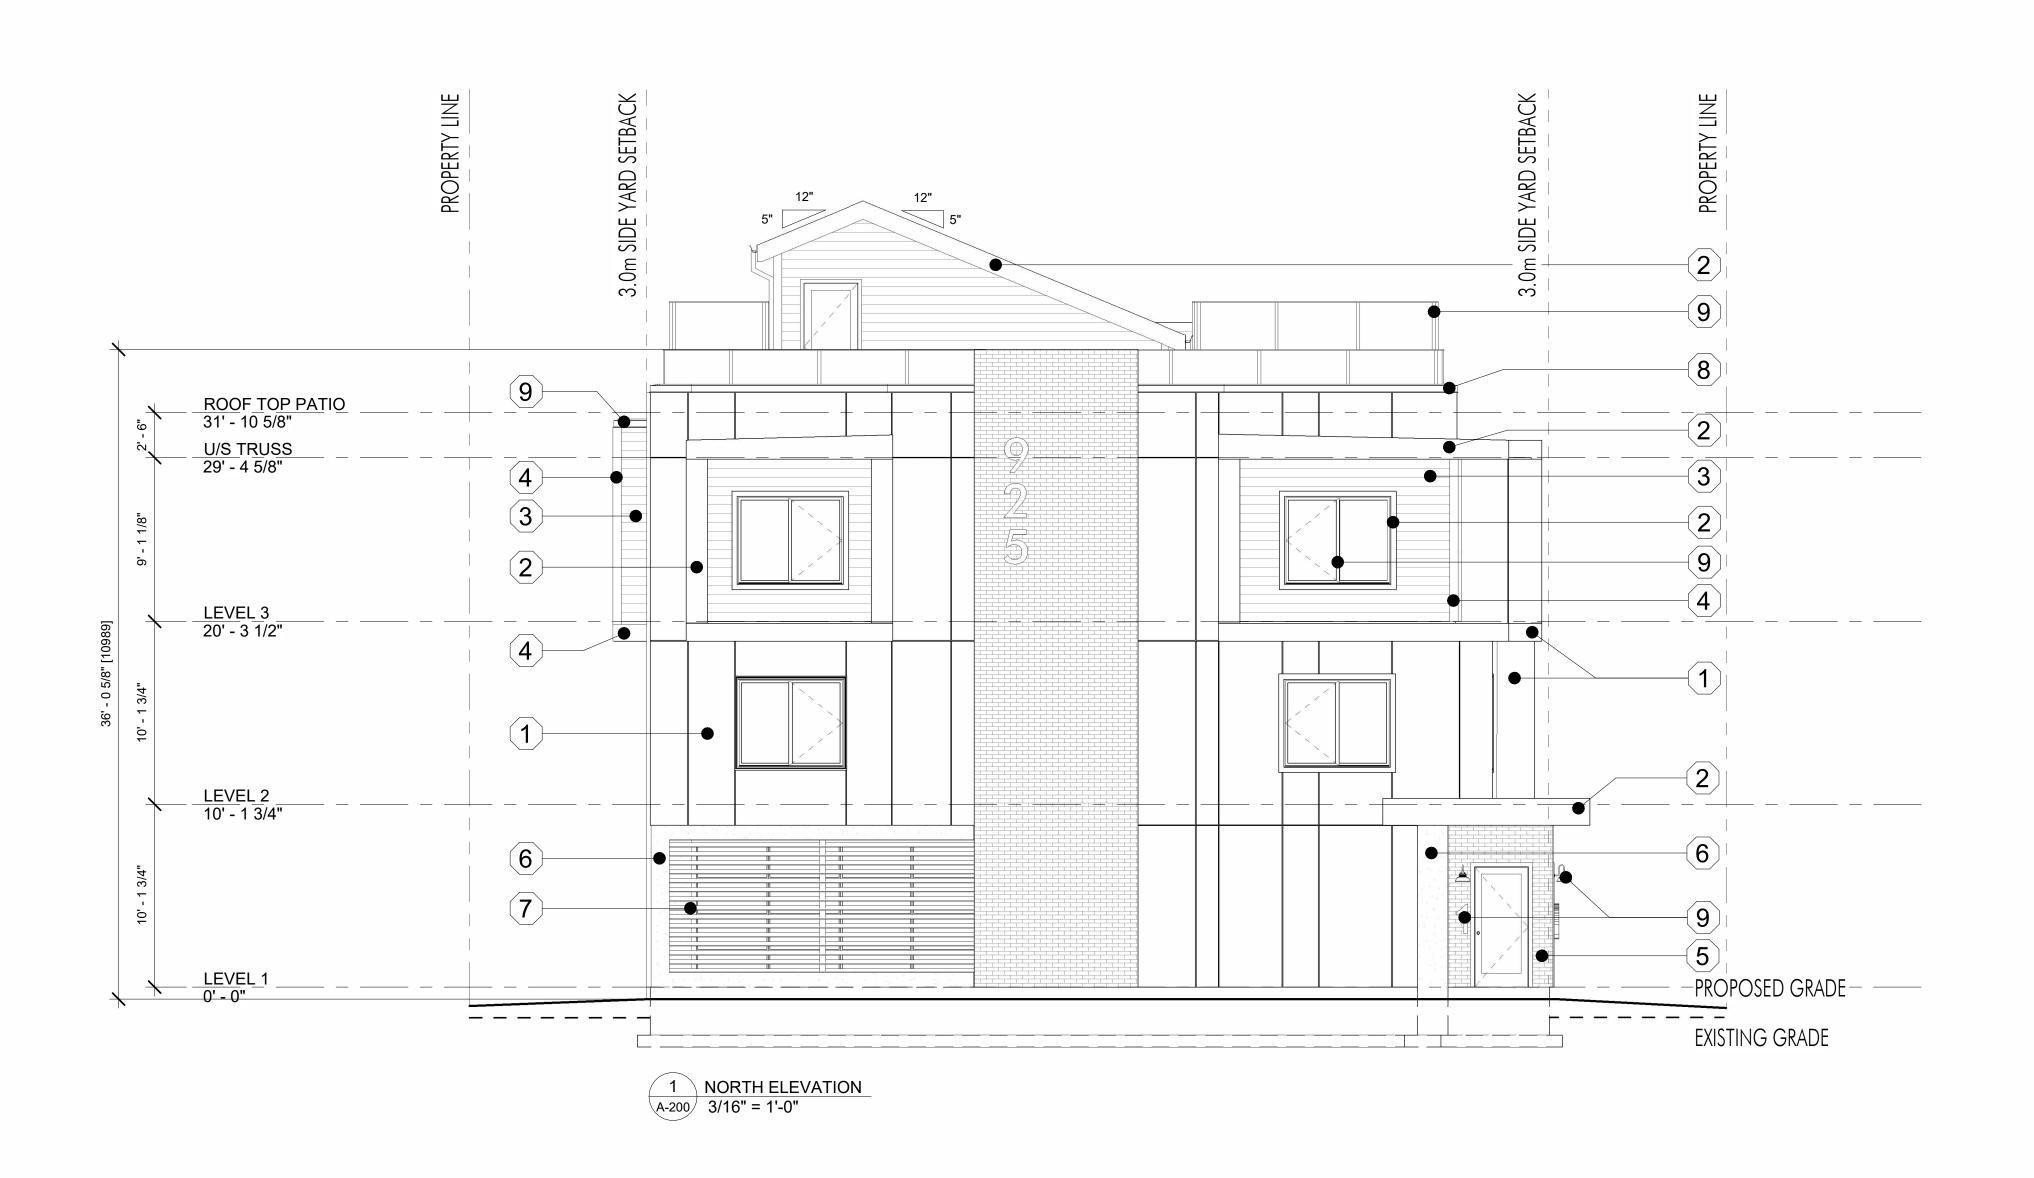
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Drawing No.











# IMAGE MATERIAL PANEL SIDING & FASCIAS: JAMES HARDI, ARCTIC WHITE PANEL SIDING, TRIM, & FASCIAS: JAMES HARDI, MIDNIGHT BLACK HORIZONTAL SIDING: JAMES HARDI, GRAY SLATE JAMES HARDI, GRAY SLATE BRICK: SIRENIS, ICY GREY CONCRETE: SEALED, SMOOTH FINISH HORIZONTAL PRIVACY SLATS: LUX, CYPRESS FLASHINGS & RWLs: WHITE ALUMINIUM DOORS, WINDOWS, RAILINGS, SOFFITS, GUTTERS, RWLS, LIGHTS, & UNIT #'s: BLACK ALUMINIUM TORCH-ON ROOFING: IKO, CHARCOAL GREY ASPHALT SHINGLE ROOFING:

IKO, HARVARD SLATE

EXTERIOR FINISHES

Plot Date 2023-11-16 11:30:34 AM PROJECT

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925 LAURIER AVENUE

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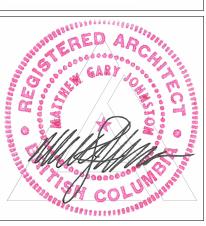
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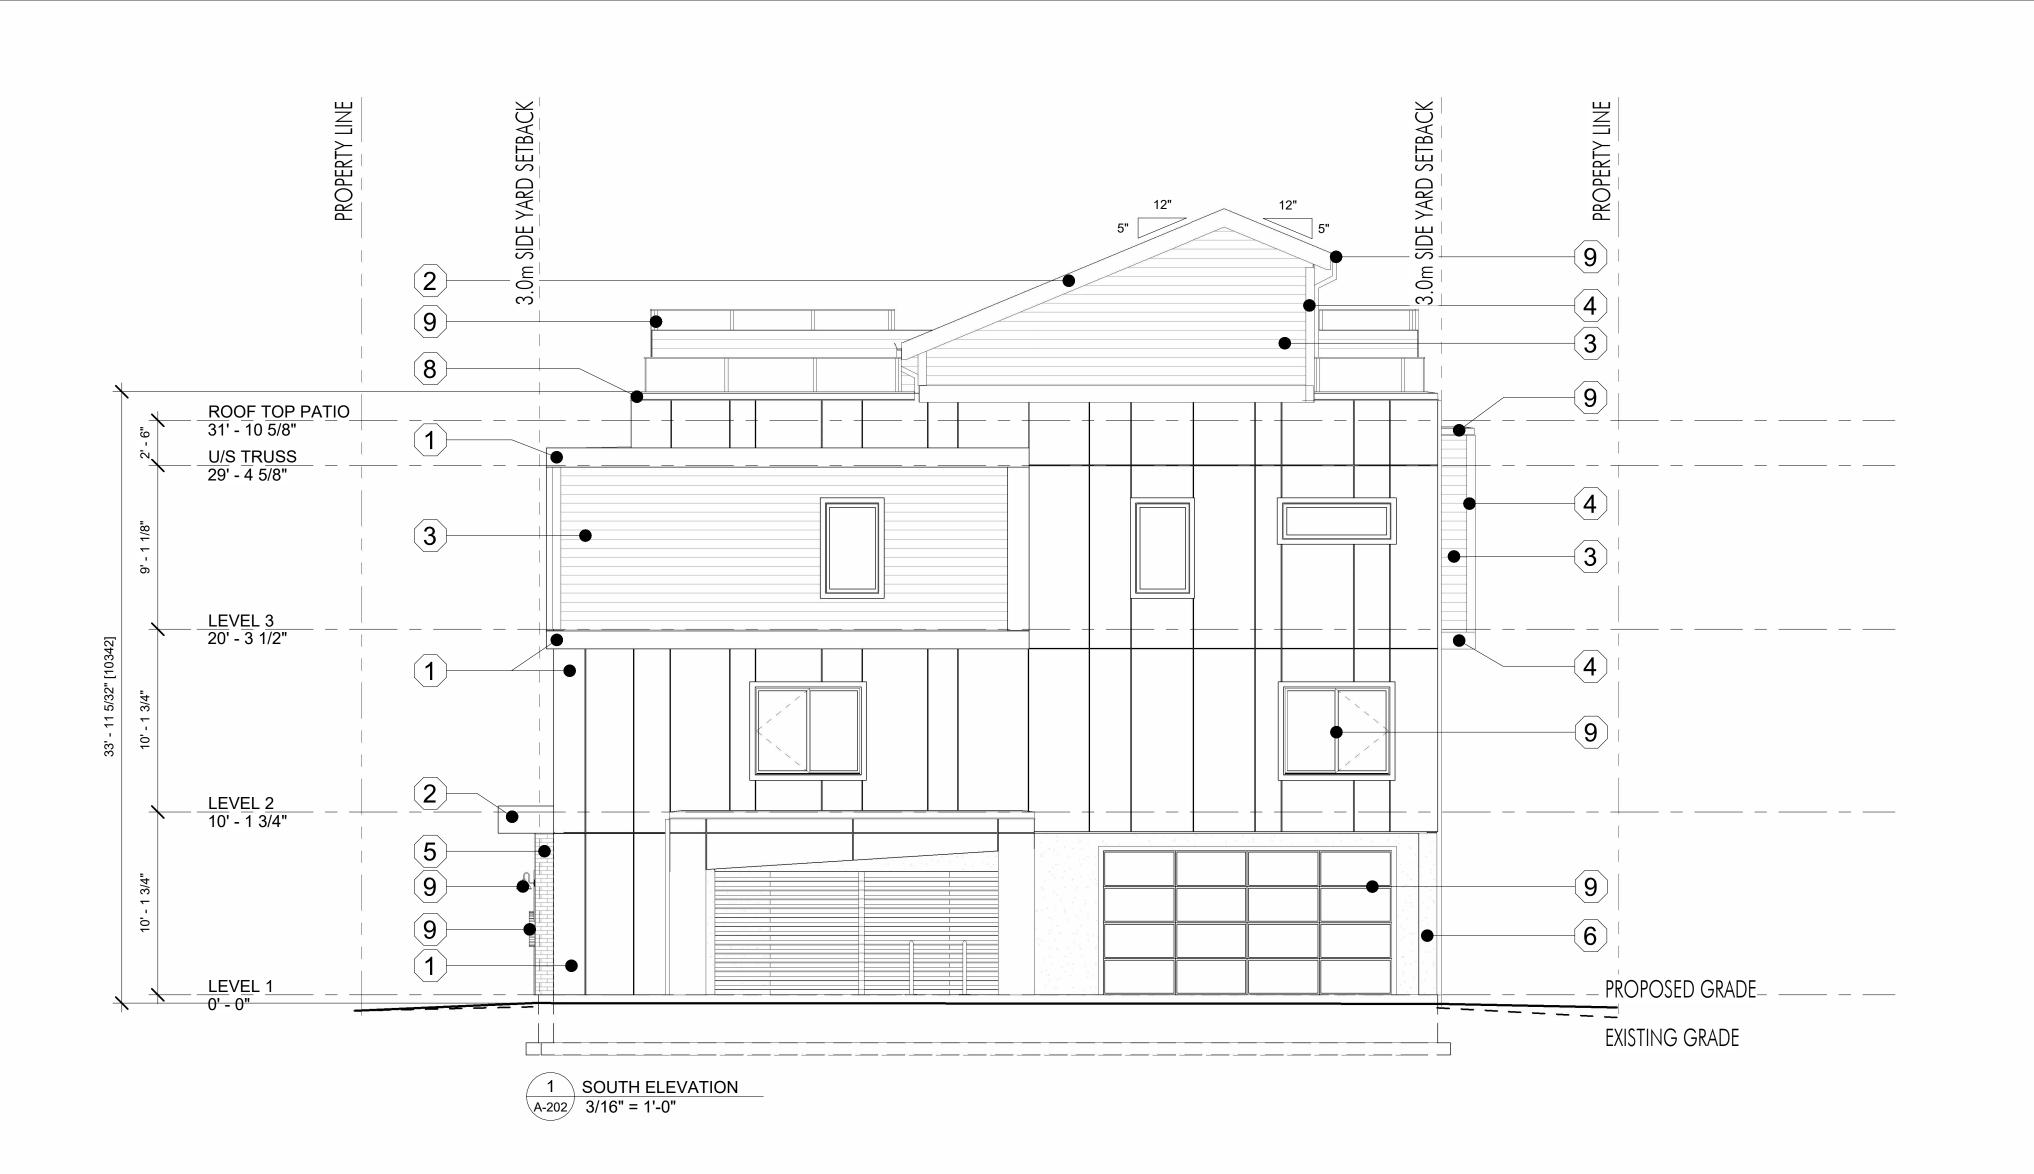
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2023-11-16 11:30:38 AM

925 LAURIER AVENUE DRAWING TITLE

ELEVATIONS







#	IMAGE	MATERIAL		
1		PANEL SIDING & FASCIAS: JAMES HARDI, ARCTIC WHITE		
2		PANEL SIDING, TRIM, & FASCIAS: JAMES HARDI, MIDNIGHT BLACK		
3		HORIZONTAL SIDING: JAMES HARDI, GRAY SLATE		
4		TRIM: JAMES HARDI, GRAY SLATE		
5		BRICK: SIRENIS, ICY GREY		
6		CONCRETE: SEALED, SMOOTH FINISH		
7		HORIZONTAL PRIVACY SLATS: LUX, CYPRESS		
8		FLASHINGS & RWLs: WHITE ALUMINIUM		
9		DOORS, WINDOWS, RAILINGS, SOFFITS, GUTTERS, RWLS, LIGHTS, & UNIT #'s: BLACK ALUMINIUM		
10		TORCH-ON ROOFING: IKO, CHARCOAL GREY		
11		ASPHALT SHINGLE ROOFING: IKO, HARVARD SLATE		

Plot Date 2023-11-16 11:30:42 AM PROJECT

PHONE:250-448-7801

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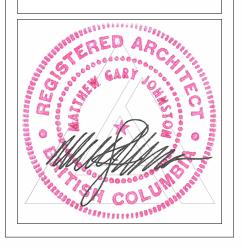
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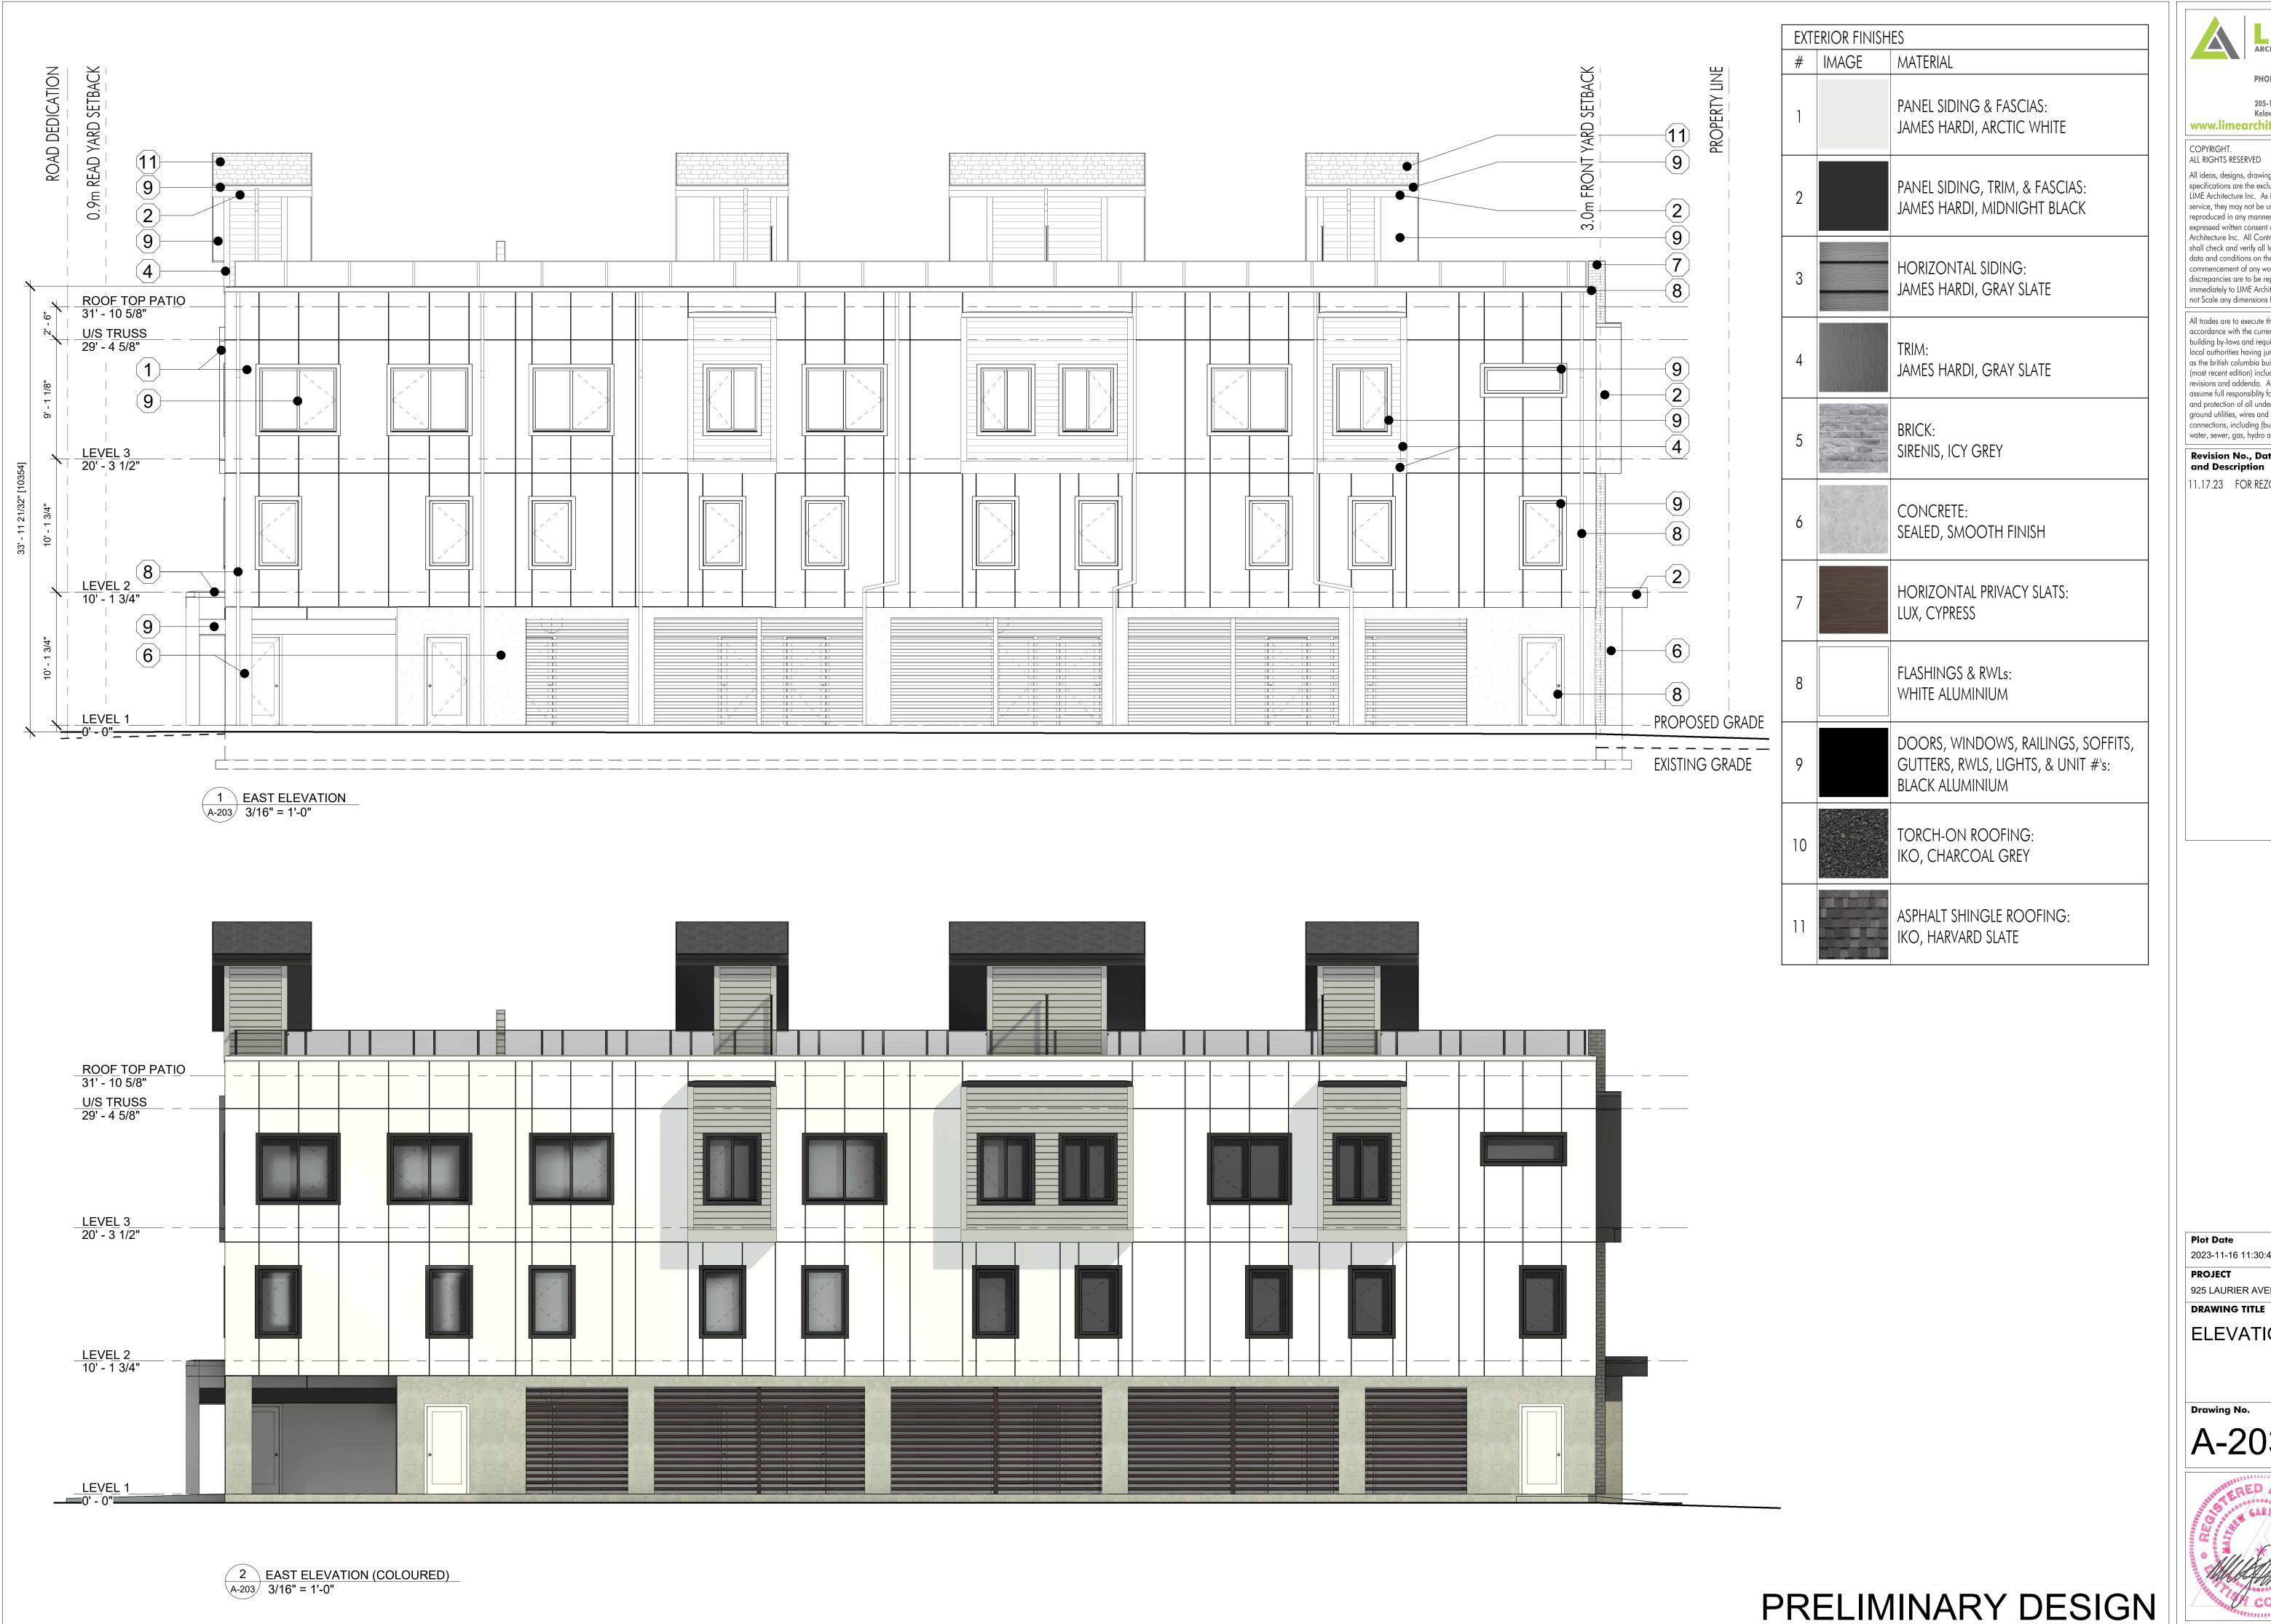
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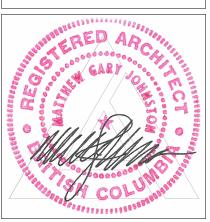
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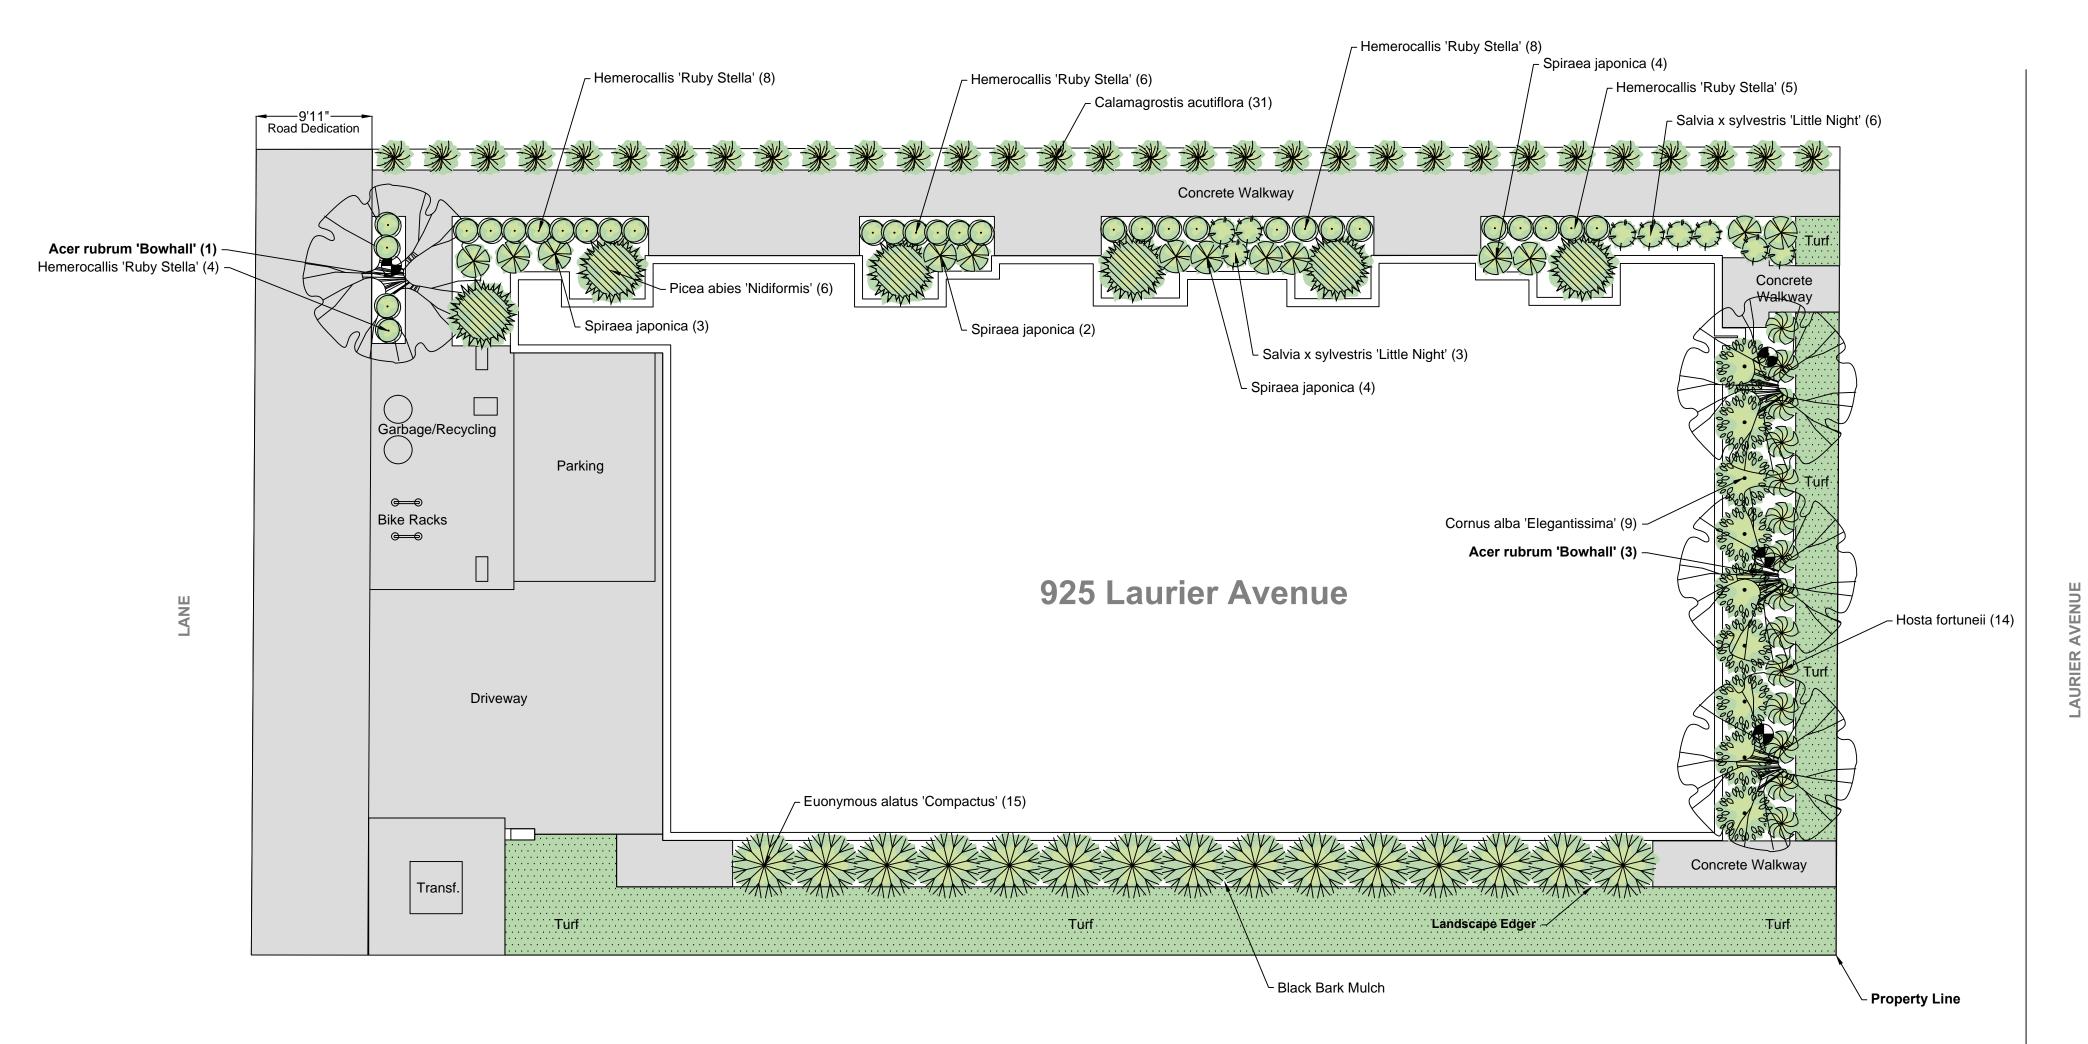
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ELEVATIONS






Plant List
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Qty	Botanical	Common	Size	Notes:
4 9 6 15 31 13 9 31 14	Acer rubrum 'Bowhall' Cornus alba 'Elegantissima' Picea abies 'Nidiformis' Euonymous alatus 'Compactus' Calamagrostis acutiflora Spiraea japonica Salvia x sylvestris Hemerocallis 'Ruby Stella' Hosta fortuneii 'Patriot'	'Bowhall' Red Maple Variegated Dogwood Nest Spruce Dwarf Burning Bush Foerster's Feather Reed Grass Double Play Red Spirea May Night Salvia Ruby Stella Dwarf Daylily Patriot Hosta	5cm Cal Min. #2 #2 #2 #1 #1 #1	<ol> <li>Planting beds to be dressed with Black Bark Mulch and have a landscape fabric underlay for weed prevention.</li> <li>Site to be watered with a fully automated irrigation system.</li> <li>Landscape lighting to be low voltage.</li> <li>All structures to have positive drainage.</li> <li>All materials and methods to conform to the Canadian Landscape Standard.</li> <li>Plant material to be locally sourced.</li> <li>Landscape edger to be used wherever turf touches bark mulch.</li> </ol>

4 Low Voltage Landscape Lighting



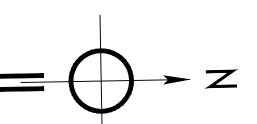

## Pre-Development Tree Inventory & Assessment

Client Name:	Push Sidhu
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**Site Address:** 925 Laurier Ave, Kelowna BC

#### **Tree List**

Trees	Common Name	Scientific Name	DBH	Comments
1	Pyramid Cedars	Thuja occidentalis "Fastigiata"	12.42cm-largest stem	Location:Multi stem type cedar in a hedge row at the front of the property, previous topping cuts
2	Black Locust	Robina pseudoacacia		Location: back fence line at back right corner of detached garage. Decay column in main stem, 30% die back in canopy.
3	Norway Maple	Acer platanoides	n/a	Location: on neighbours property - back right corner of the property. May be effected by development activities.
4	Norway Maple	Acer platanoides		Location: On neighbours property on back fence line - back left corner of property. May be effected by development activities.

