Development Permit & Rezoning Rationale 1200 Pacific Avenue — Kelowna BC



July 7, 2025



PROPOSAL

This application is for rezoning and a development permit facilitate the development of the subject property into a rental mid-rise buildings under the UC2r zone. With 157 units in total, this urban center development will add to the diversity of housing options within the Capri-Landmark area.



Figure 1: Site location.

POLICY CONTEXT

This site consists of a single parcel designated as Urban Centre (UC) in the City's OCP and appropriately zoned Capri-Landmark Urban Centre (UC2). The site is located in the 12 storey height designation, with a street character designation of "mixed residential street".







DESIGN CONCEPT

This proposal consists of a 20 storey rental apartment building with 157 homes in total. Parking will be provided entirely within the building over the course of 5 levels, one of which is below grade. Landscaping is tastefully designed along Pacific Ave to interface with the street standard intended within the Capri Landmark Urban Centre Plan, with additional landscaping on the amenity spaces on the podium and rooftop levels.


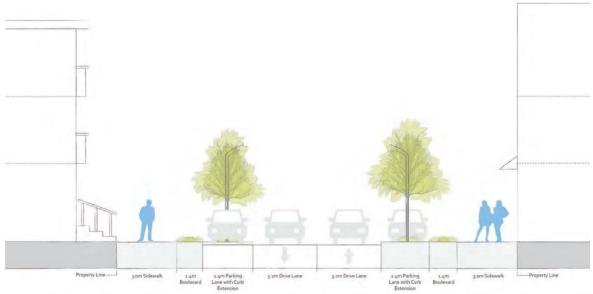


Figure 4: Pacific Ave Street Standard—Capri Landmark Urban Centre Plan.



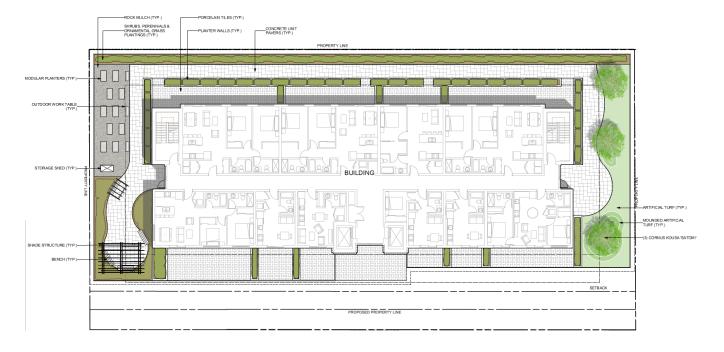

DESIGN CONCEPT (cont.)

This mid-rise building has a distinctly residential personality. The massing is segmented vertically as well as horizontally into components that harmonize through materials, architectural details and color tones. The base is personalized with street-fronting townhomes with over height windows. The middle of the building has apartments with balconies projecting from each corner. The vertical spine along the Pacific Avenue facade follows the elevator with glazed lobbies on each floor. The top of the building is multi leveled with larger apartments, and amenity space that deconstructs the boundary between the building and the sky.







HEIGHT VARIANCE

The proposed development is located within a key height transition area between the proposed 26-storey Capri Mall redevelopment and the existing 6-storey low-rise residential buildings along Mill Creek. The site is designated for a 12-storey height under the current policy framework, with an allowance of up to 15 storeys through bonusing provisions.

This application seeks a 5-storey (and 9.7m) height variance that remains consistent with the broader planning intent for this area as a transition zone. The proposed building massing has been carefully designed with stepbacks above 16 metres to reduce visual impact and provide more sensitive transition to adjacent properties. These include a significant stepback on the podium and upper-level stepback at the rooftop amenity level, further articulating the building form and reducing perceived height and bulk from the public realm and neighbouring sites.

CONCLUSION

This project offers significant housing density, ample parking and private open space within the core of the Capri/Landmark Urban Centre. The design has honored the OCP Guidelines, and the massing is sensitive to the present and future context of the established and evolving urban pattern. The provision of a significant number of dedicated rental dwellings is a strong contribution to this presently underserved housing need. It offers the right development, in the right location, and is compliant with the growth planning expectations delivered with attractive aesthetics. We seek support from the Council for the Development Permit for this purpose-built rental project.

PACIFIC UC2

ISSUED FOR DP, 25-07-07



ARCHITECTURAL

NEW TOWN ARCHITECTURE & ENGINEERING
300-1650 BERTAM STREET
KELOWNA, BC VIV 264
e: usman@newtownservices.net t: (250) 860

t: (250) 860-8185

CIVIL ENGINEERING
PROTECH CONSULTING
300 - 3275 LAKESHORE ROAD
KELOWNA, BC VIW 359
e: djames@protech-consulting.com t: (250) 860-1771

LANDSCAPE

CTQ CONSULTANTS LTD.
1334 ST. PAUL STREET
KELOWNA, BC VIY2EI
e: BDouglas@ctqconsultants.ca t: (250) 488-5367







COVER PAGE



ZONING ANALYSIS

EXISTING: RU6 - TWO DWELLING HOUSING

UC2 ZONING REQUIREMENTS

DEVELOPMENT REQUIREMENTS

6.0m 4.0m

-29 (145 x 0.2 (2090) = 29)

TOTAL (REQUIRED) TOTAL (PROVIDED) 124 STALLS 126 STALLS

SPECIALTY STALLS (INCLUDED IN TOTAL PROVIDED STALLS) DRIVE AISLE (WIDTH) DRIVE AISLE GRADE

SHORT TERM BIKE STALLS (PER ENTRANCE):

END OF TRIP FACILITY WASH & REPAIR STATION

UNIT SCHEDULE UNIT SCHEDULE LEVEL 10
UNIT A
UNIT A
UNIT A
UNIT A
UNIT B
UNIT C
UNIT C
UNIT D
UNIT D
UNIT D2
UNIT D2
UNIT D2
UNIT D2
UNIT D2
UNIT D2
UNIT D2 81.57 m² 81.67 m² 81.6 m² 53.01 m² 26.45 m² 32.89 m² 56.23 m² 26.48 m² Redundar LEVEL 5
UNIT A
UNIT A2
UNIT A3
UNIT B
UNIT C
UNIT C
UNIT D2
UNIT D2
UNIT D3
LEVEL 5 LEVEL 11
UNIT A
UNIT A
UNIT A
UNIT A
UNIT C
UNIT C LEVEL 6
UNIT A
UNIT A2
UNIT A3
UNIT B
UNIT C
UNIT C 2 BED 1 BED 81,54 m² 82,37 m² 79,81 m² 66,67 m² 53,01 m² 56,23 m² 32,59 m² 26,45 m² 28,92 m² UNIT A
UNIT A
UNIT A
UNIT A
UNIT A
UNIT C
UN 81,57 m* 82,52 m* 86,67 m* 81,6 m* 53,01 m* 28,92 m* 32,89 m* 56,23 m* Redundar 26,48 m* LEVEL 13
UNIT A
UNIT A
UNIT A
UNIT A2
UNIT B
UNIT C
UNIT D
UNIT D
UNIT D2
UNIT D2
UNIT D2
LEVEL 13: 10 81.57 m⁴ 82.52 m⁴ 68.67 m³ 81.6 m³ 53.01 m³ 26.45 m⁴ 32.89 m³ 26.48 m⁴ 76.23 m³ Redundan UNIT A
UNIT A
UNIT A
UNIT A
UNIT A
UNIT B
UNIT C
UNIT D
UNIT D2
UNIT D3 LEVEL 14
UNIT A
UNIT A
UNIT A
UNIT A
UNIT A2
UNIT B
UNIT C
UNIT D
UNIT D2
UNIT D2 82.52 m² 2 8ED 81.57 m² 2 8ED 86.97 m² 2 8ED 81.9 m² 2 8ED 53.01 m² 2 8ED 28.45 m² 2 8ED 52.28 m² 1 8ED 56.23 m² STUDD J BACHELOR Redundant Room STUDD J BACHELOR Redundant Room

CDOCC DUIL DING



UNIT SCHEDULE

82.52 m* 81.57 m* 68.67 m* 81.6 m* 53.01 m* 26.45 m* 32.89 m* 56.23 m* 26.48 m* Redundant

LEVEL 15
UNIT A
UNIT A
UNIT A
UNIT A
UNIT A2
UNIT B
UNIT C
UNIT D
UNIT D
UNIT D
UNIT D2







FAR SCHEDULE		GROSS	BUILDIN	
AREA (m2) AREA (ft2)		AREA (m2)	AREA	
LEVEL 1		LEVEL 1		
278 95 m²	3002.7 ft*	1188.86 m*	12796,8 ft*	
2100011	0002.7 H	110020111	1210000 8	
LEVEL 5		LEVEL 5		
554.27 m²	5966.15 ft ^o	749.65 m³	9369.13 ft ²	
LEVEL 6		LEVEL 6		
554.76 m²	5971.37 tr	749.62 m ⁺	9068,89 ft*	
EVEL 7		LEVEL 7		
554.76 m²	5971,37 tP	749,62 m²	8068-89 ft*	
LEVEL 8		LEVEL B		
554.76 m²	5971.37 ft ^a	749.62 m ^x	9368.89 ft ^a	
LEVEL 9		LEVEL 9		
554,76 m²	5971,37 th	749.62 m°	8068,89 ft*	
LEVEL 10		LEVEL 10		
554.76 m²	5971.37 ft ^p	749.62 m ¹	9368.89 ft ^o	
LEVEL 11		LEVEL 11		
554,76 m²	5971,37 tr	749.62 m*	9068,89 ft*	
LEVEL 12		LEVEL 12		
554.76 m²	5971.37 tP	749.62 m²	9068,89 ft ^a	
LEVEL 13		LEVEL 13		
554.76 m²	5971,37 ft*	749.62 m*	9068.89 ft*	
LEVEL 14		LEVEL 14		
554.76 m²	5971.37 to	749.62 m³	9368,89 ft ^a	
EVEL 15		LEVEL 15		
554.76 m²	5971,37 tr	749.62 m²	9068,89 ft*	
			,	
LEVEL 16		LEVEL 16		
554.76 m²	5971.37 to	749.62 m³	9368.89 ft ²	
LEVEL 17		LEVEL 17		
554.76 m*	5971.37 tr	749.62 m*	9368,89 ft*	
LEVEL 18		LEVEL 18		
554 76 m²	5971 37 tP	749 62 m²	8068 89 ft*	
	1007.7,07.10	- may, and 111		
LEVEL 19		LEVEL 19		
554.76 m²	5971.37 tr	749.62 m*	9068.89 ft*	
EVEL 20		LEVEL 20		
107,66 m²	3311,64 12	491,97 m²	5295,55 ft*	
8907.51 m²	95879 84 82	12925 22 m²	139125 88 6	

	RMS	
	REQUIRED:	PROPOSED:
GROUND ORIENTED:		
REDUCED SETBACK MAX: 1st FLOOR HEIGHT MIN: 1st FLOOR AREA	2.0m 12m (I STOREYS) II.0m²	3.9m 0.0m (0 STOREYS) 82.0m ²
URBAN & VILLAGE CENTRE (14.10):		
UPPER FLOOR SETBACK ABUTTING STREET URBAN PLAZA	30m N	3.0m N
MAX, SITE COVERAGE BASED ON STREET TYPE (6) 100% RESIDENTIAL	IOON RESIDENTIAL
MAX, PARKADE EXPOSURE (%)		
TALL BUILDINGS (9.11):	C%	0%
MIN. AMOUNT OF TRANS ON IS! FLOOR MIN DEPTH OF COMM UNIT FRONTING ST. TRIANGULAR SETBACK MAX. PODIUM HEIGHT PODIUM ROOFTOP BUILDING SEPARATION (FROM ANOTHER TOWER	75% COMMERCIAL FRONTAGE 6m 4.5m 18.0m (4 STOREYS) NO OPEN PARKING 1) 30.0m	N/A N/A N/A 15.4m (4 STOREYS) LANDSCAPE / DECI
MAX. FLOOR PLATE GFA: PODIUM RESIDENTIAL (ABOVE 6th FLOOR)	N/A 750.0m²	1568.27m² 747.38m²
TOWER STEPBACK BARRIER FREE ACCESSIBILITY	30m MAIN SES & ALL COMMON ENTRANCES	3.0m



1200 PACIFIC


NEW TOWN ARCHITECTURE + ENGINEERING ARCHITECTURE | URBAN PLANNNG | CIVIL ENGINEERING





ZONING & **BYLAW**

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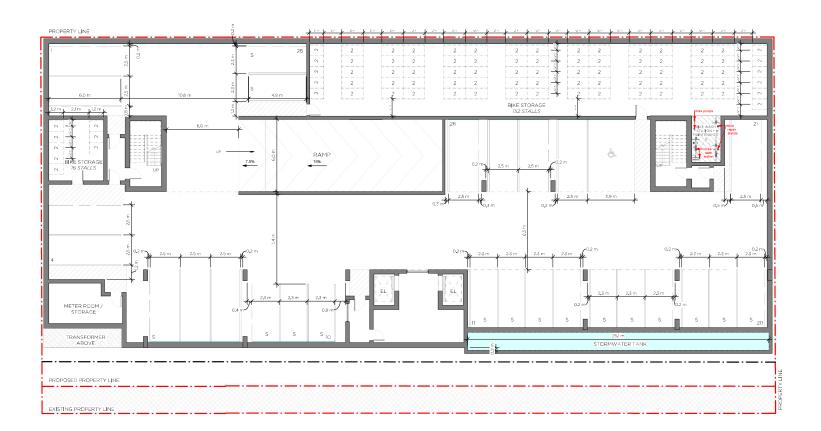


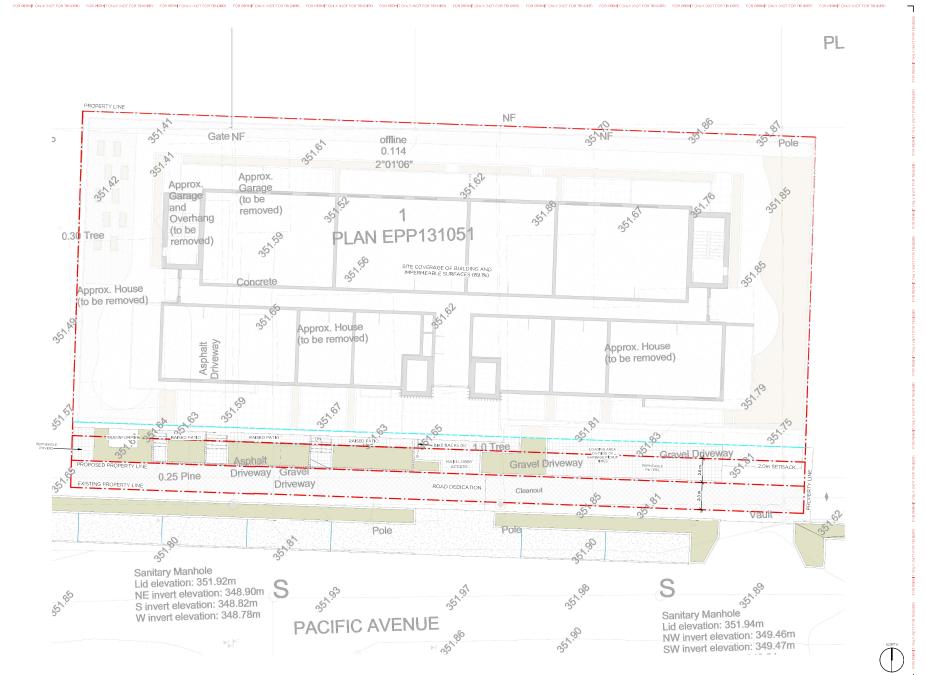



SITE PLAN





TOO, 8 TOO PACHIC AVENUE, RELOWNA


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PARKADE 0 FLOOR PLAN

4191

scale designed drawn checked 8" = 7-0" JM/LA JM/LA UA



PACIFIC AVENUE

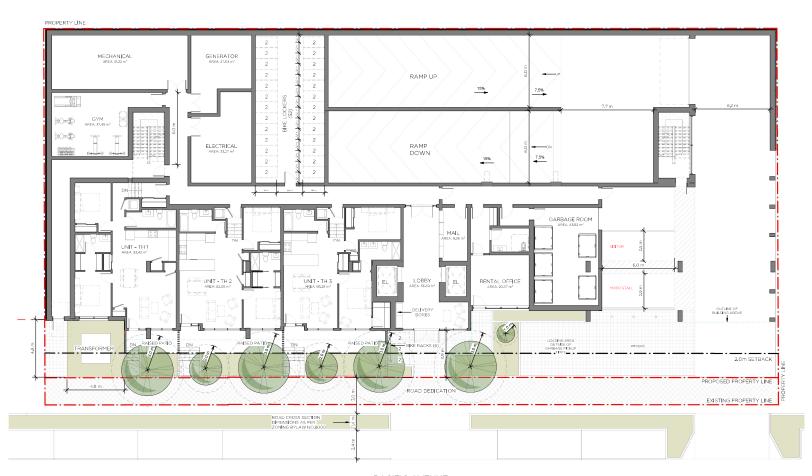

1200 PACIFIC

III, 1200, a 200 PACIFIC MELOWNA

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LEVEL 1 FLOOR PLAN

2025 07 07 4 77 25 0



PACIFIC AVENUE



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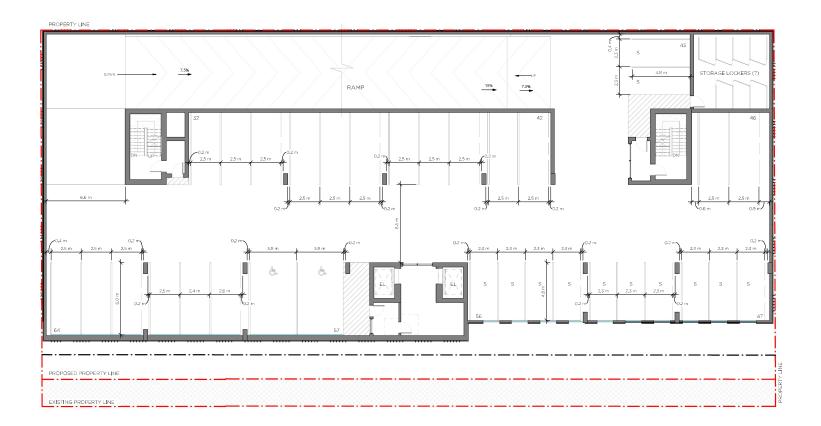
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PARKADE 2

FLOOR PLAN

4191

O' JM/LA JM/LA UA




00 PACIFIC

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4191 scale designed drawn chec

NORTH



200, 8 IZO PACIFIC AVENUE, KELOWNA
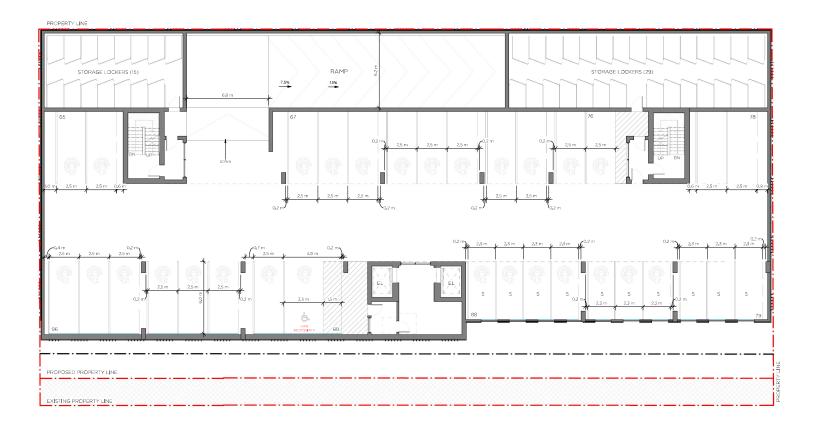
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PARKADE 4 FLOOR PLAN

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D' JEVLA JEVLA

NORTH LINE NORTH

A3.05D

LEVEL 5 FLOOR PLAN

4191
scale designed drawn chec



A3.06D

LEVELS 6 -19 FLOOR PLANS



200 PACIFIC

A3.07D

LEVEL 20 FLOOR PLAN

scale designed drawn check 1/8" = T-0" JM/LA JM/LA UA

NORTH

4.0m SETBACK MECHANICAL ENCLOSURE ELEVATOR OVERRUN PROPOSED PROPERTY LINE



A3.10D



ARCHITECTURAL CONCRETE WITH ELASTOMERIC COATING - WHITE (#2)



SMOOTH STUCCO - CHARCOAL (#3)



BOX RIB METAL SIDING - WOOD FINISH (#5)



ALUMINUM CORRUGATED PANELS - CHARCOAL (#6)



ALUMINUM RAILING - BLACK (#7)



SAMPLE FOR COLOUR PURPOSES ONLY

FOR FERMIT ONLY (NOT FOR TENDER) FOR FERMIT ONLY (NOT FOR TENDER)





BALCONY SLIDING DOOR - BLACK (#10)




GROUND ANCHORED BIKE PARKING



PARKADE MESH SCREEN - (#19)



MATERIALS

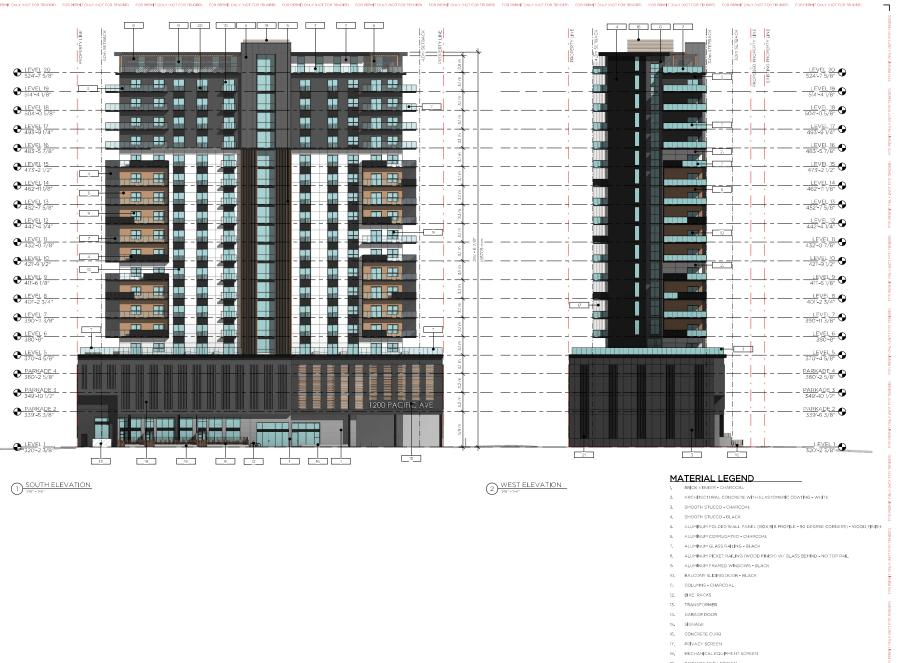

1200 PACIFIC

184 T74 Z00 & Z10 PACHE KELOWIA

184 T74 Z00 & Z10 PACHE CAVENE KELOWIA

185 T74 Z00 & Z10 PACHE CTURE + ENGINEERING

ARCHITECTURE + ENGINEERING

No. DATE ISSUED FOR.



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BUILDING ELEVATIONS

A4.01D

4191

ALUMINIUM PICKET RAILING

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2006 07 07 479 79 D



ARCHITECTURAL CONCRETE WITH ELASTOMERIC COATING - WHITE

ALUMINUM FOLDED WALL PANEL (BOX RIB PROFILE - 90 DEGREE CORNERS) - WOOD FINISH

ALUMINUM GLASS RAILING - BLACK

ALUMINUM PICKET RAILING (WOOD FINISH) W/ GLASS BEHIND - NO TOP RAIL

17. PRIVACY SCREEN

18. MECHANICAL EQUIPMENT SCREEN

TOO & IZIO PACHEC AVENUE, RELOWAN

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BUILDING **ELEVATIONS**

A4.02D

4191

NEW TOWN ARCHITECTURE + ENGINEERING

PACIFIC TOWER

1200 PACIFIC AVENUE, KELOWNA, BC

LANDSCAPE WORKS - DEVELOPMENT PERMIT FOR REVIEW

NOT FOR CONSTRUCTION

JULY 3, 2025

LIST OF DRAWINGS

LDP 1.0: LANDSCAPE PLAN - LEVEL 1

LDP 1.1: LANDSCAPE PLAN - LEVEL 1 (OFF-SITE)

LDP 1.2: LANDSCAPE PLAN - LEVEL 5

LDP 1.3: LANDSCAPE PLAN - LEVEL 20

LDP 2.0: LANDSCAPE DETAILS

LDP 3.0: WATER CONSERVATION PLAN - LEVEL 1

LDP 3.1: WATER CONSERVATION PLAN - LEVEL 1 (OFF-SITE)

LDP 3.2: WATER CONSERVATION PLAN - LEVEL 5


LDP 3.3: WATER CONSERVATION PLAN - LEVEL 20


KEY PLAN 1:400



ZONING BYLAW SUMMARY

Landscape Bylaw 12375 (Table 7.2)	UC2 ZONE (1/10 LM)	Proposed	Compliance (Y/N)
Min. tree amount Landscape lin. m setback = 61/10 =7 trees (min.)		7 Trees	Υ
Min. deciduous tree Caliper: Calipe		4 large trees, 2 medium trees, and 1 small trees	Y
Min. coniferous tree height:	250cm	N/A	N/A
Min. ratio between tree size:	Large (L): Min. 50% Medium (M): No min. or max. Small (S): Max. 25%	Large (L): 4 = 57% Medium (M): 2 = 29% Small (S): 1 = 14%	Y
Min. growing medium (planted) area 0 x 75% = 0m2		Total planted area: 41m2	Υ*
Min. growing medium volumes per tree (L) Tree: Single: 20cu.m, Shared: 15cu.m (M) Tree: Single: 18cu.m, Shared: 12cu.m (S) Tree: Single: 15cu.m, Shared: 10cu.m		(L) Tree: 4 Shared: 15cu.m, (M) Tree: 2 Shared:12 cu.m, (S) Tree: 1 Shared:10 cu.m,	Υ*
Landscape graded areas (7.2.7)	Lawn: 33% max. Shrubs/groundcover: 50% max Cross slope: 2% min.	Lawn: 33% max. Shrubs/groundcover: 50% max Cross slope: 2% min.	Y
Fence height	2.0m max.	1.2	Υ
Riparian management area (Y/N)	No, development area not withi	n a riparian management zone	N/A
Existing tree retention (Y/N)	N		
Surface parking lot over 15 stalls (Y/N)	N		N/A
Refuse & recycle screeing (Y/N)	N		N/A
Comments	Notes: *Soil cells are added for all trees in the landscape area; no minimum softscape required.		

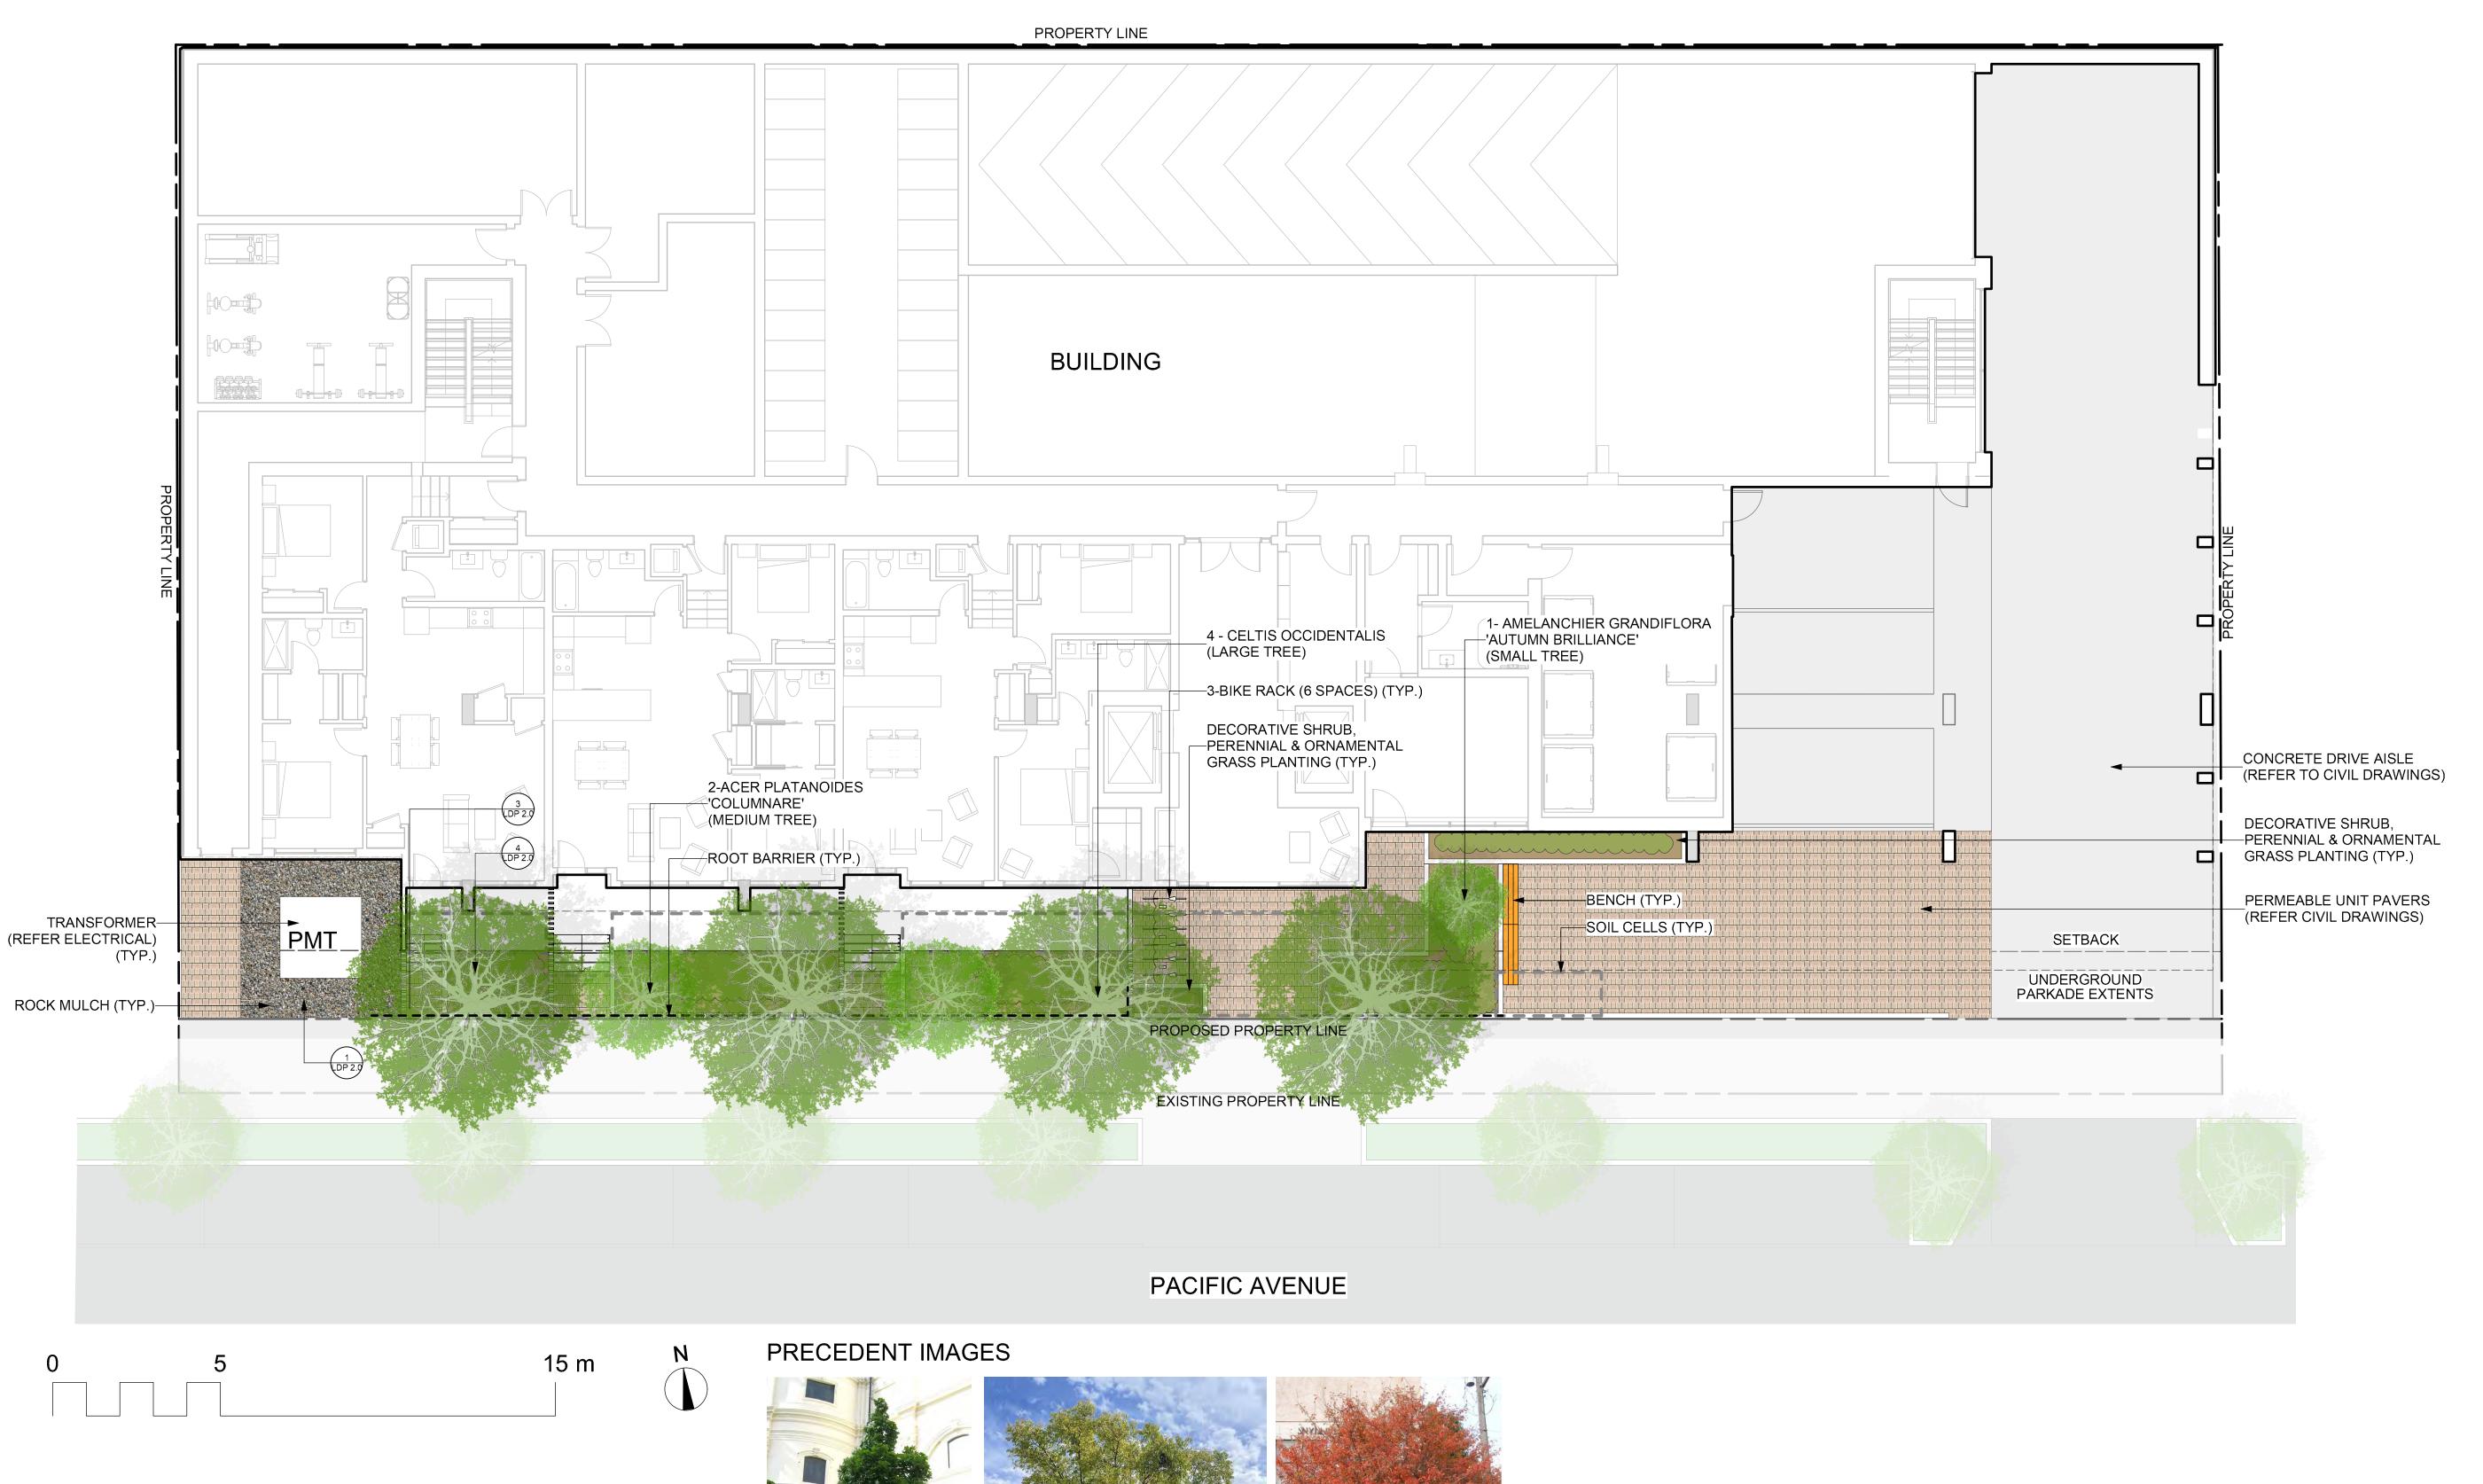

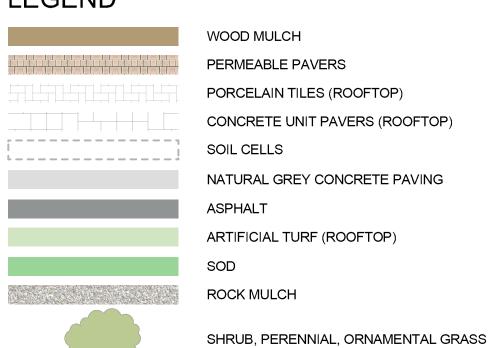



PLANT LIST:

QTY	BOTANICAL NAME	COMMON NAME	SIZE	ROOT	SPACING
	Trees Deciduous				
2	Acer platanoides 'Columnare'	Columnar Norway Maple	6cm Cal	B&B	5m o/c
1	Amelanchier grandiflora 'Autumn Brilliance'	Serviceberry	6cm Cal	B&B	6m o/c
4	Celtis occidentalis	Common Hackberry	6cm Cal	B&B	6m o/c
3	Cornus kousa 'Satomi'	Chinese Dogwood	6 cm Cal	B&B	4m o/c
	Shrubs				
56	Buxus 'Green Velvet'	Green Velvet Boxwood	#02	Potted	0.9m o/c
40	Cornus stolonifera 'Arctic Fire'	Arctic Fire Red Osier Dogwood	#02	Potted	1.2m o/c
20	Hydrangea arborescens 'Annabelle'	Annabelle Hydrangea	#02	Potted	1.5m o/c
40	Rhus aromatica 'Gro-Low'	Gro Low Fragrant Sumac	#02	Potted	1.8m o/c
	Ornamental Grasses				
23	Calamagrostis x acutiflora 'Karl Foerster'	Karl Forester Feather Reed Grass	#01	Potted	0.75m o/c
10	Deschampsia caespitosa 'Goldtau'	Gold Dew Tufted Hair Grass	#01	Potted	0.6m o/c
	Perennials				
15	Achillea filipendulina 'Gold Plate'	Gold Plate Yarrow	#01	Potted	0.6m o/c
15	Echinacea purpurea	Purple Coneflower	#01	Potted	0.6m o/c
30	Nepeta x faassenii 'Walker's Low'	Walker's Low Catmint	#01	Potted	0.6m o/c
10	Rudbeckia fulgida 'Goldstrum'	Goldstrum Black Eyed Susan	#01	Potted	0.6m o/c



ENGINEERING LANDSCAPE ARCHITECTURE URBAN PLANNING

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NOTES:

1. PLANT MATERIAL AND CONSTRUCTION
METHODS SHALL MEET OR EXCEED CANADIAN
LANDSCAPE STANDARDS. ALL OFFSITE
LANDSCAPE WORKS SHALL CONFORM WITH CITY
OF KELOWNA BYLAW 7900.

2. ALL SOFT LANDSCAPE AREAS SHALL BE WATERED BY A FULLY AUTOMATIC TIMED UNDERGROUND IRRIGATION SYSTEM.

3. TREE AND SHRUB BEDS TO BE DRESSED IN A MINIMUM 75mm NATURAL WOOD MULCH AS SHOWN IN PLANS. DO NOT PLACE WEED MAT UNDERNEATH TREE AND SHRUB BEDS.

4. SHRUB BEDS TO RECEIVE A MINIMUM 300mm DEPTH GROWING MEDIUM PLACEMENT. TREES TO RECEIVE A MINIMUM 1.0M DEPTH GROWING MEDIUM PLACEMENT. ALL TREES WITHIN THE LANDSCAPE BUFFER SHALL CONFORM WITH CITY OF KELOWNA LANDSCAPE BYLAW TABLE 7.2 REQUIREMENTS.


5. SITE GRADING AND DRAINAGE WILL ENSURE THAT ALL STRUCTURES HAVE POSITIVE DRAINAGE AND THAT NO WATER OR LOOSE IMPEDIMENTS WILL BE DISCHARGED FROM THE LOT ONTO ADJACENT PUBLIC, COMMON, OR PRIVATE PROPERTIES.

6. COMPLETED WORKS MUST MEET APPROVED DEVELOPMENT PERMIT DRAWINGS. AMENDMENT APPLICATION MUST BE MADE FOR ANY ALTERATIONS PRIOR TO WORKS BEING COMPLETED.

7. LANDSCAPE CONSTRUCTION DRAWINGS AND BCSLA SCHEDULE L IS REQUIRED AT TIME OF BUILDING PERMIT APPLICATION. MUST INCLUDE A WATER CONSERVATION REPORT IN ACCORDANCE WITH WATER REGULATION BYLAW NO. 10480 (AS AMENDED OR REPLACED FROM TIME TO TIME), INCLUDING A LANDSCAPE WATER BUDGET, A HYDROZONE PLAN AND AN IRRIGATION PLAN PREPARED BY A CERTIFIED IRRIGATION DESIGNER

SEAL



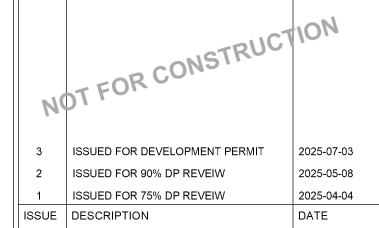

CLIENT NAM

NEW TOWN ARCHITECTURE + ENGINEERING

PROJECT NAME:

PACIFIC TOWER

DRAWING TITLE:

CONCEPTUAL LANDSCAPE

PLAN - GROUND FLOOR


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DRAWN: MM & EM

CHECKED: BD

PROJECT NO.: 24164-100





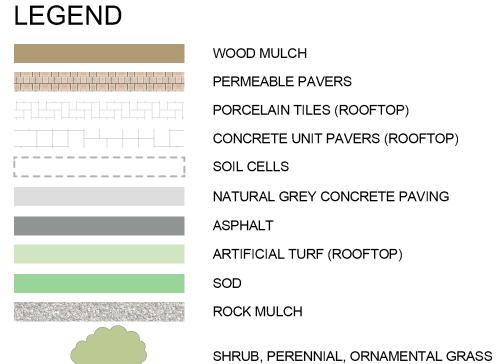

PLANT LIST:

QTY	BOTANICAL NAME	COMMON NAME	SIZE	ROOT	SPACING
	Trees Deciduous				
7	Syringa reticulata 'Ivory Silk'	Ivory Silk Tree Lilac	6cm Cal	B&B	8m x 6m



LANDSCAPE ARCHITECTURE URBAN PLANNING

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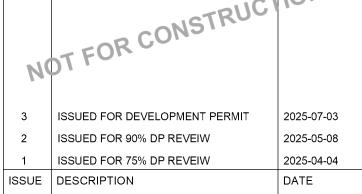
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SEAL






NEW TOWN ARCHITECTURE + ENGINEERING


PROJECT NAME:

PACIFIC TOWER

DRAWING TITLE: CONCEPTUAL LANDSCAPE PLAN - GROUND FLOOR (OFFSITE)

	,	
	DRAWN: MM & EM	DRAWING NO.:
	CHECKED: BD	I DD1
	PROJECT NO.: 24164-100	LDP1.
	SCALE.	

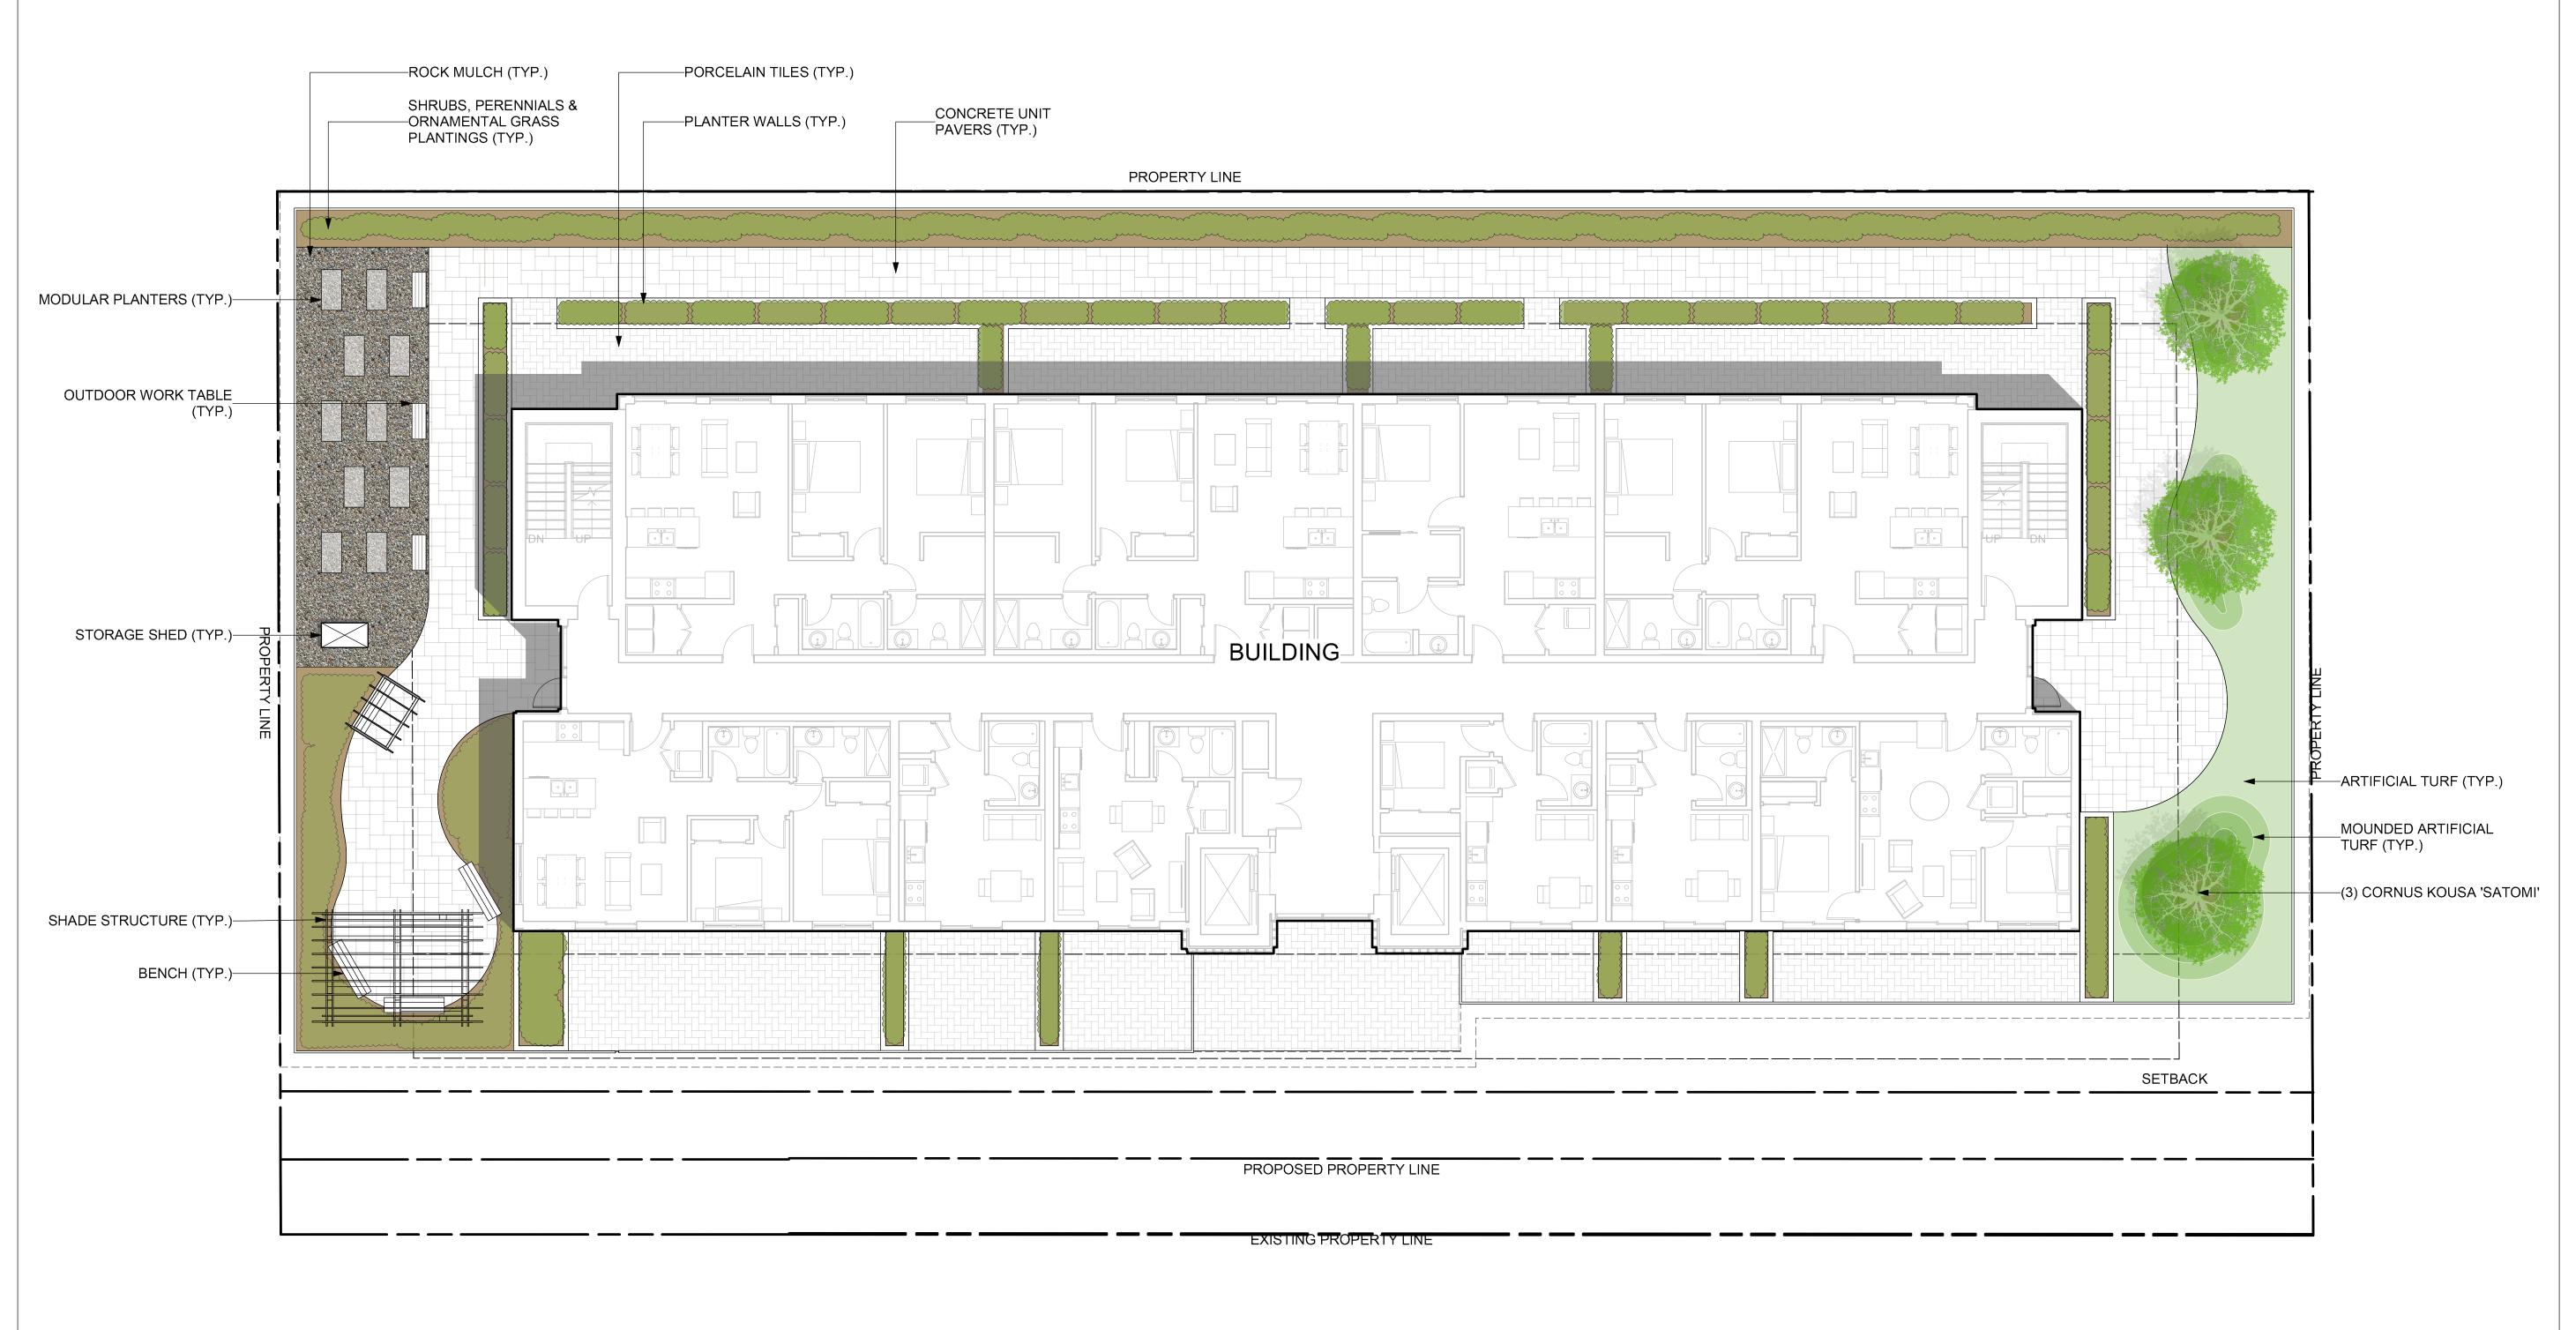

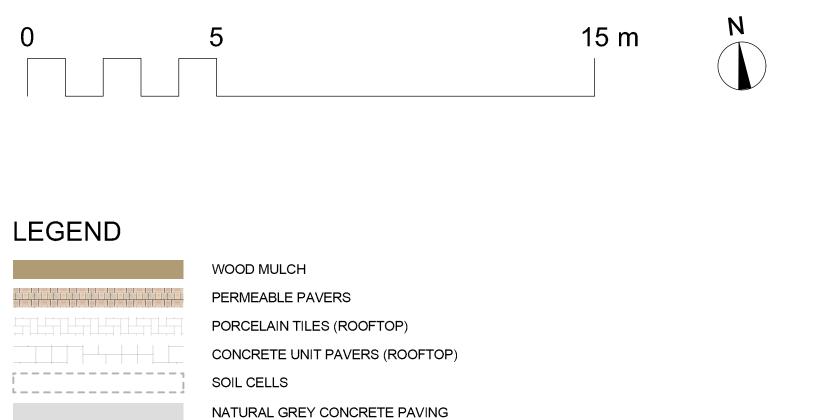

ARTIFICIAL TURF (ROOFTOP)

SHRUB, PERENNIAL, ORNAMENTAL GRASS

ROCK MULCH

PRECEDENT IMAGES



PLANT LIST:

QTY	BOTANICAL NAME	COMMON NAME	SIZE	ROOT	SPACING
	Trees Deciduous				
2	Acer platanoides 'Columnare'	Columnar Norway Maple	6cm Cal	B&B	5m o/c
1	Amelanchier grandiflora 'Autumn Brilliance'	Serviceberry	6cm Cal	B&B	6m o/c
4	Celtis occidentalis	Common Hackberry	6cm Cal	B&B	6m o/c
3	Cornus kousa 'Satomi'	Chinese Dogwood	6 cm Cal	B&B	4m o/c
	Shrubs				
56	Buxus 'Green Velvet'	Green Velvet Boxwood	#02	Potted	0.9m o/c
40	Cornus stolonifera 'Arctic Fire'	Arctic Fire Red Osier Dogwood	#02	Potted	1.2m o/c
20	Hydrangea arborescens 'Annabelle'	Annabelle Hydrangea	#02	Potted	1.5m o/c
40	Rhus aromatica 'Gro-Low'	Gro Low Fragrant Sumac	#02	Potted	1.8m o/c
	Ornamental Grasses				
23	Calamagrostis x acutiflora 'Karl Foerster'	Karl Forester Feather Reed Grass	#01	Potted	0.75m o/c
10	Deschampsia caespitosa 'Goldtau'	Gold Dew Tufted Hair Grass	#01	Potted	0.6m o/c
	Perennials				
15	Achillea filipendulina 'Gold Plate'	Gold Plate Yarrow	#01	Potted	0.6m o/c
15	Echinacea purpurea	Purple Coneflower	#01	Potted	0.6m o/c
30	Nepeta x faassenii 'Walker's Low'	Walker's Low Catmint	#01	Potted	0.6m o/c
10	Rudbeckia fulgida 'Goldstrum'	Goldstrum Black Eyed Susan	#01	Potted	0.6m o/c



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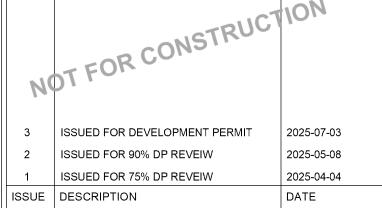
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SEAL






NEW TOWN ARCHITECTURE + ENGINEERING


PROJECT NAME:

PACIFIC TOWER

DRAWING TITLE: CONCEPTUAL LANDSCAPE PLAN - LEVEL 5

DRAWN: MM & EM	DRAWING NO.:
CHECKED: BD	
PROJECT NO.: 24164-100	

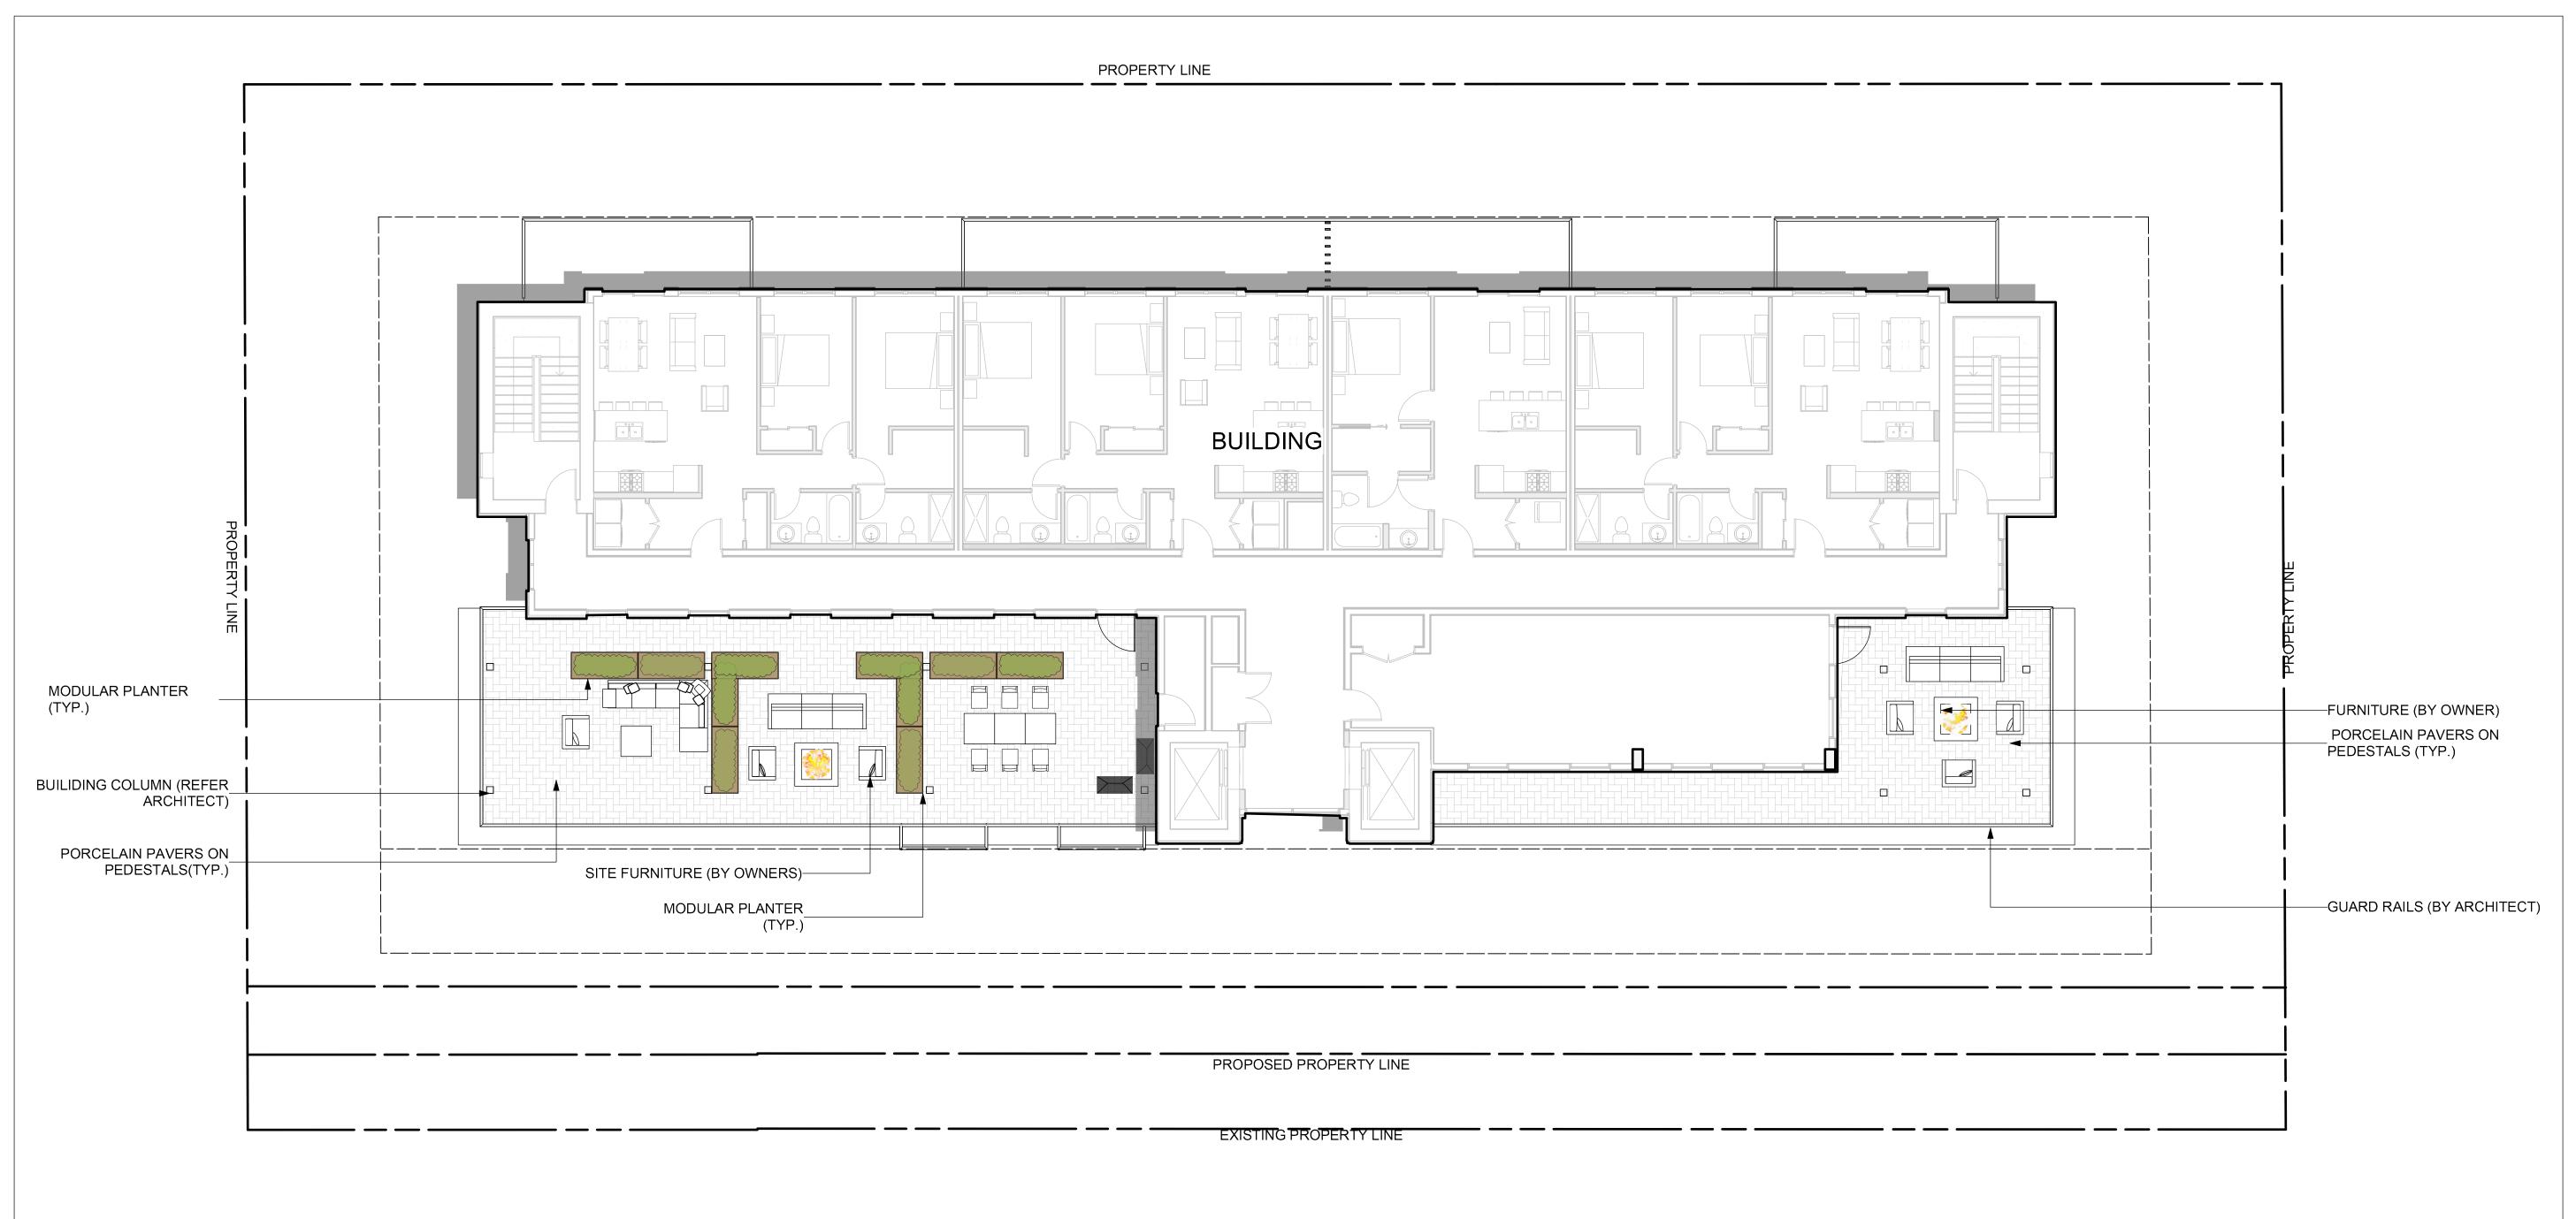

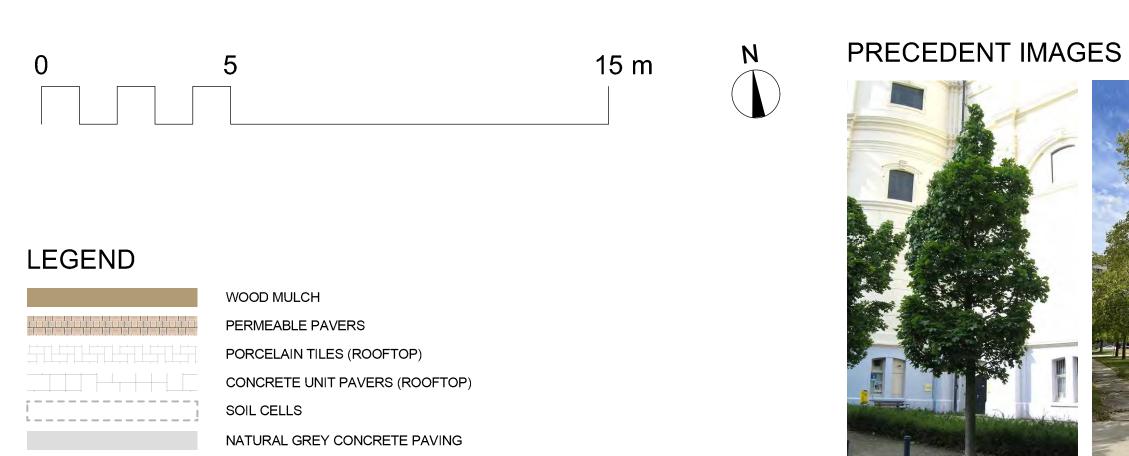

ARTIFICIAL TURF (ROOFTOP)

SHRUB, PERENNIAL, ORNAMENTAL GRASS

ROCK MULCH



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ENGINEERING LANDSCAPE ARCHITECTURE URBAN PLANNING

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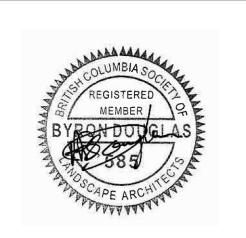
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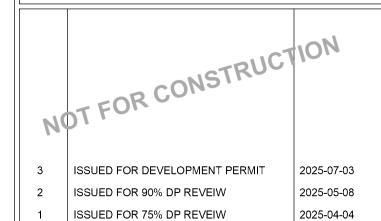
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SEAL





ISSUE DESCRIPTION

CLIENT NAME:

NEW TOWN ARCHITECTURE + ENGINEERING


PROJECT NAME:

PACIFIC TOWER

DRAWING TITLE:

CONCEPTUAL LANDSCAPE PLAN - LEVEL 20

DRAWN: MM & EM	DRAWING NO.:
CHECKED: BD	
PROJECT NO.: 24164-100	
SCALE: 1:100	

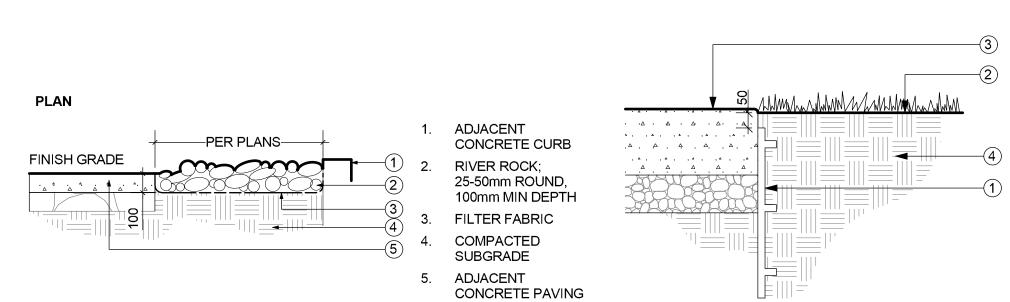

ROOT BARRIER; DEEP ROOT UB 18-2, 1.2m LENGTH, INSTALL AS PER MANUFACTURER'S RECOMMENDATIONS FINISH GRADE ADJACENT PAVING

SOIL BACKFILL


1. PRUNE DEAD & **BROKEN BRANCHES -**MAINTAIN NATURAL PLANT FORM 2. REMOVE CONTAINER

3. 75mm MIN. DEPTH WOOD MULCH (REFER SPECS)

4. FIRMLY COMPACTED EARTH SAUCER

5. FIRMLY PACKED **GROWING MEDIUM** (REFER SPECS)

6. FINISHED GRADE

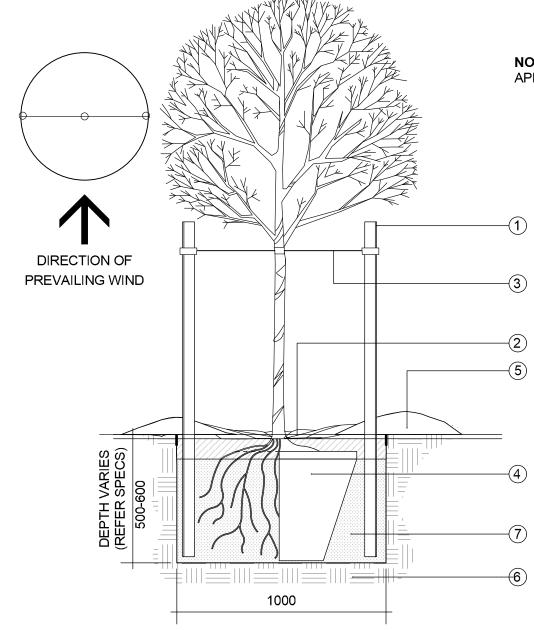

NOTE: IRRIGATION TO TREES AS PER APPROVED IRRIGATION PLAN

> CEDAR OR PRESSURE TREATED TIMBER STAKE - USE (2) 75MM DIA. X 2000mm HEIGHT STAKES. PLACÉ STAKE BEYOND THE EDGE OF THE ROOTBALL. ENSURE STAKES PENETRATE INTO A SOLID SUB-SOIL BASE. ORIENT STAKES TO BE PERPENDICULAR TO THE PREVAILING WIND.

75mm MIN. DEPTH EARTHEN SAUCER W/ MULCH, ROOTBALL/ TRUNK FLARE NOT TO BE BURIED W/ GROWING MEDIUM OR MULCH GUYWIRE - ATTACH NO. 11 GALVANIZED

WIRE TO TREE SLING STRAP, 20" WITH #4 GROMMET AROUND STEM ABOVE FIRST BRANCH (TYP. OF 2) CONTAINER GROWN SPECIMEN TREE

PLANTED IN CENTER OF TREE PIT; REMOVE CONTAINER WHEN PLANTING

75mm MIN. DEPTH MULCH

TREE PIT EXCAVATED TO SPECIFICATION AND FILLED WITH APPROVED TOPSOIL/COMPOST MIX, PER SPECS

FIRMLY COMPACTED GROWING MEDIUM (REFER SPECS.)

Rock Mulch - Section LDP 2 Scale: 1:20


Root Barrier - Section LDP 2 Scale: 1:10


Shrub in Mulch - Section LDP 2 Scale: NTS

PIT DIA. SHALL BE 2X

THAT OF THE CONTAINER

Tree in Mulch - Section LDP 2 Scale: NTS

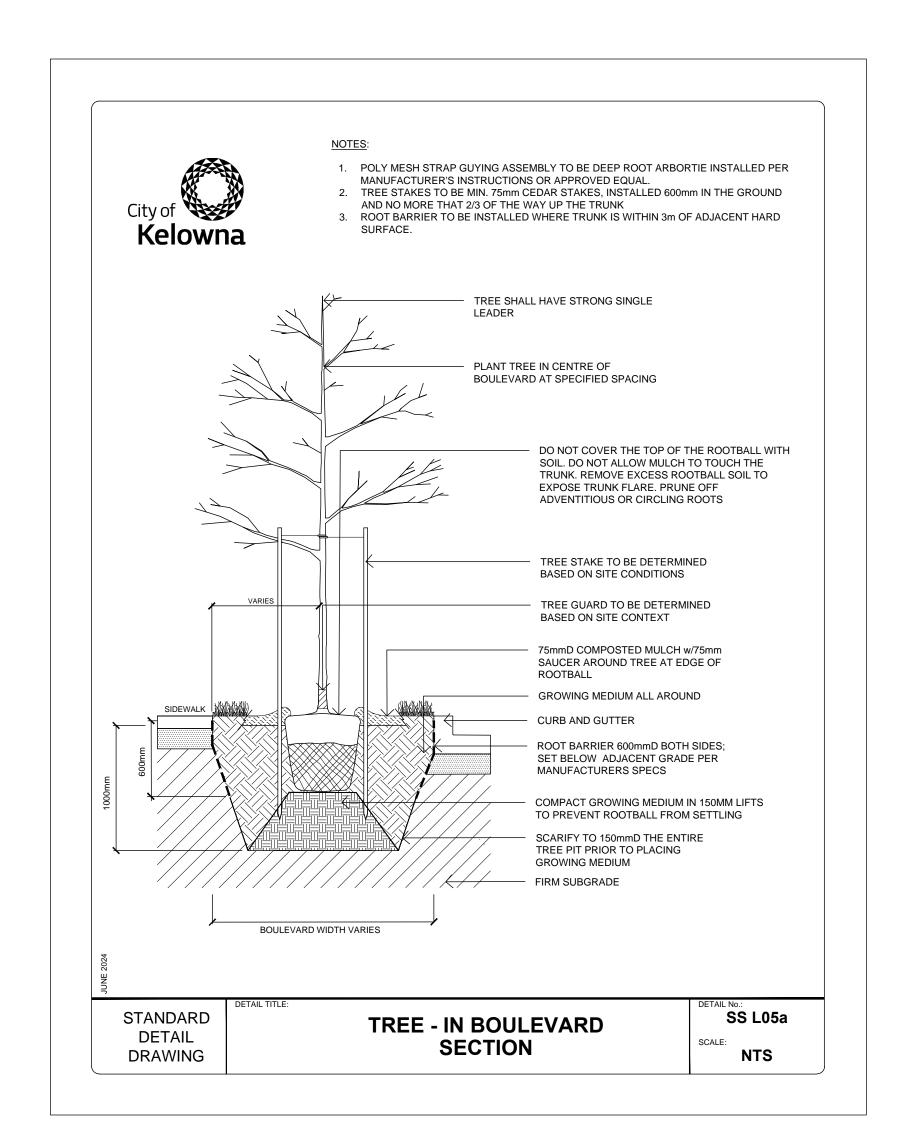

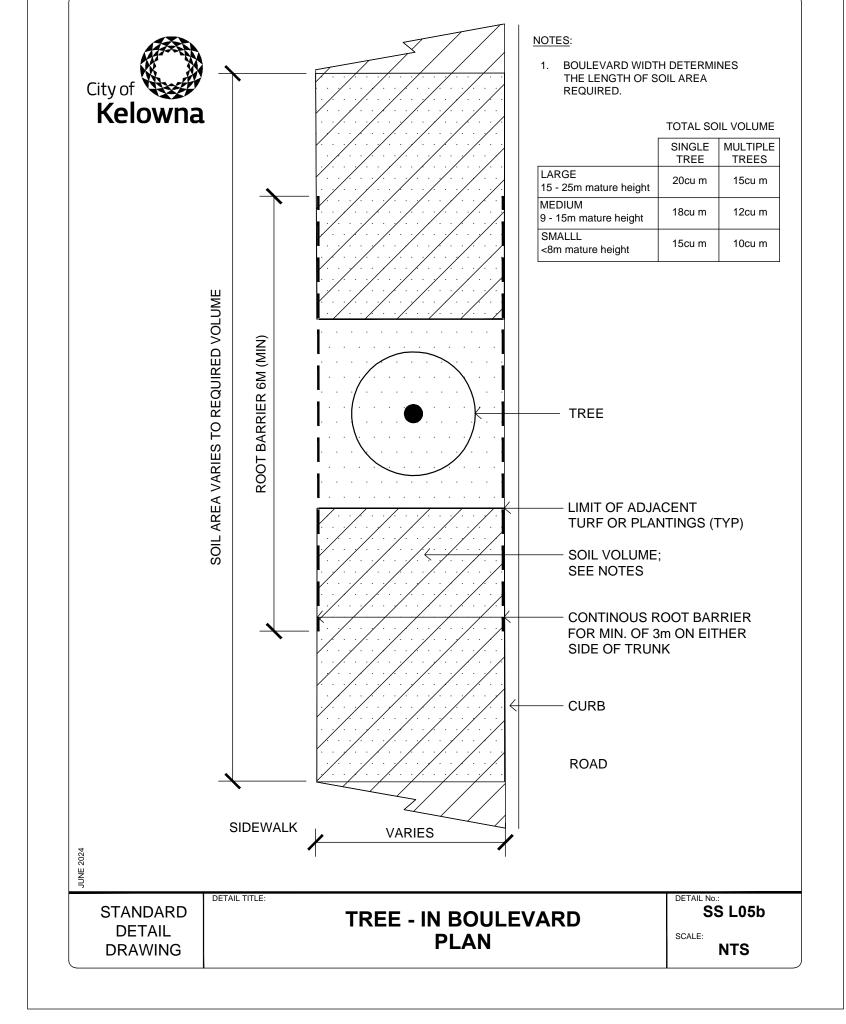









LANDSCAPE ARCHITECTURE URBAN PLANNING

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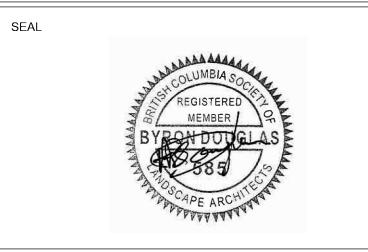
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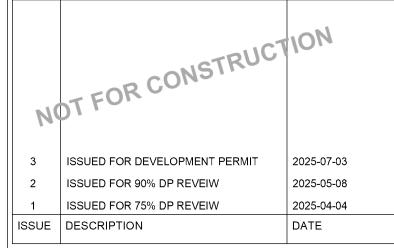
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CLIENT NAME:

NEW TOWN ARCHITECTURE + ENGINEERING

PROJECT NAME:


PACIFIC TOWER

DRAWING TITLE DETAILS

DRAWING NO.: MM & EM CHECKED: BD

AS NOTED

PROJECT NO. 24164-100 **LDP3.0**

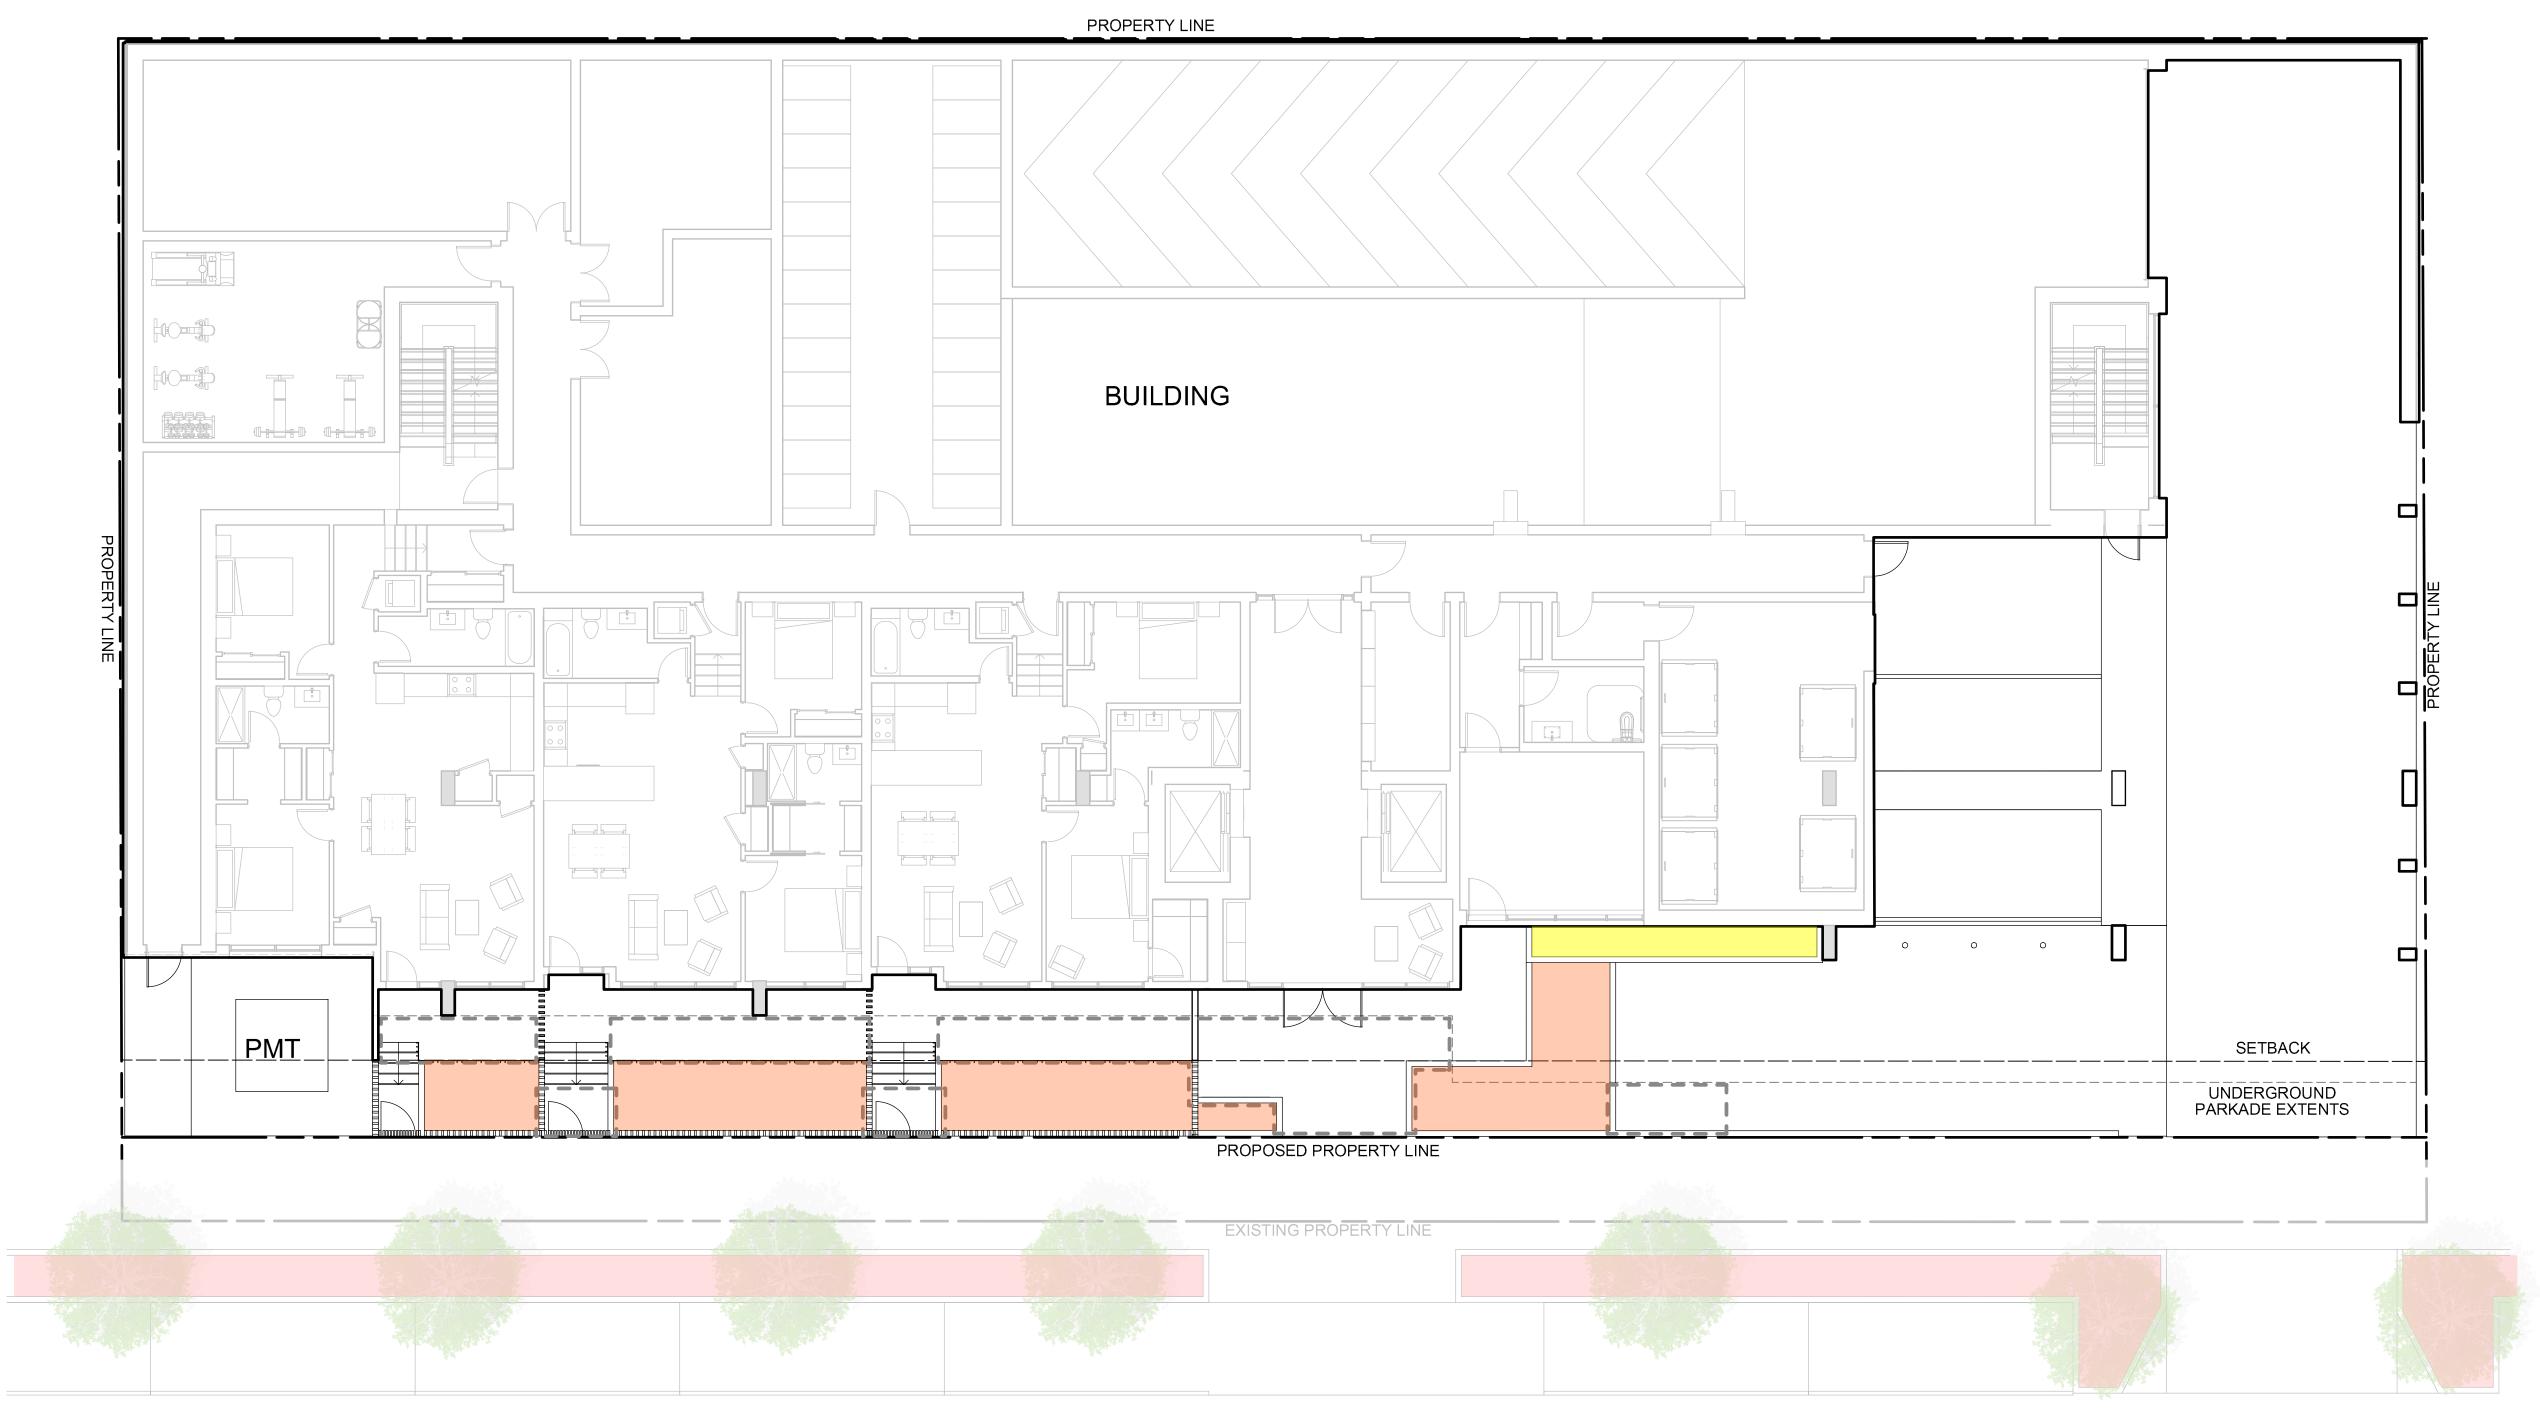

PACIFIC AVENUE



LEGEND

LOW WATER REQUIREMENTS GRASSES/PERENNIALS

MEDIUM WATER REQUIREMENTS SHRUBS

HIGH WATER REQUIREMENTS SOD



ENGINEERING LANDSCAPE ARCHITECTURE URBAN PLANNING

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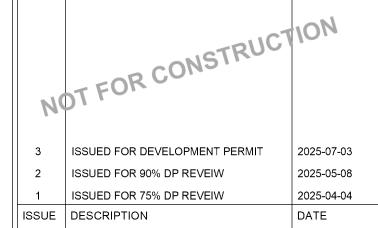
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SEAL





CLIENT NAM

NEW TOWN ARCHITECTURE + ENGINEERING

PROJECT NAME:

PACIFIC TOWER

1:100

WATER CONSERVATION PLAN GROUND FLOOR

DRAWN:


MM & EM

CHECKED:

BD

PROJECT NO.:
24164-100

COME:

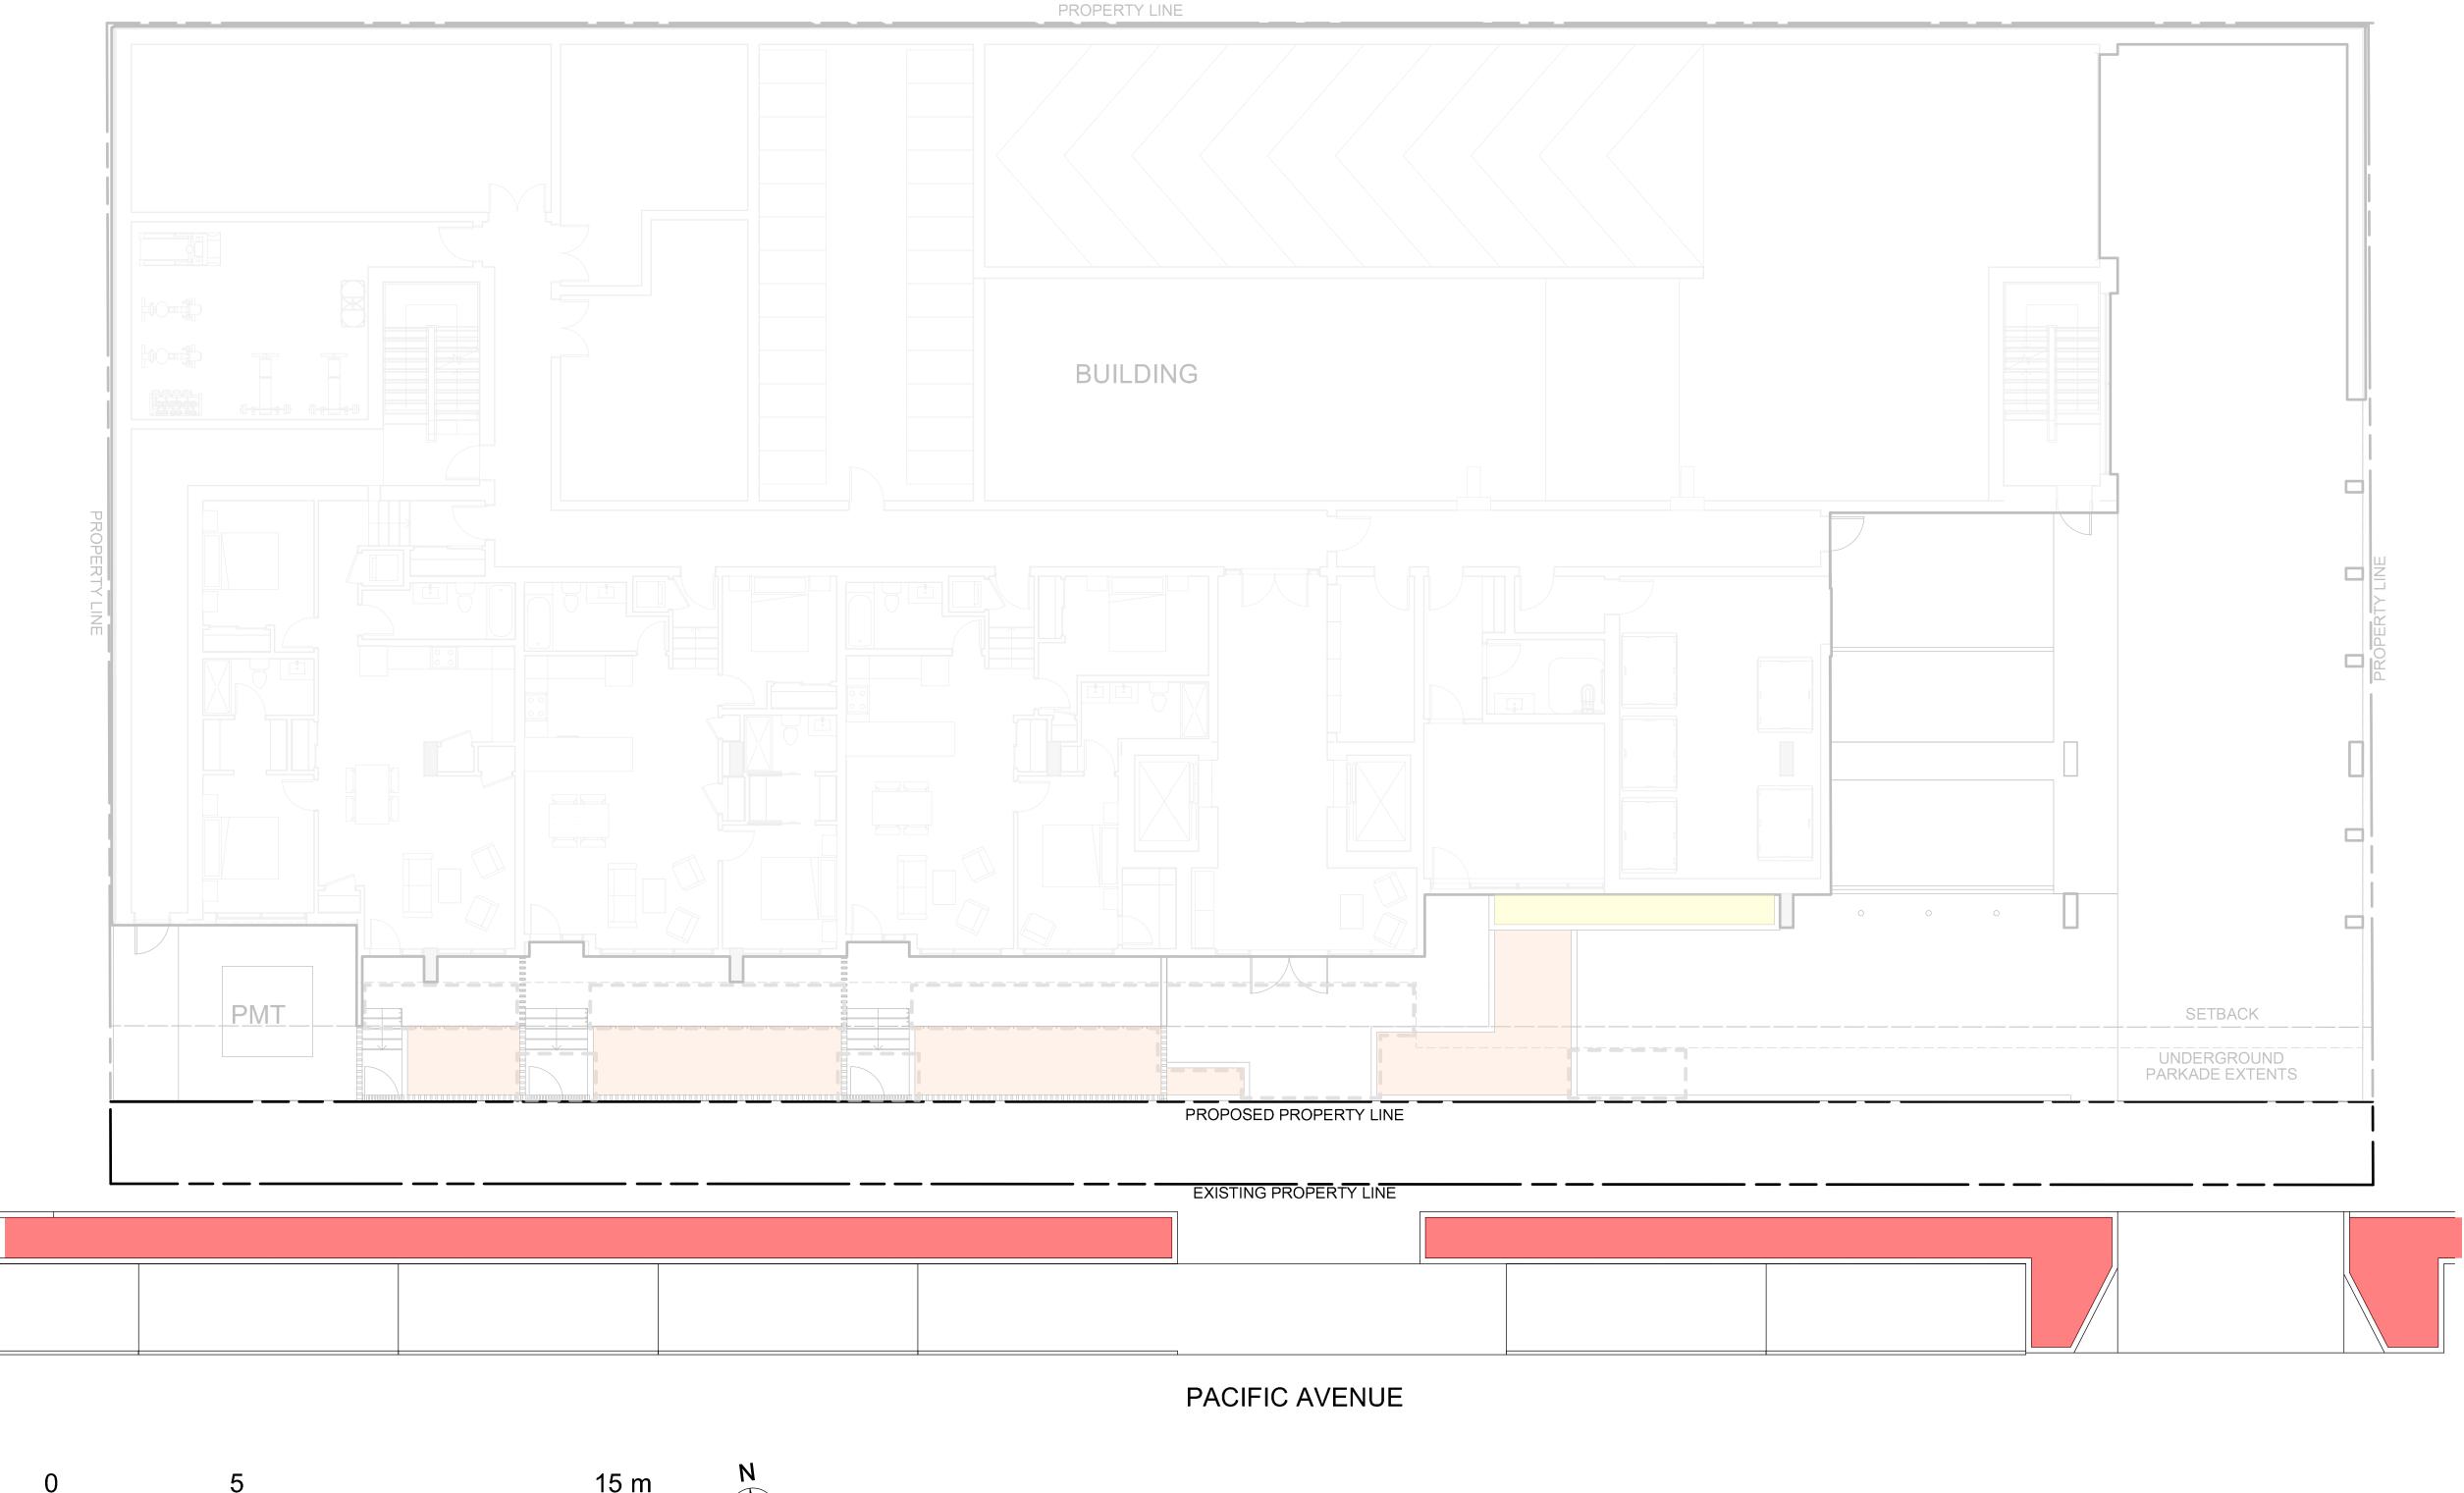



LOW WATER REQUIREMENTS GRASSES/PERENNIALS

MEDIUM WATER REQUIREMENTS SHRUBS

HIGH WATER REQUIREMENTS SOD



ENGINEERING LANDSCAPE ARCHITECTURE URBAN PLANNING

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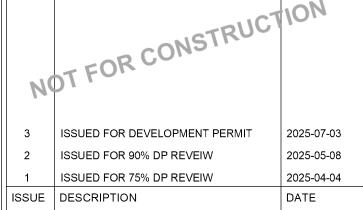
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SEAL





CLIENT NAME:

NEW TOWN ARCHITECTURE + ENGINEERING

PROJECT NAME:

PACIFIC TOWER

DRAWING TITL

WATER CONSERVATION PLAN - GROUND FLOOR (OFFSITE)


DRAWN: MM & EM

CHECKED: BD

PROJECT NO.: 24164-100

24164-100

1:100

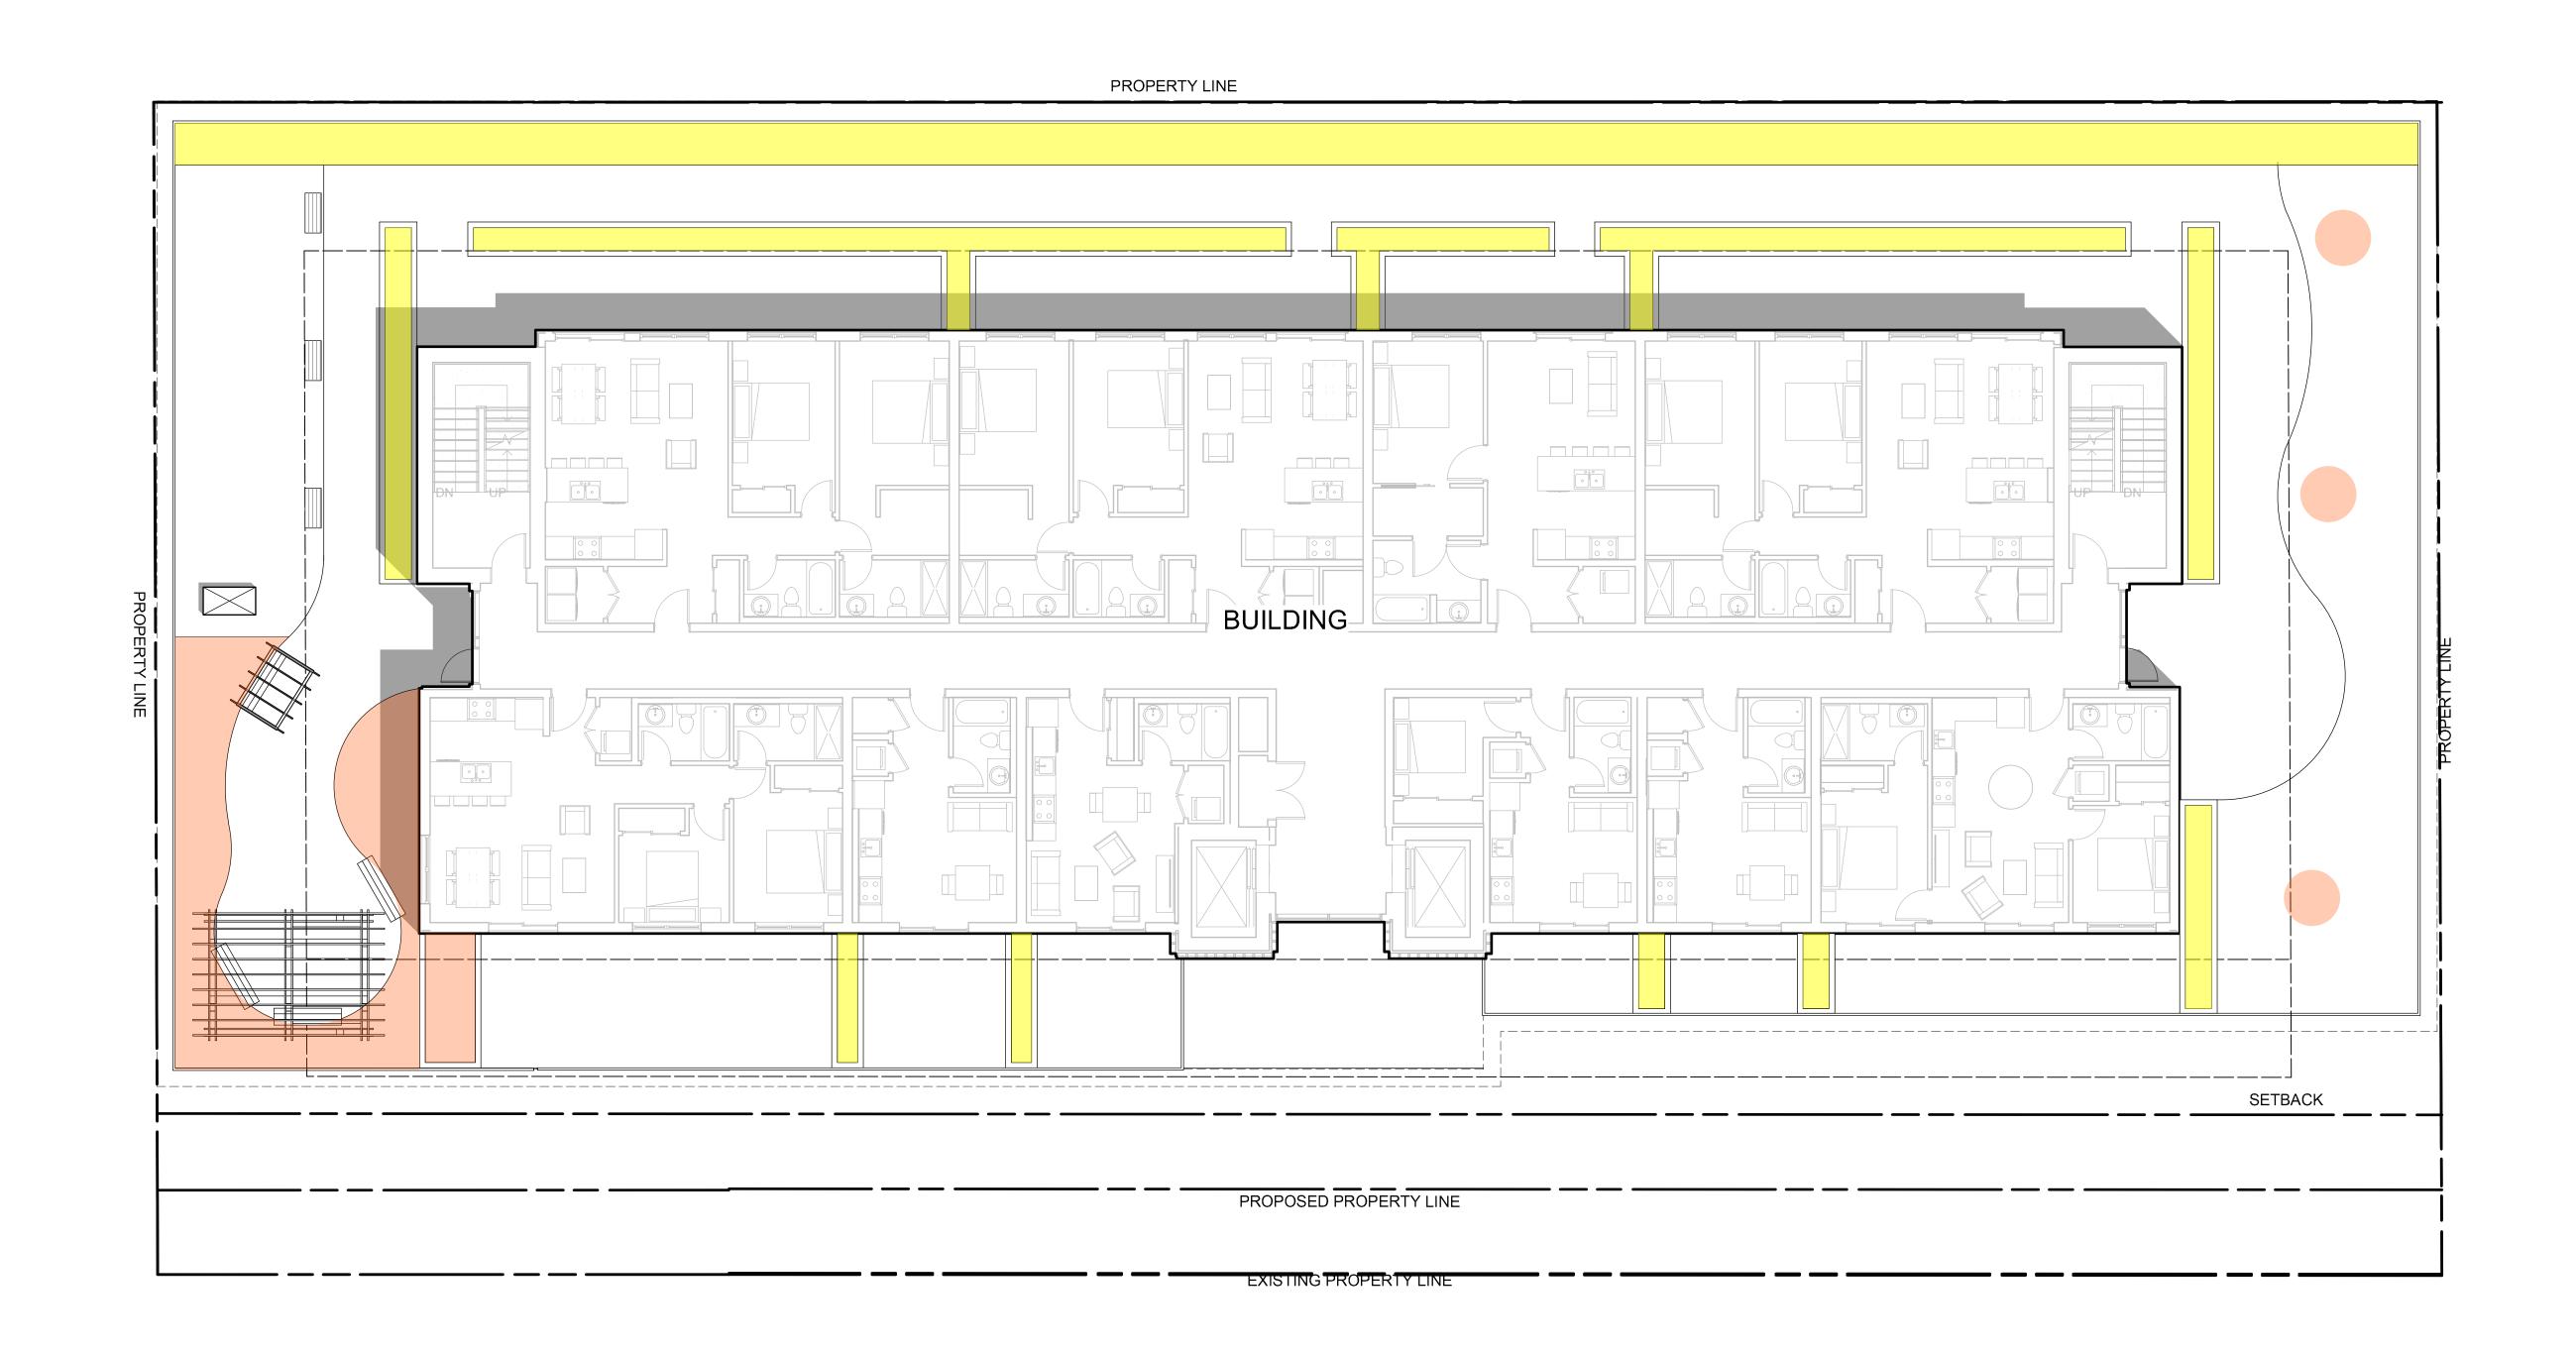



LOW WATER REQUIREMENTS GRASSES/PERENNIALS

MEDIUM WATER REQUIREMENTS SHRUBS

HIGH WATER REQUIREMENTS SOD



ENGINEERING LANDSCAPE ARCHITECTURE URBAN PLANNING

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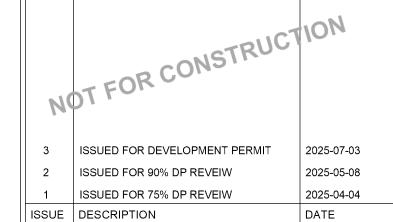
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SEAL





CLIENT NAME:

NEW TOWN ARCHITECTURE + ENGINEERING

PROJECT NAME:

PACIFIC TOWER

1:100

WATER CONSERVATION PLAN LEVEL 5


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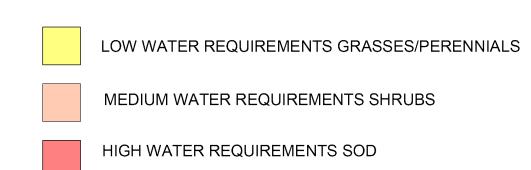
PROJECT NO.: 24164-100

DRAWING NO.:

LDP3.2





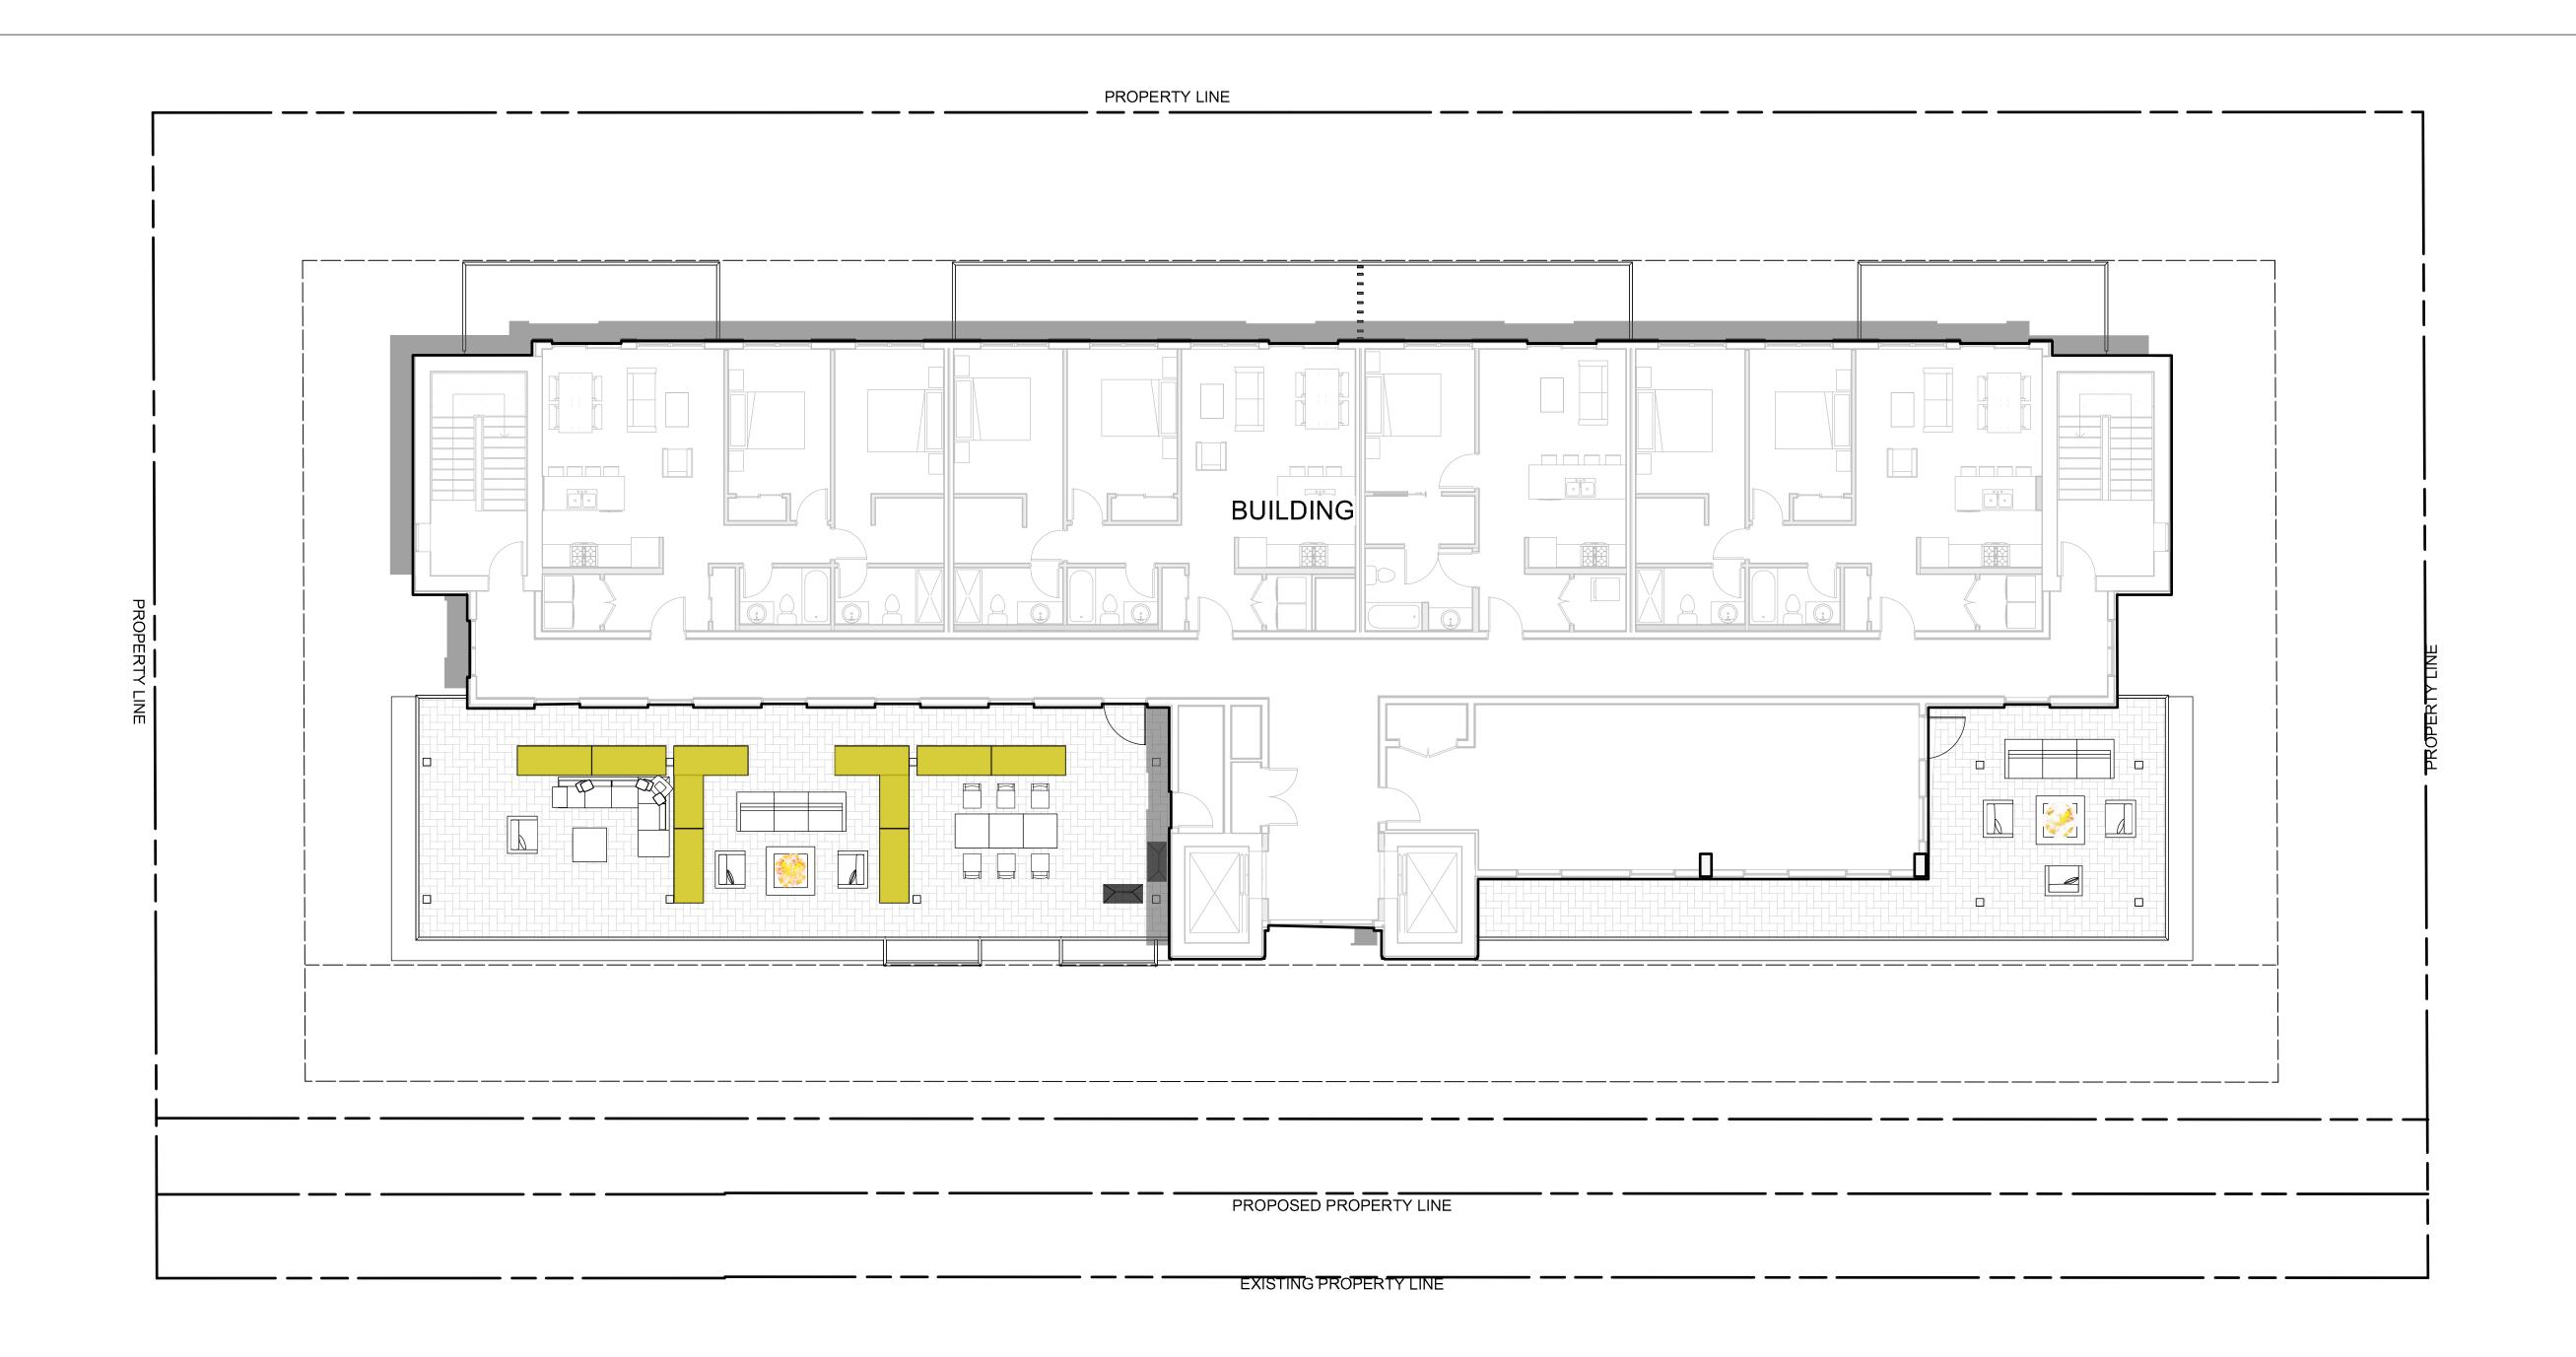



ENGINEERING LANDSCAPE ARCHITECTURE URBAN PLANNING

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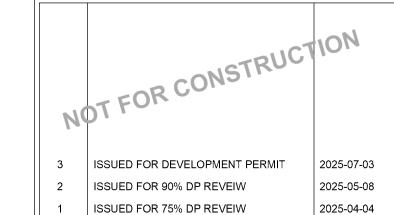
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SEAL





ISSUE DESCRIPTION

NEW TOWN ARCHITECTURE + ENGINEERING

DATE

PROJECT NAME:

PACIFIC TOWER

WATER CONSERVATION PLAN LEVEL 20

DRAWN: MM & EM

CHECKED: BD

PROJECT NO.: 24164-100

LDP3.3

1:100



IEW FROM PACIFIC AVE



PEDESTRIAN VIEW FROM PACIFIC AVE - PARKADE ENTRY





ROOFTOP PATIO VIEV



A9.01D



BIRDS EYE VIEW



PODIUM AMENITY SPACE



REAR VIEW



PODIUM AMENITY SPACE



A9.02D

419

scale designed drawn check 1:10 JM JM UA

2025-07-07 4:39:36 PM